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MAY 04 2018

PUBLIC SERVICE COMMISSION

April 4, 2018

Ms. Renee C. Smith
Filings Branch
Commonwealth of Kentucky
Public Service Commission
211 Sower Blvd.
PO Box 615
Frankfort, Kentucky 40602-0615

Re: Bronston Water Association

2017 Water System Improvements Project:

Contract 1 - Green Hill Estates & Cedar Hill Heights Water Line Replacements

Contract 2 – 500,000 Gallon Ground Water Storage Tank Replacement

RD Loan:

\$1,380,000.00

RD Grant:

\$ 458,000.00

Case: 2017-00138

Dear Ms. Smith:

This is to certify that the above-referenced project has been satisfactorily completed in accordance with the contract plans and specifications. Enclosed you will find an electronic copy on CD of the "Record Drawings" (As-Built) for the above-reference project.

Should you have any questions or need additional information, please advise.

Sincerely,

Deron S. Byrne, P.E.

Project Engineer

2017 WATER SYSTEM IMPROVEMENTS: GREEN HILL ESTATES & CEDAR HILL HEIGHTS CONTRACT 1 -WATER LINE REPLACEMENTS BRONSTON WATER ASSOCIATION PULASKI COUNTY, KENTUCKY

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BRONSTON WATER ASSOCIATION


CARTER STEWART, PRESIDENT
CHARLES CASSADA, VICE PRESIDENT
ERIC KEITH, SEC/TREASURER
CLINT KEITH LELAND KEITH


OFFICE SECRETARY - VICKIE RAMSEY
GENERAL MANAGER - DAVID SLAGLE
SUPERINTENDENT - J.C. NEW

APRIL 2016

Monarch Engineering, Inc.

556 CARLTON DRIVE LAWRENCEBURG, KY 40342

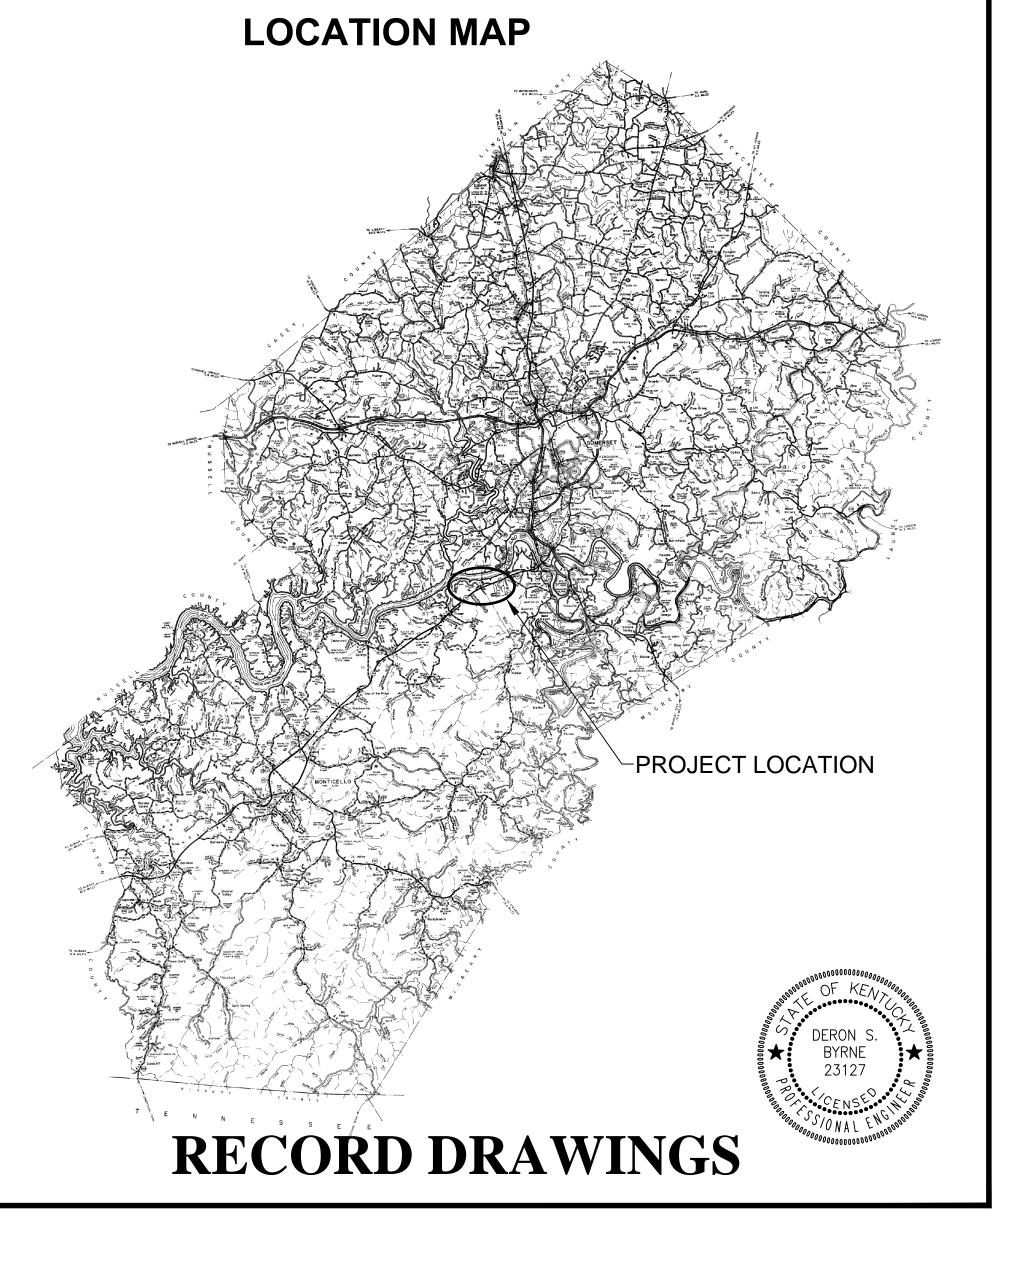

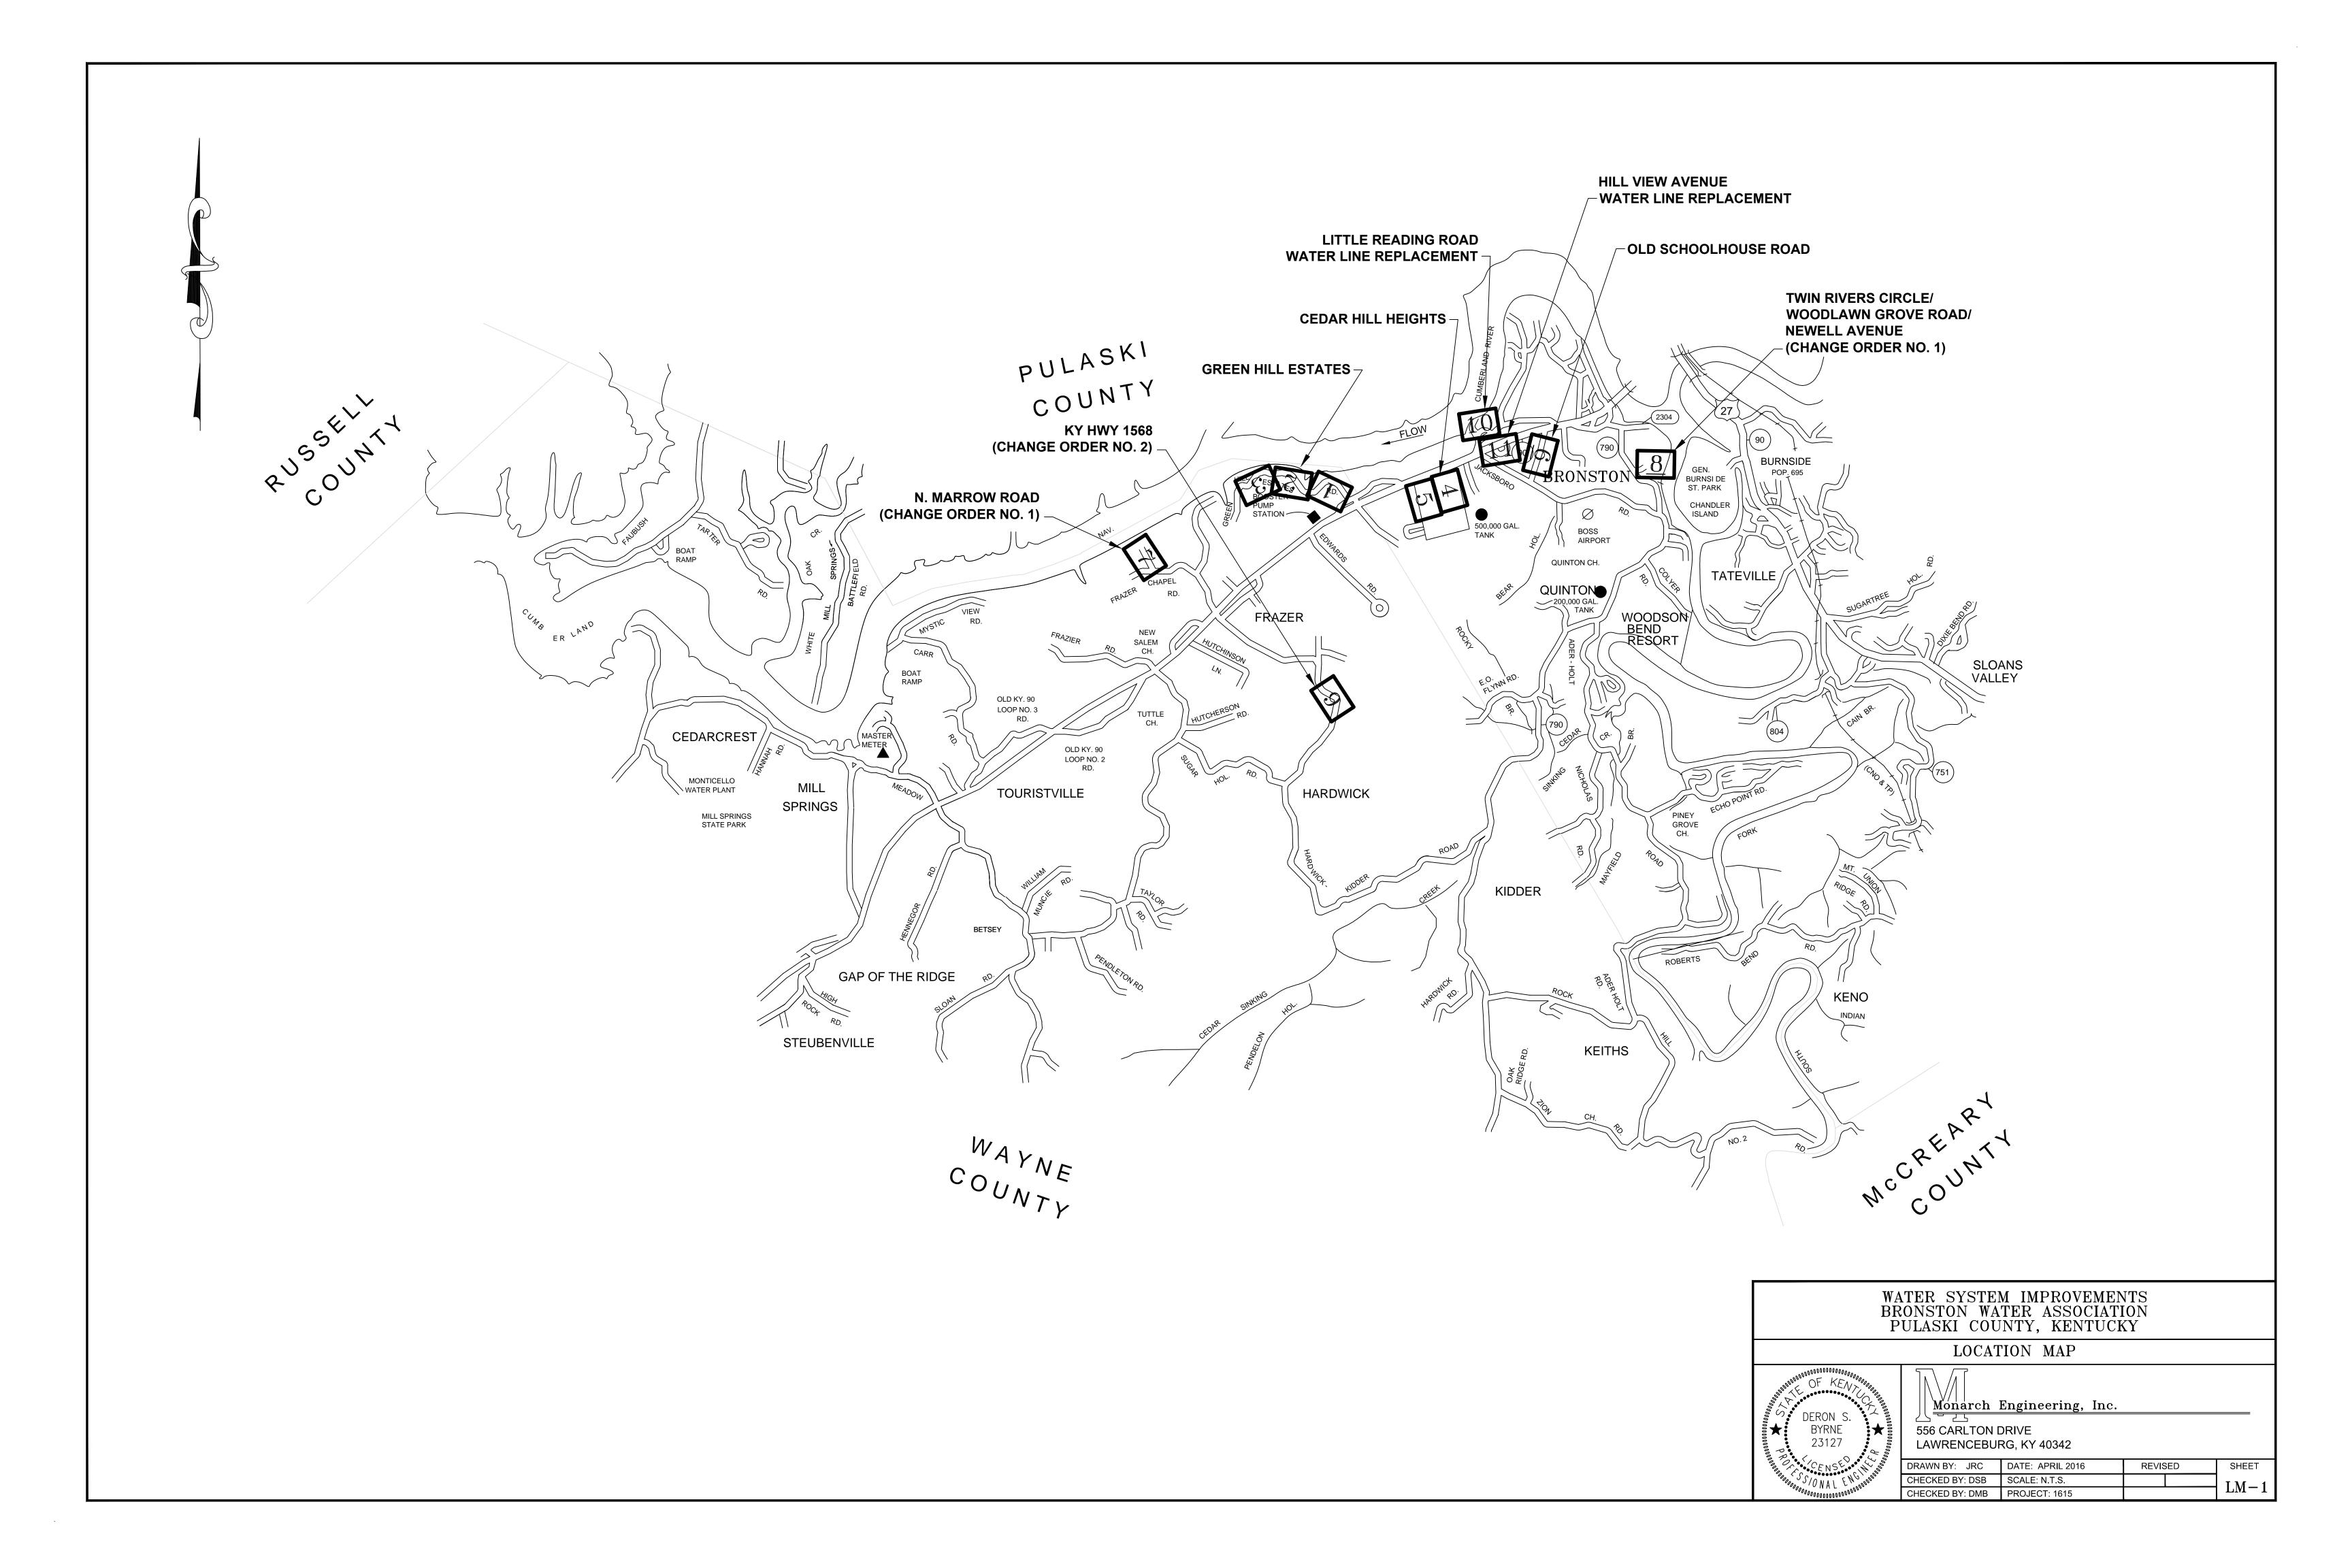

GENERAL NOTES TO CONTRACTOR

- BEFORE CONSTRUCTION BEGINS NEAR OR THROUGH EXISTING UTILITIES (i.e. GAS CO., TELEPHONE CO., CABLE CO., ETC.) EACH UTILITY COMPANY SHALL BE NOTIFIED. A REQUEST FOR THE EXACT LOCATION OF THE UTILITY SHALL BE MADE, AND PERMISSION TO PROCEED WITH CONSTRUCTION OBTAINED.
- BEFORE CONSTRUCTION BEGINS THROUGH ANY PROPERTY, THE CONTRACTOR SHALL MAKE HIMSELF AWARE OF THE EXACT LOCATION OF CONSTRUCTION THROUGH THE PROPERTY AND THE BOUNDS OF THE PERMANENT AND TEMPORARY CONSTRUCTION EASEMENTS.
- THE CONTRACTOR SHALL HAVE ON HAND AT THE JOB SITE 22, 45, AND 90 DEGREE BENDS TO ALLOW FOR THEIR USE WHERE BRONSTON WATER ASSOCIATION REQUESTS INSTALLATION AS NECESSARY.
- PIPE JOINT DEFLECTION IS NOT TO EXCEED MANUFACTURER'S ALLOWABLE LIMITS.
- CONNECTING NEW LINES TO EXISTING LINES OR TO WORK IN THEIR CONTRACTS IS SUBSIDIARY TO THE CONTRACT. IT INCLUDES FITTINGS, SLEEVES, ETC., BUT DOES NOT INCLUDE GATE VALVES, WHICH ARE EXTRA PAY ITEM.
- THE CONTRACTOR SHALL FREE BORE ALL ASPHALT AND CONCRETE RESIDENTIAL DRIVEWAYS IN DIRT. AND OPEN CUT IN ROCK AS DIRECTED BY THE BRONSTON WATER ASSOCIATION AND ENGINEER. THE CONTRACTOR SHALL EXCAVATE FROM EITHER SIDE OF ALL FENCES TO AVOID CUTTING. FENCE CUTTING AND REPAIR SHALL BE LIMITED TO UNIQUE CONDITIONS WHERE APPROVED BY BRONSTON WATER ASSOCIATION.
- ALL STREAM AND RIVER CROSSINGS GREATER THAN 15 FEET WIDE SHALL HAVE GATE VALVES INSTALLED ON EACH SIDE OF THE CROSSING. THE VALVE ON THE SOURCE SIDE SHALL HAVE A BYPASS SERVICE METER INSTALLED FOR LEAK DETECTION.
- ALL WATER LINES WITHIN 200 FEET RADIUS OF UNDERGROUND STORAGE TANKS (KRS-224.6-100), PETROLEUM STORAGE TANKS (KRS-224.60-115) AND ASSOCIATED PUMPS AND LINES SHALL BE DUCTILE IRON PIPE WITH PETROLEUM RESISTANT JOINTS AND ALL SERVICE LINE SHALL BE COPPER.
- WATER MAINS CROSSING SEWERS SHALL BE LAID TO PROVIDE A MINIMUM VERTICAL DISTANCE OF 18 INCHES BETWEEN THE OUTSIDE OF THE WATER MAIN AND THE OUTSIDE OF THE SEWER. THIS SHALL BE THE CASE WHERE THE WATER MAIN IS ABOVE OR BELOW THE SEWER AT CROSSINGS, ONE FULL LENGTH OF THE WATER PIPE SHALL BE LOCATED SO BOTH JOINTS WILL BE AS FAR FROM THE SEWER AS POSSIBLE. SPECIAL STRUCTURAL SUPPORT FOR THE WATER AND SEWER PIPES MAY BE REQUIRED.
- WATER MAINS INSTALLED PARALLEL TO SEWERS SHALL BE LAID TO PROVIDE A MINIMUM HORIZONTAL DISTANCE OF 10 FEET BETWEEN THE OUTSIDE OF THE WATER MAIN AND THE OUTSIDE OF THE SEWER
- THE CONTRACTOR SHALL NOT BE ALLOWED TO MAINTAIN PERSONNEL RESIDENCY FOR ANY EMPLOYEE ON THE CONSTRUCTION SITE.
- WHEN WORKING ALONG THE COMMONWEALTH OF KENTUCKY RIGHT OF WAY, THE CONTRACTOR SHALL BE ADVISED THAT THE WATER LINES SHALL NOT BE PLACED IN FILL AREAS.
- WHEN PERFORMING WORK ALONG OR ACROSS ANY PUBLIC ROADWAY. THE CONTRACTOR SHALL POST WARNING SIGNS PAINTED ORANGE AND THEY SHALL BE FOUR (4) FEET BY FOUR (4) FEET MOUNTED ON POSTS IN ACCORDANCE WITH THE KENTUCKY TRANSPORTATION DEPARTMENT'S MANUAL ON UNIFORM TRAFFIC CONTROL DEVICES. THE SIGNS SHALL B AS FOLLOWS:
 - 1) CAUTION PIPELINE CONSTRUCTION 1500 FEET
 - 2) CAUTION PIPELINE CONSTRUCTION 1000 FEET
 - 3) CAUTION PIPELINE CONSTRUCTION 500 FEET
- THE CONTRACTOR SHALL MAINTAIN TWO (2) FLAG MEN AT ALL TIMES WHERE MACHINERY IS IN OPERATION WHEN WORKING THE FLOW OF TRAFFIC WILL BE DISTURBED. THERE IS NO EXCEPTION TO THIS REQUIREMENT. THE USE OF RADIOS WILL BE REQUIRED WHEN VISUAL CONTRACT BETWEEN THE FLAG MEN DOES NOT EXIST.
- ALL SIGNS, BARRICADES, LIGHTS AND TRAFFIC CONTROL SHALL BE INSTALLED IN ACCORDANCE WITH THE KENTUCKY TRANSPORTATION DEPARTMENT'S MANUAL ON UNIFORM TRAFFIC CONTROL DEVICES.
- AT THE COMPLETION OF EACH WORK DAY. THE CONTRACTOR SHALL BACKFILL ALL OPEN TRENCHES AND INSTALL ALL TRAFFIC CONTROL SIGNS, BARRICADES AND LIGHTS IN ACCORDANCE WITH THE KENTUCKY TRANSPORTATION DEPARTMENT'S MANUAL ON UNIFORM TRAFFIC CONTROL DEVICES.
- CONTRACTOR SHALL BE RESPONSIBLE FOR KEEPING ENTIRE ROADWAY FREE AND CLEAR AT THE END OF EACH WORKING DAY. NO EQUIPMENT SHALL BE LEFT ON OR PARKED ALONG THE ROAD RIGHT OF WAY.
- ALL NECESSARY STEPS SHALL BE TAKEN TO PREVENT EROSION OR SILTATION OF THE PUBLIC RIGHT OF WAY, ADJOINING PROPERTY AND WATER WAYS.

WATER LINE GENERAL NOTES

- 1. ALL WATER LINES SHALL BE CONFORMING TO ASTM SPECIFICATIONS D-2241 AND D-3139. FOR MATERIAL. ALL JOINTS SHALL BE SLIP-TYPE WITH RUBBER GASKETS CONFORMING TO ASTM-1869.
- 2. FITTINGS SHALL BE DUCTILE IRON CLASS 250 IN ACCORDANCE WITH AWWA C111-71 (ANSI A21.10).
- 3. ALL VALVES SHALL CONFORM TO AWWA C500.
- 4. CONSTRUCTION PRACTICES AND PROCEDURES SHALL CONFORM TO CURRENT AWWA STANDARDS AND BE APPROVED BY THE BRONSTON WATER ASSOCIATION.
- 5. AFTER INSTALLATION, WATER LINES SHALL BE DISINFECTED WITH A CHLORINE SOLUTION IN SUCH AMOUNTS AS TO PRODUCE A CONCENTRATION OF AT LEAST FIFTY (50) PPM AND A RESIDUAL OF AT LEAST TWENTY-FIVE (25) PPM AT THE END OF THE 24 HOURS AND FOLLOWED BY THROUGH FLUSHING.
- 6. MINIMUM COVER OF WATER LINES SHALL BE 30 INCHES. WATER LINE WITHIN COMMONWEALTH OF KENTUCKY RIGHT-OF-WAYS SHALL HAVE A MINIMUM COVER OF 42-INCHES.
- 7. CONTRACTOR SHALL FULLY COMPLY WITH ALL LOCAL, STATE AND FEDERAL SAFETY AND ENVIRONMENTAL REGULATIONS GOVERNING UTILITY CONSTRUCTION.
- 8. ALL WATER LINE CROSSING PAVED SURFACE SHALL BE BACKFILLED FULL DEPTH WITH COMPACTED CRUSHED STONE.
- 9. EXISTING AND PROPOSED WATER MAIN LOCATIONS SHALL BE VERIFIED BY BRONSTON WATER ASSOCIATION PRIOR TO CONSTRUCTION.
- 10. ALL PIPE AND FITTINGS SHALL HAVE A MINIMUM OF 6-INCHES OF BEDDING OF DIRT UNDER AND ON BOTH SIDES OF PIPE UNLESS OTHERWISE SPECIFIED. ALL PIPE AND FITTING SHALL BE BACK-FILLED WITH DIRT UNLESS OTHERWISE SPECIFIED.
- 11. ALL FITTINGS: 90° BENDS, TEES, ETC., SHALL BE BLOCK WITH A MINIMUM OF 12-INCHES POURED CONCRETE AGAINST UNDISTURBED SOIL.
- 12. ALL GATE VALVES SHALL TURN RIGHT TO CLOSE AND TURN LEFT TO OPEN.
- 13. ALL VALVES SHALL BE C.I. VALVE BOXES EXTENDING 2-INCHES ABOVE SURFACE.
- 14. ALL FLUSH HYDRANTS SHALL BE STANDARD 2-WAY 5 1/4-INCHES BREAKAWAY TYPE WITH A MINIMUM 3 1/2-INCHES BURY AND TURN LEFT TO OPEN AND RIGHT TO CLOSE.
- 15. ALL PROPOSED WATER LINES SHALL HAVE A #12 COATED TRACER WIRE.
- 16. ALL FLUSH HYDRANTS, WATER VALVES AND FITTINGS SHALL HAVE RESTRAINER GLANDS (MEGALUGS®).
- 17. ALL WATER LINES SHALL BE PRESSURE TESTED TO 150 PSI FOR A MINIMUM OF FOUR (4)
- 18. CONTRACTOR SHALL PROVIDE BACTERIAL SAMPLE RESULTS OF PROPOSED WATER LINES TO BRONSTON WATER ASSOCIATION.

OWNER

BRONSTON WATER ASSOCIATION 2013 WEST HIGHWAY 90 BRONSTON, KY 42518 (606) 561-5209

LINE/CABLE LOCATION SERVICES



(800) 752-6007

RECORD DRAWINGS

WATER SYSTEM IMPROVEMENTS BRONSTON WATER ASSOCIATION PULASKI COUNTY, KENTUCKY

GENERAL NOTES



Monarch Engineering, Inc.

556 CARLTON DRIVE LAWRENCEBURG, KY 40342

DRAWN BY: JRC DATE: APRIL 2016 REVISED SHEET CHECKED BY: DSB SCALE: N.T.S. G-1CHECKED BY: DMB PROJECT: 1615















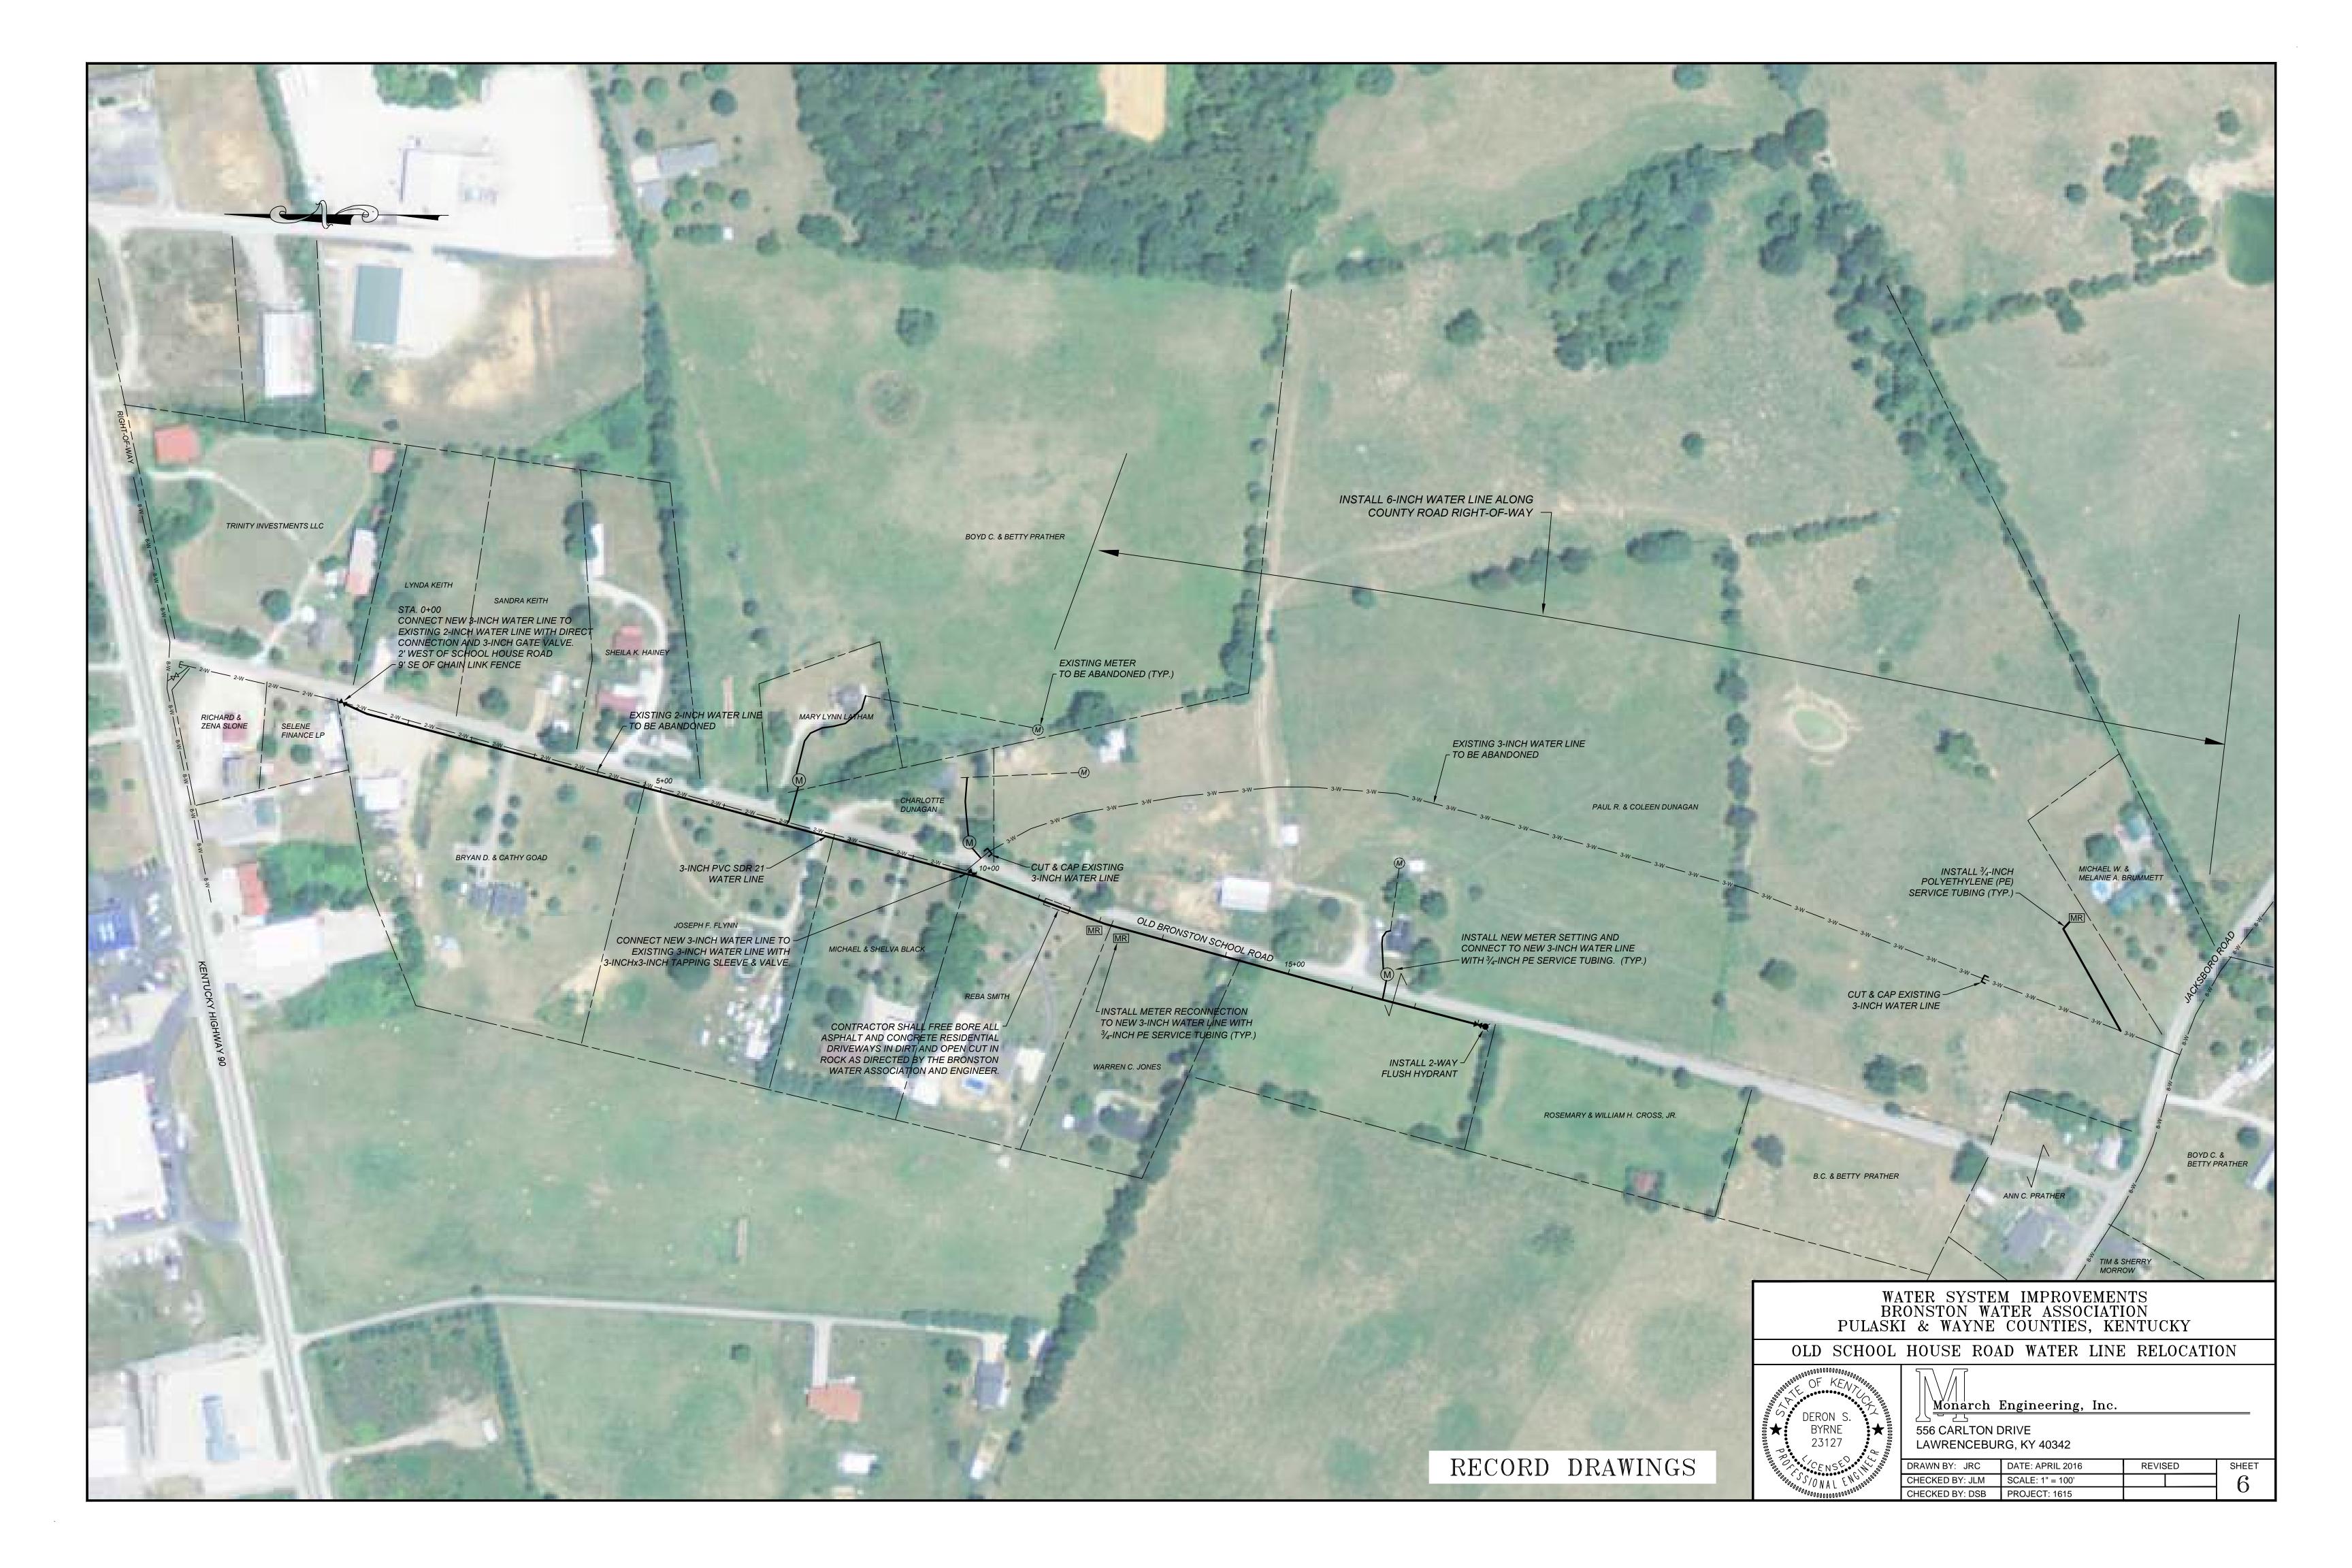




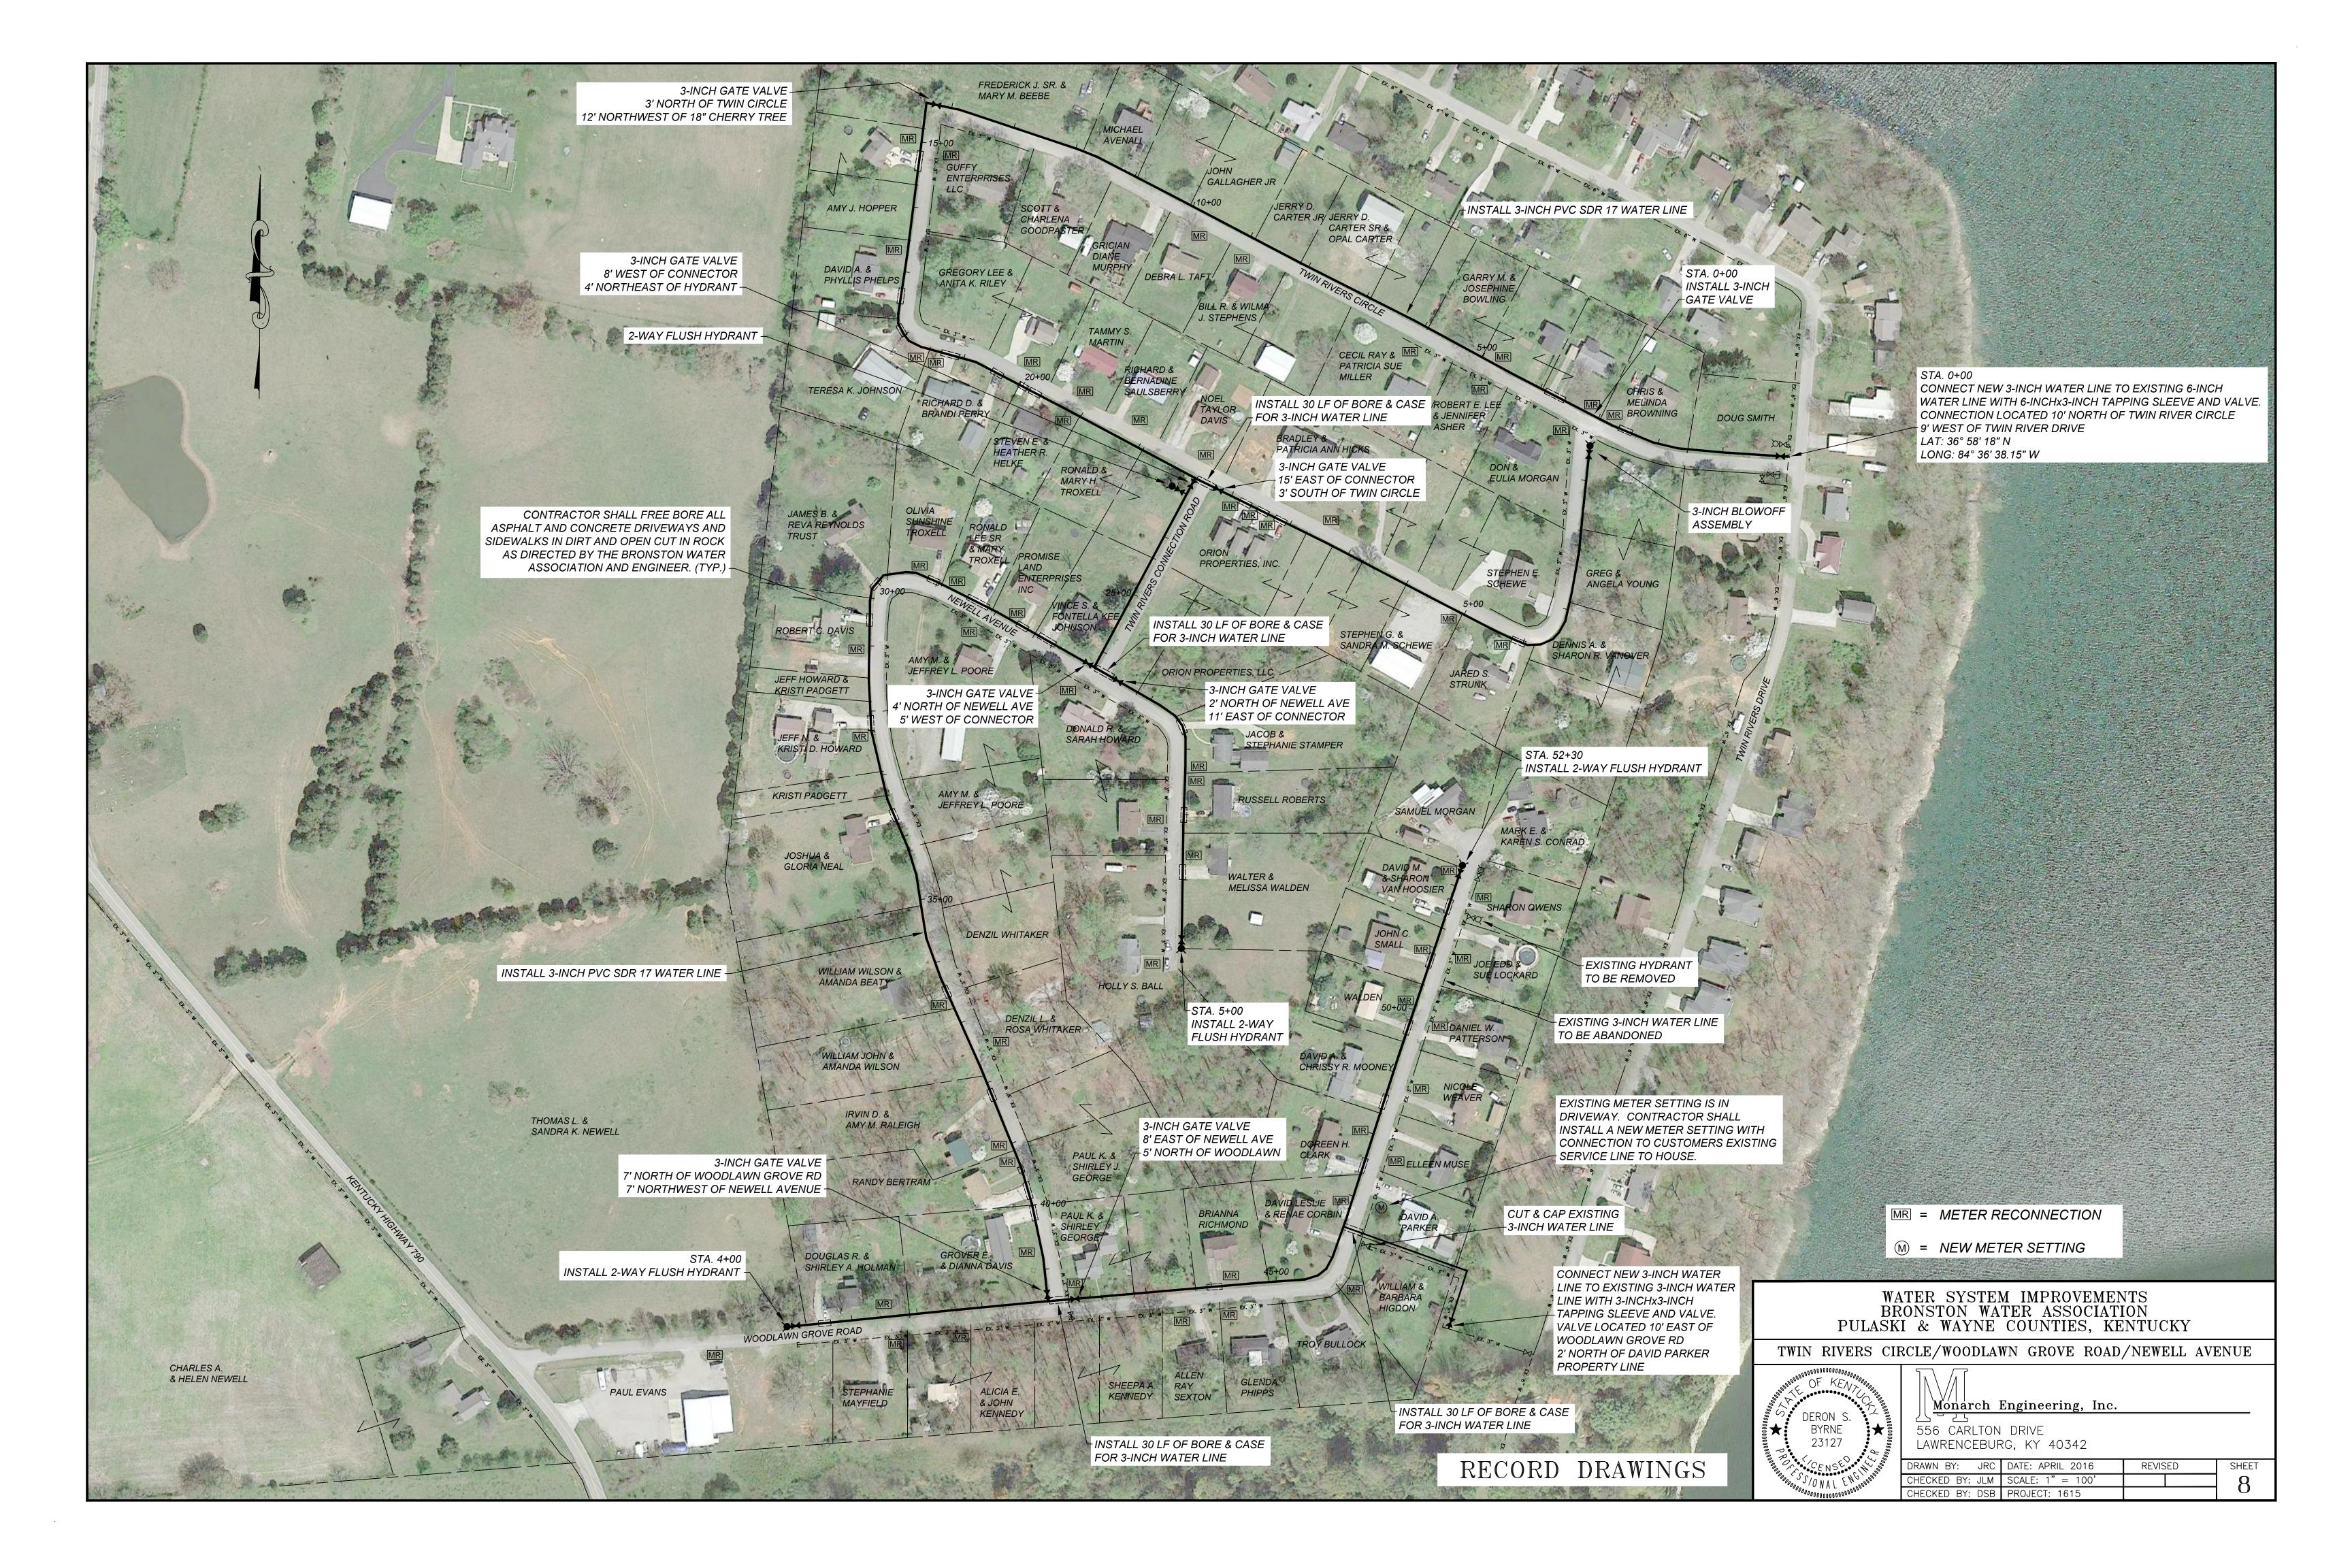

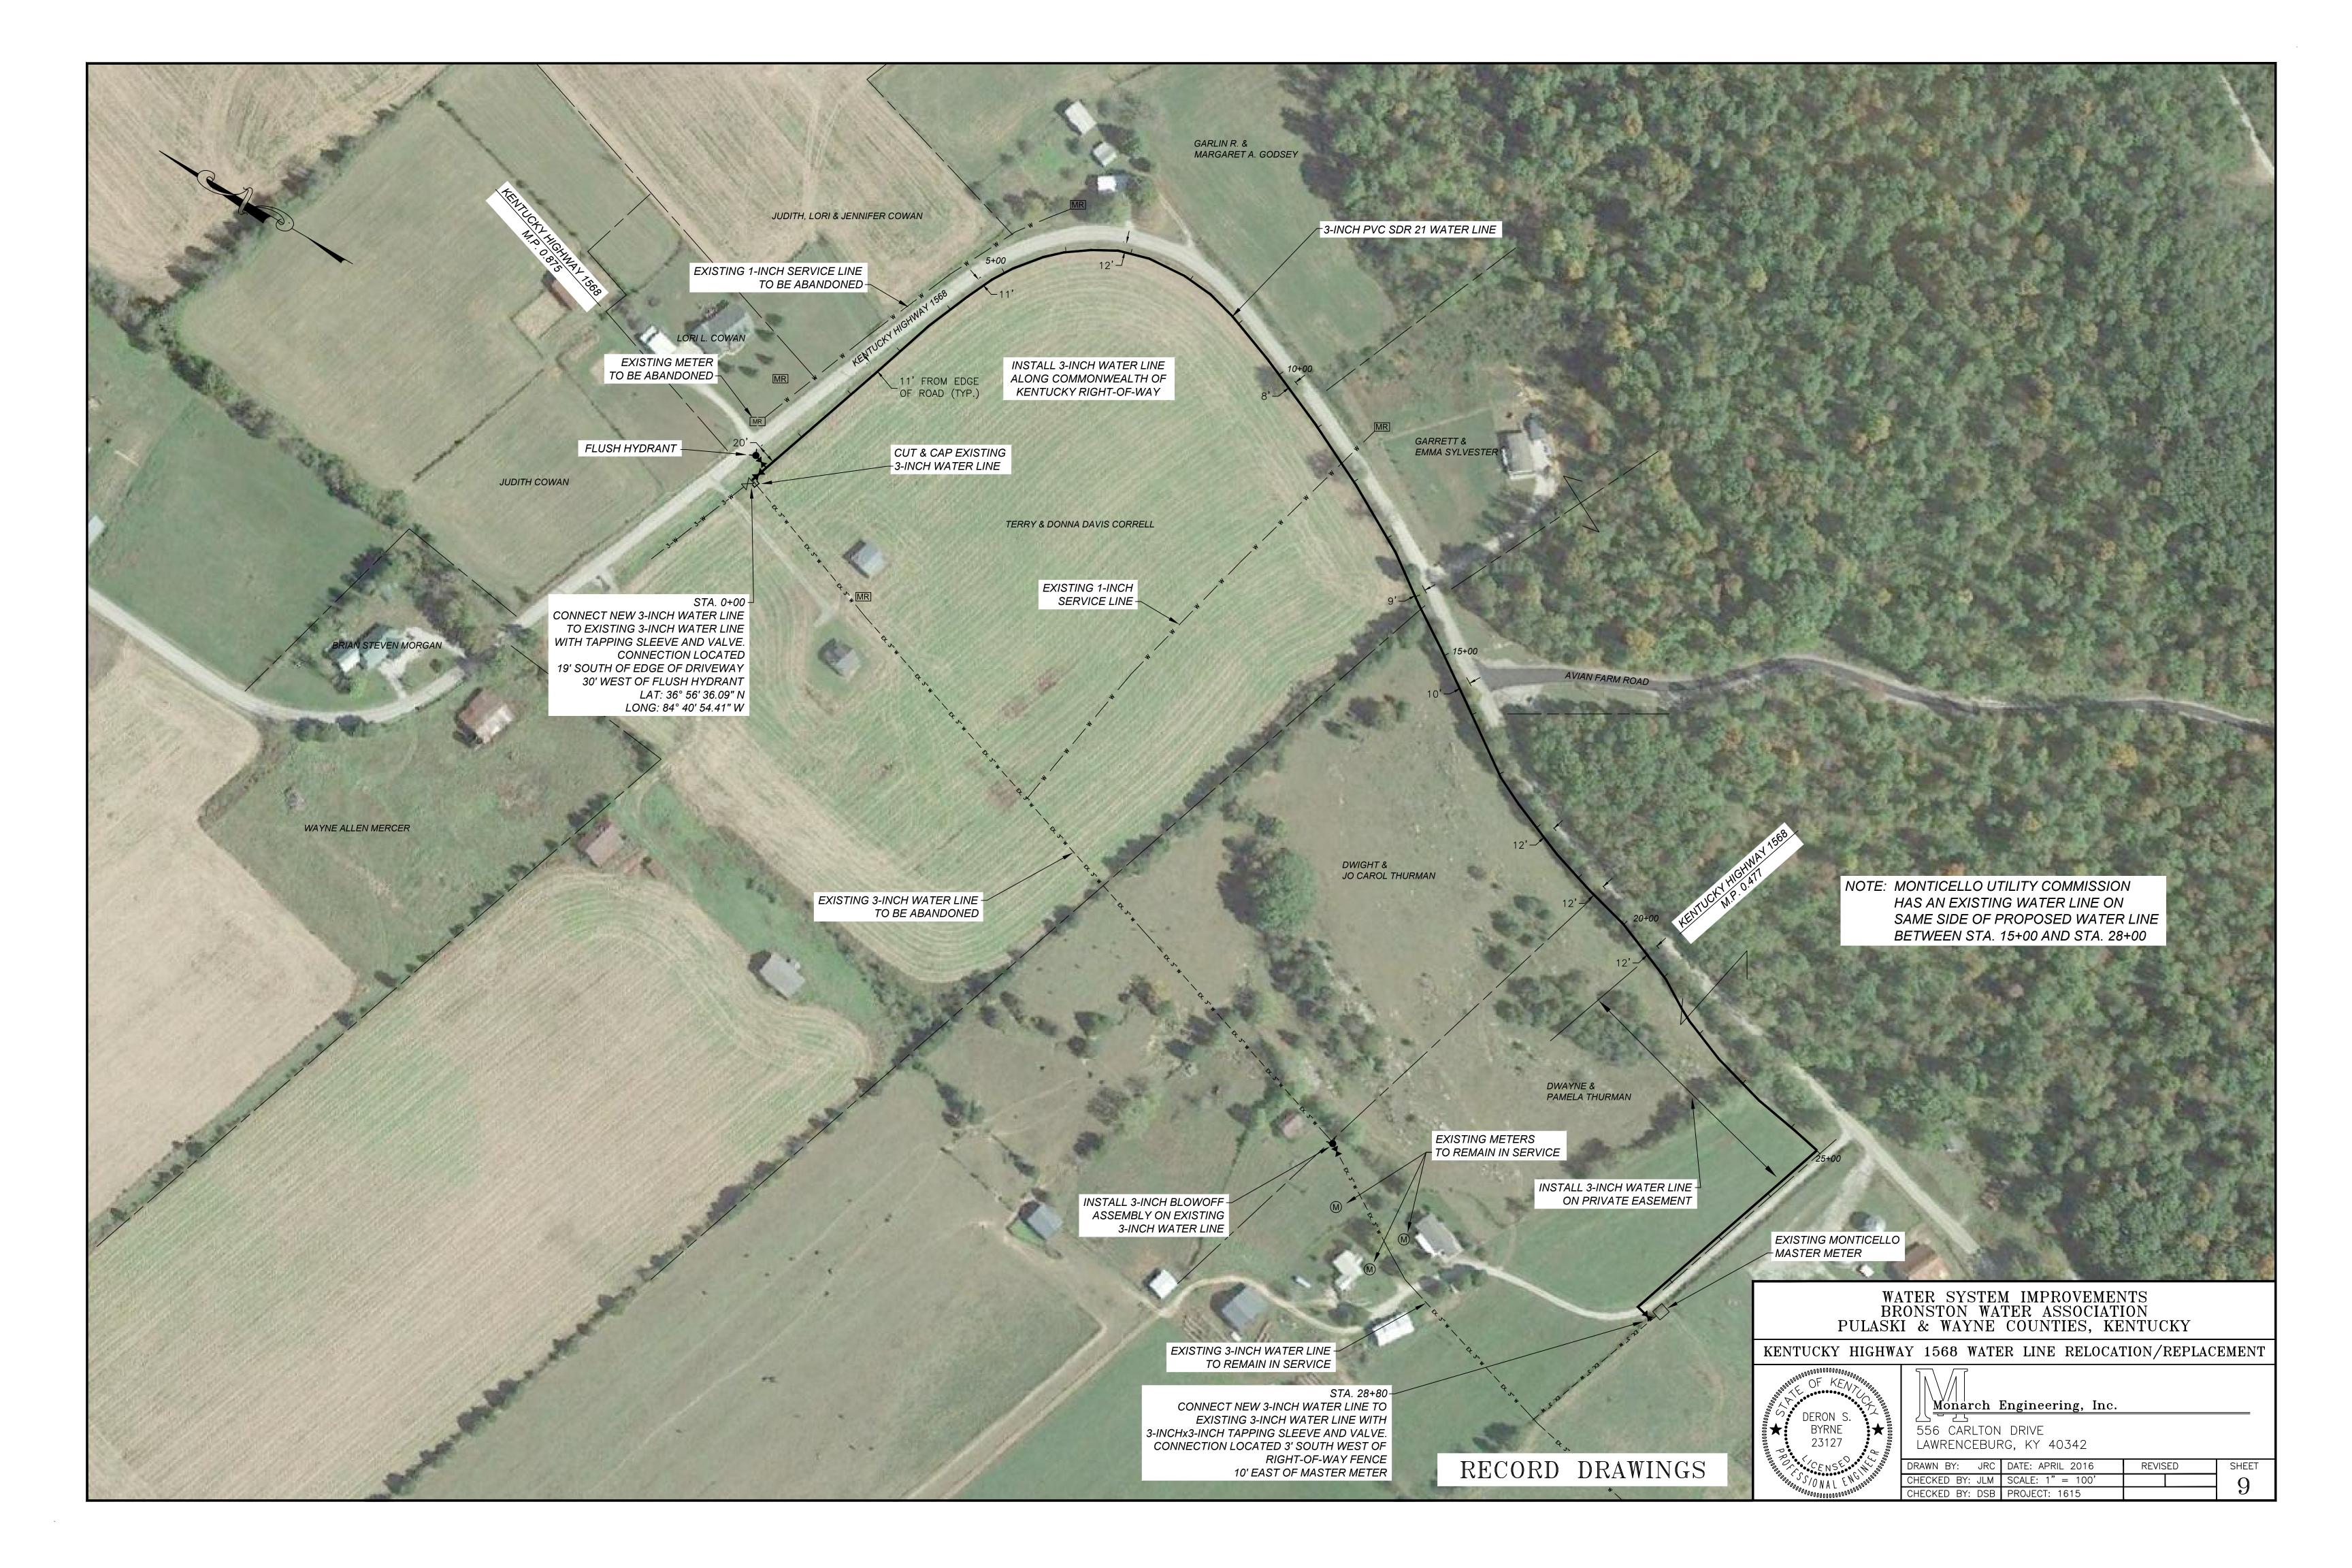


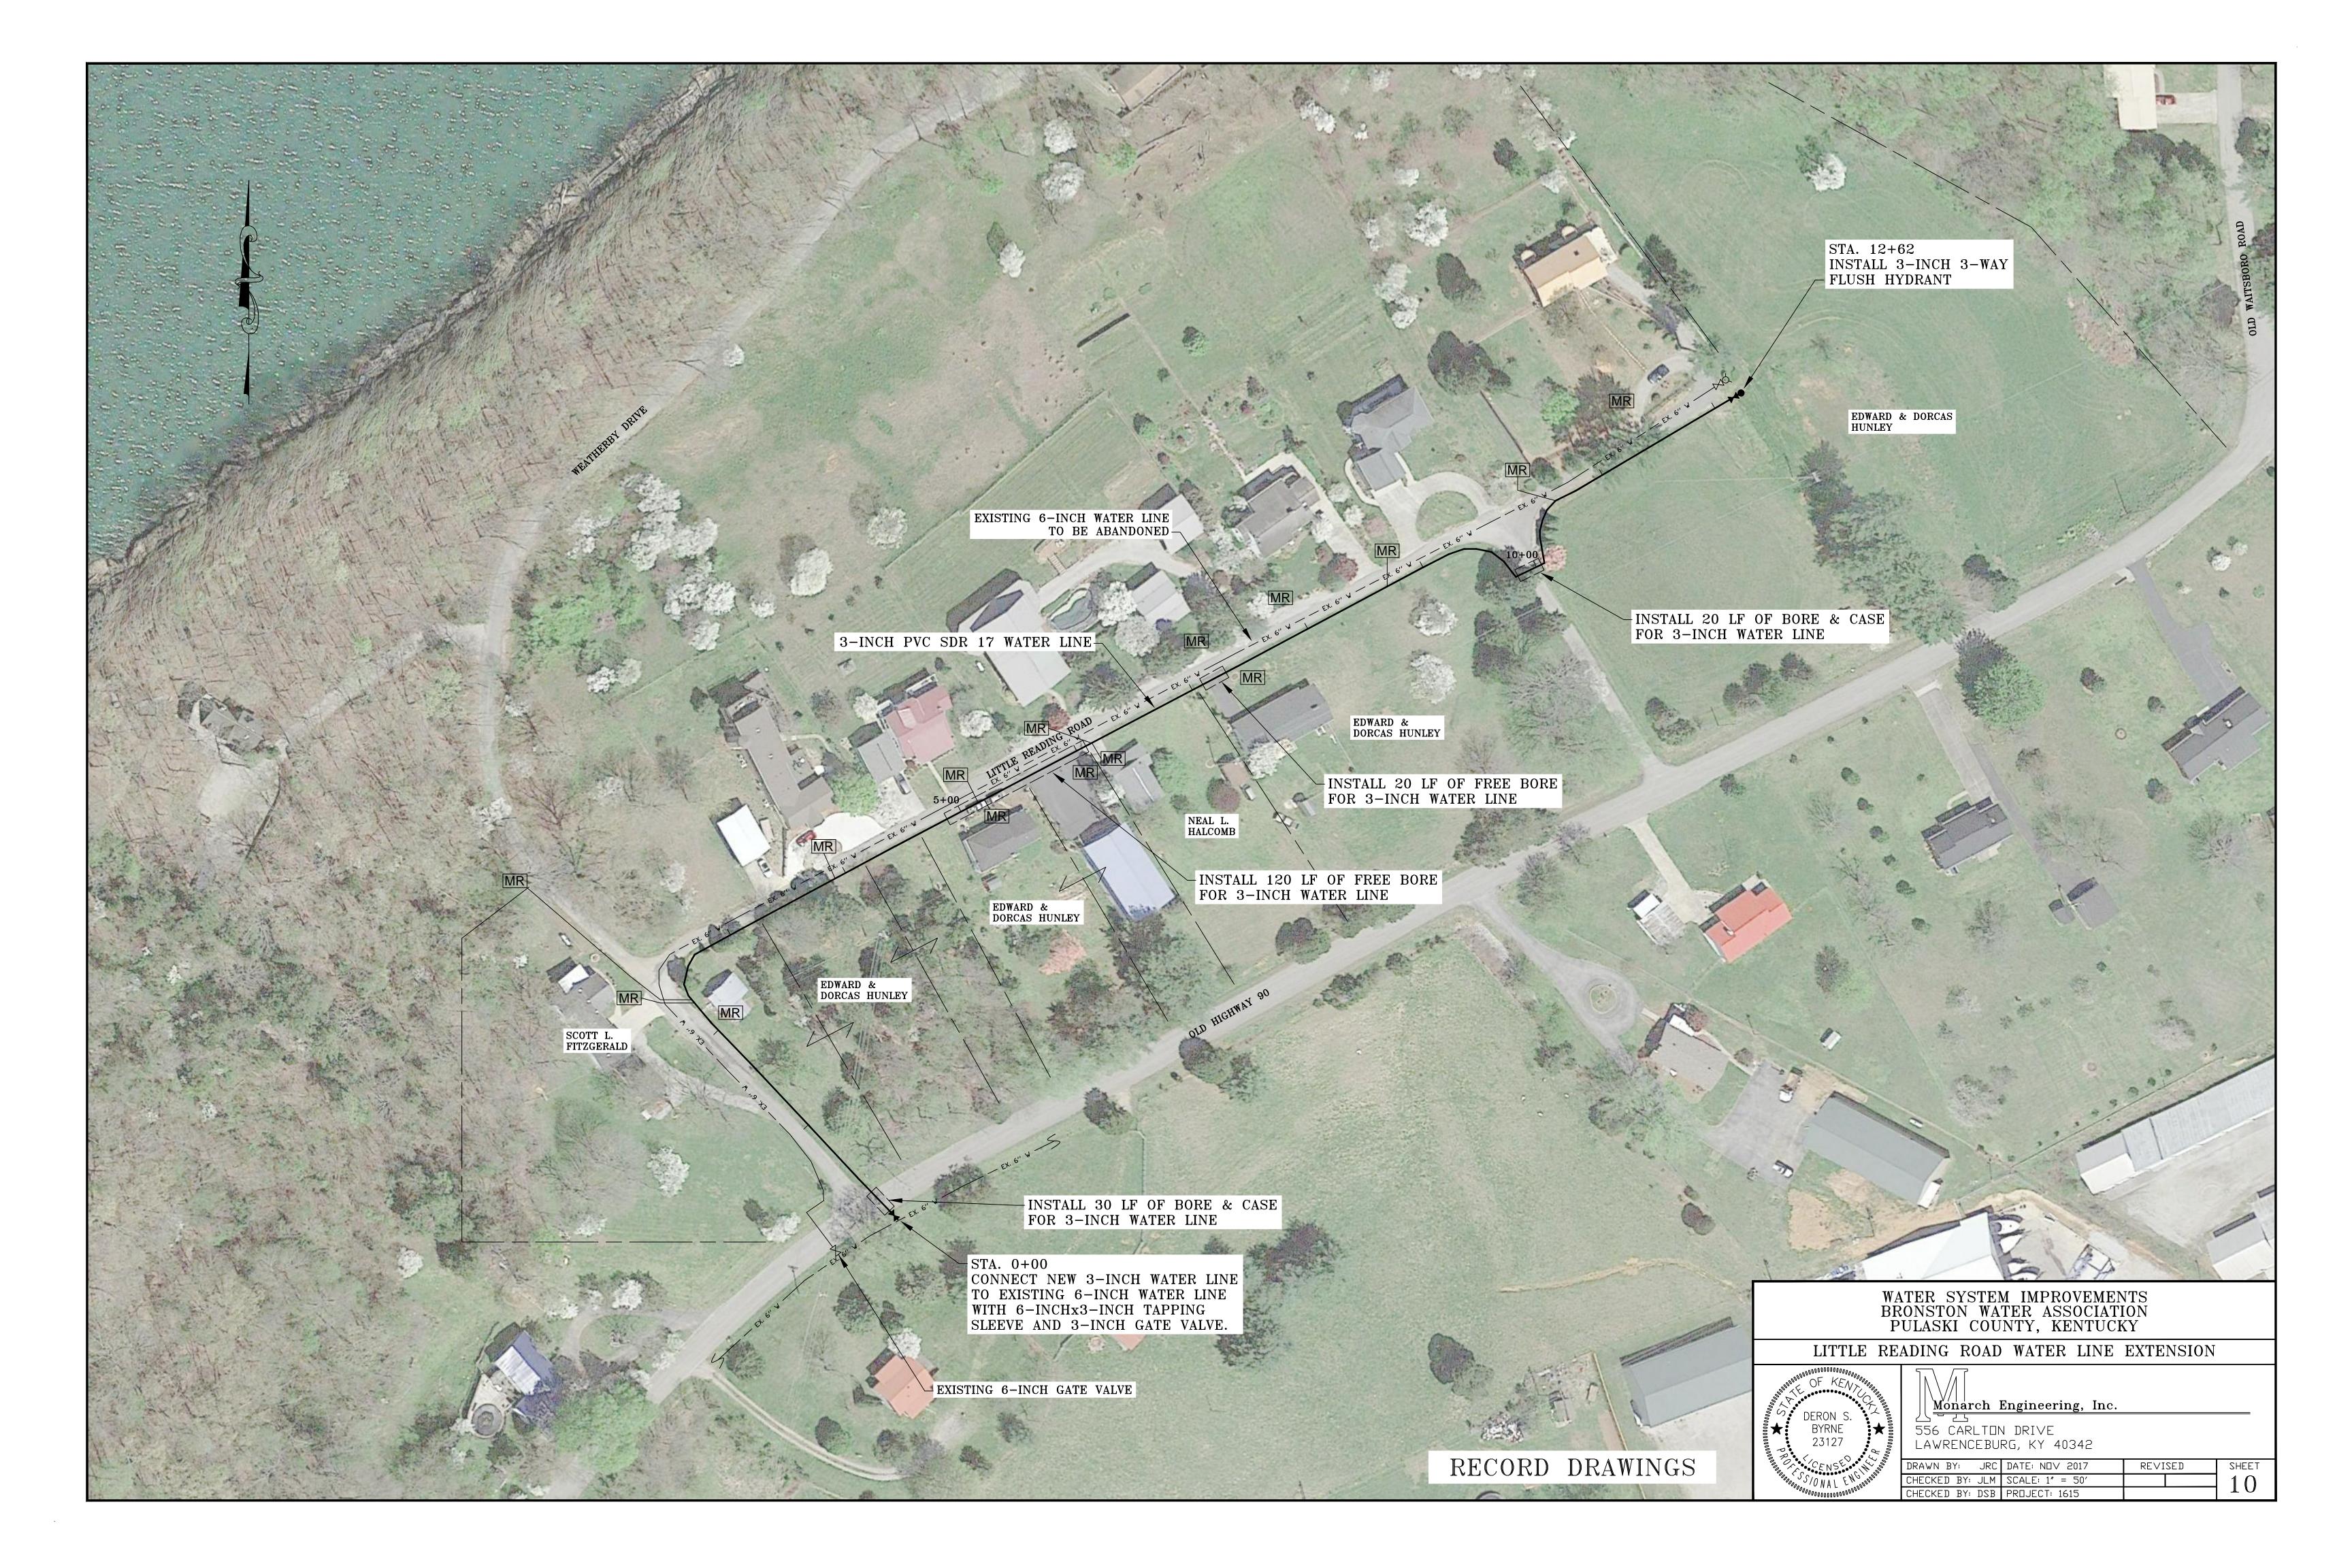



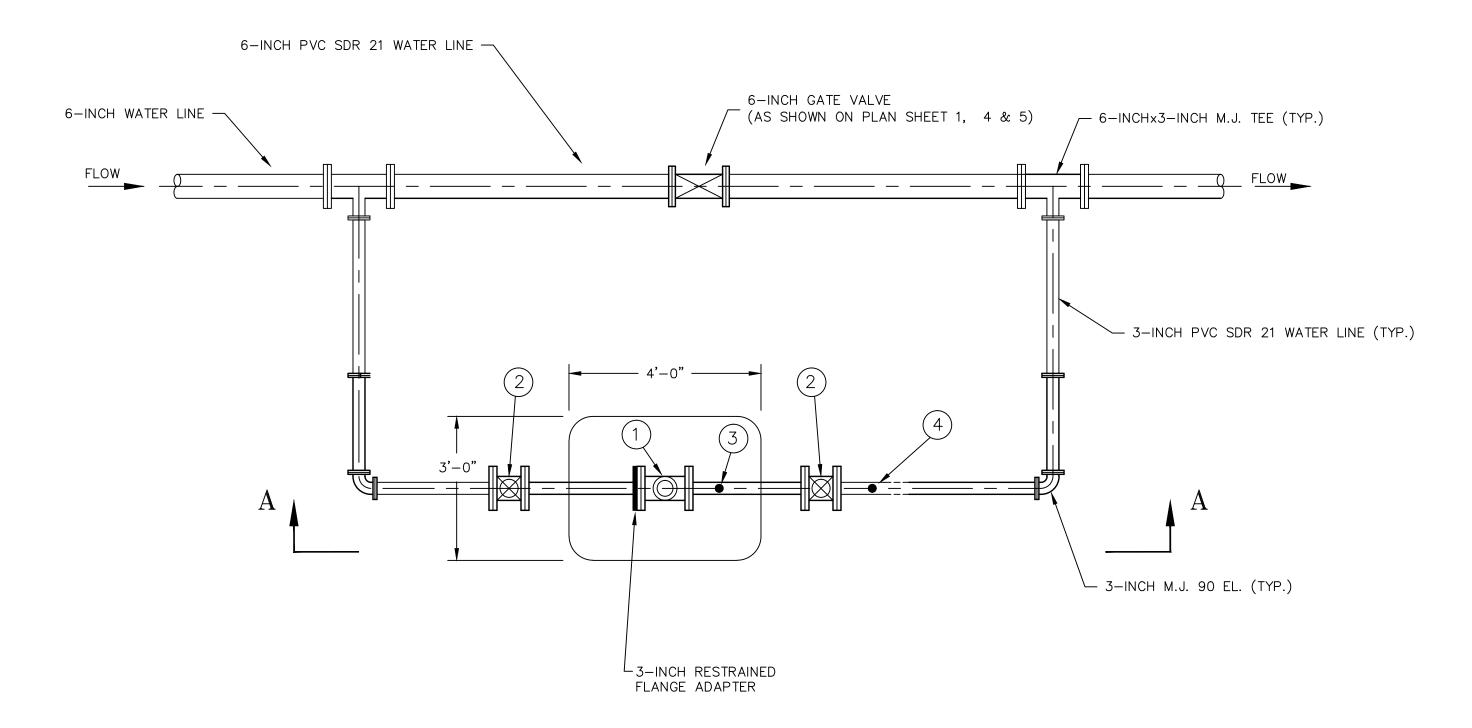

 $\frac{CHECK \ METER}{\frac{PLAN \ VIEW}{}}$ SCALE: 1/2" = 1'-0"

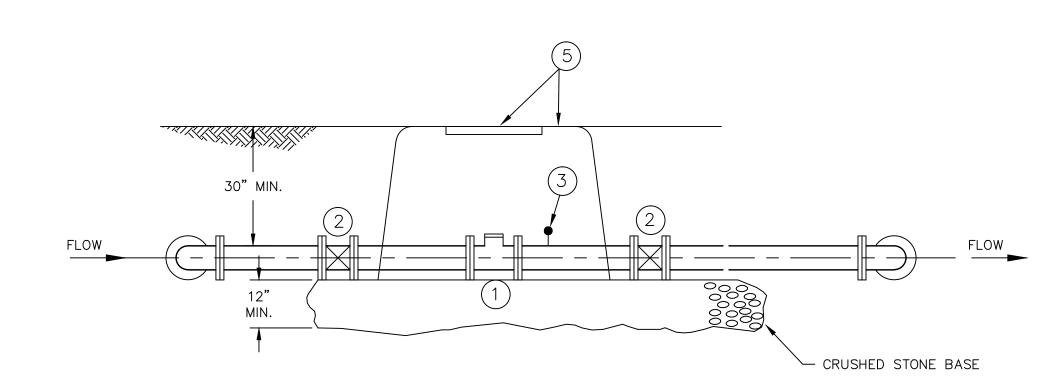


 $\frac{SECTION A-A}{SCALE: 1/2" = 1'-0"}$

\underline{LEGEND}

- 1. 3-INCH FLANGED WATER METER BY BRONSTON WATER ASSOCIATION.
- 2. 3—INCH MECHANICAL JOINT RESILIENT WEDGE/SEATED GATE VALVE BY AMERICAN FLOW, MODEL 2506—MJ, OR APPROVED EQUAL, WITH VALVE BOX ASSEMBLY AND COVER.
- 3. PRESSURE GAUGE ASHCROFT 4½" DURAGAUGE WITH 0-200 psi RANGE (OIL FILLED)
- 4. INSIDE PIPING AND FITTING SHALL BE 3—INCH D.I. WITH 150# FLGS.
- 5 3-0"Wx4-0"Lx3-0"H PREFABRICATED CHECK METER VAULT TO BE PROVIDED BY BRONSTON WATER ASSOCIATION AND INSTALLED BY CONTRACTOR.

WATER SYSTEM IMPROVEMENTS
BRONSTON WATER ASSOCIATION
PULASKI & WAYNE COUNTIES, KENTUCKY


CHECK METER ASSEMBLY

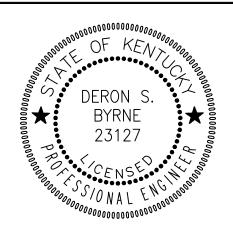


Monarch Engineering, Inc.

556 CARLTON DRIVE LAWRENCEBURG, KY 40342


DRAWN BY: JRC	DATE: APRIL 2016	REVISED	SHEET
CHECKED BY: DSB	SCALE: 1/2"=1'-0"		CM-1
CHECKED BY: DMB	PROJECT: 1615		

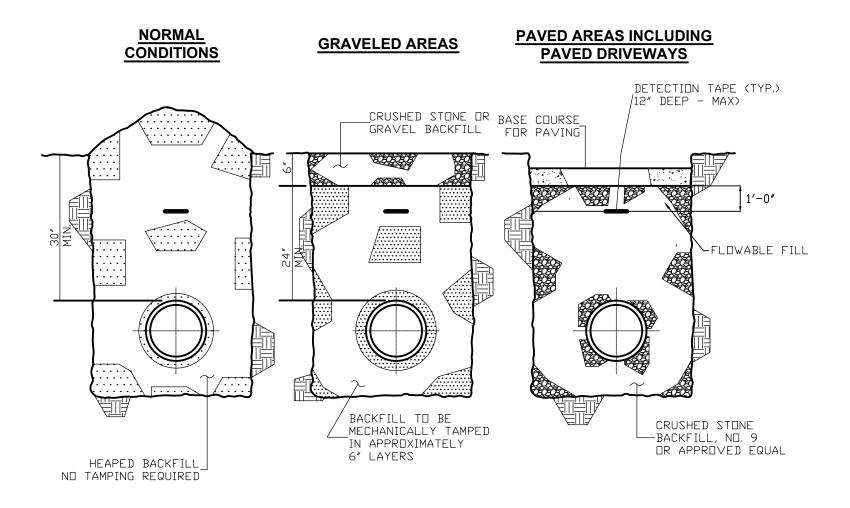


BACKFILLING DETAILS N.T.S

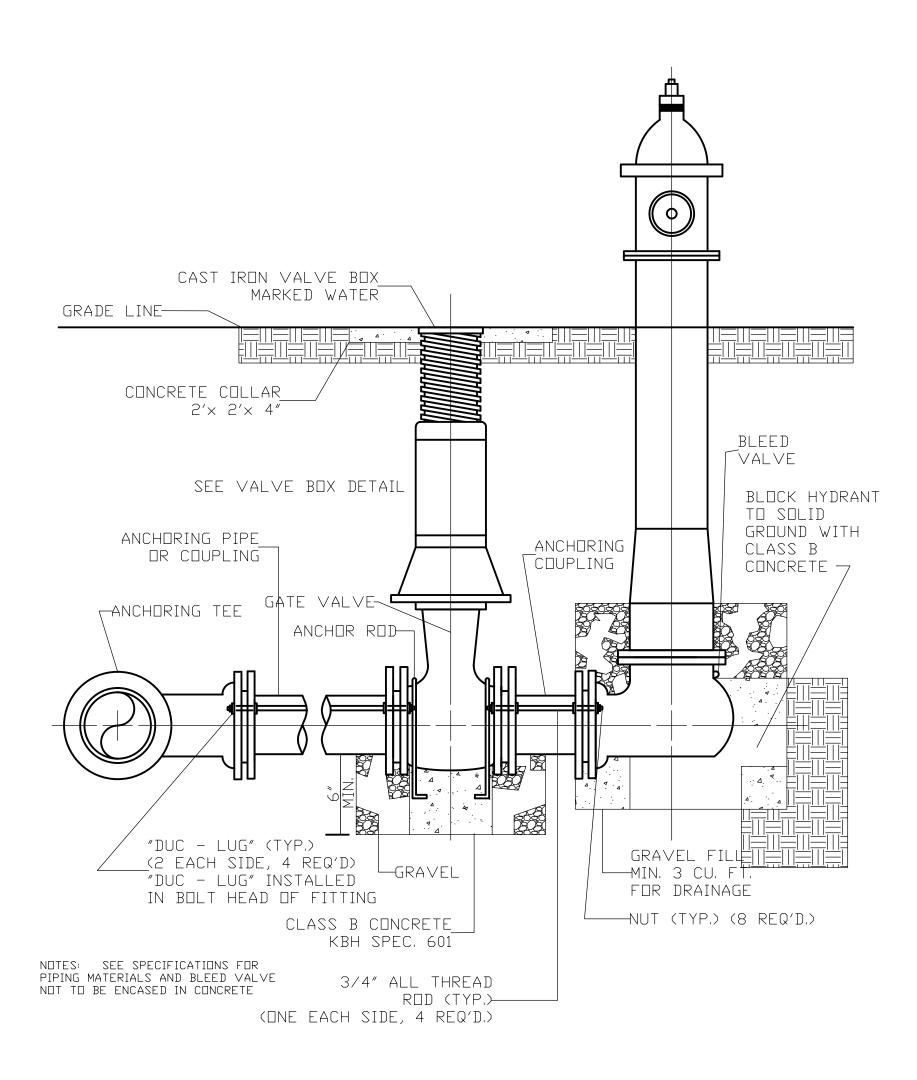

FLUSH HYDRANT DETAIL N.T.S

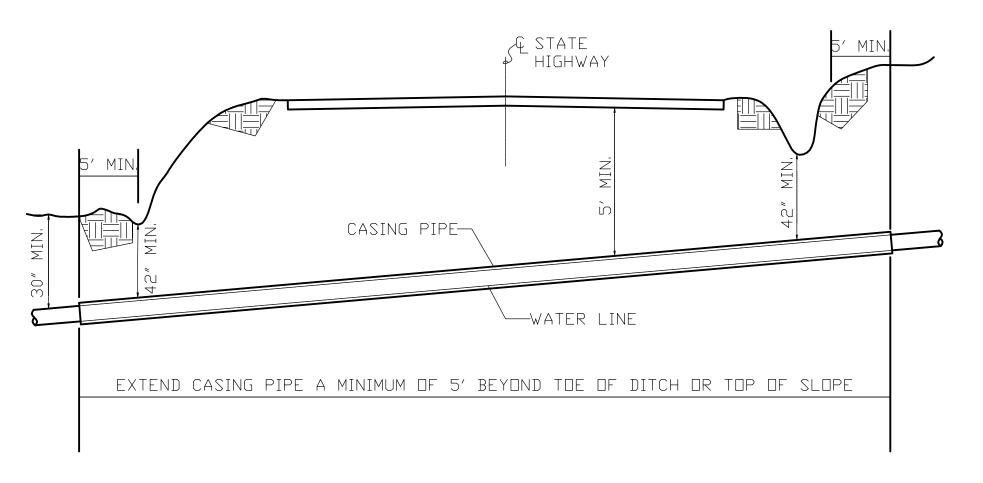

TYP. STATE HIGHWAY ENCASED BORE CROSSING N.T.S

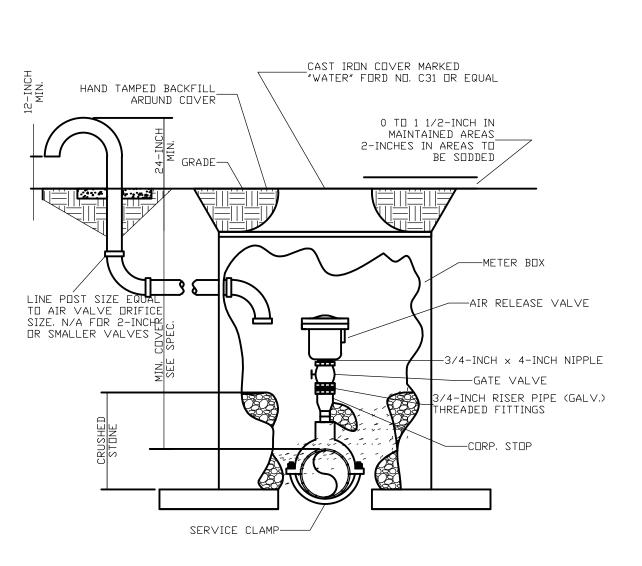

NOTE: WHERE THE WATER LINE IS LOCATED IN A STREET OR ROAD, THE AIR RELEASE

VALVE AND BOX ARE TO BE LOCATED OFF THE ROAD AS DIRECTED BY


THE

ENGINEER AND CONNECTED TO THE MAINLINE BY 3/4-INCH SERVICE PIPE.

NOTE: 2 THICK PROCENCY PEON CHEETE BROADERS PAY ITEM.


4 REQ'D. TO SUPPORT BOX OFF MAINLINE

AIR RELEASE VALVE N.T.S

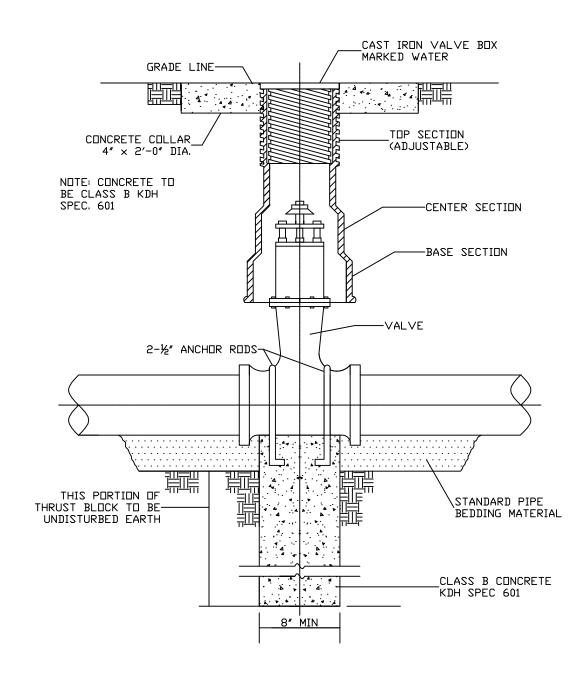



NOTE: SEE SPECIFICATION FOR PIPING MATERIALS AND PIPING JOINTS

GATE VALVE DETAIL N.T.S

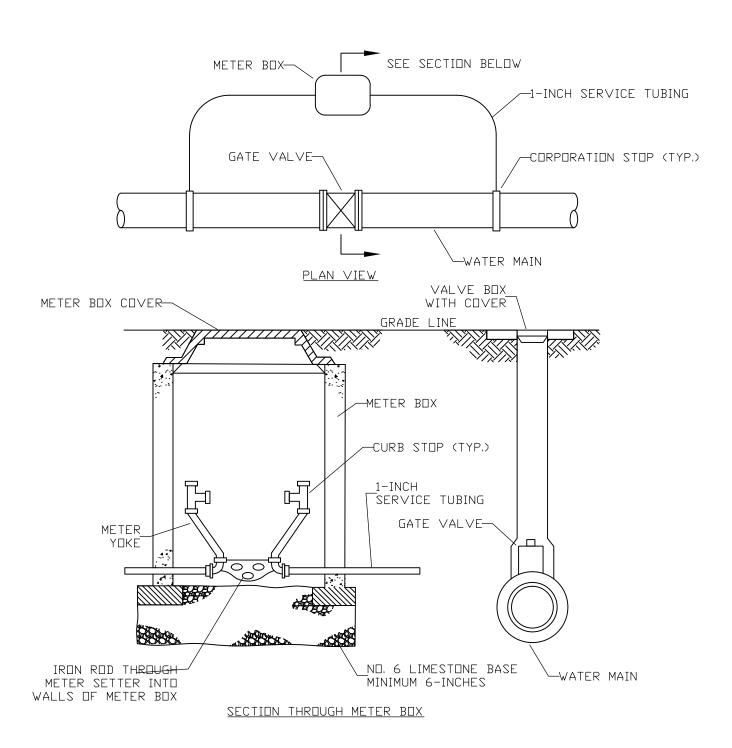


ISOLATION CHECK METER DETAIL N.T.S

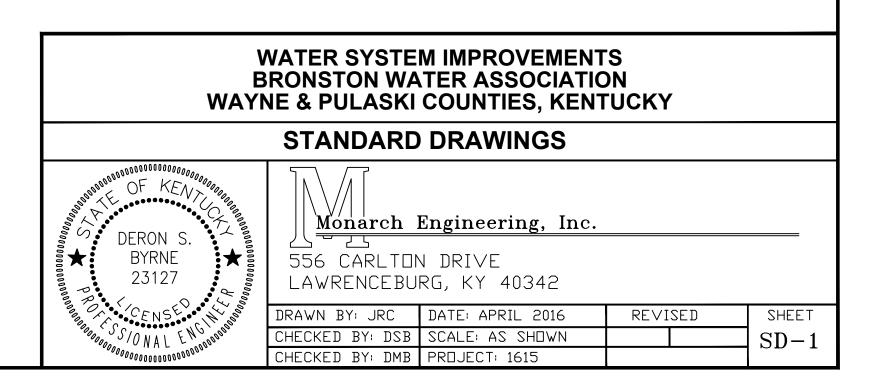

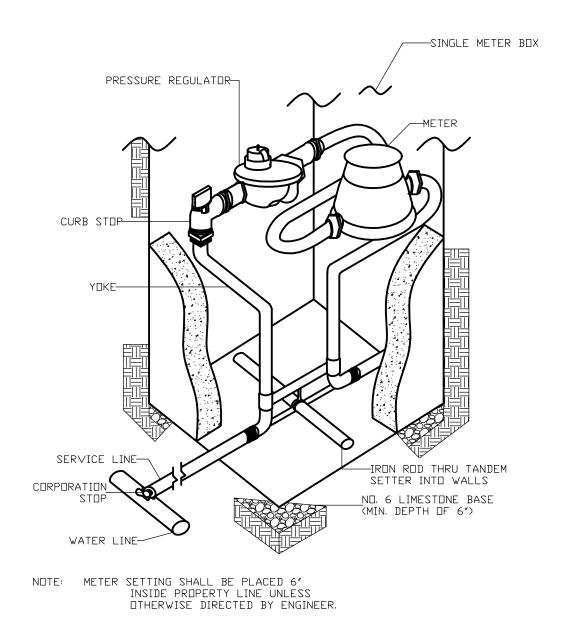


METER SETTING AND CONNECTION DETAIL N.T.S

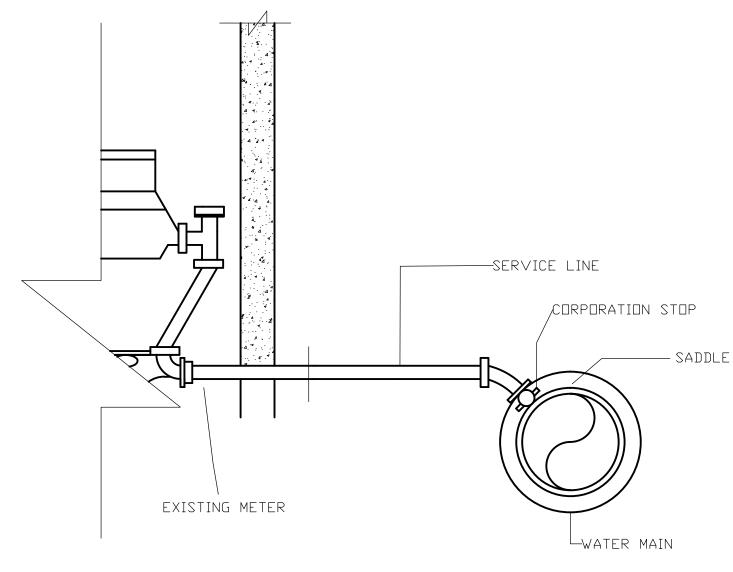


CONNECT NEW SERVICE LINE TO NEW WATER MAIN AND EXTEND TO AND CONNECT TO EXISTING METER.

SERVICE RECONNECTION DETAIL N.T.S

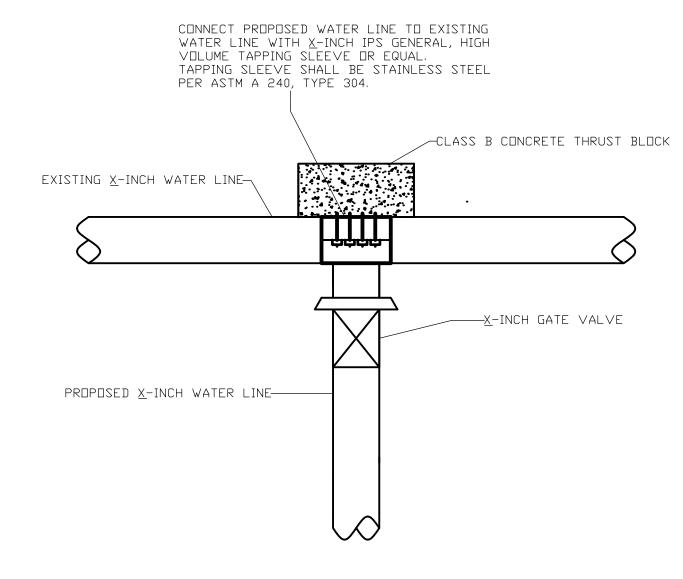


WATER LINE CONNECTION DETAIL N.T.S

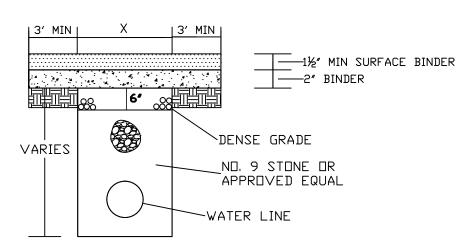


BITUMINOUS SURFACE 2" +

REPLACE BITUMINOUS PAVEMENT WITH SAME TYPE AND DEPTH AS EXISTING PAVEMENT

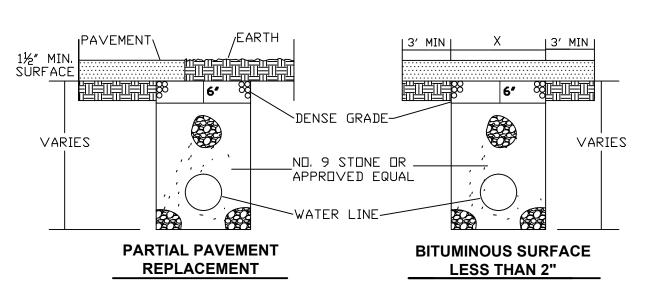


ANY TRENCH THAT DISTURBS PAVEMENT SHALL BE BACKFILLED WITH STONE


BITUMINOUS PAVEMENT REPLACEMENT DETAILS
N.T.S

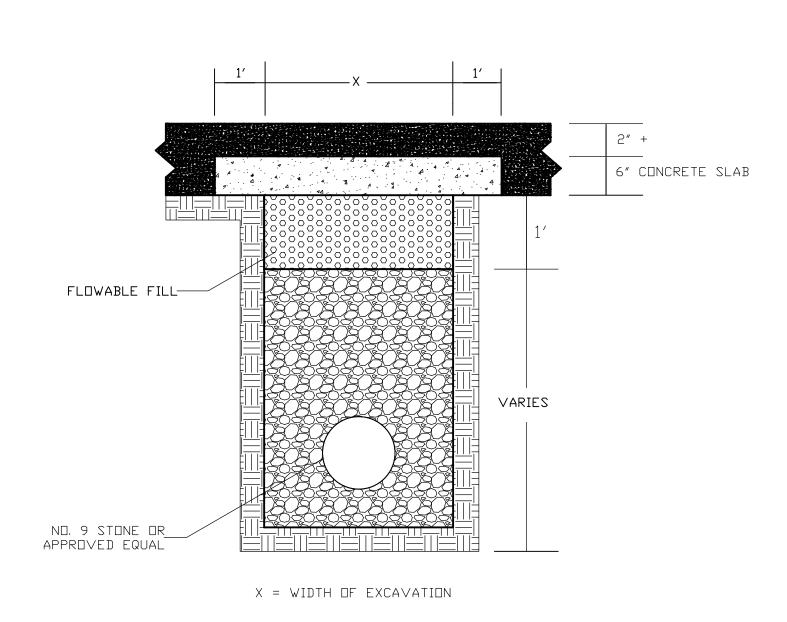

STATE HIGHWAY PAVEMENT REPLACEMENT N.T.S

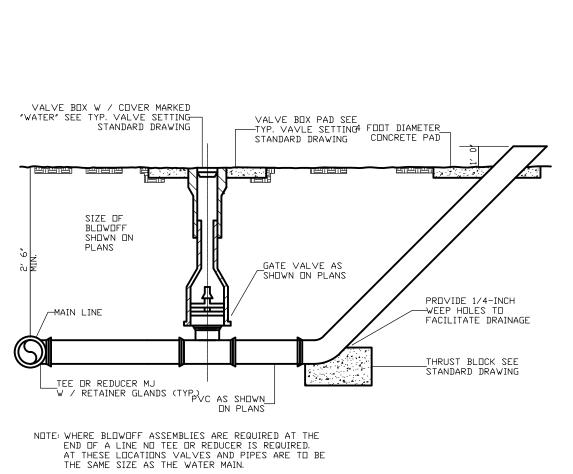


BLOWOFF DETAIL N.T.S

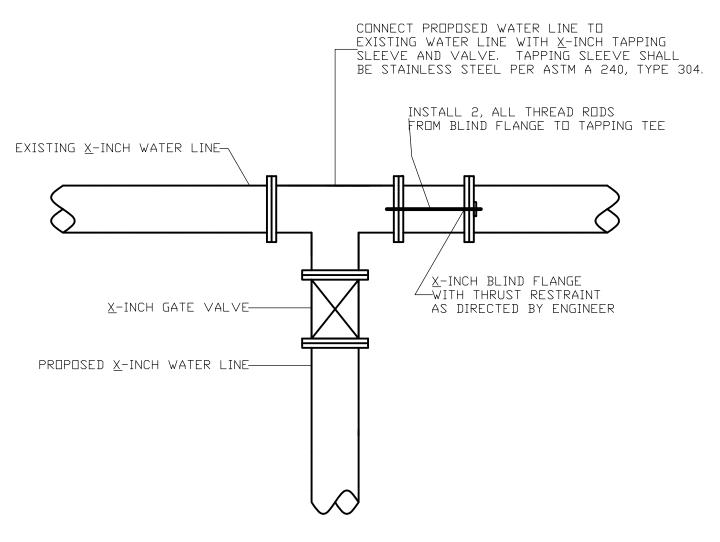

TYPE I CONNECTION DETAIL N.T.S

WATER SYSTEM IMPROVEMENTS BRONSTON WATER ASSOCIATION WAYNE & PULASKI COUNTIES, KENTUCKY

STANDARD DRAWINGS

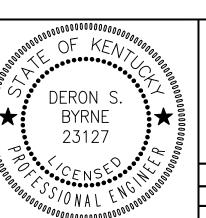

Monarch Engineering, Inc.


556 CARLTON DRIVE

DRAWN BY: JRC DATE: APRIL 2016 REVI

DRAWN BY: JRC DATE: APRIL 2016 REVISED SHEET

CHECKED BY: DSB SCALE: AS SHOWN

CHECKED BY: DMB PROJECT: 1615

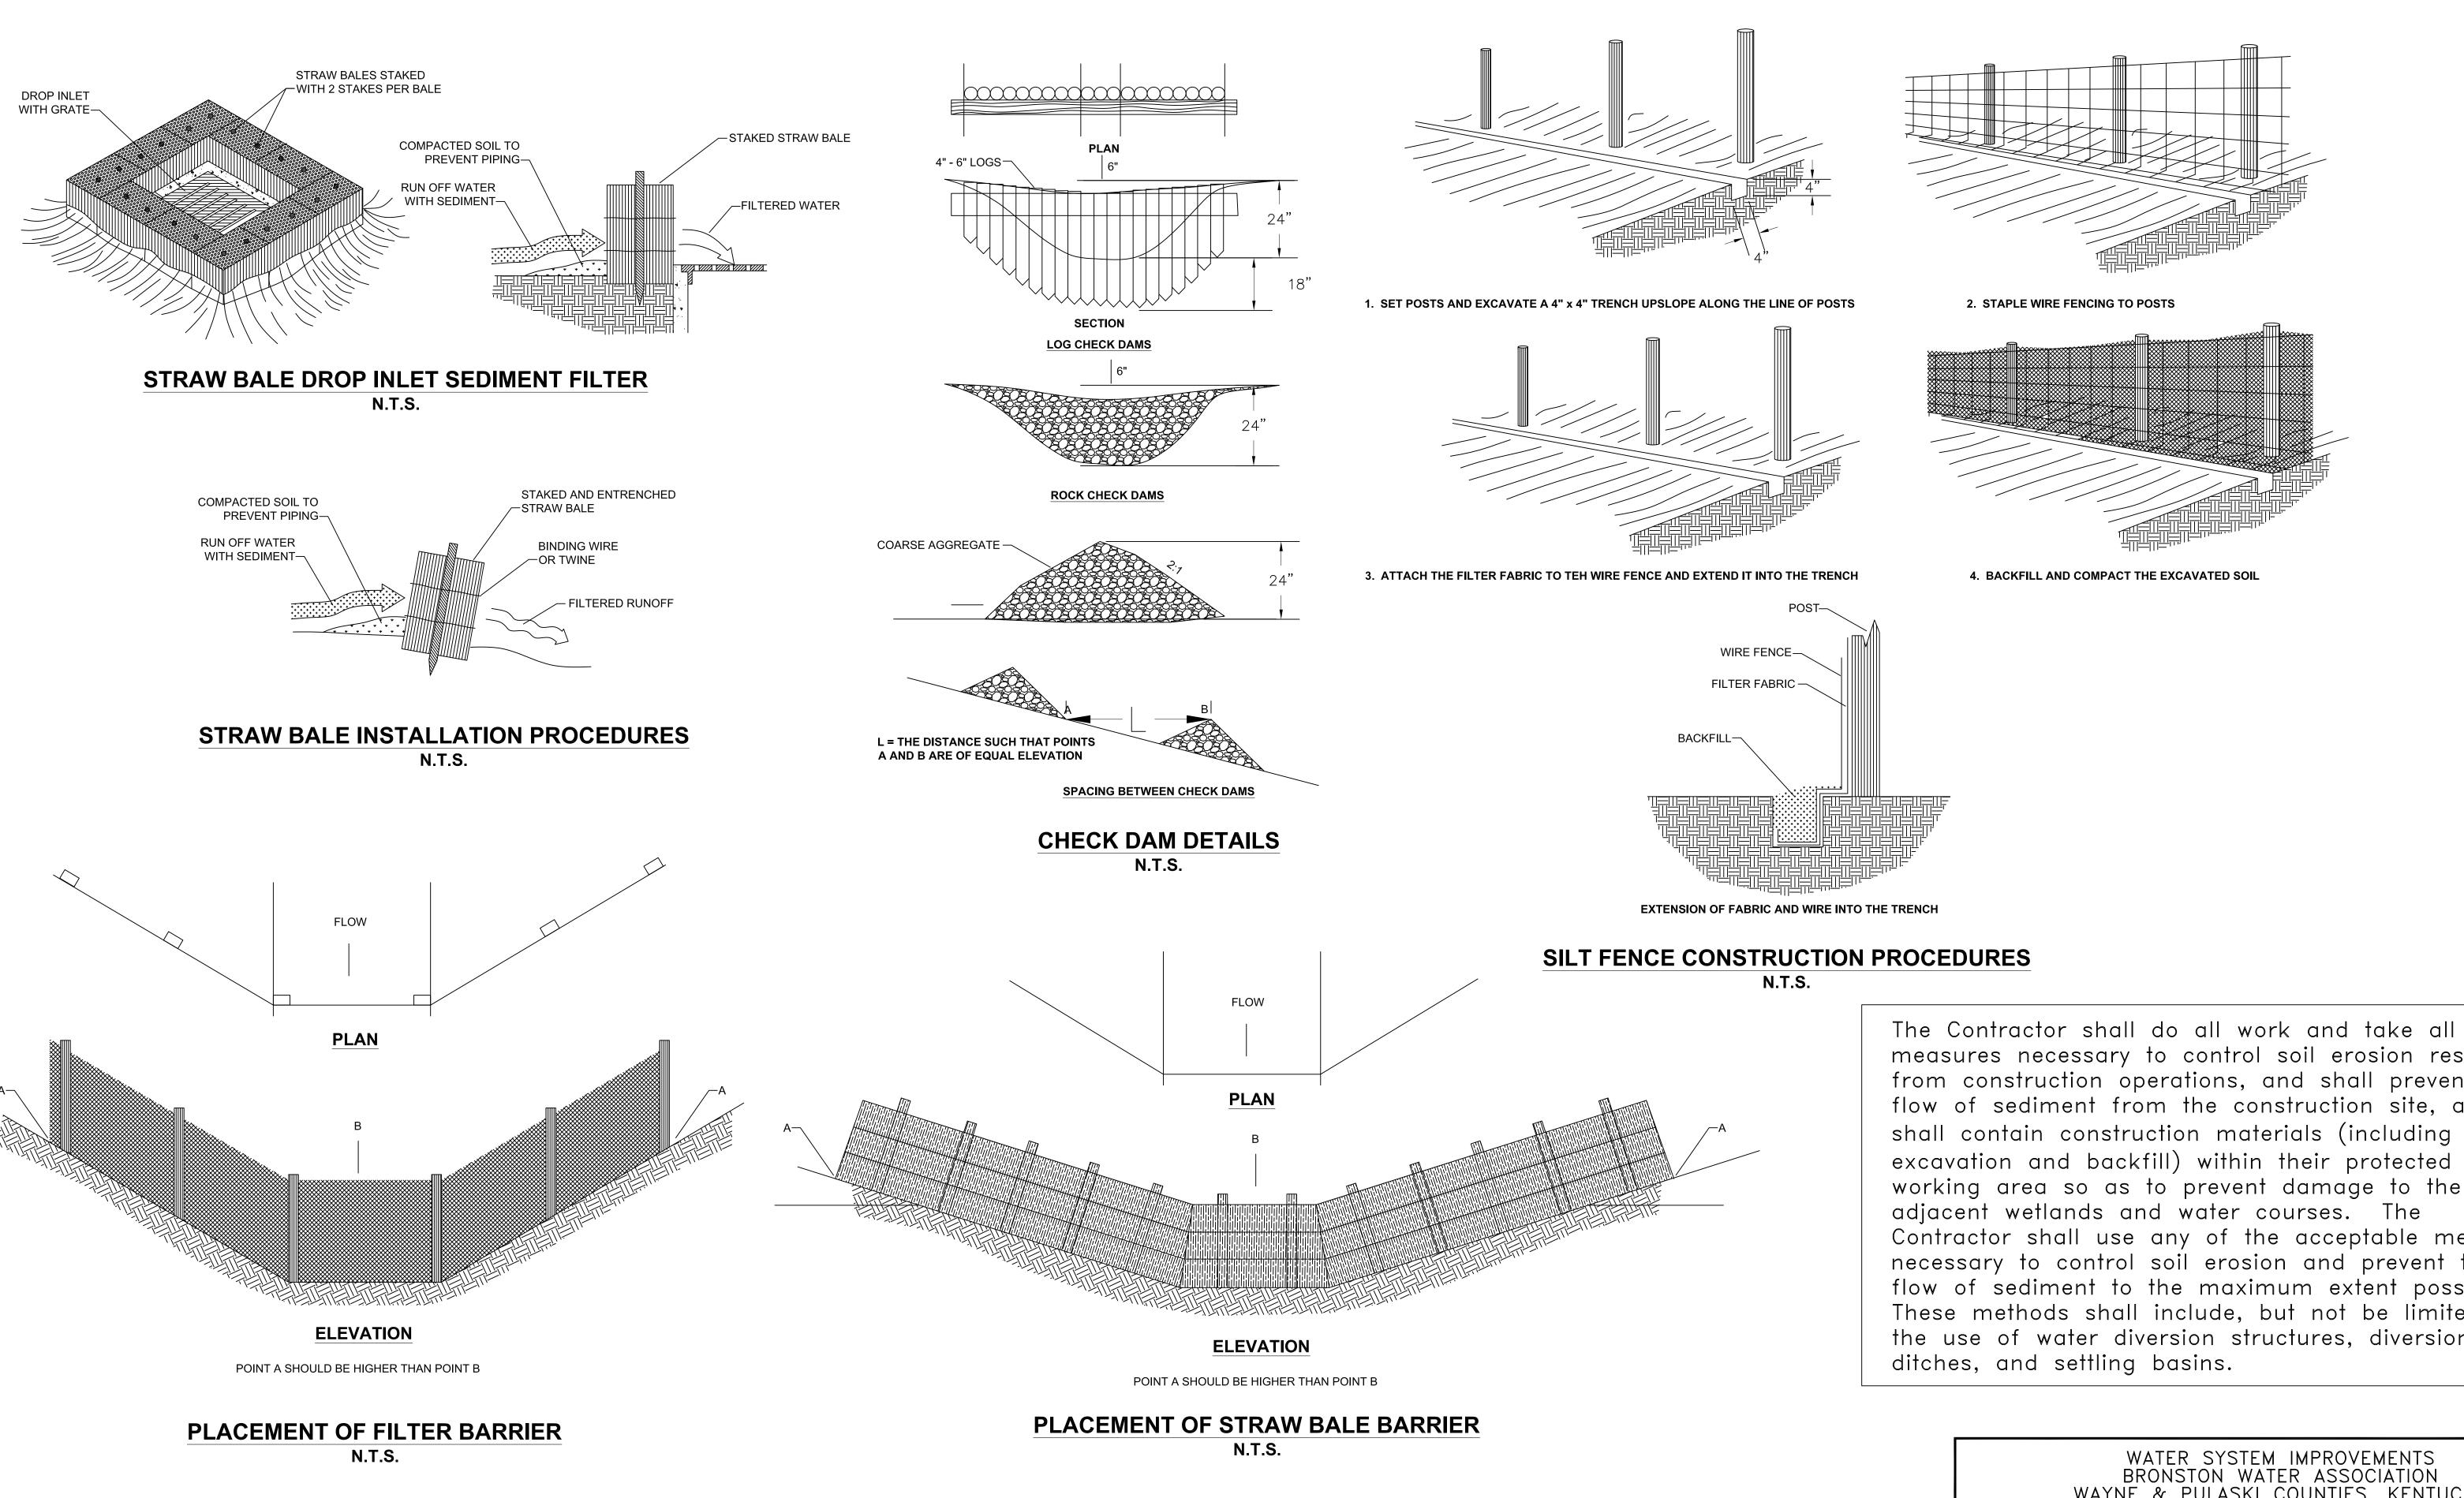


EROSION CONTROL DETAILS N.T.S.

measures necessary to control soil erosion resulting from construction operations, and shall prevent the flow of sediment from the construction site, and shall contain construction materials (including excavation and backfill) within their protected working area so as to prevent damage to the adjacent wetlands and water courses. The Contractor shall use any of the acceptable methods necessary to control soil erosion and prevent the flow of sediment to the maximum extent possible. These methods shall include, but not be limited to, the use of water diversion structures, diversion

WATER SYSTEM IMPROVEMENTS BRONSTON WATER ASSOCIATION WAYNE & PULASKI COUNTIES, KENTUCKY

EROSION CONTROL DETAILS

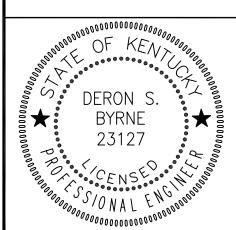

Monarch Engineering, Inc.

556 CARLTON DRIVE

LAWRENCEBURG, KY 40342

DRAWN BY: JRC DATE: APRIL 2016 SHEET CHECKED BY: DSB SCALE: AS SHOWN EC-1CHECKED BY: DMB PROJECT: 1615

2017 WATER SYSYEM IMPROVEMENTS: BRONSTON WATER ASSOCIATION CONTRACT 2 500,000 GALLON WATER STORAGE TANK REPLACEMENT PULASKI COUNTY, KENTUCKY

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COVER
GENERAL NOTES
SITE PLAN
TANK DETAIL, TOPO MAP

STANDARD DRAWINGS FENCE DETAIL

FENCE DETAIL F-1
EROSION CONTROL EC-1

THIS PROJECT FUNDED BY:

U.S.D.A. RURAL DEVELOPEMENT

BRONSTON WATER ASSOCIATION

CARTER STEWART, PRESIDENT

CLINT KEITH ERIC KEITH CHARLES CASSADA LELAND KEITH


OFFICE SECRETARY - VICKIE RAMSEY
GENERAL MANAGER - DAVID SLAGLE
SUPERINTENDENT - J.C. NEW

SEPT 2016



556 CARLTON DRIVE LAWRENCEBURG, KY 40342

LOCATION MAP

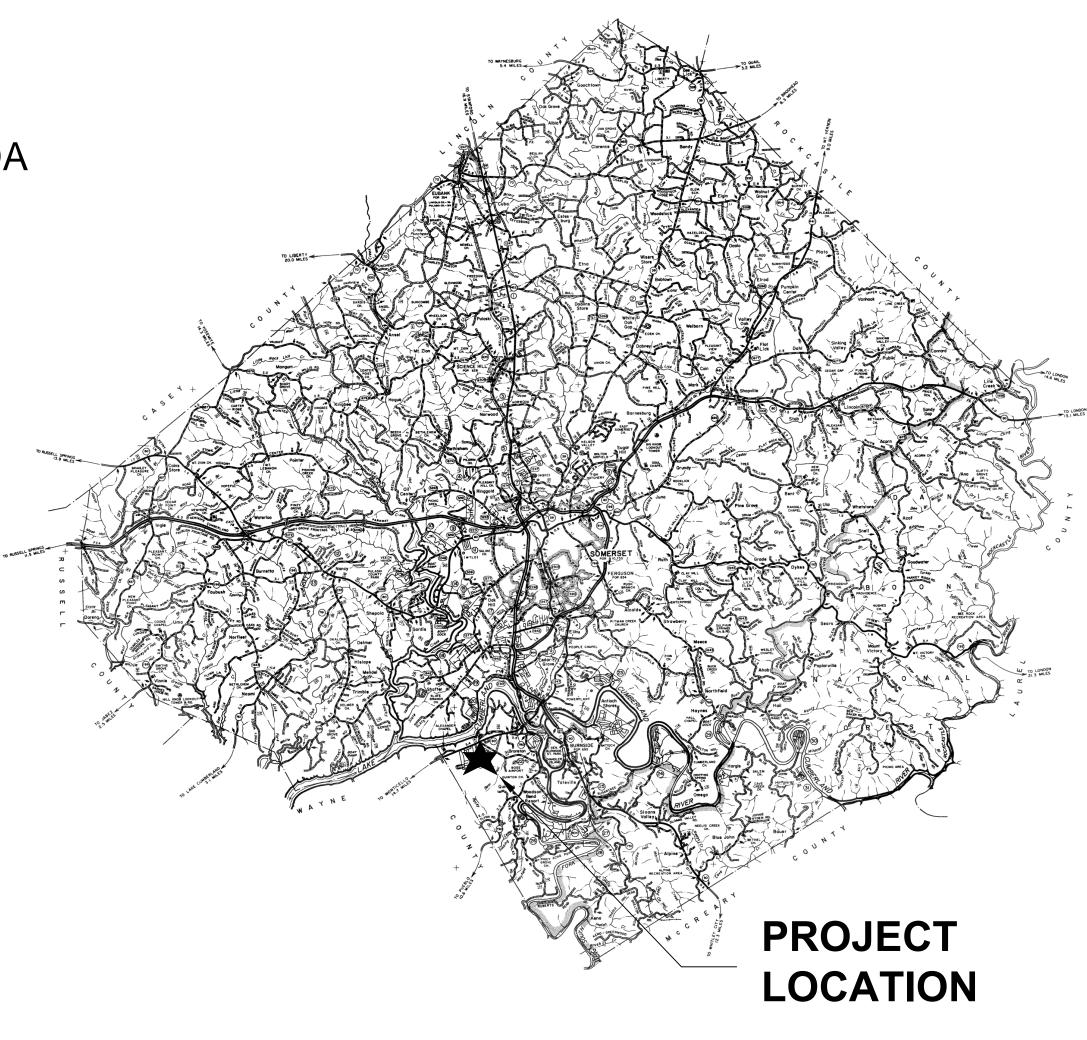

RECORD DRAWINGS

LOCATION AND SCOPE OF PROJECT

THE PROJECT LOCATION IS GENERALLY DEFINED AS BRONSTON, PULASKI COUNTY, KENTUCKY. THE WORK TO BE DONE UNDER THIS CONTRACT INCLUDES FURNISHING ALL MATERIALS, EQUIPMENT, AND LABOR NECESSARY TO CONSTRUCT THE 500,000 WATER STORAGE TANK IN ACCORDANCE WITH THE PLANS, SPECIFICATIONS AND CONTRACT DOCUMENTS.

GENERAL NOTES

- 1. IT IS THE INTENTION OF THESE PLANS TO CONSTRUCT ALL WORK IN ACCORDANCE WITH ALL APPLICABLE REQUIREMENTS OF THE WESTERN PULASKI COUNTY WATER DISTRICT, PULASKI COUNTY AND THE KENTUCKY DEPARTMENT FOR ENVIRONMENTAL PROTECTION. WHERE THERE IS A CONFLICT BETWEEN THE CONTRACT DOCUMENTS, PLANS, AND SPECIFICATIONS AND THE PERMIT REQUIREMENTS OF THE AGENCY CONTROLLING THE UTILITY OR RESPECTIVE RIGHTS—OF—WAY, THE MORE RESTRICTIVE SHALL GOVERN
- 2. THE CONTRACTOR AND ANY APPLICABLE SUBCONTRACTORS SHALL ATTEND A PRE-CONSTRUCTION MEETING AT A TIME AND PLACE ARRANGED BY THE ENGINEER, IN WHICH ALL AFFECTED PARTIES WILL BE PRESENT. ALSO, A PRE-DISTRUBANCE WALK THROUGH WILL NEED TO BE ATTENDED BY THE CONTRACTOR.
- 3. FOLLOWING THE PRE-CONSTRUCTION MEETING, THE CONTRACTOR SHALL NOTIFY THE ENGINEER A MINIMUM OF THREE (3) WORKING DAYS PRIOR TO THE START OF CONSTRUCTION FOR INSPECTION COORDINATION. NO WORK CAN COMMENCE UNTIL ALL PERMITS HAVE BEEN OBTAINED AND THE CONTRACTOR HAS BEEN GIVEN THE AUTHORITY TO PROCEED.
- 4. THE CONTRACTOR SHALL NOTIFY KENTUCKY 811 AT LEAST 72 HOURS IN ADVANCE OF CONSTRUCTION, FOR LOCATION AND MARKING OF ALL EXISTING UTILITIES.
- 5. LOCATIONS AND ELEVATIONS OF EXISTING UNDERGROUND UTILITIES AS SHOWN ON THE PLANS ARE APPROXIMATE. NO GUARANTEE IS EITHER EXPRESSED OR IMPLIED AS TO THE COMPLETENESS OR ACCURACY THEREOF. THE CONTRACTOR SHALL BE EXCLUSIVELY RESPONSIBLE FOR DETERMINING AND VERIFYING THE LOCATION, DEPTH, AND ELEVATION OF THE EXISTING UTILITIES WITHIN THE CONSTRUCTION AREA PRIOR TO THE START OF CONSTRUCTION. THE CONTRACTOR SHALL NOTIFY THE ENGINEER IF ANY CONFLICTS ARE APPARENT OR IF LOCATIONS AND DEPTHS DIFFER SIGNIFICANTLY FROM THE PLANS.
- 6. ALL ELEVATIONS REFER TO THE CURRENT NORTH AMERICAN VERTICAL DATUM OF 1988 (NAVD '88).
- 7. THE ENGINEER HAS NOT PERFORMED PROPERTY OR RIGHT-OF-WAY SURVEYS FOR ANY OF THE AREAS INCLUDED IN THIS PROJECT. RIGHT-OF-WAY OR PROPERTY LINES SHOWN ON THE PLANS ARE APPROXIMATE AND ARE SHOWN FOR GENERAL ORIENTATION ONLY. PROPERTY CORNERS OR OTHER SURVEY MARKERS HAVE NOT BEEN LOCATED, UNLESS SPECIFICALLY CALLED OUT ON THE PLANS.
- 8. ALL PROPERTIES OR FACILITIES IN THE SURROUNDING AREAS, PUBLIC OR PRIVATE, DESTROYED OR OTHERWISE DAMAGED BY THE CONTRACTORS OPERATIONS SHALL BE REPLACED OR REPAIRED BY THE CONTRACTOR AT THEIR OWN EXPENSE TO THE SATISFACTION OF THE AUTHORITY HAVING JURISDICTION OVER THE IMPACTED PROPERTY OR FACILITY.
- 9. IF, IN THE OPINION OF THE ENGINEER, WORK HAS NOT PROGRESSED IN A REASONABLE AND TIMELY MANNER, THE ENGINEER SHALL HAVE THE RIGHT, WITH THE APPROVAL OF THE OWNER, TO DIRECT THE CONTRACTOR TO PROCEED WITH THE WORK OR ANY PORTION THEREOF IMMEDIATELY. IN THE EVENT THAT THE CONTRACTOR DOES NOT PROCEED WITH THE WORK IMMEDIATELY, AS DIRECTED BY THE ENGINEER, THE ENGINEER, UNDER THE DIRECTION OF THE OWNER, MAY ORDER ANY OR ALL OTHER OPERATIONS OF THE CONTRACTOR, UNDER THIS CONTRACT, TO CEASE UNTIL THE REQUESTED WORK IS PROCEEDING IN AN ACCEPTABLE MANNER. SHOULD THE CONTRACTOR FAIL TO COMPLY WITH THESE PROVISIONS, THE OWNER MAY, WITH OR WITHOUT NOTICE, CAUSE THE REQUIRED WORK TO BE DONE BY THE OWNER OR OTHERS AND WILL DEDUCT THE COST OF SAID WORK FROM ANY FUNDS DUE OR TO BECOME DUE THE CONTRACTOR UNDER THIS CONTRACT. THE PERFORMANCE OF SUCH WORK BY THE OWNER OR OTHERS SHALL SERVE IN NO WAY TO RELEASE THE CONTRACTOR FROM HIS GENERAL OF PARTICULAR LIABILITY FOR THE SAFETY OF THE PUBLIC OR COMPLETION OF THE WORK.
- 10. ACTIONS MUST BE TAKEN TO MINIMIZE THE TRACKING OF MUD AND SOIL FROM CONSTRUCTION AREAS ONTO PUBLIC ROADWAYS. ANY SOIL TRACKED ONTO A PUBLIC ROADWAY SHALL BE REMOVED DAILY.
- 11. ALL WORK SHALL BE INCORPORATED IN TO THOSE UNIT PRICES LISTED IN THE CONTRACT DOCUMENTS. ANY ITEMS NOT SPECIFICALLY LISTED IN THE UNIT PRICES SHALL BE CONSIDERED INCIDENTAL TO THE WORK AND SHALL NOT BE ELIGIBLE FOR SEPARATE PAYMENT OR COMPENSATION.

EROSION AND SEDIMENTATION CONTROL NOTES

- 1. THE CONTRACTOR SHALL COMPLY WITH ALL EROSION AND SEDIMENTATION CONTROL REQUIREMENTS OF THE BOTH THE STATE OF KENTUCKY AND THE U.S. ARMY CORPS OF ENGINEERS FOR ALL DISTRUSTED AREAS INCLUDED IN THE PROJECT.
- 2. THE CONTRACTOR SHALL CONDUCT CONSTRUCTION OPERATIONS IN A MANNER THAT WILL REDUCE ACCELERATED EROSION TO THE PRACTICAL MINIMUM AND PREVENT DAMAGING SILTATION TO EXISTING SEWERS AND WATER COURSES LEADING FROM THE PROJECT AREA.
- 3. THE CONTRACTOR SHALL CONDUCT WORK IN SUCH A MANNER AS TO PREVENT THE ENTRY OF FUELS, OILS, BITUMINOUS MATERIALS, CHEMICALS, SEWERAGE, OR OTHER HARMFUL MATERIALS INTO NEARBY LAKES AND STREAMS
- 4. WASTE DISPOSAL AREAS SHALL BE SELECTED BY THE CONTRACTOR WITH FULL CONSIDERATION OF EROSION AND SEDIMENT CONTROL, SELECTION OF DISPOSAL SITE(S), AND CONTROL OF OPERATIONS, AND THE RESTORATION OF SAID AREAS SHALL BE SUBJECT TO APPROVAL OF THE ENGINEER.
- 5. EXCAVATIONS FROM THE PROJECT AREA INCLUDING THOSE IN CHANNELS AND WATERCOURSES SHALL NOT BE DEPOSITED IN OR NEAR RIVERS, STREAMS, OR PONDS WHERE IT MAY ENTER THE WATERWAY.
- 6. AT THE COMPLETION OF EACH DAYS CONSTRUCTION, CARE SHOULD BE TAKEN TO ENSURE THAT MINIMAL EROSION WILL OCCUR IN TRENCHES AND TO STOCKPILED MATERIALS UNTIL RESUMPTION OF WORK.
- 7. THE CONTRACTOR SHALL CONFINE CONSTRUCTION OPERATIONS TO THE MINIMUM AMOUNT OF WORKING SPACE PRACTICAL TO AID IN THE MINIMIZATION OF SOIL EROSION.
- 8. THE PROJECT WILL BE CONTINUALLY OBSERVED BY VARIOUS STATE & LOCAL REGULATORY AGENCIES FOR EROSION CONTROL COMPLIANCE. DEFICIENCIES WILL BE CORRECTED BY THE CONTRACTOR IMMEDIATELY UPON NOTICE OF SUCH DEFICIENCIES. FAILURE TO CORRECT THE DEFICIENCIES MAY RESULT IN THE ISSUANCE OF A STOP WORK ORDER AND THERE WILL BE NO CONTRACT TIME EXTENSION GRANTED FOR THIS TYPE OF STOPPAGE.
- 9. TEMPORARY SOIL EROSION CONTROL MEASURES CONSISTING OF SILT FENCE, MULCHING, AND TARPING SHALL BE IMPLEMENTED THROUGHOUT THE ENTIRE CONSTRUCTION AREA OF THE PROJECT, AND SHALL BE REMOVED BY THE CONTRACTOR AFTER THE PERMANENT SOIL EROSION MEASURES HAVE BEEN ESTABLISHED.
- 10. PERMANENT SOIL EROSION MEASURES CONSISTING OF AN APPROVED SEED MIXTURE AND MULCH BLANKET SHALL BE COMPLETED WITHIN FIVE (5) CALENDAR DAYS OF FINAL GRADING. IN THE EVENT IT IS NOT POSSIBLE TO PERMANENTLY STABILIZE THE AREA DUE TO SITE CONDITIONS OR SEASONAL LIMITATIONS, THE TEMPORARY MEASURES SHALL REMAIN IN FORCE AND SHALL BE MAINTAINED BY THE CONTRACTOR UNTIL SUCH TIME IT IS PRACTICAL TO COMPLETE THE PERMANENT SOIL EROSION CONTROL
- 11. THE ENGINEER SHALL HAVE FULL AUTHORITY TO TEMPORARILY SUSPEND WORK IN THE EVENT THAT ANY OF THE ABOVE REQUIREMENTS ARE NOT BEING MET BY THE CONTRACTOR, OR IF CONDITIONS INDICATE THAT ADDITIONAL TEMPORARY MEASURES ARE WARRANTED, IN THE OPINION OF THE ENGINEER OR REGULATORY AGENCIES.
- 12. PRIOR TO THE START OF CONSTRUCTION, THE CONTRACTOR SHALL INSTALL INLET FILTERS AT ALL STORM SEWER INLETS WHICH MAY BE PRESENT IN THE CONSTRUCTION AREA.
- 13. THE CONTRACTOR SHALL BE RESPONSIBLE FOR THE MAINTENANCE OF ANY REQUIRED ACCESS ROAD SURFACES AND SOIL EROSION CONTROL MEASURES WITHIN THE CONSTRUCTION AREA UNTIL THE FULL COMPLETION OF THE PROJECT.
- 14. ALL NON-PAVED DISTURBED AREAS SHALL BE RESTORED AS INDICATED ON THE PLANS. IF NOT SPECIFICALLY STATED ON THE PLANS, RESTORATION SHALL CONSIST OF 4-INCHES OF TOPSOIL, FERTILIZER, SEED AND MULCH. UNLESS OTHERWISE STATED, ALL DISTURBED AREAS SHALL BE SEEDED WITH A SEED MIX APPROVED BY THE ENGINEER.

WORK LIMITS

IF INDICATED ON THE PLANS, THE CONTRACTOR SHALL KEEP ALL OPERATIONS WITHIN THE WORK LIMITS SHOWN. OTHERWISE, THE CONTRACTOR SHALL ESTABLISH CONSTRUCTION LIMITS WITHIN THE EXISTING AND/OR PROPOSED RIGHTS—OF—WAY AND EASEMENTS AS DIRECTED BY THE ENGINEER. THIS REQUIREMENT SHALL INCLUDE MATERIAL STOCKPILING AND EQUIPMENT STORAGE. THE CONTRACTOR MAY NOT EXIT THE ESTABLISHED PROJECT WORK LIMITS WITHOUT EXPLICIT PERMISSION FROM THE OWNER AND THE ENGINEER.

UTILITIES

FOR PROTECTION OF UNDERGROUND UTILITIES AND IN CONFORMANCE WITH KENTUCKY LAW, THE CONTRACTOR SHALL SHALL DAIL KENTUCKY 811 A MINIMUM OF THREE (3) FULL WORKING DAYS, EXCULDING SATURDAYS, SUNDAYS, AND HOLIDAYS, PRIOR TO BEGINNING WORK IN EACH CONSTRUCTION AREA WHERE PUBLIC UTILITIES HAVE NOT BEEN PREVIOUSLY LOCATED. MEMBERS WILL THUS BE ROUTINELY NOTIFIED. THIS DOES NOT RELIEVE THE CONTRACTOR OF THE RESPONSIBILITY OF NOTIFYING UTILITY OWNERS WHO MAY NOT BE PART OF THE 'KY 811" ALERT SYSTEM. UTILITY LOCATIONS SHOWN ON THE PLANS ARE ONLY APPROXIMATE AND SHOULD BE LOCATED IN THE FIELD PRIOR TO ANY EXCAVATION.

WORK WITHIN STREAMS, CREEKS & WATERWAYS

ANY AND ALL WORK TO BE COMPLETED WITHIN STREAMS, CREEKS & WATERWAYS SHALL BE COMPLETED ONLY DURING TIMES OF LOW FLOW AS DETERMINED BY THE ENGINEER. THE CONTRACTOR SHALL STRICTLY LIMIT THE USE OF HEAVY EQUIPMENT WITHIN THE WATERCOURSE AT ALL TIMES. STREAM FLOW SHALL NOT BE RESTRICTED OR IMPEDED AT ANY TIME DURING THE COURSE OF CONSTRUCTION.

DISRUPTION OF SERVICE

THE CONTRACTOR SHALL COORDINATE ALL DISRUPTIONS OF SERVICE WITH THE OWNER AND ENGINEER. PRIOR TO ANY DISRUPTION, THE CONTRACTOR SHALL INFORM BOTH PARTIES OF HIS INTENTIONS, METHODS AND PROJECTED DURATION OF DISTURBANCE AND RECEIVE THEIR APPROVAL PRIOR TO INITIATING THE SPECIFIC WORK.

WORK WITHIN PUBLIC ROAD RIGHT-OF-WAYS

WHEN PERFORMING WORK ALONG OR ACROSS ANY PUBLIC ROADWAY, THE CONTRACTOR SHALL POST WARNING SIGNS PAINTED ORANGE AND THEY SHALL BE FOUR FEET BY FOUR FEET MOUNTED ON POSTS IN ACCORDANCE WITH THE KENTUCKY TRANSPORTATION DEPARTMENT'S MANUAL ON UNIFORM TRAFFIC CONTROL DEVICES. THE SIGNS SHALL BE AS FOLLOWS:

- CAUTION PIPELINE CONSTRUCTION 1500 FEET
 CAUTION PIPELINE CONSTRUCTION 1000 FEET
- 3) CAUTION PIPELINE CONSTRUCTION 500 FEET

ALL SIGNS, BARRICADES, LIGHTS, AND TRAFFIC CONTROL SHALL BE INSTALLED IN ACCORDANCE WITH THE KENTUCKY TRANSPORTATION DEPARTMENT'S MANUAL ON UNIFORM TRAFFIC CONTROL DEVICES.


THE CONTRACTOR SHALL MAINTAIN TWO FLAG MEN AT ALL TIMES WHERE MACHINERY IS IN OPERATION WHERE THE FLOW OF TRAFFIC WILL BE DISTURBED. THERE IS NO EXCEPTION TO THIS REQUIREMENT. THE USE OF RADIOS WILL BE REQUIRED WHEN VISUAL CONTACT BETWEEN THE FLAGMEN DOES NOT EXIST.


THE CONTRACTOR SHALL BE RESPONSIBLE FOR KEEPING ENTIRE ROADWAY FREE AND CLEAR AT THE END OF EACH WORKING DAY. NO EQUIPMENT SHALL BE LEFT ON OR PARKED ALONG THE ROAD RIGHT OF WAY. AT THE COMPLETION OF EACH WORK DAY, THE CONTRACTOR SHALL BACKFILL ALL OPEN TRENCHES AND INSTALL ALL TRAFFIC CONTROL SIGNS, BARRICADES, AND LIGHTS IN ACCORDANCE WITH THE KENTUCKY TRANSPORTATION DEPARTMENT'S MANUAL ON UNIFORM TRAFFIC CONTROL DEVICES.

PROJECT LOCATION MAPS

TANK SITE LAT: 36°58'25" N LONG: 84°39'10" W

TANK SITE-

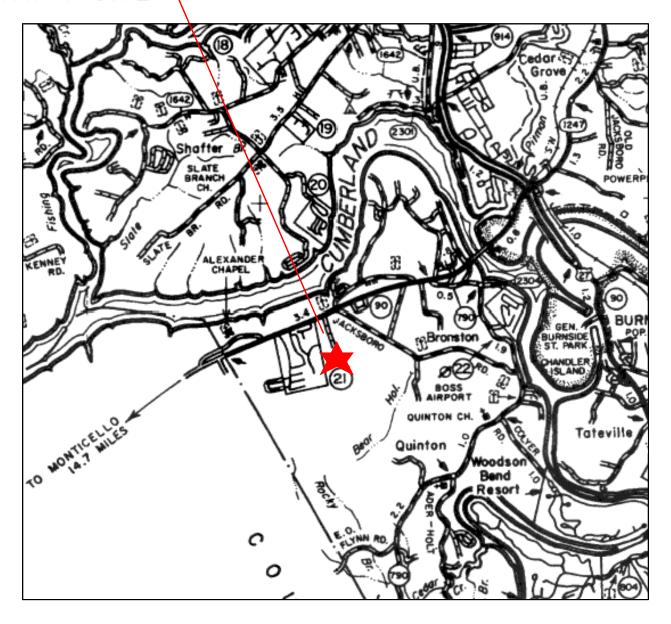

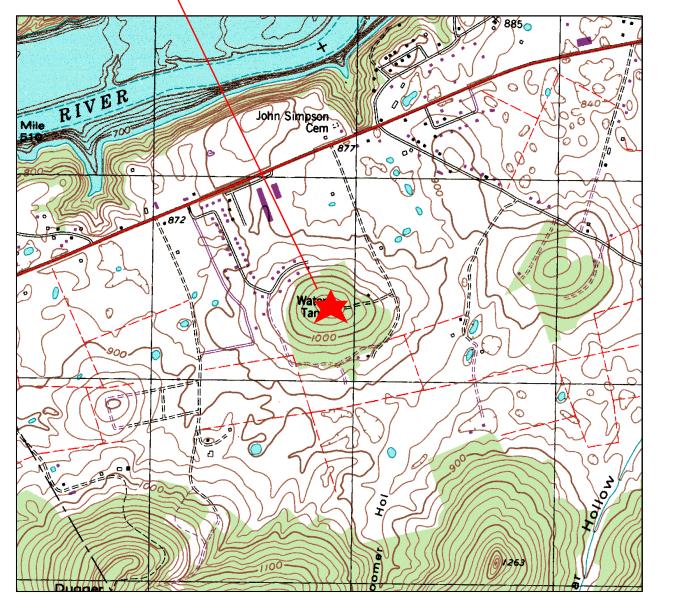

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MER: STERN PULASKI COUNTY WATER DISTI PULASKI COUNTY, KENTUCKY

PROJECT NO. 1534
DATE: MARCH 2016
DRAWN BY: JRC
CHECKED BY: DSB


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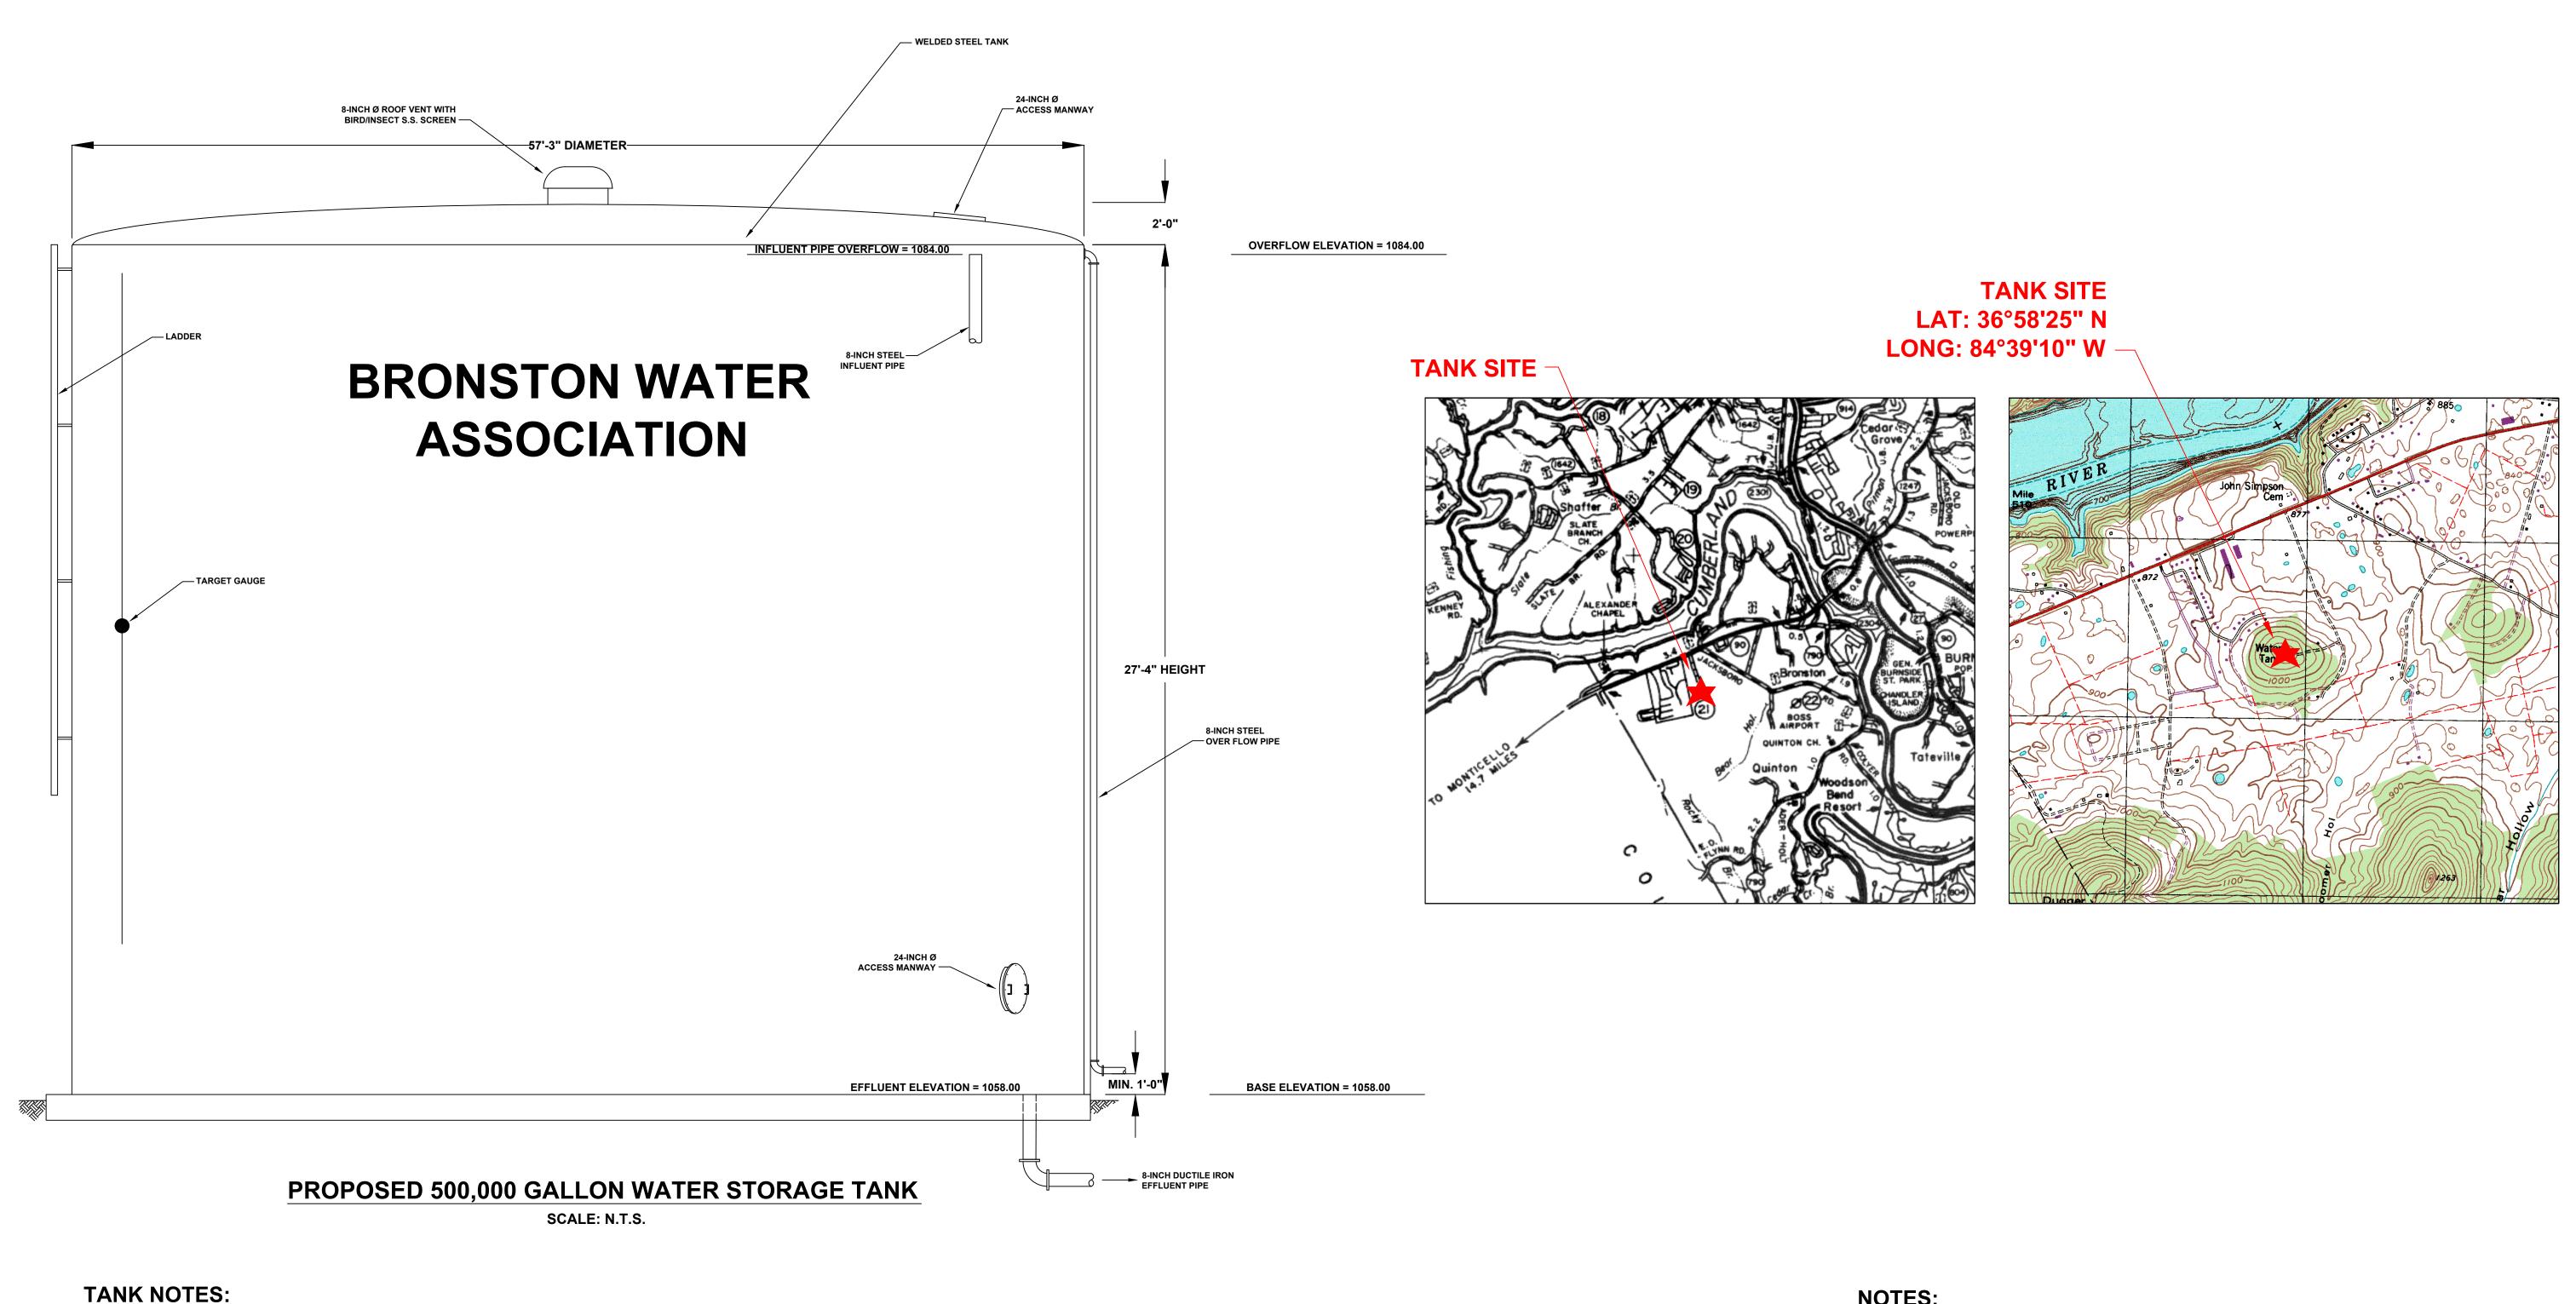
SCALE: AS NOTED

SHEET:

GN-1





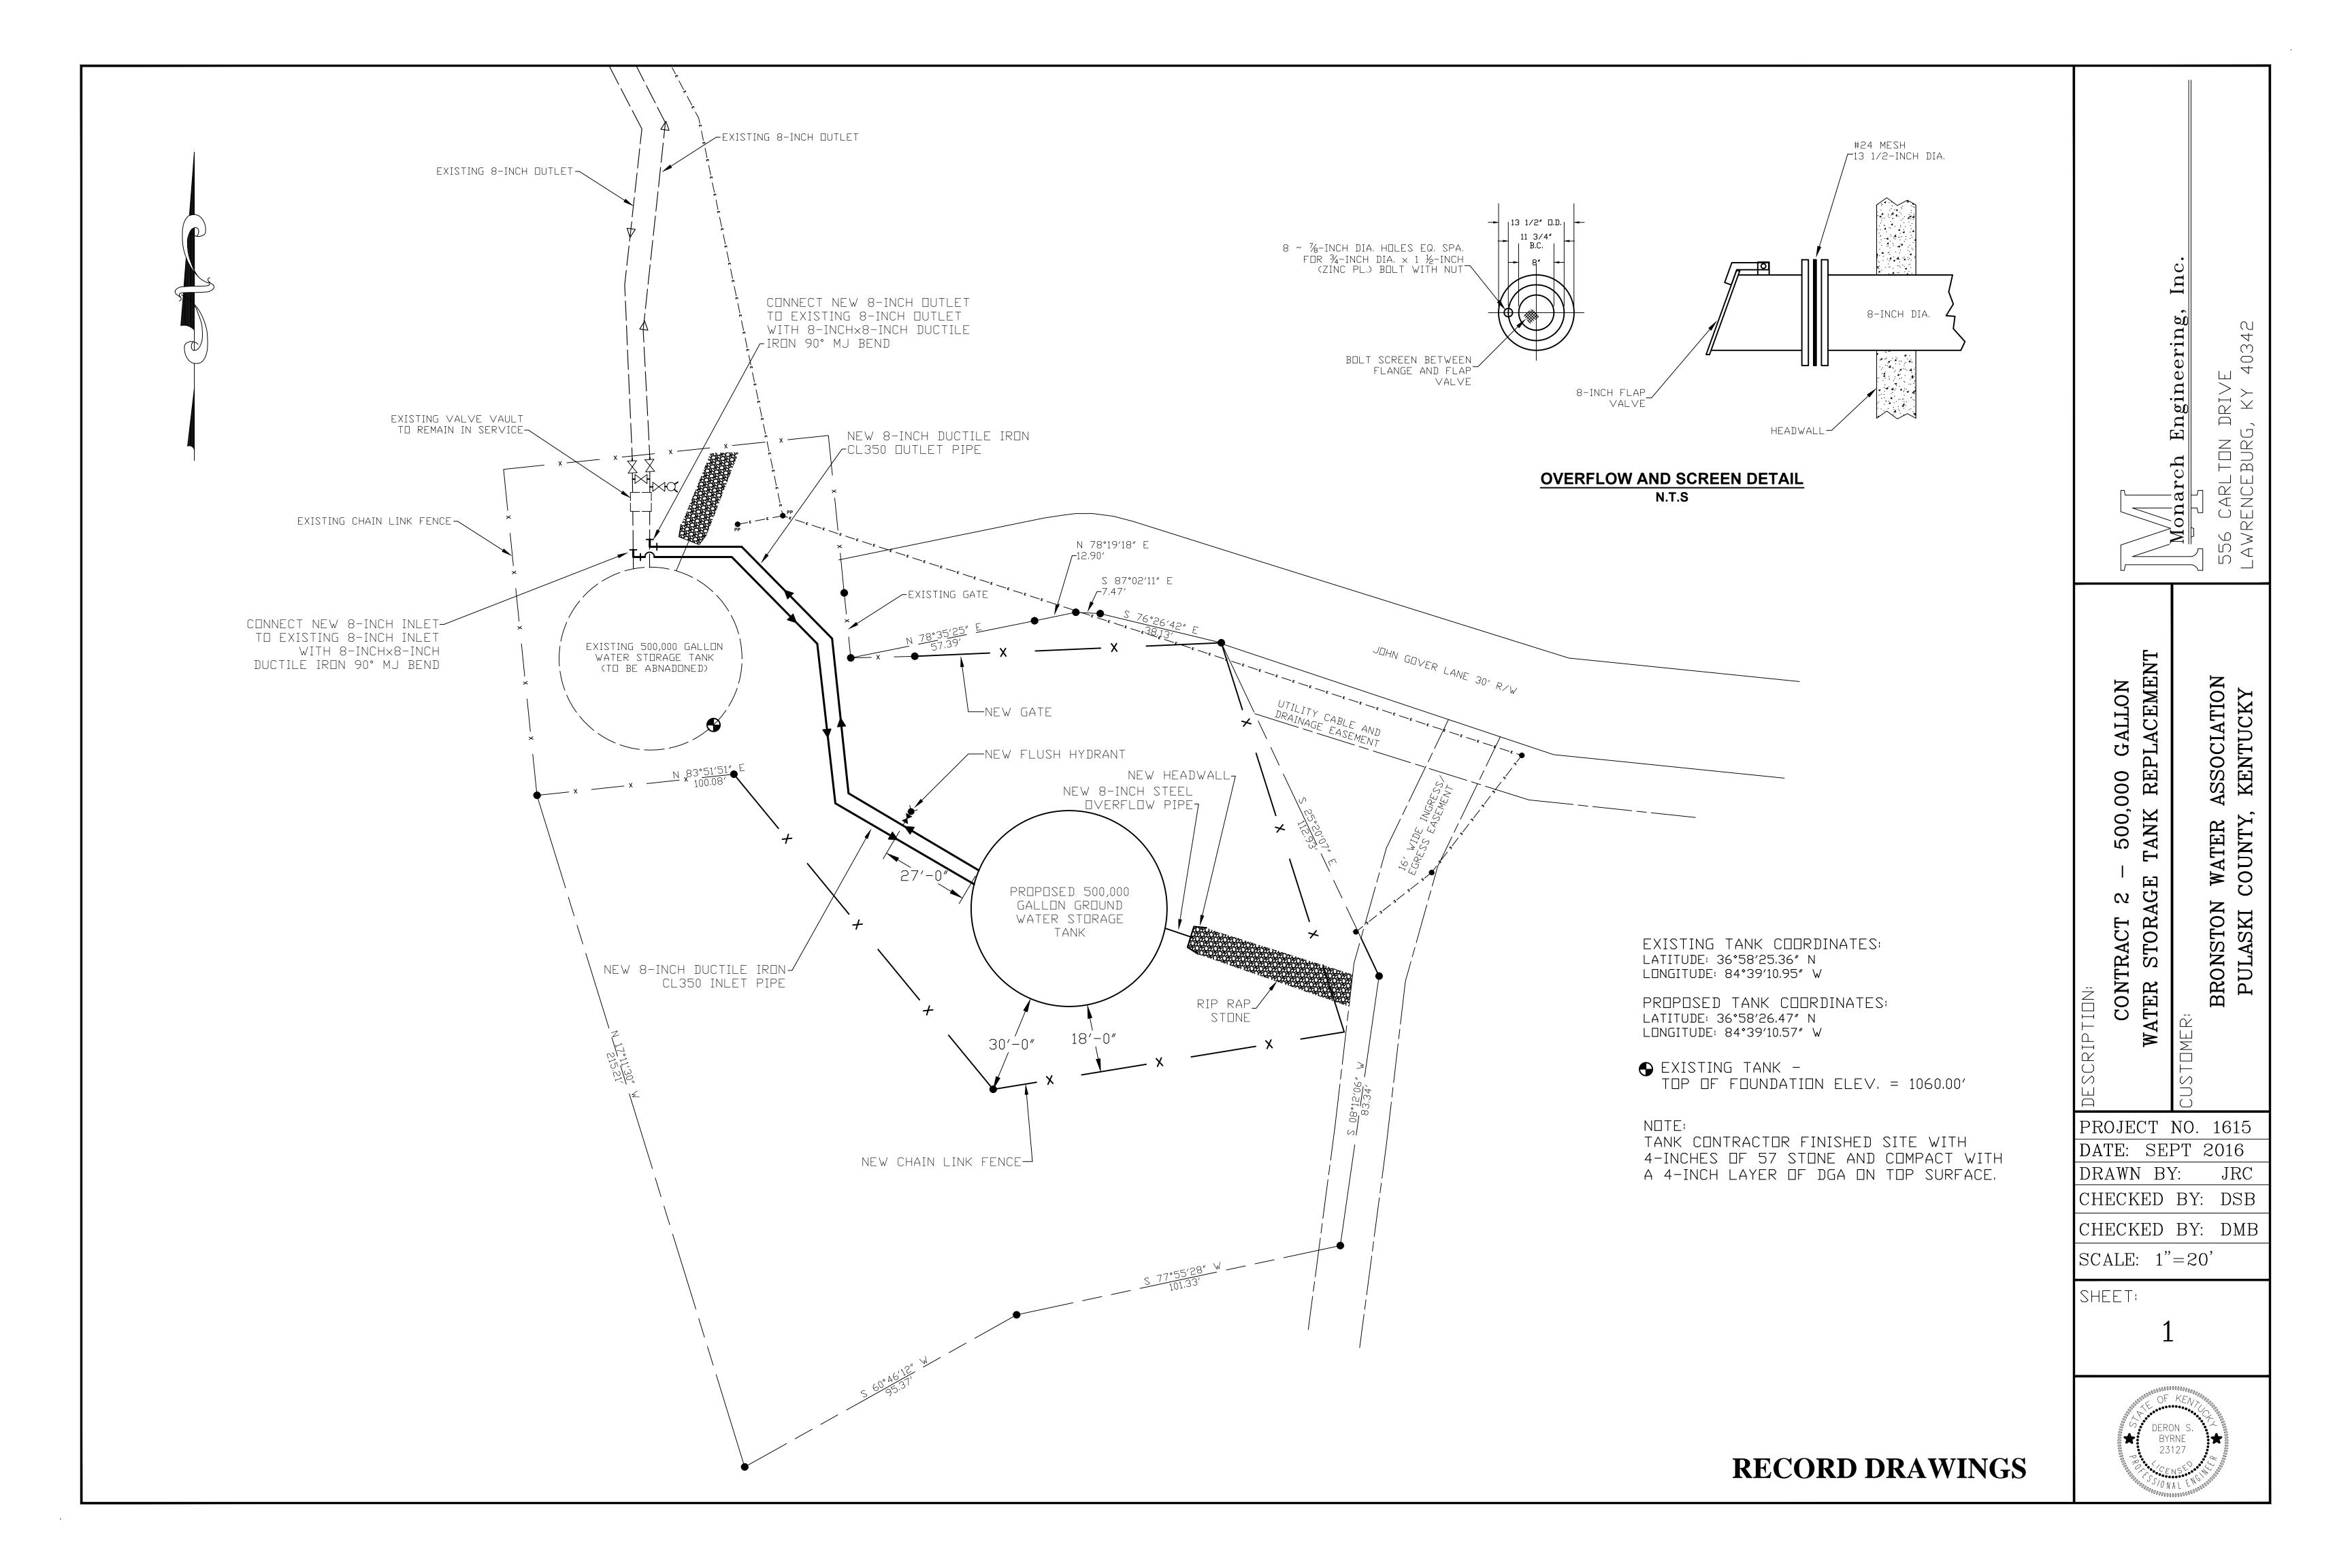

- 1. THE TANK FOUNDATION SHALL BE DESIGNED IN ACCORADNCE WITH AWWA STANDARD FOR WELDED STEEL TANKS AND/OR BOLTED STEEL TANKS FOR WATER STORAGE; (AWWA D100-84), (AWWA D103-09), (AWS D5.2-84). THE TANK FOUNDATION SHALL BE DESIGNED FOR A 100 MILE PER HOUR WIND AND A ZONE 1 EARTHQUAKE.
- 2. PLATE MATERIAL FOR TANK SHELL, TANK BOTTOM AND TANK ROOF SHALL CONFORM TO THE REQUIREMENTS OF ASTM A36.
- 3. CONCRETE SHALL HAVE A MINIMUM COMPRESSIVE STRENGTH OF 4,000 PSI AT 28 DAYS.
- 4. REINFORCING STEEL SHALL BE ASTM A615, A616 OR A617, GRADE 60.
- 5. REINFORCING STEEL FOR CONCRETE CAST AGAINST EARTH SHALL HAVE A MINIMUM COVER OF 3 INCHES. ALL OTHER REINFORCING STEEL SHALL HAVE A MINIMUM COVER OF 2 INCHES.
- 6. ALL WORK SHALL BE PERFORMED IN ACCORDANCE WITH AWWA STANDARD FOR WELDED STEEL TANKS AND/OR BOLTED STEEL TANKS FOR WATER STORAGE (AWWA D100-84), (AWWA D103-09).
- 7. ANCHOR BOLTS SHALL BE THREADED RODS CONFORMING TO THE REQUIREMENTS OF ASTM A36.

NOTES:

- 1. THE INLET/OUTLET PIPE SERVING THE TANK SHALL BE 8-INCH DUCTILE IRON, PRESSURE CLASS 350.
- 2. THE 8-INCH INLET SHALL EXTEND TO THE TOP OF THE TANK (ELEVATION 1084.00'). THE TANK EFFLUENT SHALL BE AT THE BASE OF THE TANK (ELEVATION 1058.00').
- 3. OVERFLOW PIPE SHALL EXTEND A MINIMUM OF TEN FEET FROM THE TANK.
- 4. THE CONTRACTOR SHALL BE RESPONSIBLE FOR FOUNDATION DESIGN.
- 5. TANK APPURTENANCES TO BE FIELD LOCATED BY THE CONTRACTOR AND APPROVED BY THE ENGINEER.
- 6. TANK CONTRACTOR SHALL GRADE SITE TO ENSURE RUNOFF IS AWAY FROM FOUNDATION.
- 7. TANK CONTRACTOR SHALL FINISH TANK SITE WITH 4-INCHES OF 57 STONE AND COMPACT WITH A 4-INCH LAYER OF DGA ON TOP OF SURFACE.

500 TANK


PROJECT NO. 1615 DATE: SEPT 2016


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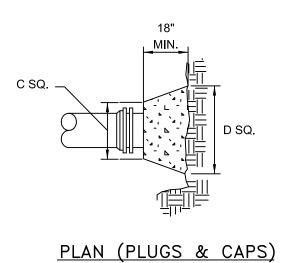
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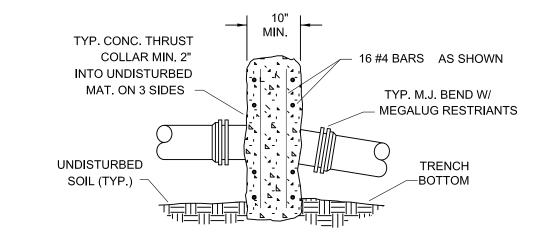




PLAN (HORIZONTAL BENDS)

PLAN (TEES)

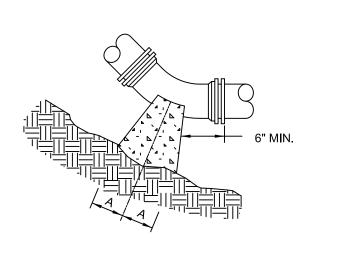18" MIN.-10"DIA. & LESS
24" MIN.-12"DIA. & GREATER

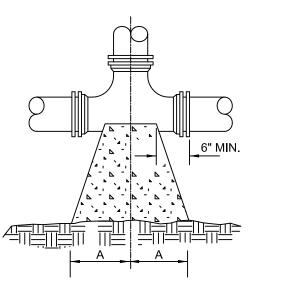

SECTION (HORIZONTAL BENDS & TEES)

SECTION (VERTICAL BENDS)

NOTES:


- FOR VERT. BEND DOWN IN EXCESS OF 11 1/4" BEND, ANCHORAGE SHALL BE DESIGNED BY ENGINEER.
- 2. FOR VERT. BEND UPWARD, BLOCKING TO BE SIMILAR TO THAT FOR HORIZ. BEND.
- 3. GLANDS & BOLTS SHALL REMAIN ACCESSIBLE AND MUST BE PROTECTED FROM CONCRETE BY PLASTIC SHEETING OR OTHERWISE.
- 4. ALL THRUST BLOCK & SUPPORT CONCRETE SHALL BE 3000 PSI READY MIX
- 5. THRUST BLOCKS WITH "B" DIMENSION GREATER THAN 30" SHALL HAVE THE RESTRAINED PIPE INSTALLED WITH A
- MINIMUM OF 4' OF COVER.

 6. DESIGN CRITERIA:


LINE PRESSURE = 200 psi
SOIL BEARING CAPACITY = 2000 psf
FACTOR OF SAFETY = 1.5

DIMEN	ISION CH	IART										
PIPE	90° B	END	45° BEND		22 1/2°	BEND	11 1/4°	BEND	TE	E	PL	UG
SIZE	Α	В	Α	В	Α	В	Α	В	Α	В	С	D
4"	8"	12"	8"	8"	6"	6"	6"	6"	11"	9"	10"	6"
6"	18"	12"	8"	10"	8"	8"	8"	8"	11"	10"	12"	18"
8"	18"	13"	10"	10"	8"	8"	8"	8"	11"	12"	12"	24"
10"	20"	16"	12"	14"	8"	12"	8"	12"	14"	16"	16"	30"
12"	20"	16"	12"	14"	8"	12"	8"	12"	14"	16"	16"	30"
16"	26"	20"	16"	18"	11"	13"	11"	13"	18"	20"	20"	36"
24"	82"	42"	62"	30"	44"	22"	22"	16"	82"	42"	82"	42"
30"	185"	42"	100"	42"	52"	42"	40"	30"	185"	42"	185"	42"


THRUST BLOCK DETAILS

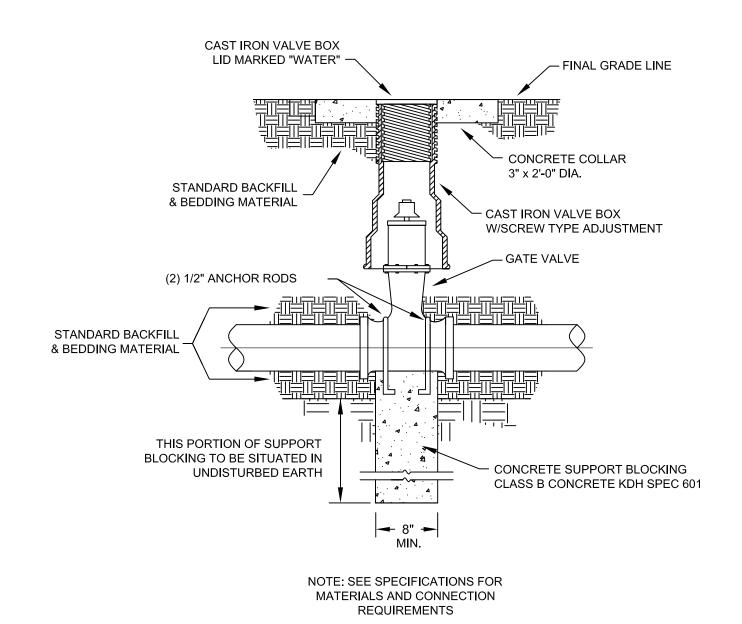

GATE VALVE DETAIL

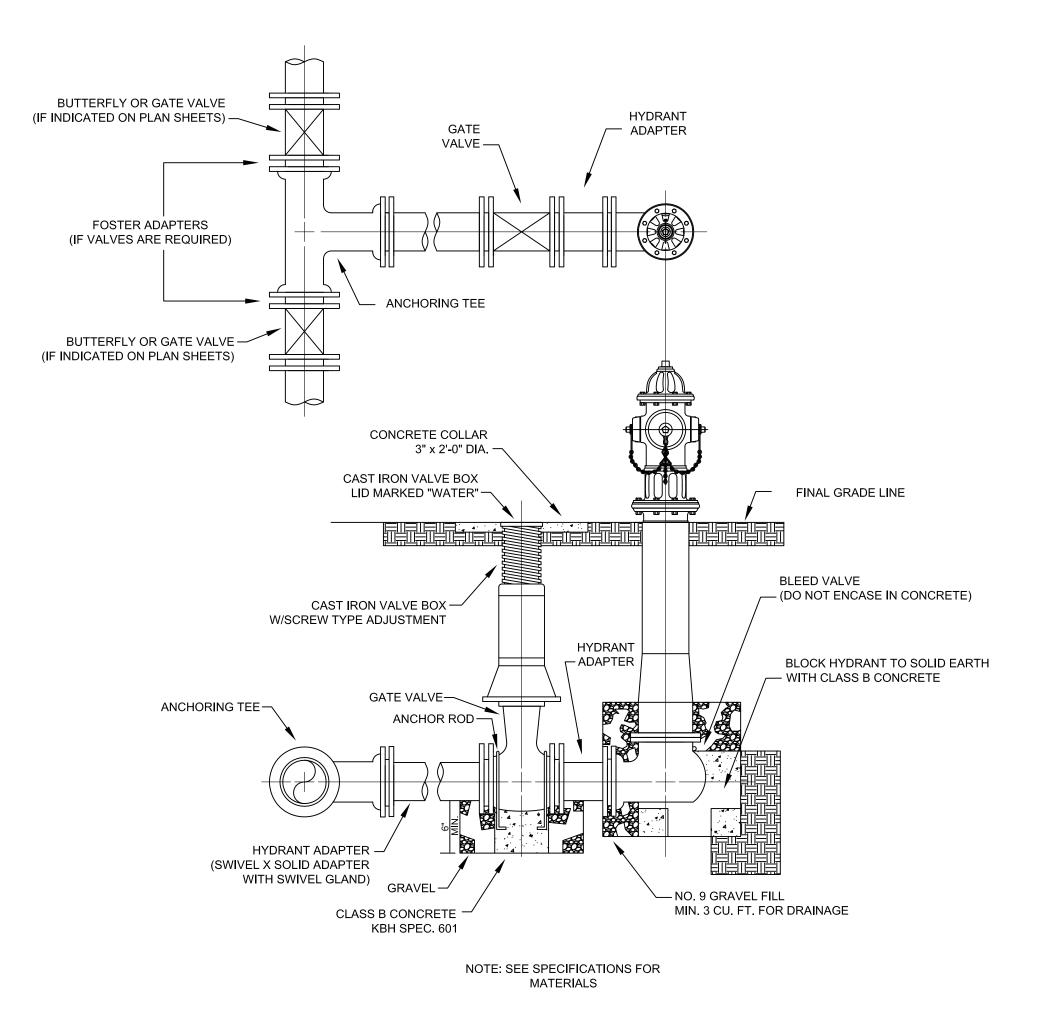

FLUSH HYDRANT ASSEMBLY

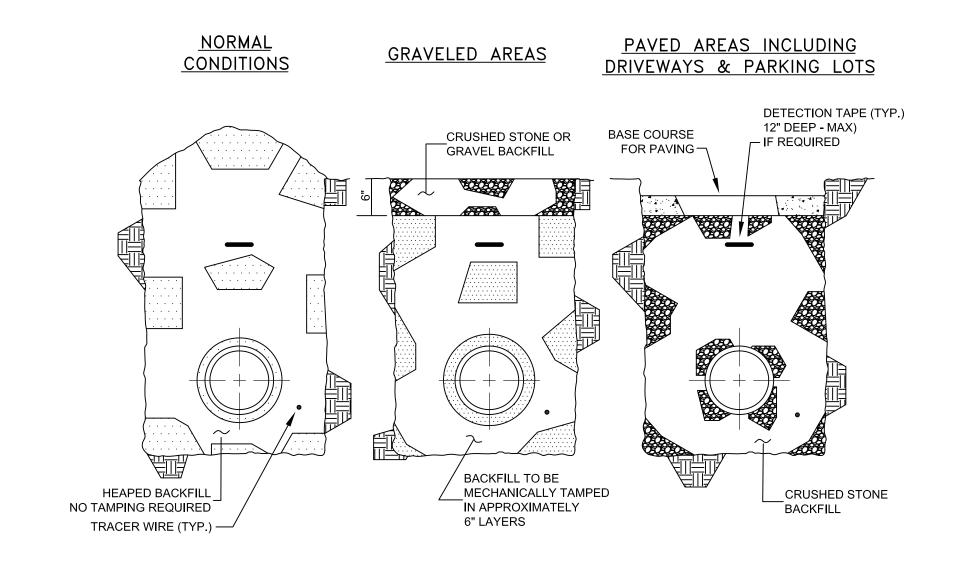


BACKFILLING

RECORD DRAWINGS

	Monarch E 556 CARLTON DR LAWRENCEBURG,			
STANDARD DRAWINGS	customer: BRONSTON WATER ASSOCIATION PULASKI COUNTY, KENTUCKY			
ROJECT	NO. 1615			
ATE: SE				
RAWN BY HECKED	T: JRC BY: DSB			
	BY: DMB			
	N.T.S.			
HEET:				
SD-1				

DERON S. BYRNE

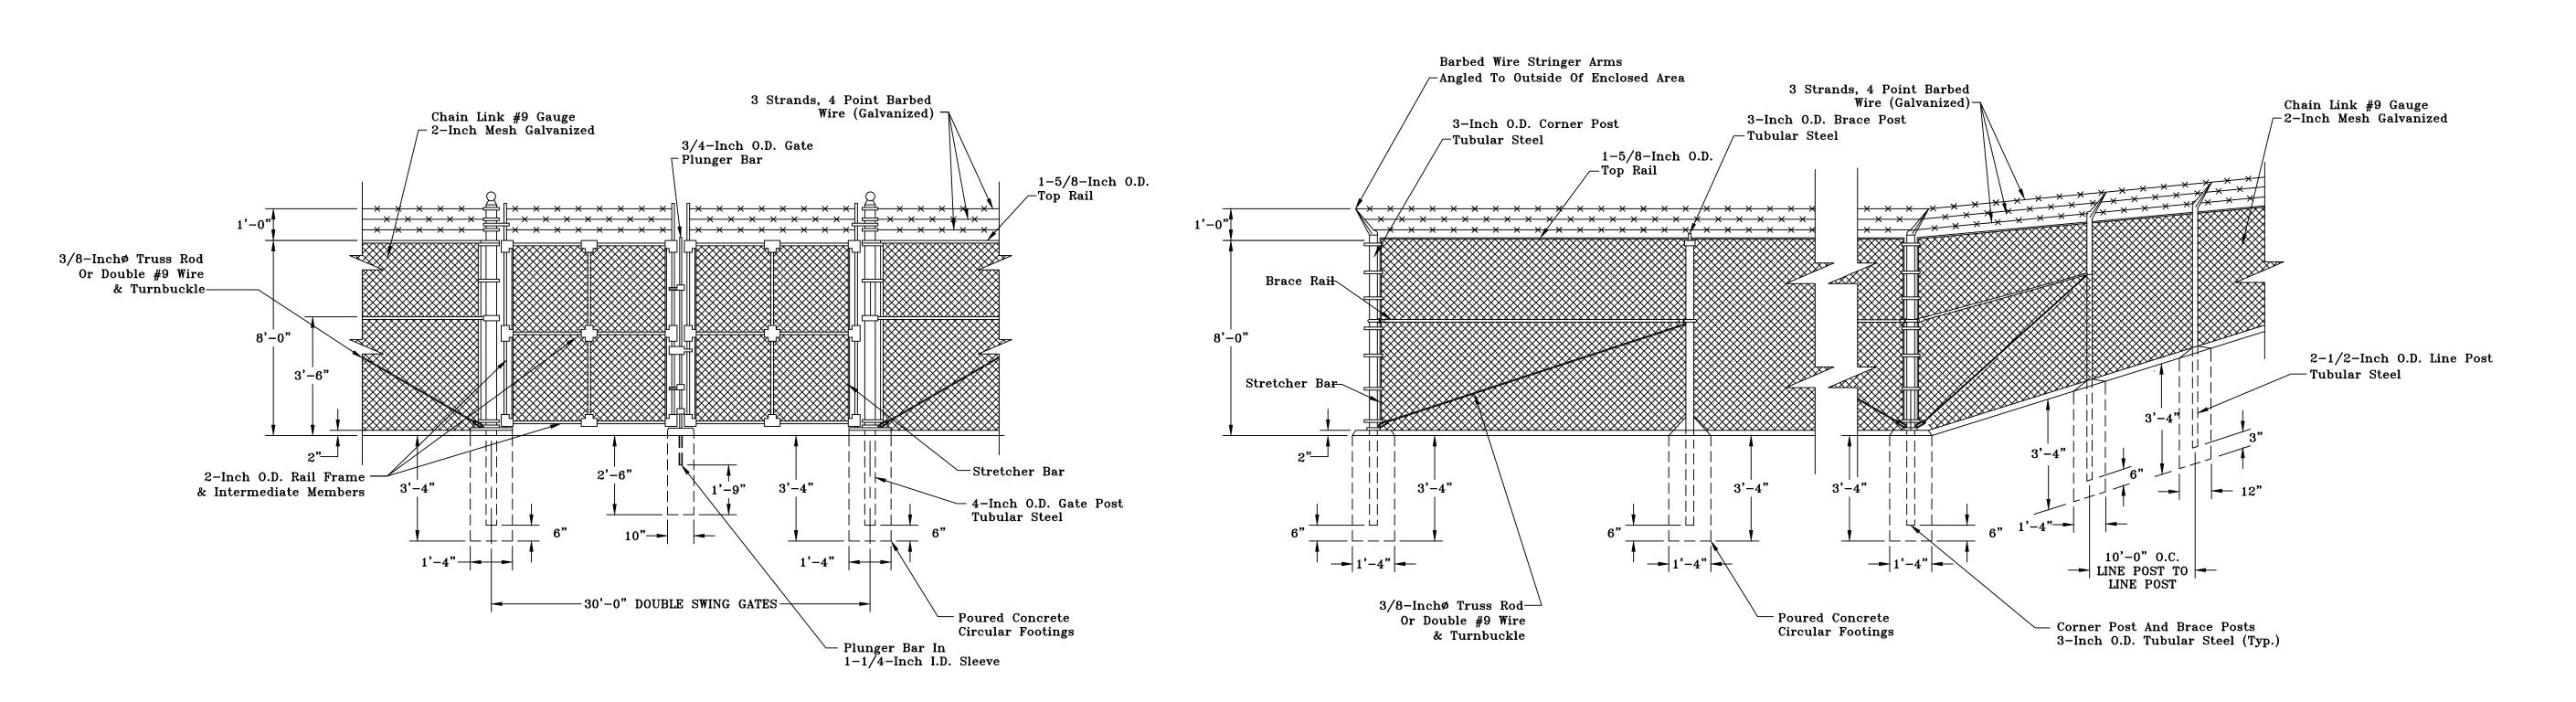

CHAIN LINK FENCE ELEVATION

Scale: N. T. S.

Engineering, ASSOCIATION KENTUCKY AIL DE FENCE BRONSTON PULASKI (PROJECT NO. 1615 DATE: SEPT 2016 DRAWN BY: CHECKED BY: DSB CHECKED BY: DMB SCALE: AS NOTED SHEET: F-1

