

COMMONWEALTH OF KENTUCKY
BEFORE THE PUBLIC SERVICE COMMISSION

In the Matter of:

ELECTRONIC APPLICATION OF NORTHERN KENTUCKY)	
WATER DISTRICT FOR A CERTIFICATE OF PUBLIC)	CASE NO. 2025-00243
CONVENIENCE AND NECESSITY FOR THE CONSTRUCTION)	
OF SUB DISTRICT O WATER MAIN EXTENSION, FINANCING)	
AND SURCHARGE)	

APPLICATION

Northern Kentucky Water District (“NKWD” or “District”), by and through counsel, petitions the Commission for an order authorizing for a Certificate of Public Convenience and Necessity for the construction of Sub District O water main extension **before the bids expire on October 1, 2025** pursuant to KRS 278.020 and approval of financing pursuant to KRS 278.300. In support of this Application, NKWD states as follows:

GENERAL INFORMATION

1. NKWD states pursuant to **807 KAR 5:001(14)** that its office address is 2835 Crescent Springs Road, Erlanger, Kentucky 41018-0640. Its principal officers are listed in its current Annual Report, which is filed with the Commission as are its prior years Reports.
2. Pursuant to **807 KAR 5:001(14)**, NKWD states it is a non-profit water district organized under Chapter 74 and has no separate articles of incorporation; its web page is www.nkywater.org. Its contact officers and employees are:

Stacey Kampsen Vice President of Finance and Support Services 2835 Crescent Spring Road P.O. Box 18640 Erlanger, Kentucky 41018 Phone: (859) 578 9898 Fax: (859) 578-3668	Tom Edge General Counsel and Director of Compliance, Communications and Regulatory Affairs 2835 Crescent Spring Road P.O. Box 18640 Erlanger, Kentucky 41018 Phone: (859) 578 5457
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Email: skampsen@nkywater.org	Fax: (859) 578-3668 Email: tedge@nkywater.org
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3. A description of NKWD's water system and its property stated at original cost by accounts is contained in its Annual Report, which is incorporated by reference.
4. NKWD serves retail customers in Kenton, Boone and Campbell Counties and sells water at wholesale to non-affiliated water distribution systems in Kenton, Boone, Pendleton and Campbell Counties.
5. NKWD proposes constructing a water main extension as described in Exhibit A.
6. The Sub District O water main extension is necessary to provide service to unserved properties in unincorporated areas of Kenton County and to maintain quality water service to the general area of Kenton County. NKWD seeks an order allowing the formation of the sub district associated with the construction proposed in this Application.
 - a. The purpose of the sub district is to aggregate sufficient customers to make the extension of facilities to the residents of the affected areas feasible. While there are limited areas in NKWD's service area that are unserved, those areas are widely separated and sparsely populated. The estimated 462 households in Kenton County without access to a potable water distribution system are widely dispersed. By combining the proposed areas into Sub District O, NKWD is able to provide water service to higher density unserved areas which helps spread the cost among sufficient customers to make the project financially feasible for NKWD and affordable for the residents in those areas. This is the same methodology and application format that NKWD has used for other sub district projects.¹

¹ See e.g., *Electronic Application of Northern Kentucky Water District for a Certificate of Public Convenience and Necessity for the Construction of Sub District HB Water Main Extension, Financing and Surcharge*, Case No. 2024-00304; *Application of Northern Kentucky Water District for a Certificate of Convenience and Necessity, Financing, Surcharge, and Creation of Sub District M Pursuant to KRS 278.023*, Case No. 2014-00150; *Application of Northern Kentucky Water District for a Certificate of Convenience and Necessity for the Construction of Sub District I Water Main Extension, Financing and Surcharge*, Case No. 2012-00583; *Application of Northern Kentucky Water District for a Certificate of Convenience and Necessity for the Construction of Sub District H Water Main Extensions, Financing and Surcharge*, Case No. 2010-00434;

- b. NKWD has always used household density as one of the primary criterion for the establishment of a sub district. See Exhibit I. In order to maximize the number of customers served with the limited dollars available from all funding sources, NKWD determines where the highest number of households per mile can be feasibly served and where interest levels are highest. The cost per mile of any extension dictates that NKWD maximize the number of customers served along each extension. Because of the limited resources available to extend service, NKWD attempts to get the most value from each dollar spent.
- c. To standardize the sub district process, NKWD formulated a tariff that specifies the criteria for establishing a sub district:

**SECTION XIV-D – DISTRIBUTION MAIN EXTENSION POLICY
FOR DISTRIBUTION SUBDISTRICTS**

1. Pursuant to 807 KAR 5:066, when the District determines that the cost of a main extension using any other main extension tariff creates an unreasonable financial hardship on potential customers or that an alternative extension method will benefit the public interest by allowing the extension of water facilities into unserved areas that would otherwise be uneconomical to serve or would benefit the District, the District may use a subdistrict and rate surcharge as an alternative to other extension procedures.
2. The use of a subdistrict, including the imposition of a rate surcharge for the customers within the subdistrict, is subject to the following criteria:
 - a. There must be a demand for the extension of the service sufficient to make the extension hydraulically and financially feasible as determined by the District.
 - b. There must be funds available to the District from third party sources, such as governmental loans and grants, customer contributions or other non-rate based revenue to supplement the District's financial contribution to the extension to make the extension financially feasible in the discretion of the District.
 - c. The demand for service must be within an area or areas in which the potential customers share common geographic characteristics or can be served through common utility plant and facilities. The area of the proposed subdistrict may include non-contiguous locations of potential customers.
 - d. Common geographic characteristics include but are not limited to greater customer population density when compared to other unserved areas within the District's service area. In areas where customer density may be lower than other potentially served areas, factors such as location of customers along the route needed to connect higher density areas, hydraulic improvements to the District's system, geotechnical factors, location of existing distribution facilities, adequate customer participation in the project, financial contributions by a customer or group of customers to fund the extension, availability of sewer service in an area or other similar factors may be used by the District in assessing the feasibility of the subdistrict.

d. As the application and exhibits herein establish, all criteria have been met.

7. The construction is in the public interest and is required to allow NKWD to continue to provide adequate service to customers within its jurisdiction.

a. The areas included in Sub District O are all rural, remote from existing water distribution facilities and have no access to potable water other than cisterns and wells. Given the need to develop financially and technically feasible projects, location of these residents, the distance between the properties, the sparse number of residents in the affected areas and the demand for safe, affordable, piped water supplies, all of the residents of the proposed sub district are in a similar situation as to geographic characteristics, water supply inadequacy, and need for affordable service. This project will extend 8-inch water mains to make public water available to 61 residences in rural areas that currently have no access to public water supply:

- i.** Approximately 367 feet of 8" ductile iron water main along Highwater Road (from River Heights Lane to #1873);
- ii.** Approximately 1,527 feet of 8" PVC water main along Scenic Ridge Drive;
- iii.** Approximately 464 feet of 8" ductile iron water main along Decoursey Pike (from Ryland Lakes Drive to Steep Creek Road);
- iv.** Approximately 5,370 feet of 8" ductile iron water main along Steep Creek Road (from Decoursey Pike to #3704 at the bridge);
- v.** Approximately 591 feet of 8" ductile iron water main along Mann Road (from Steep Creek Road to #11290);
- vi.** Approximately 1,264 feet of 8" ductile iron and PVC water main along Gene Street;
- vii.** Approximately 4,197 feet of 8" ductile iron water main along Fiskburg Road (Goshorn Road to Alexander Road);

viii. Approximately 2,634 feet of 8” ductile iron and PVC water main along Alexander Road (Fiskburg Road to St. Marys Road); and

ix. Approximately 4,883 feet of 8” ductile iron and PVC water main along Elliot Road (from KY 17 to the Pendleton County Line).

b. These areas were chosen based on population density and interest level. The estimated cost of the total project is \$4,826,785.00. All areas included in the project have similar characteristics of rural location, sparse population density, lack of potable water supply and inability to connect to a water distribution system without the extension of these water lines.

c. The funds obtained in a number of prior sub districts were predicated on the economic status of the affected areas’ residents. The funds in this case are not so encumbered. There is no low/moderate income requirements for the financing of this project, therefore, income levels are not a factor in the selection of geographic areas. There is no low/moderate income funding associated with this project. No customers or areas have been designated a part of this sub district based on income criteria.

8. The proposed construction project identified in Exhibit A is scheduled to begin construction upon PSC approval and beginning in October 2025 and completed in June 2026. Board approval of the final bids for the project is included in Exhibit C. The bids were opened July 3, 2025 and are subject to acceptance for 90 days. **The bids will expire October 1, 2025.**

9. The project, its cost, need and other details are contained in Exhibits A -1 through A-7.

10. NKWD has received approvals from the DOW for the Plans and Specifications and funding for these improvements. See Exhibit B.

11. A copy of the Bid Tabulation for this project, along with the Engineer’s Recommendation of Award and minutes of NKWD’s Board of Commissioner’s meeting approving the award are contained in Exhibit C-1 through C-3.

12. The project finance information including: (i) customers added and revenue effect; (ii) debt issuance and source of debt; (iii) USoA Accounts; (iv) additional costs for operating and maintenance; and (v) depreciation costs and debt service after construction is contained in Exhibit D.

13. Information on NKWD's Mortgages, Bonds, Notes and Other Indebtedness is included in Exhibit E.

14. NKWD's Financial Statements are included as Exhibit F and an Affidavit for this Application is included as Exhibit J.

15. Only an additional surcharge for the customers being added upon approval and construction of the proposed Sub District is being proposed. See Exhibit G and H. No other rate adjustment is being proposed as part of this Application.

16. The following information is provided pursuant to **807 KAR 5:001(15)(2)**:

a. Specifications and descriptions are in Exhibit A. The construction is in the public interest and is required to allow NKWD to continue to provide adequate service to its customers. Facts relied on to justify the public need are included in the project descriptions in Exhibit A-1 through A-6.

b. No new franchises are required. Copies of permits from the proper public authority for the proposed construction are in Exhibit B.

c. A full description of the proposed location and route of the proposed construction including a description of the manner of the construction and related information is in Exhibit A-1 through A-6. The project will not compete against any other public utility in the area.

d. A Project Map is included as Exhibit A-1.

e. The project will be funded using the following sources:

Cleaner Water Program Grant #21CWW285	\$1,100,000.00
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Kenton County Fiscal Court Contribution	\$2,400,000.00
Sub District O Surcharge	\$297,000.00
NKWD Contribution	\$1,029,785.00
TOTAL PROJECT FUNDING:	\$4,826,785.00

The Sub District O Surcharge portion of the project funding will be advanced by NKWD and collected as a monthly surcharge of \$30.00 on the customer's water bill over 25 years and assumes 33 of the 61 potential customers will sign up which is based on the 33 property owners that have already submitted applications and tap fees. These 33 property owners completed this action at NKWD's invitation and with an understanding that the surcharge would be required. Funding will cover costs including construction cost, engineering, and contingencies. A summary of the project costs is provided below:

Engineering	\$468,036.00
Contractor's Bid	\$4,134,880.65
Misc. & Contingencies	\$223,868.35
TOTAL PROJECT COST:	\$4,826,785.00

Project financial information is further outlined Exhibit D.

17. Pursuant to **807 KAR 5:001(12)(1)**, Financial operations information for the twelve-month period not less than 90 days prior is attached hereto in Exhibit F.

18. The following information is provided pursuant to **807 KAR 5:001(12)(2)**:

- a. No stock is authorized.
- b. No stock is issued.
- c. There are no stock preferences.
- d. Mortgages are listed in Exhibit E.
- e. Bonds are listed in Exhibit E.

- f. Notes are listed in Exhibit E.
 - g. Other indebtedness is listed in Exhibit E.
 - h. No dividends have been paid.
 - i. Current balance sheet and income statement are attached as Exhibit F.
19. Pursuant to **KRS 322.340**, Engineering plans, specifications, drawings, plats and reports for the proposed construction or extension prepared by a registered engineer are signed, sealed and dated by an engineer registered in Kentucky are included as Exhibit A.
20. The following information is provided as required by **807 KAR 5:001(18)(1)**:
 - a. The information required by **807 KAR 5:001(14)** is contained within this Petition generally and within paragraphs 1-4 specifically as if fully rewritten herein;
 - b. A general description of the property is contained in the NKWD Annual Report filed with the Public Service Commission and is incorporated herein. The Annual Report and attached financial information in Exhibit F are the latest available from NKWD.

No stock or bonds are to be issued as part of this case. Project financial information is included as Exhibit D.
 - c. The funds will be used to construct the project described in Exhibit A.
 - d. A detailed description of property to be acquired, constructed, improved or extended is included in Exhibit A and Exhibit B.
 - e. There is no refunding or refinancing proposed herein.
 - f. The state debt officer has not been notified pursuant to 807 KAR 5:001(18)(1)(g) because no permanent debt is being issued.
21. The following exhibits are provided pursuant to **807 KAR 5:001(18)(2)**:
 - a. Financial Exhibits, pursuant to **807 KAR 5:001(12)**, are included as Exhibit F.
 - b. There are no trust deeds. All notes, mortgages and other forms of indebtedness are

included as Exhibit E.

c. Maps and plans of property constructed or acquired are listed in Exhibit A.

22. Pursuant to **KRS 278.300**, this Application is made under oath through an Affidavit located in Exhibit J.

23. A copy of the customer notice to be advertised simultaneously with this filing is attached as Exhibit G.

24. Proposed tariff sheets setting forth Sub District O are attached hereto as Exhibit H.

25. To the extent that the Commission determines 807 KAR 5:001, Section 16 is applicable, NKWD requests a deviation from its requirements pursuant to 807 KAR 5:001, Section 22. NKWD has good cause for the deviation as bids could reasonably be held open only for 90 days and NKWD has historically conducted sub district creation cases without application of 807 KAR 5:001, Section 16. *See e.g., Electronic Application of Northern Kentucky Water District for a Certificate of Public Convenience and Necessity for the Construction of Sub District HB Water Main Extension, Financing and Surcharge, Case No. 2024-00304; Application of Northern Kentucky Water District for a Certificate of Convenience and Necessity, Financing, Surcharge, and Creation of Sub District M Pursuant to KRS 278.023, Case No. 2014-00150; Application of Northern Kentucky Water District for a Certificate of Convenience and Necessity for the Construction of Sub District I Water Main Extension, Financing and Surcharge, Case No. 2012-00583; Application of Northern Kentucky Water District for a Certificate of Convenience and Necessity for the Construction of Sub District H Water Main Extensions, Financing and Surcharge, Case No. 2010-00434; Application of Northern Kentucky Water District for a Certificate of Convenience and Necessity for the Construction of Sub District G Water Main Extensions, Financing and Surcharge, Case No. 2007-00131; Application of Northern Kentucky Water District for a Certificate of Convenience and Necessity for the Construction of Subdistrict F Water Main Extensions, Financing and Surcharge, Case No. 2006-00315.* Moreover, NKWD will conduct public notice of the new sub district and the proposed rate as depicted in Exhibit G and has previously notified all potential sub district customers that they would be subject to a sub district surcharge if the

water main extensions were completed.

For these reasons, NKWD requests issuance of an order granting authority to construct and finance the facilities, issue and collect a surcharge for Sub District O and for any other authorizations that may be necessary.

RESPECTFULLY SUBMITTED:



Tom Edge, Esq. (KBA #95534)

General Counsel

Cassandra Zoda, Esq. (KBA #96871)

Contracts, Claims and Procurement Coordinator

Northern Kentucky Water District

2835 Crescent Springs Rd.

Erlanger, KY 41018

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Fax - 859-426-2770


Email: tedge@nkywater.org

czoda@nkywater.org

Counsel for Northern Kentucky Water District

CERTIFICATE OF SERVICE

In accordance with 807 KAR 5:001, Section 8, I certify that this document was submitted electronically to the Public Service Commission on July 23, 2025 and that there are currently no parties that the Public Service Commission has excused from participation by electronic means in this proceeding.



Tom Edge, Esq. (KBA #95534)

EXHIBIT LIST

TABLE OF CONTENTS

EXHIBIT A ENGINEERING REPORTS AND INFORMATION

- (1) Project Description And Map
- (2) Engineer's Opinion of Probable Total Construction Costs
- (3) System Hydraulic Model
- (4) Plans
- (5) Specifications

EXHIBIT B APPROVALS AND PERMITS (Franchises, Plan Review and Permit Status, Easements, Right-of-Ways, Construction Start and In-Service Date, Plant Retirements)

EXHIBIT C BID INFORMATION AND BOARD APPROVAL

- (1) Bid Tabulation
- (2) Engineer's Recommendation of Award
- (3) Board Meeting Minutes

EXHIBIT D PROJECT FINANCE INFORMATION

EXHIBIT E MORTGAGES, BONDS, NOTES AND OTHER INDEBTEDNESS

EXHIBIT F FINANCIAL STATEMENTS (Balance Sheet and Income Statement)

EXHIBIT G CUSTOMER NOTICE

EXHIBIT H PROPOSED TARIFF

EXHIBIT I STREET DENSITY TABLE

EXHIBIT J AFFIDAVIT



EXHIBIT A

ENGINEERING REPORTS AND INFORMATION



EXHIBIT A-1

PROJECT DESCRIPTION AND MAP

Subdistrict O Water Main Extension

Project 184-0927

Project Description:

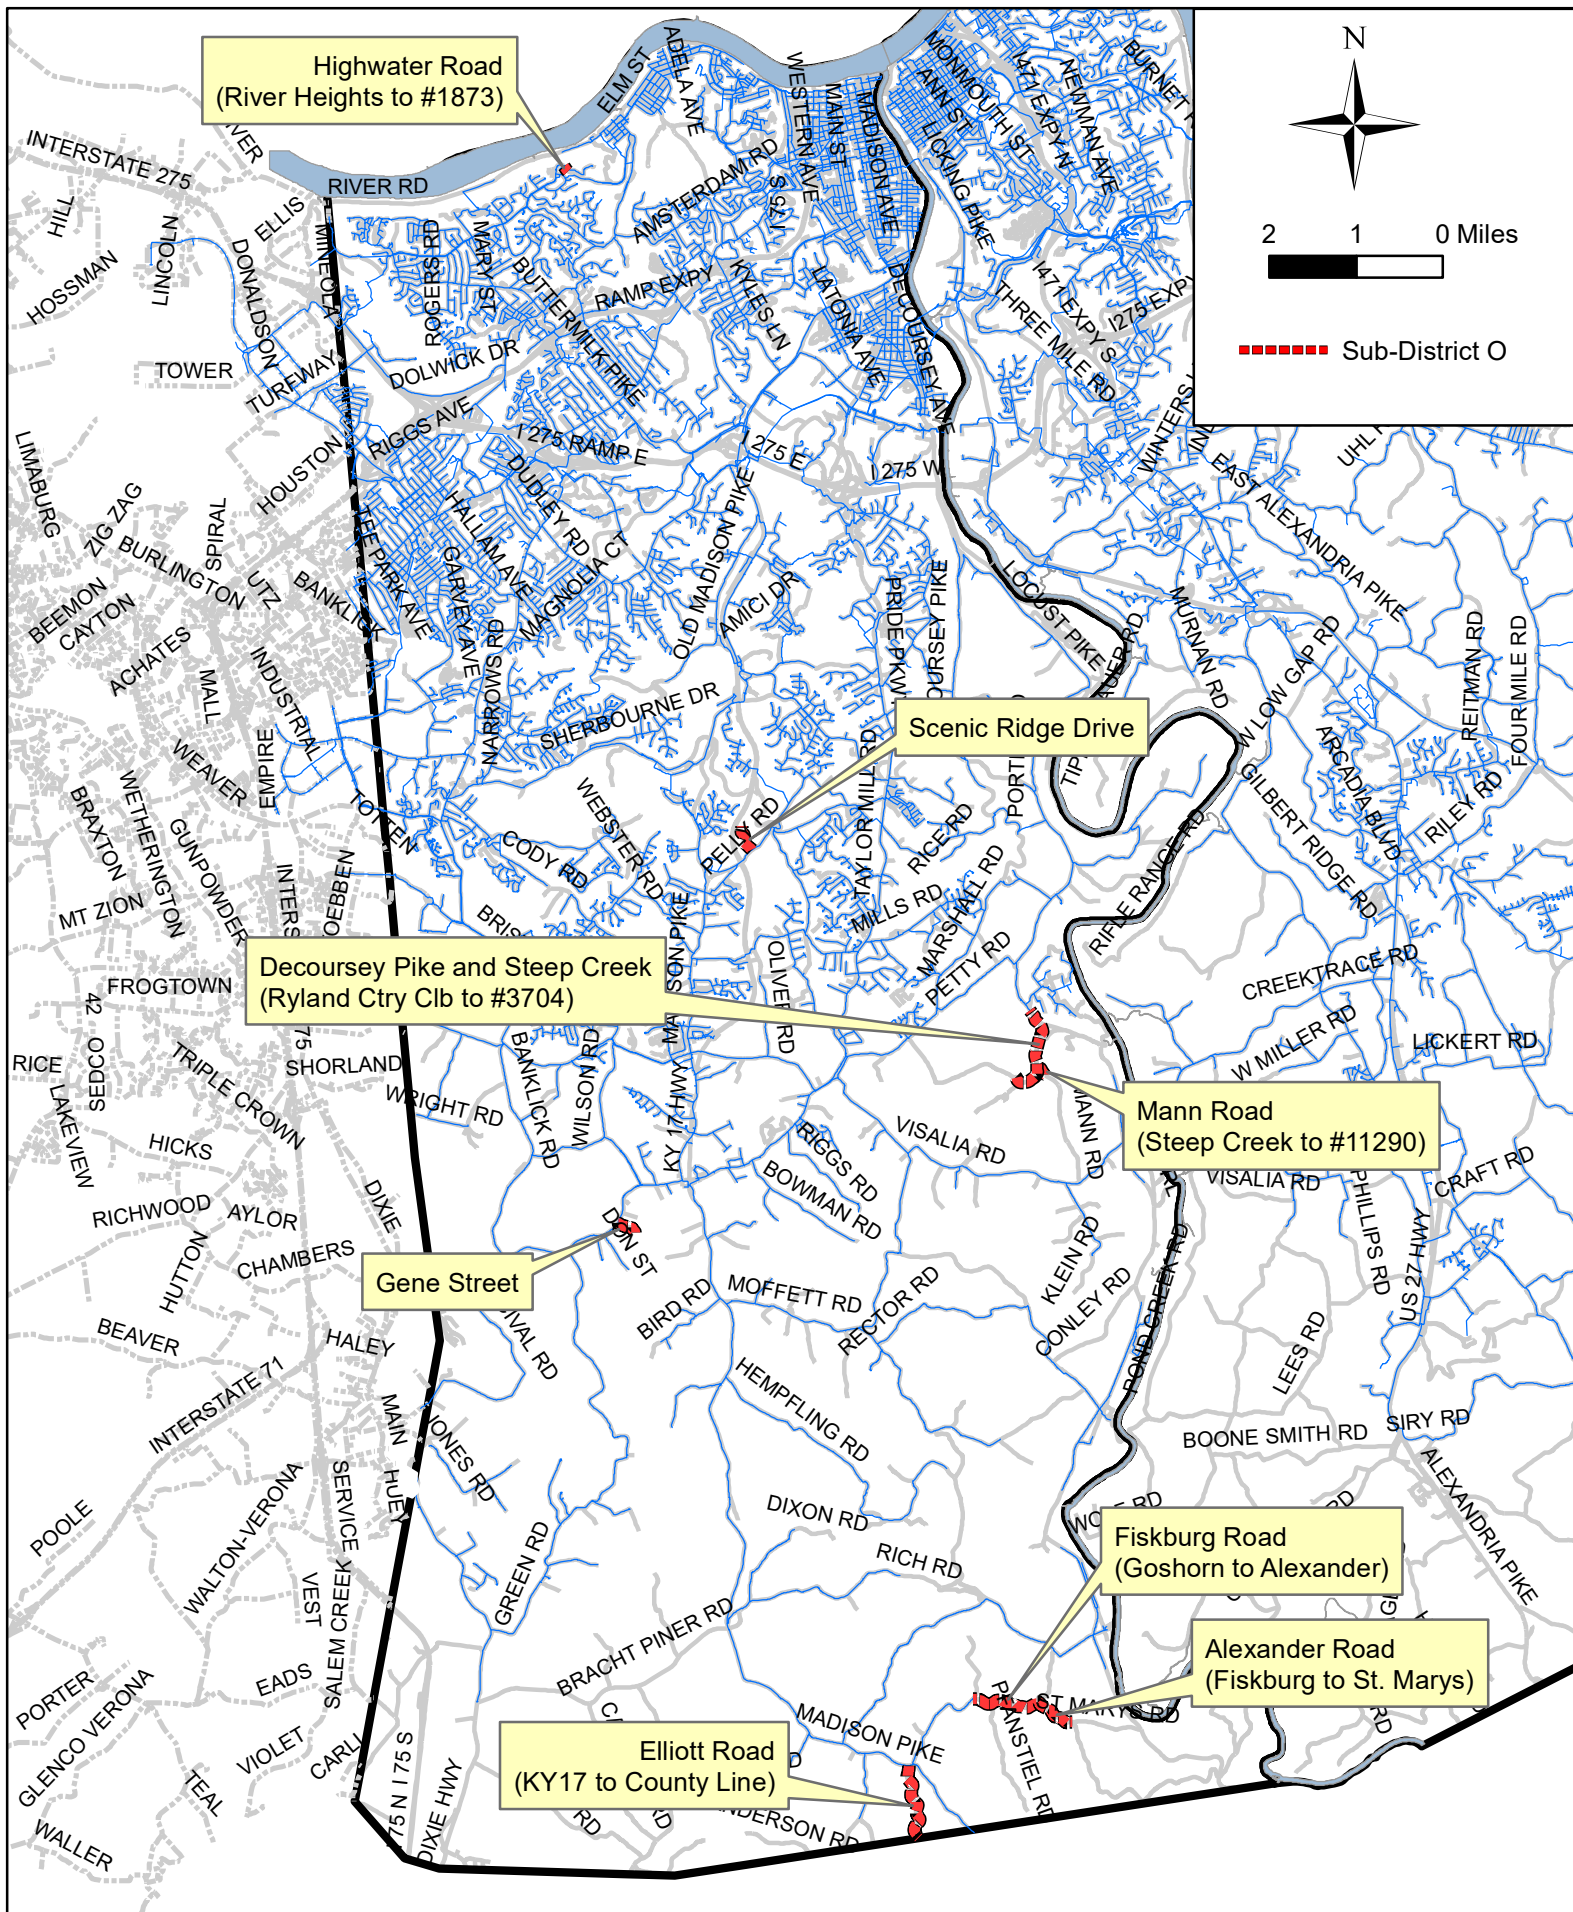
The proposed project consists of 21,297 LF of water main extensions in the following areas of Kenton County, Kentucky:

- Approximately 367 feet of 8" ductile iron water main along Highwater Road (from River Heights Lane to #1873)
- Approximately 1,527 feet of 8" PVC water main along Scenic Ridge Drive
- Approximately 464 feet of 8" ductile iron water main along Decoursey Pike (from Ryland Lakes Drive to Steep Creek Road)
- Approximately 5,370 feet of 8" ductile iron water main along Steep Creek Road (from Decoursey Pike to #3704 at the bridge)
- Approximately 591 feet of 8" ductile iron water main along Mann Road (from Steep Creek Road to #11290)
- Approximately 1,264 feet of 8" ductile iron and PVC water main along Gene Street
- Approximately 4,197 feet of 8" ductile iron water main along Fiskburg Road (Goshorn Road to Alexander Road)
- Approximately 2,634 feet of 8" ductile iron and PVC water main along Alexander Road (Fiskburg Road to St. Marys Road)
- Approximately 4,883 feet of 8" ductile iron and PVC water main along Elliot Road (from KY 17 to the Pendleton County Line)

This project will extend water mains to make public water available to 61 residences in areas that currently have no access to public water supply. These areas were chosen based on population density and interest. The cost of the total project is \$4,836,785.00. There are no low/moderate income requirements for the financing of this project, therefore, income levels are not a factor in the selection of geographic areas. All areas included in the project have similar characteristics of rural location, sparse population density, lack of potable water supply and inability to connect to a water distribution system without the extension of these water lines.

Street Name	Potential Customers	Total Signups	% Signups
Highwater Road	1	1	100%
Scenic Ridge Drive	6	6	100%
Decoursey Pike	0	N/A	N/A
Steep Creek Road	9	4	44.4%
Mann Road	4	3	75.0%
Gene Street	7	4	57.1%
Fiskburg Road	8	5	62.5%
Alexander Road	11	4	36.4%
Elliot Road	15	6	40.0%
Totals	61	33	54.1%

Bids for this project were opened on July 3rd, 2025 and are subject to acceptance for 90 days. Therefore, the bids will expire on October 1st, 2025.



Sub-District O Water Main Extension



EXHIBIT A-2

ENGINEER'S OPINION OF PROBABLE TOTAL CONSTRUCTION COSTS

Sub-District O Water Main Extension Project

Corridor	Engineer's Cost	
	Opinion	LF
Highwayter Road	\$158,972.00	367
Scenic Ridge Drive	\$513,095.00	1526
Decoursey Pike	\$90,684.00	464
Steep Creek Road	\$1,247,950.00	5370
Mann Road	\$172,920.00	591
Gene Street	\$325,336.00	1264
Fiskburg Road	\$982,495.80	4197
Alexander Road	\$835,796.50	2634
Elliot Road	\$1,585,600.50	4883
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Total =	\$5,912,849.80	21,296



NKWD SUBDISTRICT 'O' - HIGHWATER ROAD WATER MAIN EXTENSION

Final Review 04-15-2025

Item No.	Description	Unit of Measure	Estimated Quantity	Unit Cost Total	Total Cost
1	6.01 CLASS 52 DUCTILE IRON PIPE (8"). (Detail 103, 103a, 104, 104a, 110)	LF	367	\$160.00	\$58,720.00
2	7.01 CONNECT TO EXISTING MAIN/TIE-IN (8")	EA	1	\$5,000.00	\$5,000.00
3	8.01 INSTALL FIRE HYDRANT ASSEMBLY	EA	1	\$8,000.00	\$8,000.00
4	9.01 DUCTILE IRON RESILIENT SEATED GATE VALVE (8")	EA	2	\$2,800.00	\$5,600.00
5	10.05 INSTALL WATER METER SETTING (Service line materials provided by NKWD)	EA	1	\$3,000.00	\$3,000.00
6	11.04 PLUG AND BLOCK (8")	EA	1	\$600.00	\$600.00
7	11.06 8"x8"x6" ANCHORING TEE AND BLOCK	EA	1	\$1,000.00	\$1,000.00
8	12.05 1-1/2" ASPHALTIC CONCRETE MILLING AND PAVING	SY	460	\$60.00	\$27,600.00
9	12.06 ASPHALTIC CONCRETE - TRENCH RESTORATION	SY	165	\$200.00	\$33,000.00
10	12.14 BEST MANAGEMENT PRACTICE	LS	1	\$2,000.00	\$2,000.00
SUBTOTAL					\$144,520.00
CONTINGENCIES (10%)					\$14,452.00
TOTAL BASE BID					\$158,972.00

Note: See section 01025 Measurement and Payment for bid form definitions

NKWD SUBDISTRICT 'O' - SCENIC RIDGE DRIVE WATER MAIN EXTENSION

Final Review 04-15-2025

Item No.	Description	Unit of Measure	Estimated Quantity	Unit Cost Total	Total Cost
1	6.03 C-900, C-909 Poly Vinyl Chloride (PVC) (8") (Detail 103, 103a, 104, 104a, 110)	LF	1526	\$135.00	\$206,010.00
2	7.01 CONNECT TO EXISTING MAIN/TIE-IN (8")	EA	1	\$5,000.00	\$5,000.00
3	8.01 INSTALL FIRE HYDRANT ASSEMBLY	EA	4	\$8,000.00	\$32,000.00
4	9.01 DUCTILE IRON RESILIENT SEATED GATE VALVE (8")	EA	2	\$2,800.00	\$5,600.00
5	10.05 INSTALL WATER METER SETTING (Service line materials provided by NKWD)	EA	6	\$3,000.00	\$18,000.00
6	11.04 PLUG AND BLOCK (8")	EA	1	\$600.00	\$600.00
7	11.06 8"x8"x6" ANCHORING TEE AND BLOCK	EA	4	\$1,000.00	\$4,000.00
8	12.05 1-1/2" ASPHALTIC CONCRETE MILLING AND PAVING	SY	1500	\$60.00	\$90,000.00
9	12.06 ASPHALTIC CONCRETE - TRENCH RESTORATION	SY	500	\$200.00	\$100,000.00
10	12.07 ASPHALTIC CONCRETE - DRIVEWAY	SY	22	\$150.00	\$3,240.00
11	12.14 BEST MANAGEMENT PRACTICE	LS	1	\$2,000.00	\$2,000.00
SUBTOTAL					\$466,450.00
CONTINGENCIES (10%)					\$46,645.00
TOTAL BASE BID					\$513,095.00

Note: See section 01025 Measurement and Payment for bid form definitions

NKWD SUBDISTRICT 'O' - DECOURSEY PIKE WATER MAIN EXTENSION

Final Review 04-15-2025

Item No.	Description	Unit of Measure	Estimated Quantity	Unit Cost Total	Total Cost
1	6.01 CLASS 52 DUCTILE IRON PIPE (8"). (Detail 103, 103a, 104, 104a, 110)	LF	464	\$160.00	\$74,240.00
2	7.01 CONNECT TO EXISTING MAIN/TIE-IN (8")	EA	1	\$5,000.00	\$5,000.00
3	SPL - KYTC CHANNEL LINING, CLASS II (12") w/ NON-WOVEN GEOTEXTILE FILTER FABRIC	SY	8	\$150.00	\$1,200.00
4	12.14 BEST MANAGEMENT PRACTICE	LS	1	\$2,000.00	\$2,000.00
SUBTOTAL					\$82,440.00
CONTINGENCIES (10%)					\$8,244.00
TOTAL BASE BID					\$90,684.00
Note: See section 01025 Measurement and Payment for bid form definitions					

NKWD SUBDISTRICT 'O' - STEEP CREEK ROAD WATER MAIN EXTENSION

Final Review 04-15-2025

Item No.	Description	Unit of Measure	Estimated Quantity	Unit Cost Total	Total Cost
1	6.01 CLASS 50 DUCTILE IRON PIPE (8"). (Detail 103, 103a, 104, 104a, 110)	LF	5370	\$160.00	\$859,200.00
2	7.01 CONNECT TO EXISTING MAIN/TIE-IN (8")	EA	0	\$5,000.00	\$0.00
3	8.01 INSTALL FIRE HYDRANT ASSEMBLY	EA	6	\$8,000.00	\$48,000.00
4	9.01 DUCTILE IRON RESILIENT SEATED GATE VALVE (8")	EA	6	\$2,800.00	\$16,800.00
5	10.05 INSTALL WATER METER SETTING (Service line materials provided by NKWD)	EA	4	\$3,000.00	\$12,000.00
6	11.04 PLUG AND BLOCK (8")	EA	1	\$600.00	\$600.00
7	11.06 8"x8"x6" ANCHORING TEE AND BLOCK	EA	6	\$1,000.00	\$6,000.00
8	11.06 8"x8"x8" ANCHORING TEE AND BLOCK	EA	1	\$1,200.00	\$1,200.00
9	12.05 1-1/2" ASPHALTIC CONCRETE MILLING AND PAVING	SY	1300	\$60.00	\$78,000.00
10	12.06 ASPHALTIC CONCRETE - TRENCH RESTORATION	SY	510	\$200.00	\$102,000.00
11	12.13 GRAVEL DRIVEWAY	SY	20	\$60.00	\$1,200.00
12	SPL - KYTC CHANNEL LINING, CLASS II (12") w/ NON-WOVEN GEOTEXTILE FILTER FABRIC	SY	50	\$150.00	\$7,500.00
13	12.14 BEST MANAGEMENT PRACTICE	LS	1	\$2,000.00	\$2,000.00
SUBTOTAL					\$1,134,500.00
CONTINGENCIES (10%)					\$113,450.00
TOTAL BASE BID					\$1,247,950.00
Note: See section 01025 Measurement and Payment for bid form definitions					

NKWD SUBDISTRICT 'O' - MANN ROAD WATER MAIN EXTENSION

Final Review 04-15-2025

Item No.	Description	Unit of Measure	Estimated Quantity	Unit Cost Total	Total Cost
1	6.01 CLASS 50 DUCTILE IRON PIPE (8"). (Detail 103, 103a, 104, 104a, 110)	LF	303	\$160.00	\$48,480.00
2	6.02 CLASS 50 DUCTILE IRON PIPE (8") – RESTRAINED JOINT.	LF	288	\$170.00	\$48,960.00
3	7.01 CONNECT TO EXISTING MAIN/TIE-IN (8")	EA	1	\$5,000.00	\$5,000.00
4	8.01 INSTALL FIRE HYDRANT ASSEMBLY	EA	1	\$8,000.00	\$8,000.00
5	9.01 DUCTILE IRON RESILIENT SEATED GATE VALVE (8")	EA	1	\$2,800.00	\$2,800.00
6	10.05 INSTALL WATER METER SETTING (Service line materials provided by NKWD)	EA	4	\$3,000.00	\$12,000.00
7	11.01 CONCRETE ENCASEMENT	LF	88	\$150.00	\$13,200.00
8	11.04 PLUG AND BLOCK (8")	EA	1	\$600.00	\$600.00
9	11.06 8"x8"x6" ANCHORING TEE AND BLOCK	EA	1	\$1,000.00	\$1,000.00
10	11.11 TEST TAP	EA	1	\$3,000.00	\$3,000.00
11	12.05 1-1/2" ASPHALTIC CONCRETE MILLING AND PAVING	SY	125	\$60.00	\$7,500.00
12	12.06 ASPHALTIC CONCRETE - TRENCH RESTORATION	SY	20	\$200.00	\$4,000.00
13	12.13 GRAVEL DRIVEWAY	SY	11	\$60.00	\$660.00
14	12.14 BEST MANAGEMENT PRACTICE	LS	1	\$2,000.00	\$2,000.00
SUBTOTAL					\$157,200.00
CONTINGENCIES (10%)					\$15,720.00
TOTAL BASE BID					\$172,920.00
Note: See section 01025 Measurement and Payment for bid form definitions					

NKWD SUBDISTRICT 'O' - GENE STREET WATER MAIN EXTENSION

Final Review 04-15-2025

Item No.	Description	Unit of Measure	Estimated Quantity	Unit Cost Total	Total Cost
1	6.01 CLASS 52 DUCTILE IRON PIPE (8"). (Detail 103, 103a, 104, 104a, 110)	LF	50	\$160.00	\$8,000.00
2	6.03 C-900, C-909 Poly Vinyl Chloride (PVC) (8") (Detail 103, 103a, 104, 104a, 110)	LF	1214	\$135.00	\$163,890.00
3	7.01 CONNECT TO EXISTING MAIN/TIE-IN (8")	EA	1	\$5,000.00	\$5,000.00
4	8.01 INSTALL FIRE HYDRANT ASSEMBLY	EA	3	\$8,000.00	\$24,000.00
5	10.05 INSTALL WATER METER SETTING (Service line materials provided by NKWD)	EA	4	\$3,000.00	\$12,000.00
6	11.04 PLUG AND BLOCK (8")	EA	1	\$600.00	\$600.00
7	11.06 8"x8"x6" ANCHORING TEE AND BLOCK	EA	3	\$1,000.00	\$3,000.00
8	12.05 1-1/2" ASPHALTIC CONCRETE MILLING AND PAVING	SY	830	\$60.00	\$49,800.00
9	12.09 CONCRETE PAVEMENT - TRENCH RESTORATION	SY	100	\$200.00	\$20,000.00
10	12.10 CONCRETE DRIVEWAY	SY	31	\$150.00	\$4,650.00
11	12.13 GRAVEL DRIVEWAY	SY	47	\$60.00	\$2,820.00
12	12.14 BEST MANAGEMENT PRACTICE	LS	1	\$2,000.00	\$2,000.00
SUBTOTAL					\$295,760.00
CONTINGENCIES (10%)					\$29,576.00
TOTAL BASE BID					\$325,336.00

Note: See section 01025 Measurement and Payment for bid form definitions

NKWD SUBDISTRICT 'O' - FISKBURG ROAD WATER MAIN EXTENSION

Final Review 04-15-2025

Item No.	Description	Unit of Measure	Estimated Quantity	Unit Cost Total	Total Cost
1	6.01 CLASS 52 DUCTILE IRON PIPE (8"). (Detail 103, 103a, 104, 104a, 110)	LF	4197	\$160.00	\$671,520.00
2	7.01 CONNECT TO EXISTING MAIN/TIE-IN (8")	EA	1	\$5,000.00	\$5,000.00
3	8.01 INSTALL FIRE HYDRANT ASSEMBLY	EA	5	\$8,000.00	\$40,000.00
4	9.01 DUCTILE IRON RESILIENT SEATED GATE VALVE (8")	EA	7	\$2,800.00	\$19,600.00
5	10.05 INSTALL WATER METER SETTING (Service line materials provided by NKWD)	EA	7	\$3,000.00	\$21,000.00
6	11.04 PLUG AND BLOCK (8")	EA	1	\$600.00	\$600.00
7	11.05 AIR RELEASE VALVE (ARV and service line materials provided by NKWD)	EA	1	\$3,000.00	\$3,000.00
8	11.06 8"x8"x6" ANCHORING TEE AND BLOCK	EA	5	\$1,000.00	\$5,000.00
9	11.06 8"x8"x8" ANCHORING TEE AND BLOCK	EA	2	\$1,200.00	\$2,400.00
10	12.05 1-1/2" ASPHALTIC CONCRETE MILLING AND PAVING	SY	1100	\$60.00	\$66,000.00
11	12.06 ASPHALTIC CONCRETE - TRENCH RESTORATION	SY	245	\$200.00	\$49,000.00
12	12.10 CONCRETE DRIVEWAY	SY	22	\$150.00	\$3,270.00
13	12.13 GRAVEL DRIVEWAY	SY	80	\$60.00	\$4,788.00
14	12.14 BEST MANAGEMENT PRACTICE	LS	1	\$2,000.00	\$2,000.00
SUBTOTAL					\$893,178.00
CONTINGENCIES (10%)					\$89,317.80
TOTAL BASE BID					\$982,495.80
Note: See section 01025 Measurement and Payment for bid form definitions					

NKWD SUBDISTRICT 'O' - ALEXANDER ROAD WATER MAIN EXTENSION

Final Review 04-15-2025

Item No.	Description	Unit of Measure	Estimated Quantity	Unit Cost Total	Total Cost
1	6.01 CLASS 52 DUCTILE IRON PIPE (8") . (Detail 103, 103a, 104, 104a, 110)	LF	65	\$160.00	\$10,400.00
2	6.03 C-900, C-909 Poly Vinyl Chloride (PVC) (8") (Detail 103, 103a, 104, 104a, 110)	LF	2569	\$135.00	\$346,815.00
3	7.01 CONNECT TO EXISTING MAIN/TIE-IN (8")	EA	1	\$5,000.00	\$5,000.00
4	8.01 INSTALL FIRE HYDRANT ASSEMBLY	EA	4	\$8,000.00	\$32,000.00
5	9.01 DUCTILE IRON RESILIENT SEATED GATE VALVE (8")	EA	1	\$2,800.00	\$2,800.00
6	10.05 INSTALL WATER METER SETTING (Service line materials provided by NKWD)	EA	4	\$3,000.00	\$12,000.00
7	11.04 PLUG AND BLOCK (8")	EA	1	\$600.00	\$600.00
8	11.06 8"x8"x6" ANCHORING TEE AND BLOCK	EA	4	\$1,000.00	\$4,000.00
9	12.05 1-1/2" ASPHALTIC CONCRETE MILLING AND PAVING	SY	3000	\$60.00	\$180,000.00
10	12.06 ASPHALTIC CONCRETE - TRENCH RESTORATION	SY	800	\$200.00	\$160,000.00
11	12.07 ASPHALTIC CONCRETE - DRIVEWAY	SY	14	\$150.00	\$2,100.00
12	12.13 GRAVEL DRIVEWAY	SY	35	\$60.00	\$2,100.00
13	12.14 BEST MANAGEMENT PRACTICE	LS	1	\$2,000.00	\$2,000.00
SUBTOTAL					\$759,815.00
CONTINGENCIES (10%)					\$75,981.50
TOTAL BASE BID					\$835,796.50
Note: See section 01025 Measurement and Payment for bid form definitions					

NKWD SUBDISTRICT 'O' - ELLIOT ROAD WATER MAIN EXTENSION

Final Review 04-15-2025

Item No.	Description	Unit of Measure	Estimated Quantity	Unit Cost Total	Total Cost
1	6.01 CLASS 52 DUCTILE IRON PIPE (8") . (Detail 103, 103a, 104, 104a, 110)	LF	54	\$160.00	\$8,640.00
2	6.03 C-900, C-909 Poly Vinyl Chloride (PVC) (8") (Detail 103, 103a, 104, 104a, 110)	LF	4829	\$135.00	\$651,915.00
3	7.01 CONNECT TO EXISTING MAIN/TIE-IN (16")	EA	1	\$7,000.00	\$7,000.00
4	8.01 INSTALL FIRE HYDRANT ASSEMBLY	EA	7	\$8,000.00	\$56,000.00
5	9.01 DUCTILE IRON RESILIENT SEATED GATE VALVE (8")	EA	3	\$2,800.00	\$8,400.00
6	10.05 INSTALL WATER METER SETTING (Service line materials provided by NKWD)	EA	6	\$3,000.00	\$18,000.00
7	11.04 PLUG AND BLOCK (8")	EA	1	\$600.00	\$600.00
8	11.06 8"x8"x6" ANCHORING TEE AND BLOCK	EA	7	\$1,000.00	\$7,000.00
9	12.05 1-1/2" ASPHALTIC CONCRETE MILLING AND PAVING	SY	5500	\$60.00	\$330,000.00
10	12.06 ASPHALTIC CONCRETE - TRENCH RESTORATION	SY	1650	\$200.00	\$330,000.00
11	12.07 ASPHALTIC CONCRETE - DRIVEWAY	SY	89	\$150.00	\$13,350.00
12	12.10 CONCRETE DRIVEWAY	SY	33	\$150.00	\$4,950.00
13	12.13 GRAVEL DRIVEWAY	SY	60	\$60.00	\$3,600.00
14	12.14 BEST MANAGEMENT PRACTICE	LS	1	\$2,000.00	\$2,000.00
SUBTOTAL					\$1,441,455.00
CONTINGENCIES (10%)					\$144,145.50
TOTAL BASE BID					\$1,585,600.50
Note: See section 01025 Measurement and Payment for bid form definitions					



EXHIBIT A-3

SYSTEM HYDRAULIC MODEL



FIRE FLOW CERTIFICATION

Sub-District O

**Gene St., Scenic Ridge Dr., Mason Rd., Alexander Rd., Fiskburg Rd.,
Goshorn Rd., Webster Rd., Pfanstiehl Rd., Elliott Rd., Justice Ln.,
Highwater Rd., Trace Run Rd., Mann Rd., & Steep Creek Rd.
Kenton County, KY
June 30, 2024**

I certify that the proposed improvements meet the 807 KAR 5:066, Section 10b regulation for fire flow protection relating to KRS Chapter 278. I am certifying that "the system can provide a minimum fire flow of 250 gallons per minute; and the water system supporting this flow has the capability of providing this flow for a period of not less than two (2) hours plus consumption at the maximum daily rate". This certification is based on the information available and is not a guarantee of any precise results.

This certification is based on hydraulic modeling performed using InfoWater, the program available from Innovyze. Supporting documentation and operating conditions are attached and are the basis for this certification.

It should be noted that input data used for modeling is based on available data. Results can change and are dependent on the demand conditions, which can vary at any given time. These values will impact the final results when adjusted. The certification is based on estimated conditions and contains many assumptions based on historical data.

With this certification, the Northern Kentucky Water District will permit the construction of fire hydrants within this project.

Fire flow analyses were made using a hydrant within the project area that would provide a representative result that should simulate the results at other hydrants within the system. Minor variations at different hydrants would still provide a flow rate that meets the minimum standard.





HYDRAULIC AND FLUSHING VELOCITY CERTIFICATION

Sub-District O

**Gene St., Scenic Ridge Dr., Mason Rd., Alexander Rd., Fiskburg Rd.,
Goshorn Rd., Webster Rd., Pfanstiehl Rd., Elliott Rd., Justice Ln.,
Highwater Rd., Trace Run Rd., Mann Rd., & Steep Creek Rd.
Kenton County, KY
June 30, 2024**

I certify that the proposed improvements are hydraulically capable of meeting the Kentucky Division of Water General Design Criteria for Surface and Ground Water Supplies standard for flushing velocity in the main meeting 2.5 feet per second while maintaining at least 20 psi pressure in accordance with 401 KAR 8:100.

The maximum flow rate that can reliably be supplied to the main and meet 20 psi in the system under maximum hour conditions is:

- Gene Street – 1,400 gpm
- Scenic Ridge Drive – 1,500 gpm
- Mason Road – 425 gpm
- Alexander Rd., Fiskburg Rd., & Pfanstiehl Rd. – 500 gpm
- Goshorn Road – 600 gpm
- Webster Road – 1,500 gpm
- Elliott Road – 950 gpm
- Justice Lane – 450 gpm
- Highwater Road – 1,500 gpm
- Trace Run Road – 950 gpm
- Mann Road & Steep Creek Road – 850 gpm

At least 30 psi can be maintained under the peak domestic demand for the 123 customers affected. The peak domestic demand using the D.R. Taylor formula is:

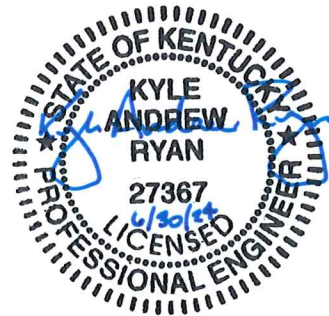
- 22.4 gpm on Gene Street (5 potential customers)
- 24.5 gpm on Scenic Ridge Drive (6 potential customers)
- 20.0 gpm on Mason Road (4 potential customers)
- 64.8 gpm on Alexander Rd., Fiskburg Rd., & Pfanstiehl Rd. (42 potential customers)
- 36.1 gpm on Goshorn Road (13 potential customers)
- 34.6 gpm on Webster Road (12 potential customers)
- 36.1 gpm on Elliott Road (13 potential customers)
- 20.0 gpm on Justice Lane (4 potential customers)
- 10.0 gpm on Highwater Road (1 potential customer)
- 31.6 gpm on Trace rund Road (10 potential customers)
- 36.1 gpm on Mann Rd. & Steep Creek Rd. (13 potential customers)

This certification is based on the information available and is not a guarantee of any precise results. Results are based on hydraulic modeling performed using InfoWater, the program available from Innovyze. Supporting documentation and operating conditions are attached and are the basis for this certification.

It should be noted that input data used for modeling is based on available data. Results can change and are dependent on the demand conditions, which can vary at any given time. These values will impact the final results when adjusted. The certification is based on estimated conditions for maximum hour demand conditions and contains many assumptions based on historical data.

With this certification, the Northern Kentucky Water District will permit the construction of the proposed development.

The assumed Hazen-Williams roughness coefficient for all new pipe was 120, which is suitable for ductile iron or PVC. The water level in the Devon, Industrial, Independence, Kenton Lands, & Barrington Tanks were one-half full.



Sub-District O

Gene St., Scenic Ridge Dr., Mason Rd.,
 Alexander Rd., Fiskburg Rd., Goshorn Rd.,
 Webster Rd., Pfanstiehl Rd., Elliott Rd., Justice Ln.
 Highwater Rd., Trace Run Rd., Mann Rd., Steep Creek Rd.
 Kenton County, Kentucky



Output from InfoWater model - copied to Excel

June 30, 2024

Maximum Hour Run for Potential Customers

Gene Street

Maximum Hour Run, 5 potential Customers = 22.4 GPM				
9047N	7.5	940	1064.2	53.8
J68	7.5	912	1064.1	65.9
J70	7.5	930	1064.1	58.1

Scenic Ridge Drive

Maximum Hour Run, 6 potential Customers = 24.5 GPM				
8004N	4.9	846	1070.6	97.3
J72	4.9	838	1070.6	100.8
J74	4.9	842	1070.6	99.0
J76	4.9	824	1070.6	106.9
J80	4.9	851	1070.6	95.2

Mason Road

Maximum Hour Run, 4 potential Customers = 20 GPM				
9671N	6.7	740	1014.6	119.0
J82	6.7	576	1014.6	190.0
J84	6.7	665	1014.6	151.5

Alexander Rd, Fiskburg Road, & Pfanstiehl Road

Maximum Hour Run, 42 potential Customers = 64.8 GPM				
7109N	5.4	874	1047.5	75.2
J100	5.4	827	1047.4	95.5
J102	5.4	828	1047.4	95.1
J104	5.4	868	1047.4	77.7
J106	5.4	874	1047.4	75.1
J108	5.4	867	1047.4	78.2
J110	5.4	860	1047.4	81.2
J112	5.4	878	1047.4	73.4
J114	5.4	862	1047.4	80.3
J94	5.4	882	1047.4	71.7
J96	5.4	735	1047.4	135.3
J98	5.4	857	1047.4	82.5

Goshorn Road

Maximum Hour Run, 13 potential Customers = 36.1 GPM				
7010N	7.2	870	1047.6	76.9
J86	7.2	848	1047.5	86.4
J88	7.2	864	1047.5	79.5
J90	7.2	863	1047.5	79.9
J92	7.2	877	1047.5	73.9

Scenic Ridge Drive

Flushing velocity for new 8" pipe (under max hour)				
ID	Demand, gpm	Elevation, ft	Grade, ft	Pressure, psi
8004N	4.9	846	1063.5	94.2
J72	392.0	838	1057.7	95.2
J74	4.9	842	1058.6	93.8
J76	4.9	824	1061.1	102.7
J80	4.9	851	1062.9	91.8

Pipe Information for flushing velocity for new 8" pipe					
Pipe ID	Length, ft	Diam, inch	Flow, gpm	Velocity, fps	Roughness
P581	129	8	407	2.6	120
P583	667	8	397	2.5	120
P585	238	8	392	2.5	120
P587	470	8	402	2.6	120

Mason Road

Flushing velocity for new 8" pipe (under max hour)				
ID	Demand, gpm	Elevation, ft	Grade, ft	Pressure, psi
9671N	6.7	740	906.8	72.3
J82	392.0	576	902.6	141.5
J84	6.7	665	904.7	103.9

Pipe Information for flushing velocity at 2.5 fps for new 8" pipe					
Pipe ID	Length, ft	Diam, inch	Flow, gpm	Velocity, fps	Roughness
P589	545	8	399	2.5	120
P591	574	8	392	2.5	120

Alexander Rd., Fiskburg Rd.

Flushing velocity for new 8" pipe (under max hour)				
ID	Demand, gpm	Elevation, ft	Grade, ft	Pressure, psi
7109N	5.4	874	998.7	54.1
J100	5.4	827	994.4	72.5
J102	5.4	828	994.4	72.1
J104	5.4	868	994.4	54.8
J106	5.4	874	981.5	46.6
J108	5.4	867	988.6	52.7
J110	392.0	860	971.7	48.4
J112	5.4	878	974.0	41.6
J114	5.4	862	977.8	50.2
J94	5.4	882	994.5	48.7
J96	5.4	735	994.4	112.4
J98	5.4	857	994.4	59.5

Pipe Information for flushing velocity at 2.5 fps for new 8" pipe					
Pipe ID	Length, ft	Diam, inch	Flow, gpm	Velocity, fps	Roughness
P601	901	8	446	2.9	120
P613	1429	8	414	2.6	120
P615	1748	8	408	2.6	120
P617	945	8	403	2.6	120
P619	1001	8	397	2.5	120
P621	614	8	392	2.5	120

Pfanstiel Road**Flushing velocity for new 8" pipe (under max hour)**

ID	Demand, gpm	Elevation, ft	Grade, ft	Pressure, psi
7109N	5.4	874	998.7	54.1
J100	5.4	827	972.2	62.9
J102	5.4	828	977.1	64.6
J104	5.4	868	989.3	52.6
J106	5.4	874	994.4	52.2
J108	5.4	867	994.4	55.2
J110	5.4	860	994.4	58.2
J112	5.4	878	994.4	50.4
J114	5.4	862	994.4	57.4
J94	5.4	882	994.5	48.7
J96	392.0	735	966.8	100.4
J98	5.4	857	983.8	54.9

Pipe Information for flushing velocity at 2.5 fps for new 8" pipe

Pipe ID	Length, ft	Diam, inch	Flow, gpm	Velocity, fps	Roughness
P603	1250	8	414	2.6	120
P605	1369	8	408	2.6	120
P607	1690	8	403	2.6	120
P609	1291	8	397	2.5	120
P611	1445	8	392	2.5	120

Goshorn Road**Flushing velocity for new 8" pipe (under max hour)**

ID	Demand, gpm	Elevation, ft	Grade, ft	Pressure, psi
7010N	7.2	870	999.7	56.2
J86	392.0	848	982.3	58.2
J88	7.2	864	988.6	54.0
J90	7.2	863	985.3	53.0
J92	7.2	877	995.5	51.4

Pipe Information for flushing velocity at 2.5 fps for new 8" & 12" pipe

Pipe ID	Length, ft	Diam, inch	Flow, gpm	Velocity, fps	Roughness
P593	1007	8	414	2.6	120
P595	1724	8	406	2.6	120
P597	852	8	399	2.6	120
P599	816	8	392	2.5	120

Webster Road**Flushing velocity for new 8" pipe (under max hour)**

ID	Demand, gpm	Elevation, ft	Grade, ft	Pressure, psi
J116	5.8	653	1053.0	173.3
J118	392.0	642	1049.5	176.6
J120	5.8	623	1056.2	187.7
J122	392.0	615	1058.5	192.2
J124	5.8	635	1079.5	192.6
J126	5.8	615	1059.2	192.5

Pipe Information for flushing velocity for new 8" pipe

Pipe ID	Length, ft	Diam, inch	Flow, gpm	Velocity, fps	Roughness
P625	1446	8	801	5.1	120
P627	179	8	392	2.5	120
P629	751	8	404	2.6	120
P631	832	8	398	2.5	120
P633	949	8	392	2.5	120

Elliott Road

Flushing velocity for new 8" pipe (under max hour)				
ID	Demand, gpm	Elevation, ft	Grade, ft	Pressure, psi
9239N	7.2	887	1031.9	62.8
J128	392.0	837	1012.8	76.2
J130	7.2	875	1020.7	63.1
J132	7.2	857	1016.3	69.0
J134	7.2	878	1025.8	64.0

Pipe Information for flushing velocity for new 8" pipe					
Pipe ID	Length, ft	Diam, inch	Flow, gpm	Velocity, fps	Roughness
P635	1491	8	414	2.6	120
P637	1261	8	406	2.6	120
P639	1128	8	399	2.6	120
P641	939	8	392	2.5	120

Justice Lane

Flushing velocity for new 8" pipe (under max hour)				
ID	Demand, gpm	Elevation, ft	Grade, ft	Pressure, psi
7922N	6.7	844	954.2	47.8
J136	392.0	840	947.4	46.5
J138	6.7	847	952.0	45.5

Pipe Information for flushing velocity for new 8" pipe					
Pipe ID	Length, ft	Diam, inch	Flow, gpm	Velocity, fps	Roughness
P643	562	8	399	2.5	120
P645	1239	8	392	2.5	120

Highwater Road

Flushing velocity for new 8" pipe (under max hour)				
ID	Demand, gpm	Elevation, ft	Grade, ft	Pressure, psi
1962N	5.0	796	1007.4	91.6
J140	392.0	775	1006.0	100.1

Pipe Information for flushing velocity for new 8" pipe					
Pipe ID	Length, ft	Diam, inch	Flow, gpm	Velocity, fps	Roughness
P647	366	8	392	2.5	120

Trace Run Road

Flushing velocity for new 8" pipe (under max hour)				
ID	Demand, gpm	Elevation, ft	Grade, ft	Pressure, psi
9162N	7.9	886	1045.7	69.2
J142	392.0	861	1029.5	73.0
J144	7.9	882	1040.3	68.6
J146	7.9	876	1035.5	69.1

Pipe Information for flushing velocity for new 8" pipe					
Pipe ID	Length, ft	Diam, inch	Flow, gpm	Velocity, fps	Roughness
P649	1356	8	408	2.6	120
P651	1236	8	400	2.6	120
P653	1594	8	392	2.5	120

Steep Creek**Flushing velocity for new 8" pipe (under max hour)**

ID	Demand, gpm	Elevation, ft	Grade, ft	Pressure, psi
8647N	7.2	598	736.2	59.9
J148	392.0	575	713.1	59.9
J150	7.2	530	721.1	82.8
J152	7.2	538	727.7	82.2
J154	7.2	548	721.1	75.0

Pipe Information for flushing velocity for new 8" pipe

Pipe ID	Length, ft	Diam, inch	Flow, gpm	Velocity, fps	Roughness
P655	2060	8	414	2.6	120
P657	1656	8	406	2.6	120
P659	2122	8	392	2.5	120

Mann Road**Flushing velocity for new 8" pipe (under max hour)**

ID	Demand, gpm	Elevation, ft	Grade, ft	Pressure, psi
8647N	7.2	598	736.2	59.9
J148	7.2	575	721.0	63.3
J150	7.2	530	721.1	82.8
J152	7.2	538	727.7	82.2
J154	392.0	548	718.7	74.0

Pipe Information for flushing velocity for new 8" pipe

Pipe ID	Length, ft	Diam, inch	Flow, gpm	Velocity, fps	Roughness
P661	627	8	392	2.5	120

Maximum Available Flow Under Maximum Hour**Gene Street****Maximum Hour Run, Maximum Available Flow**

ID	Demand, gpm	Elevation, ft	Grade, ft	Pressure, psi
9047N	7.5	940	1047.3	46.5
J68	1400.0	912	997.0	36.8
J70	7.5	930	1023.4	40.5

Scenic Ridge Drive**Maximum Hour Run, Maximum Available Flow**

ID	Demand, gpm	Elevation, ft	Grade, ft	Pressure, psi
8004N	4.9	846	1039.9	84.0
J72	1500.0	838	971.9	58.0
J74	4.9	842	982.6	60.9
J76	4.9	824	1012.7	81.8
J80	4.9	851	1034.0	79.3

Mason Road**Maximum Hour Run, Maximum Available Flow**

ID	Demand, gpm	Elevation, ft	Grade, ft	Pressure, psi
9671N	6.7	740	890.5	65.2
J82	425.0	576	885.6	134.1
J84	6.7	665	888.1	96.7
9673N*	1.5	842	896.1	23.4

* Area of min. pressure

Alexander Rd, Fiskburg Road, & Pfanstiehl Road

Maximum Hour Run, Maximum Available Flow				
7109N	5.4	874	977.9	45.0
J100	5.4	827	971.5	62.6
J102	5.4	828	971.5	62.2
J104	5.4	868	971.5	44.9
J106	5.4	874	951.6	33.6
J108	5.4	867	962.5	41.4
J110	500.0	860	936.2	33.0
J112	5.4	878	939.8	26.8
J114	5.4	862	945.8	36.3
J94	5.4	882	971.5	38.8
J96	5.4	735	971.5	102.5
J98	5.4	857	971.5	49.6

Goshorn Road

Maximum Hour Run, Maximum Available Flow				
7010N	7.2	870	957.7	38.0
J86	600.0	848	920.2	31.3
J88	7.2	864	934.1	30.4
J90	7.2	863	926.9	27.7
J92	7.2	877	948.9	31.2

Webster Road

Maximum Hour Run, Maximum Available Flow				
J116	5.8	653	932.6	121.1
J118	1500.0	642	890.0	107.5
J120	5.8	623	970.2	150.5
J122	5.8	615	1004.4	168.7
J124	5.8	635	1071.2	189.0
J126	5.8	615	1004.4	168.7

Elliott Road

Maximum Hour Run, Maximum Available Flow				
9239N	7.2	887	996.4	47.4
J128	950.0	837	901.3	27.9
J130	7.2	875	941.5	28.8
J132	7.2	857	919.4	27.1
J134	7.2	878	966.5	38.3

Justice Lane

Maximum Hour Run, Maximum Available Flow				
7922N	6.7	844	936.4	40.1
J136	450.0	840	927.7	38.0
J138	6.7	847	933.6	37.5
7944N*	0.1	871.08	941.7	30.6

*Area of min. pressure

Highwater Road

Maximum Hour Run, Maximum Available Flow				
1962N	5.0	796	961.7	71.8
J140	1500.0	775	945.3	73.8


Trace Run Road


Maximum Hour Run, Maximum Available Flow				
9162N	7.9	886	1005.8	51.9
J142	950.0	861	923.9	27.3
J144	7.9	882	978.8	42.0
J146	7.9	876	954.6	34.1

Mann Road & Steep Creek Road

Maximum Hour Run, Maximum Available Flow				
8647N	7.2	598	727.9	56.3
J148	850.0	575	634.1	25.6
J150	7.2	530	667.3	59.5
J152	7.2	538	694.1	67.6
J154	7.2	548	667.3	51.7

<u>Pipe ID</u>	<u>From Node</u>	<u>To Node</u>
P577	9047N	J70
P579	J70	J68
P585	J74	J72
P583	J76	J74
P587	J80	J76
P581	8004N	J80
P589	9671N	J84
P591	J84	J82
P593	7010N	J92
P595	J92	J88
P597	J88	J90
P599	J90	J86
P601	7109N	J94
P603	J94	J104
P605	J104	J98
P607	J98	J102
P609	J102	J100
P611	J100	J96
P613	J94	J108
P615	J108	J106
P617	J106	J114
P619	J114	J112
P621	J112	J110
P625	J124	J126
P627	J126	J122
P629	J126	J120
P631	J120	J116
P633	J116	J118
P635	9239N	J134
P637	J134	J130
P639	J130	J132
P641	J132	J128
P643	7922N	J138
P645	J138	J136
P647	1962N	J140
P649	9162N	J144
P651	J144	J146
P653	J146	J142
P655	8647N	J152
P657	J152	J150
P659	J150	J148
P661	J150	J154

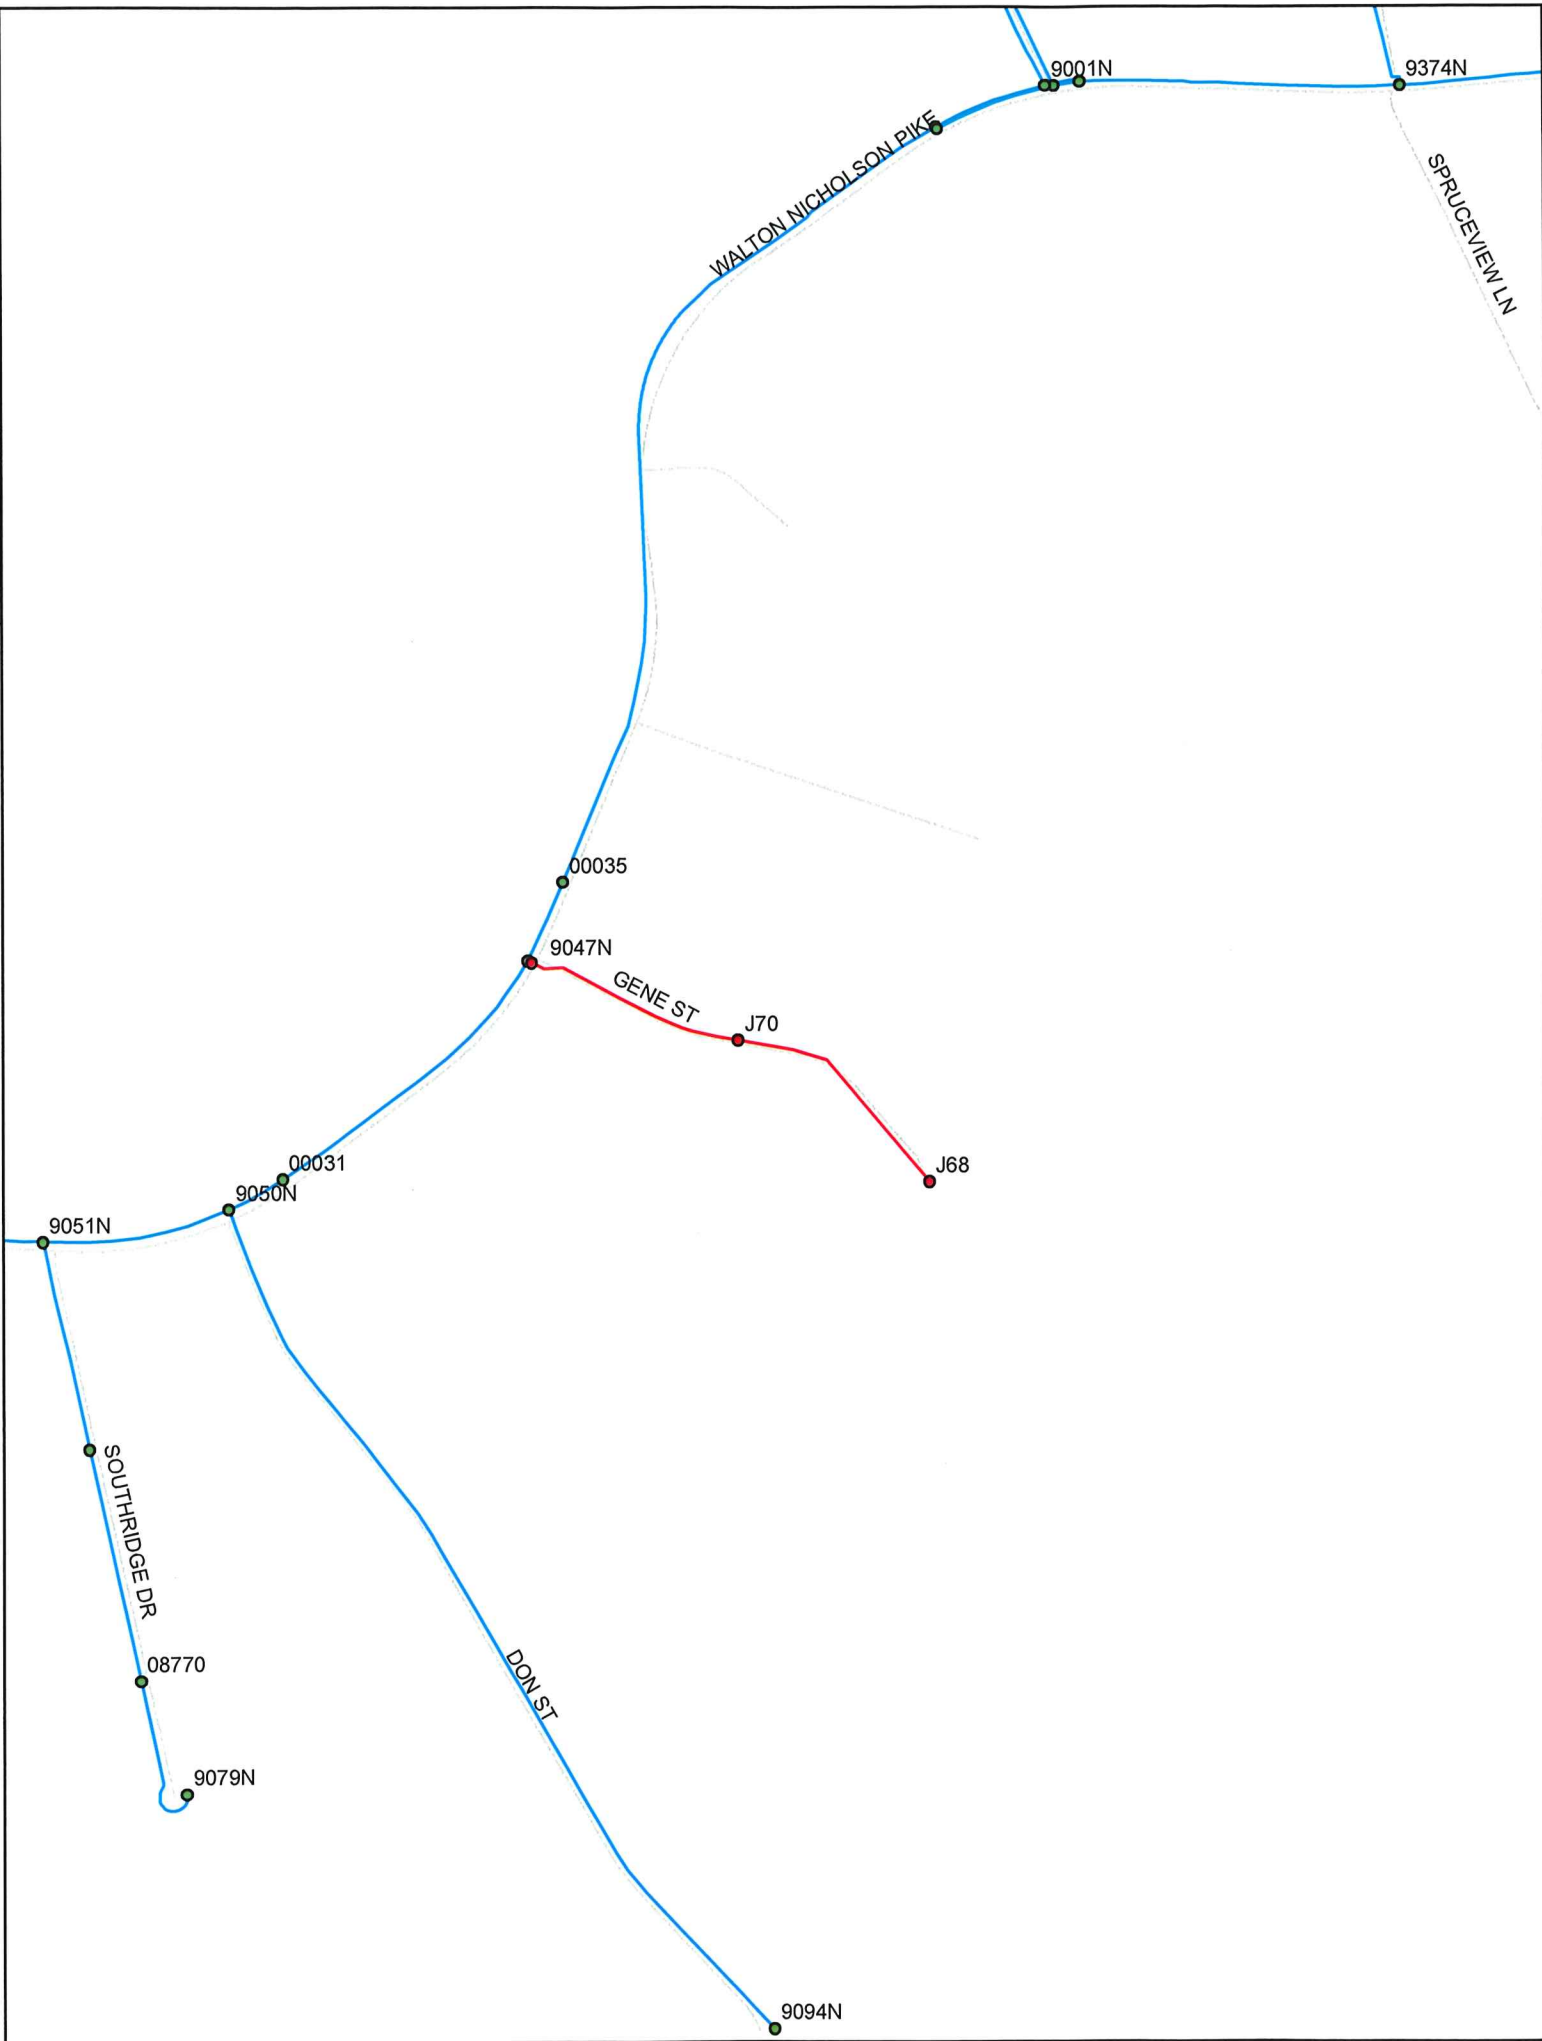

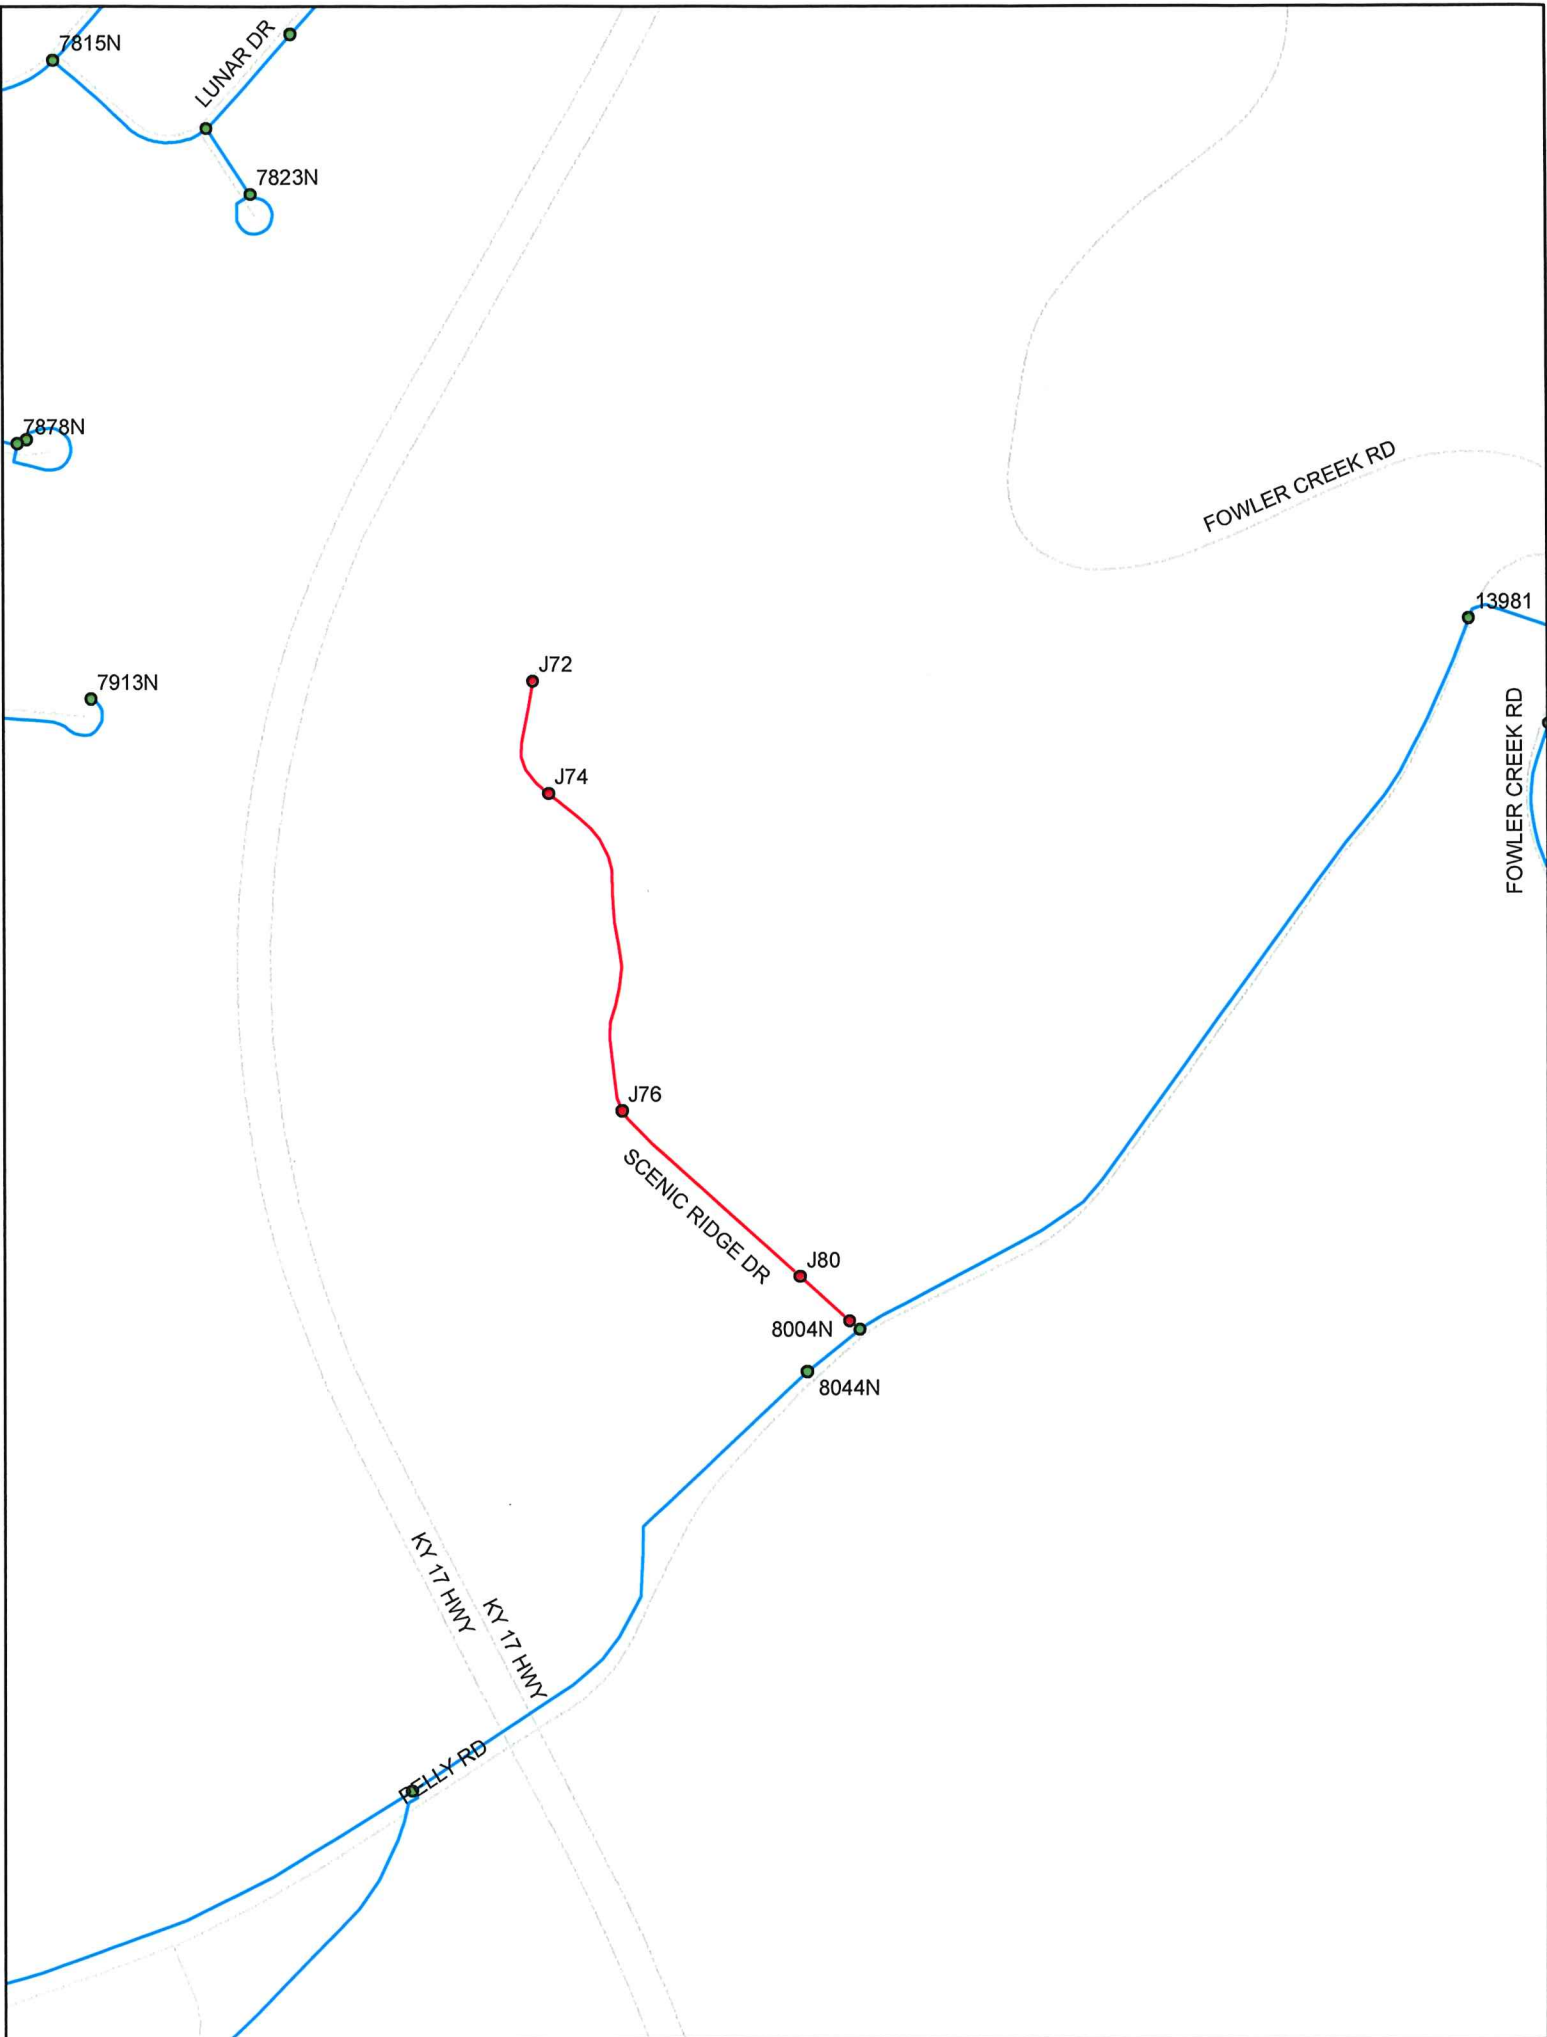

7815N

LUNAR DR

7823N

7878N

7913N

J72

J74

J76

SCENIC RIDGE DR

J80

8004N

8044N

KY 17 HWY

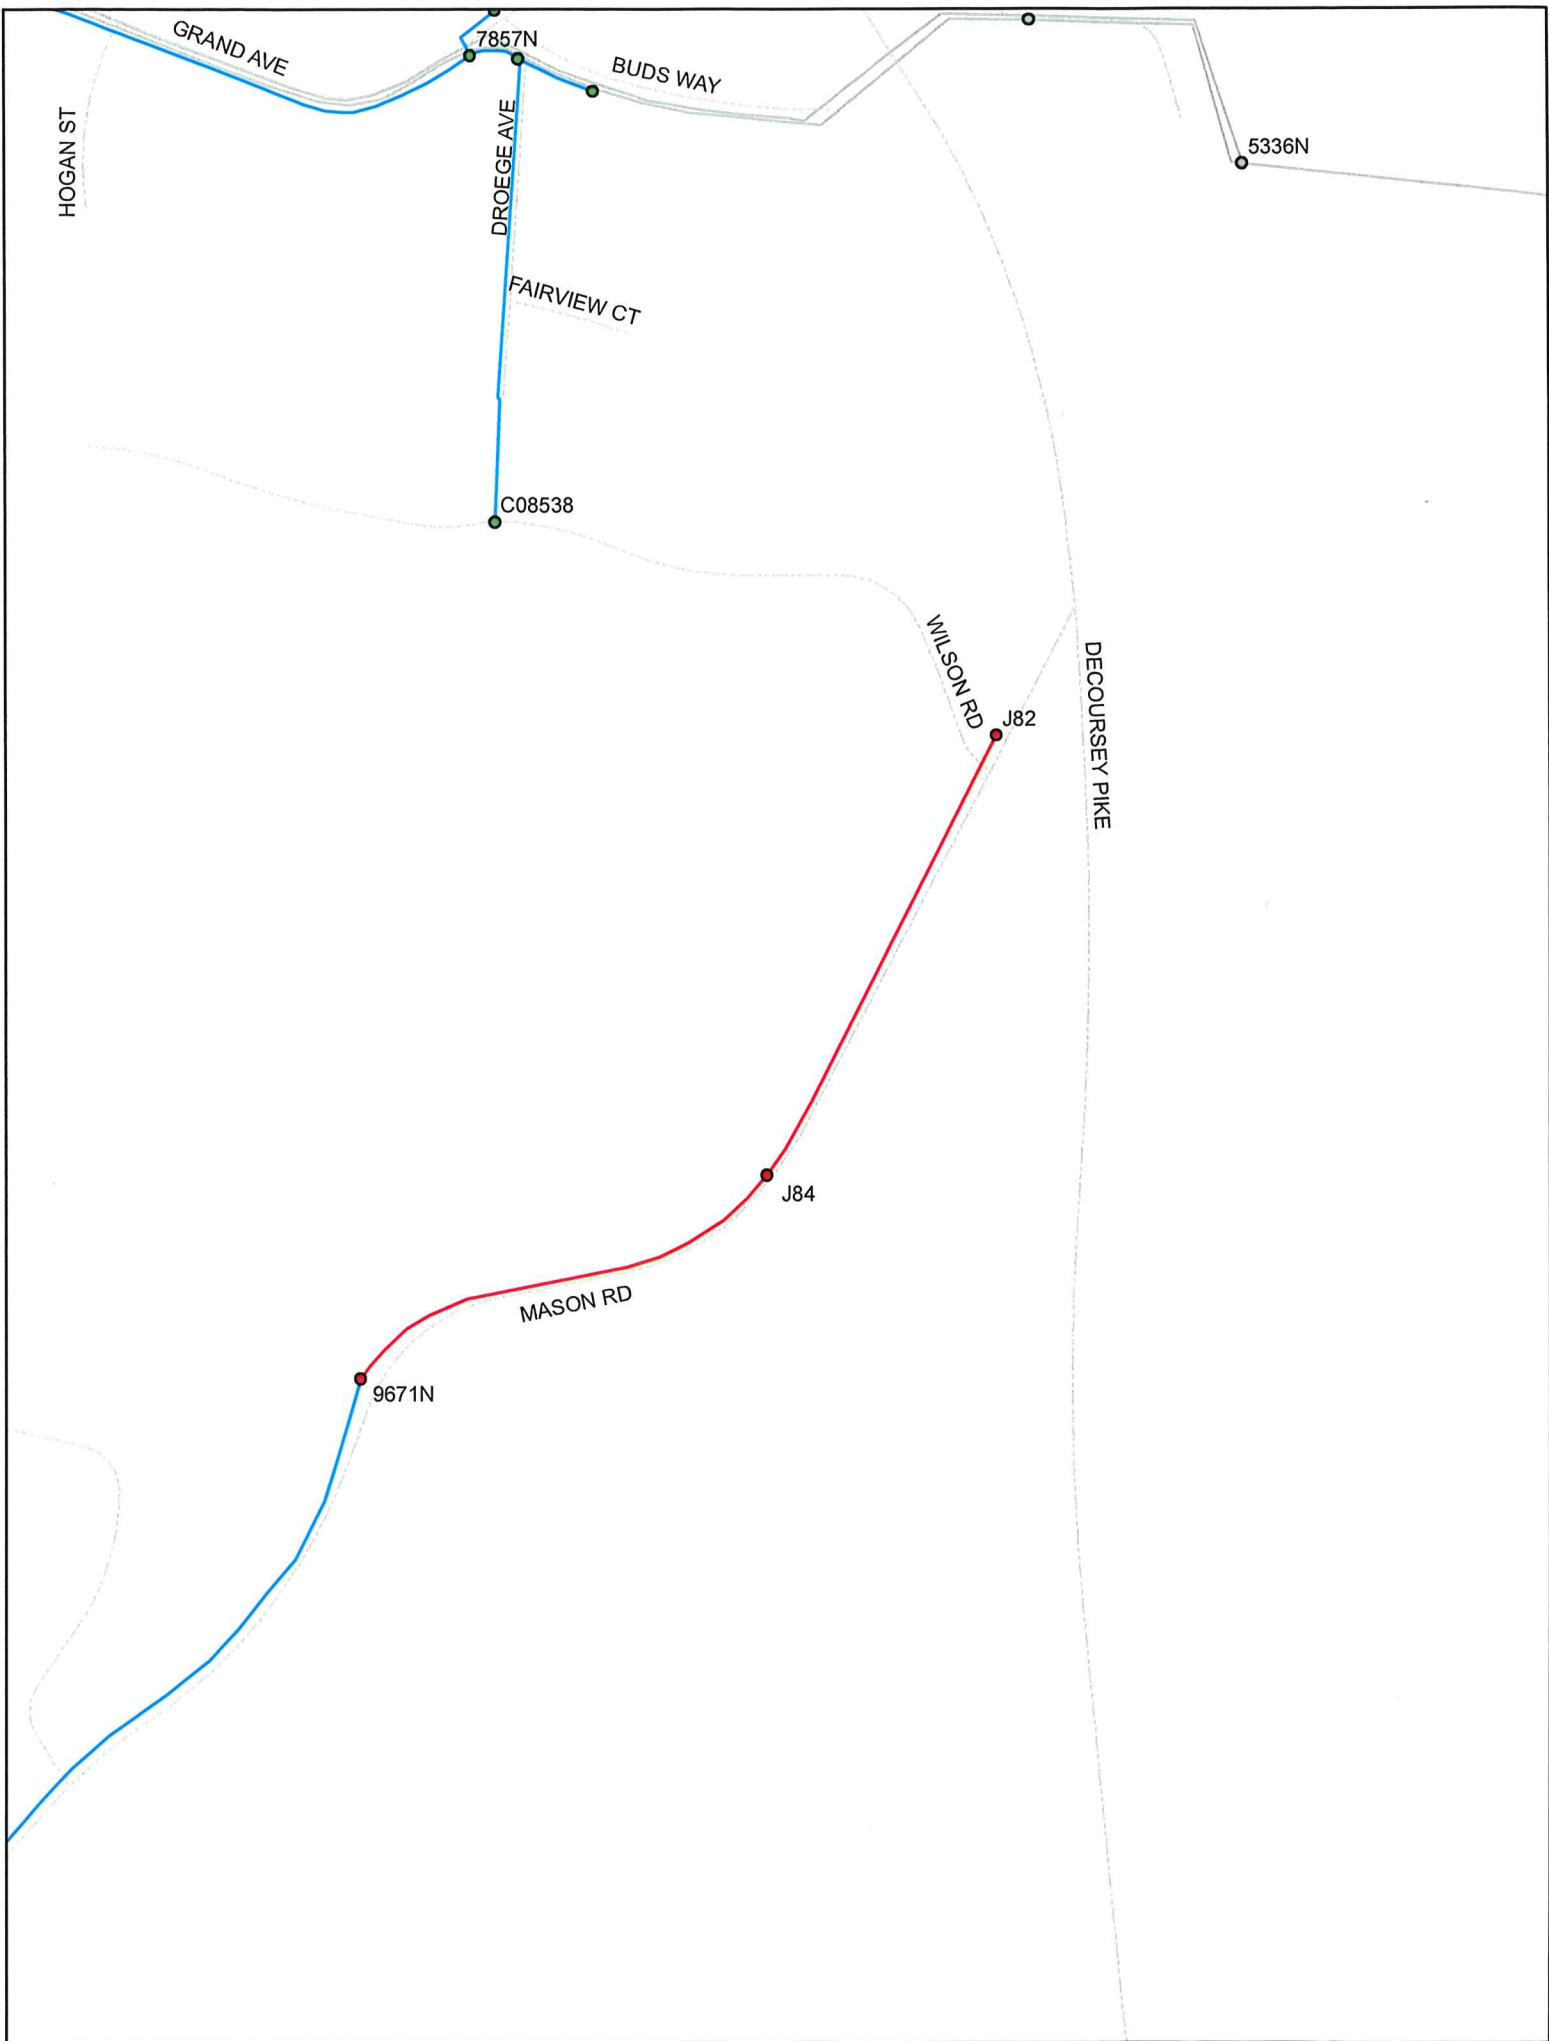
KY 17 HWY

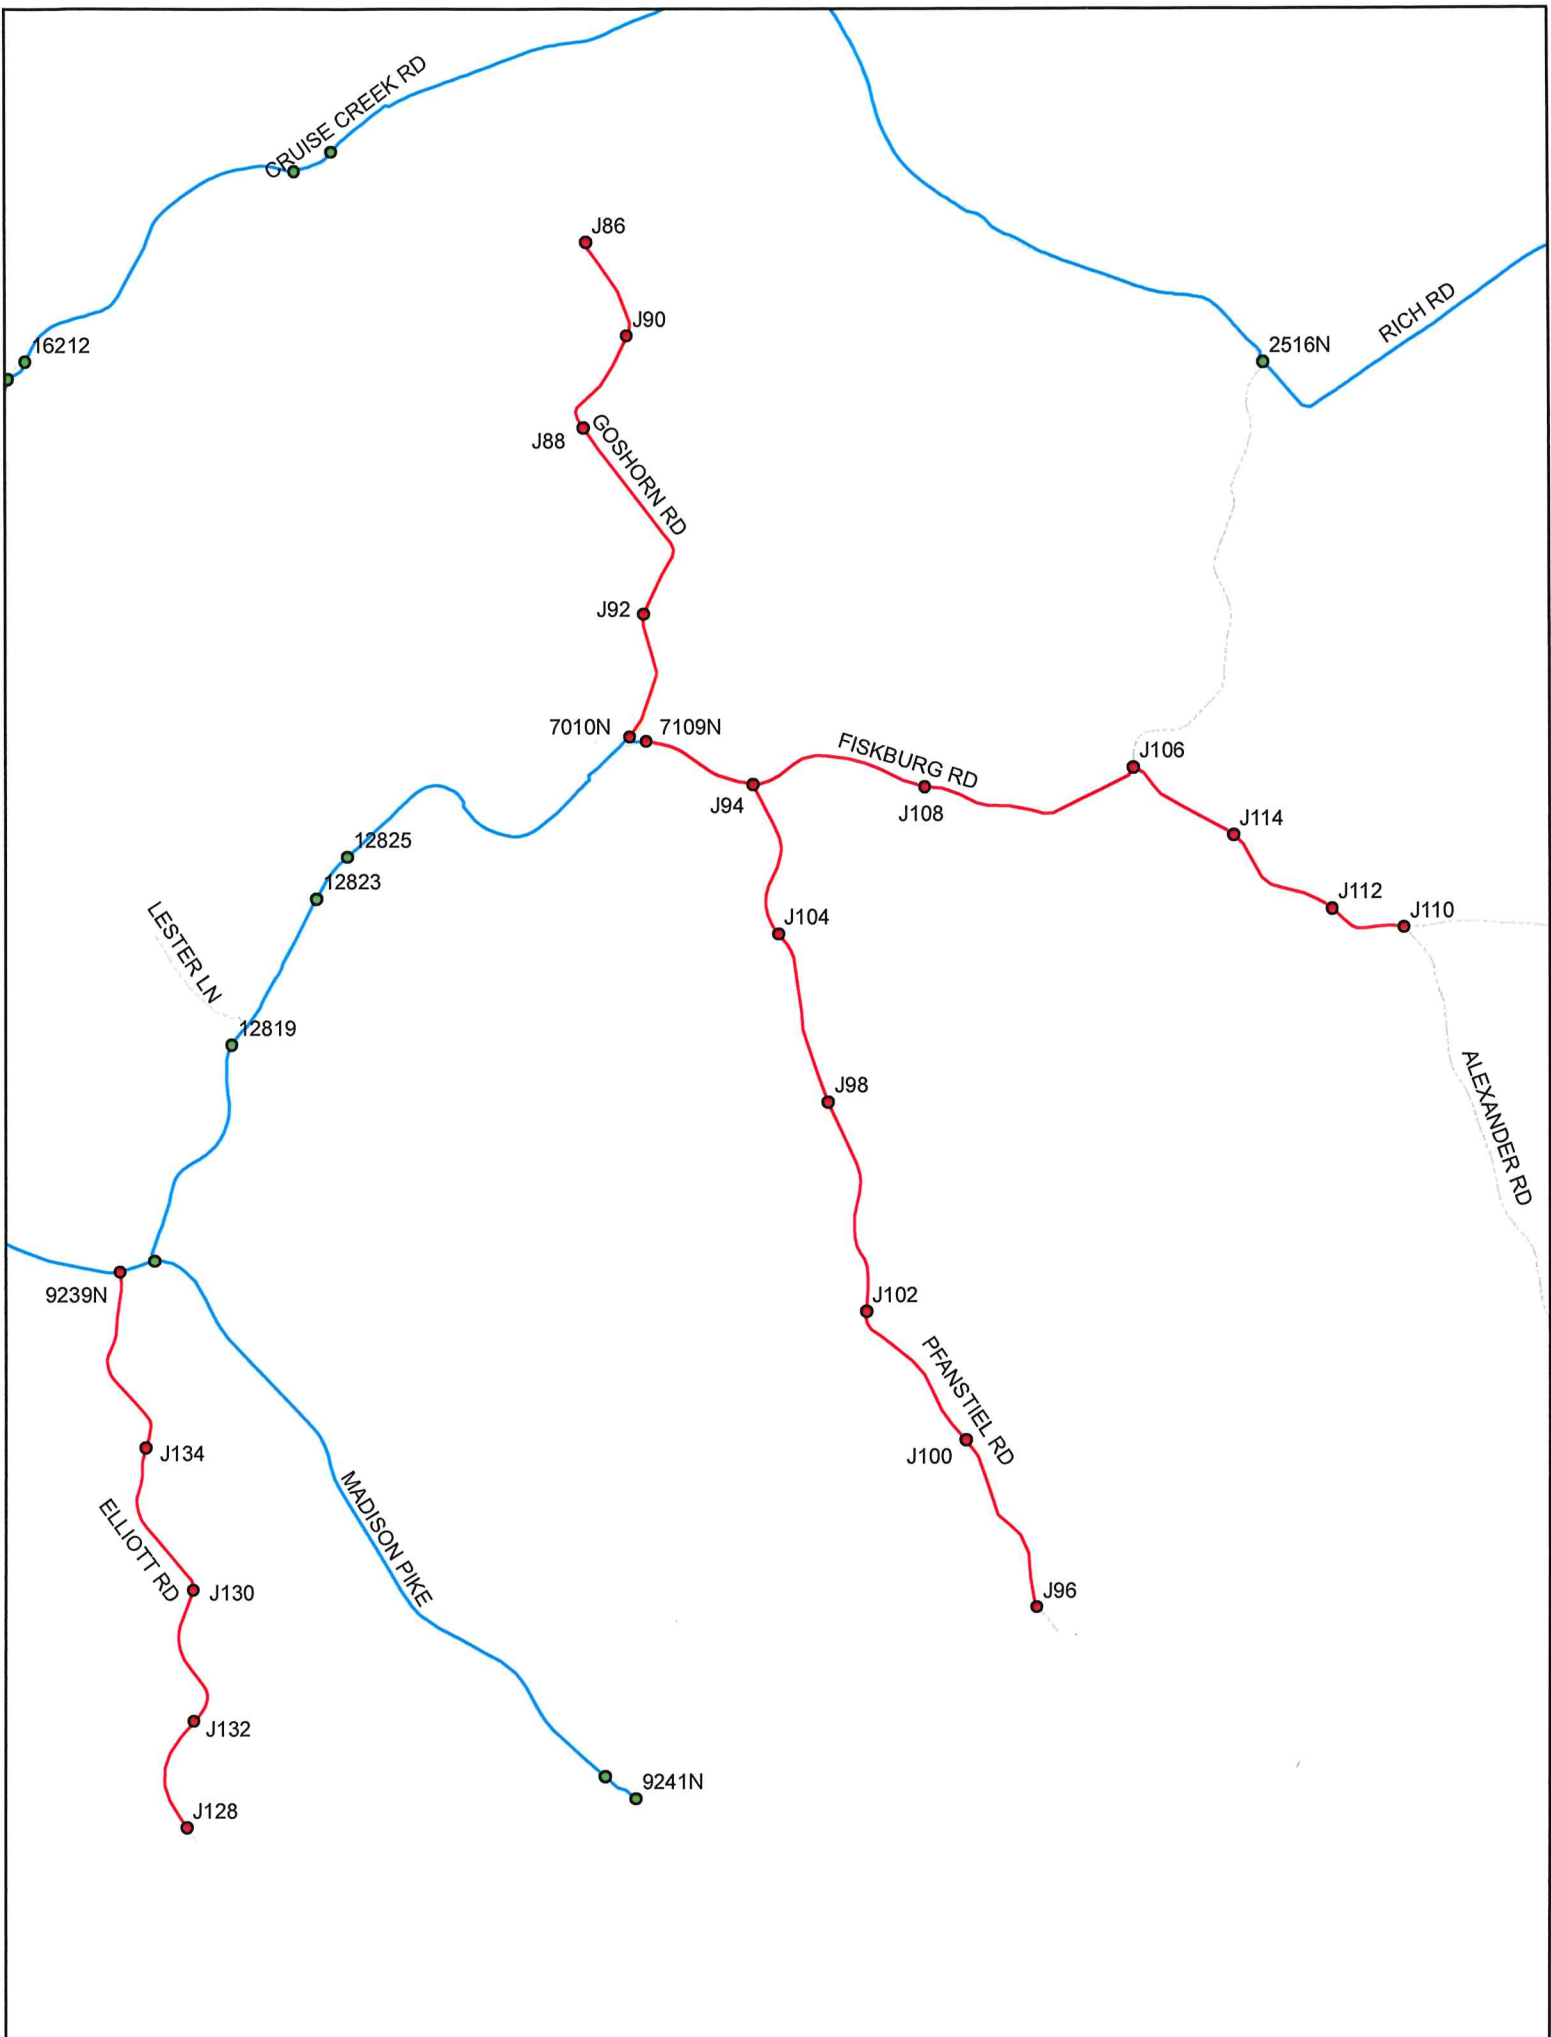
KELLY RD

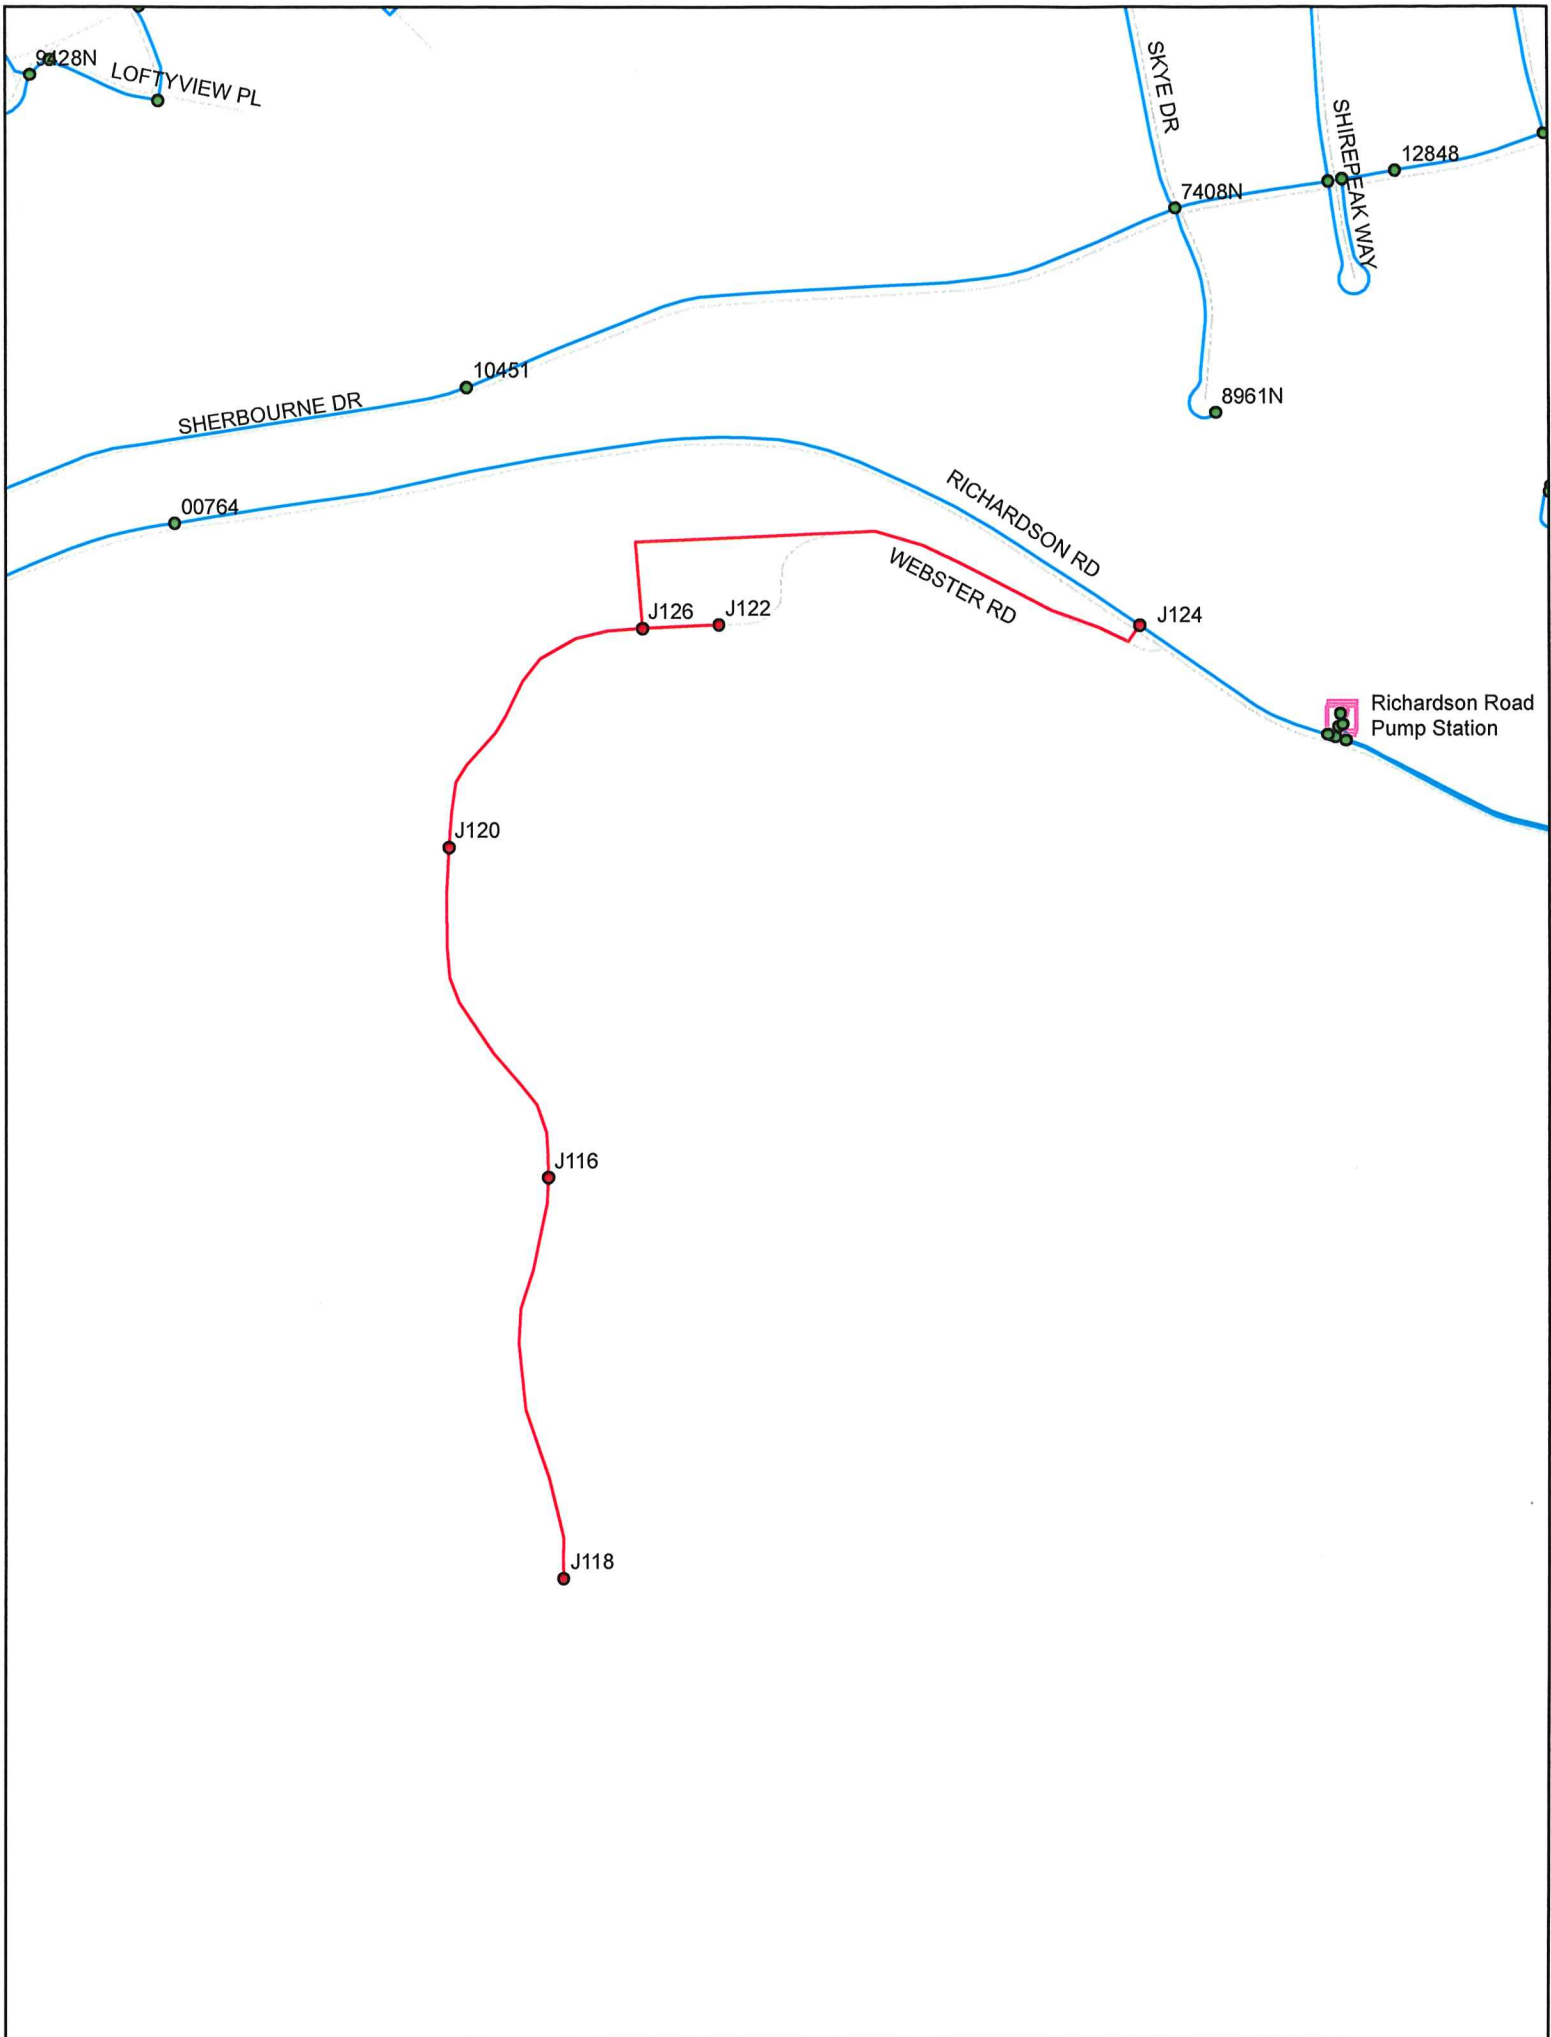
FOWLER CREEK RD

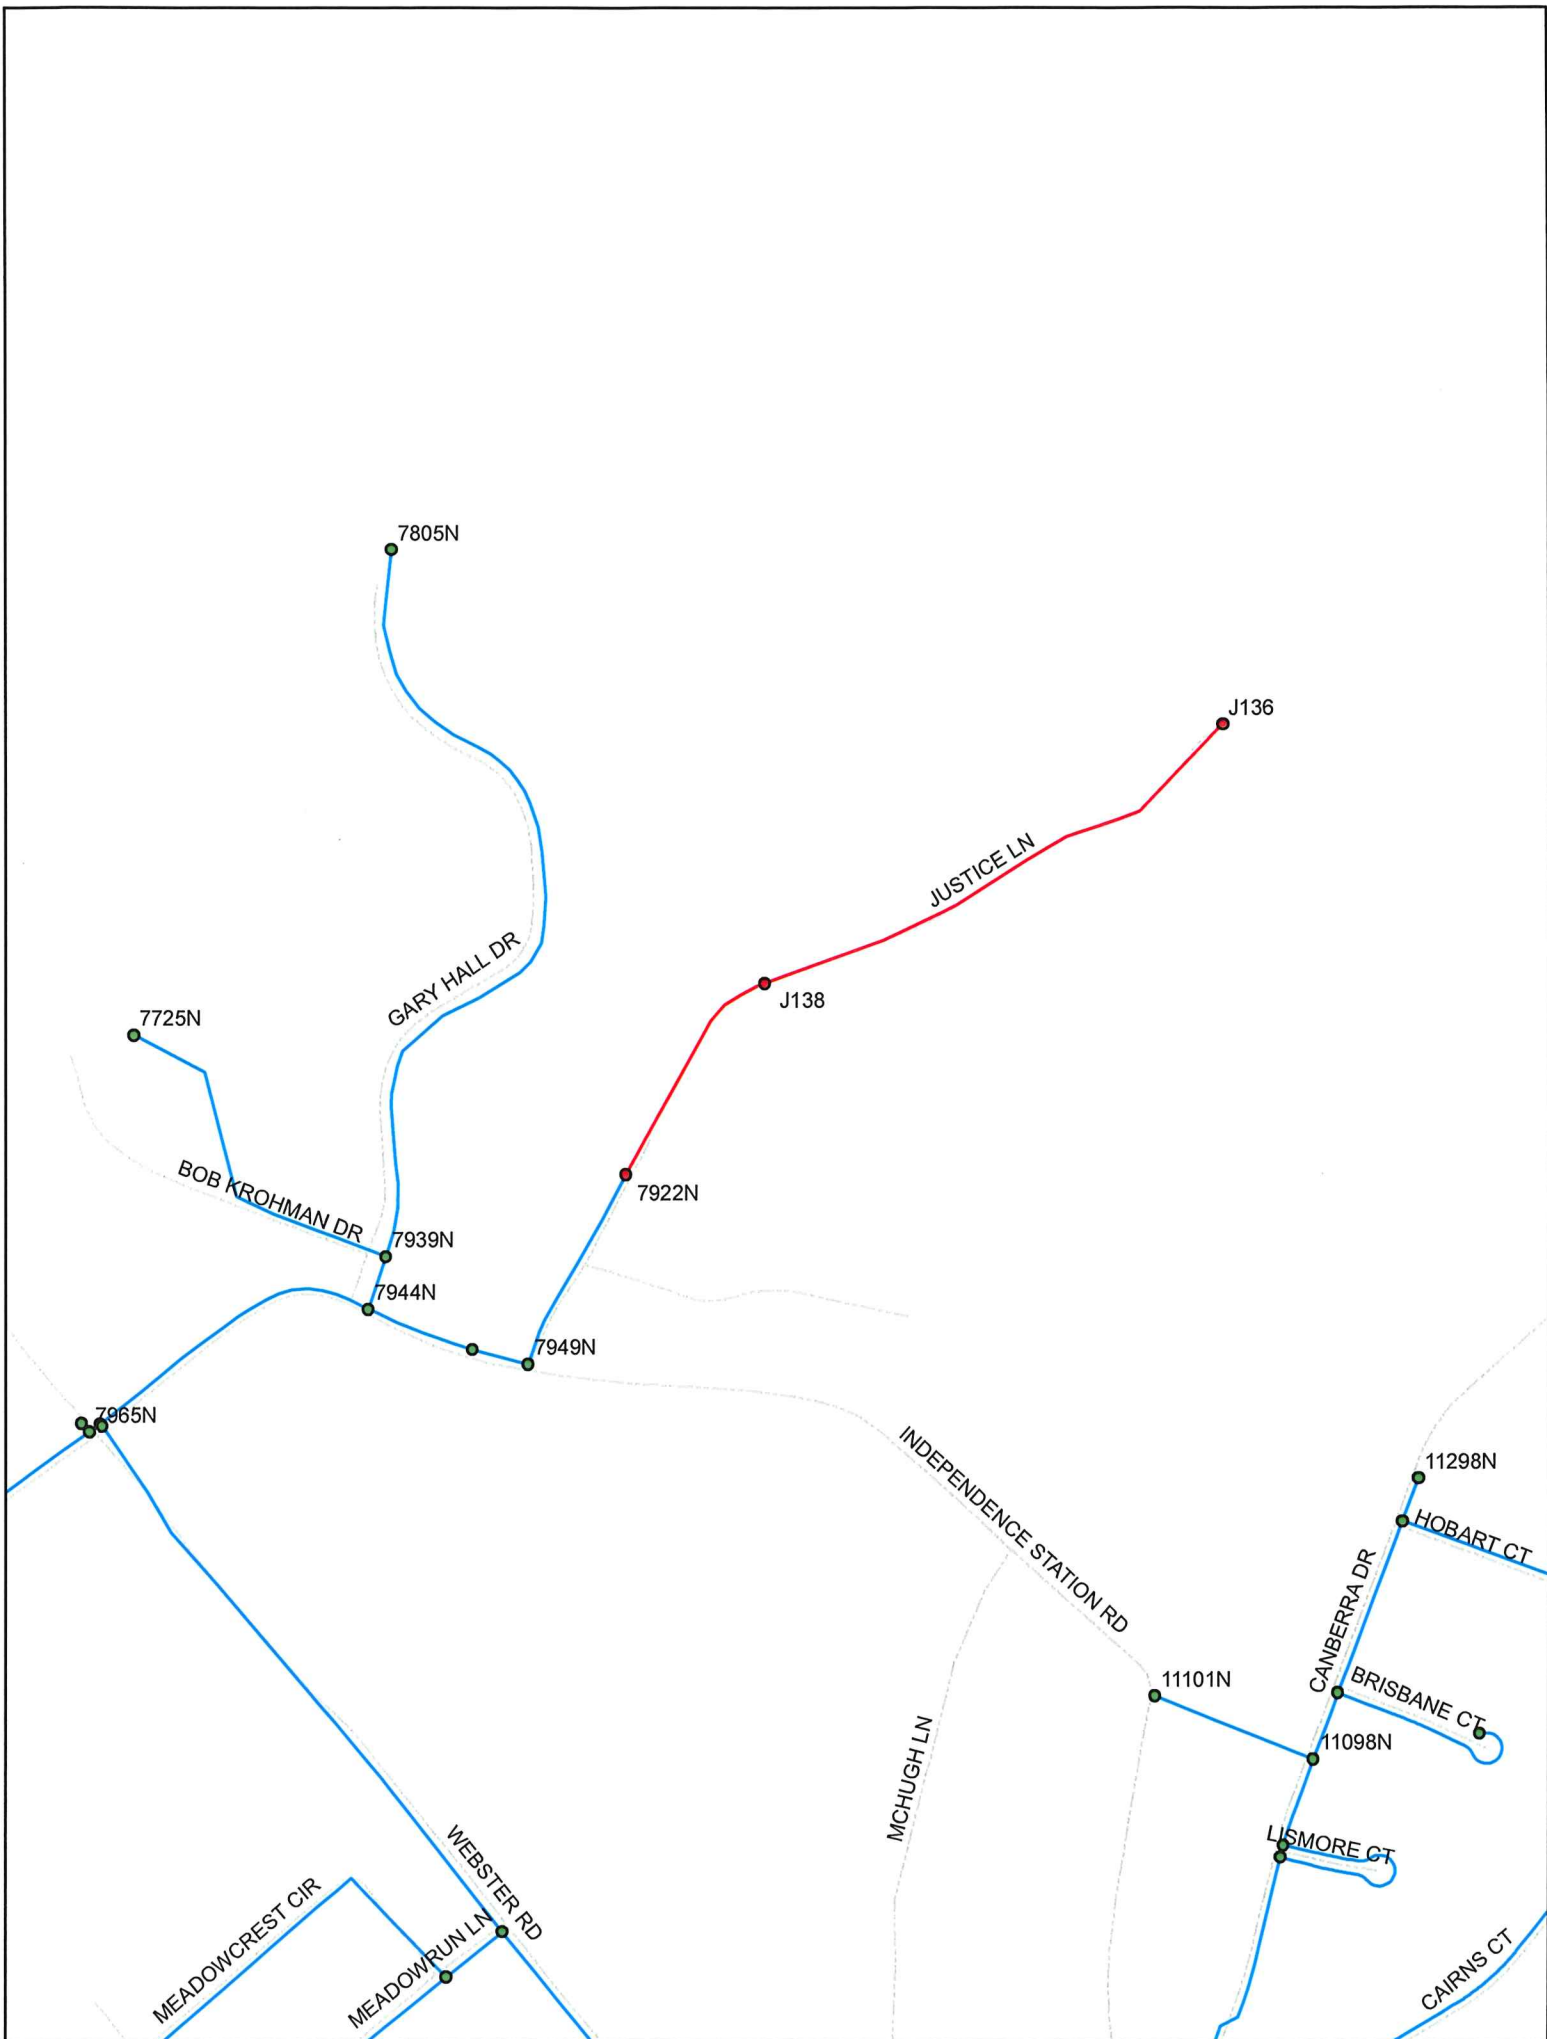
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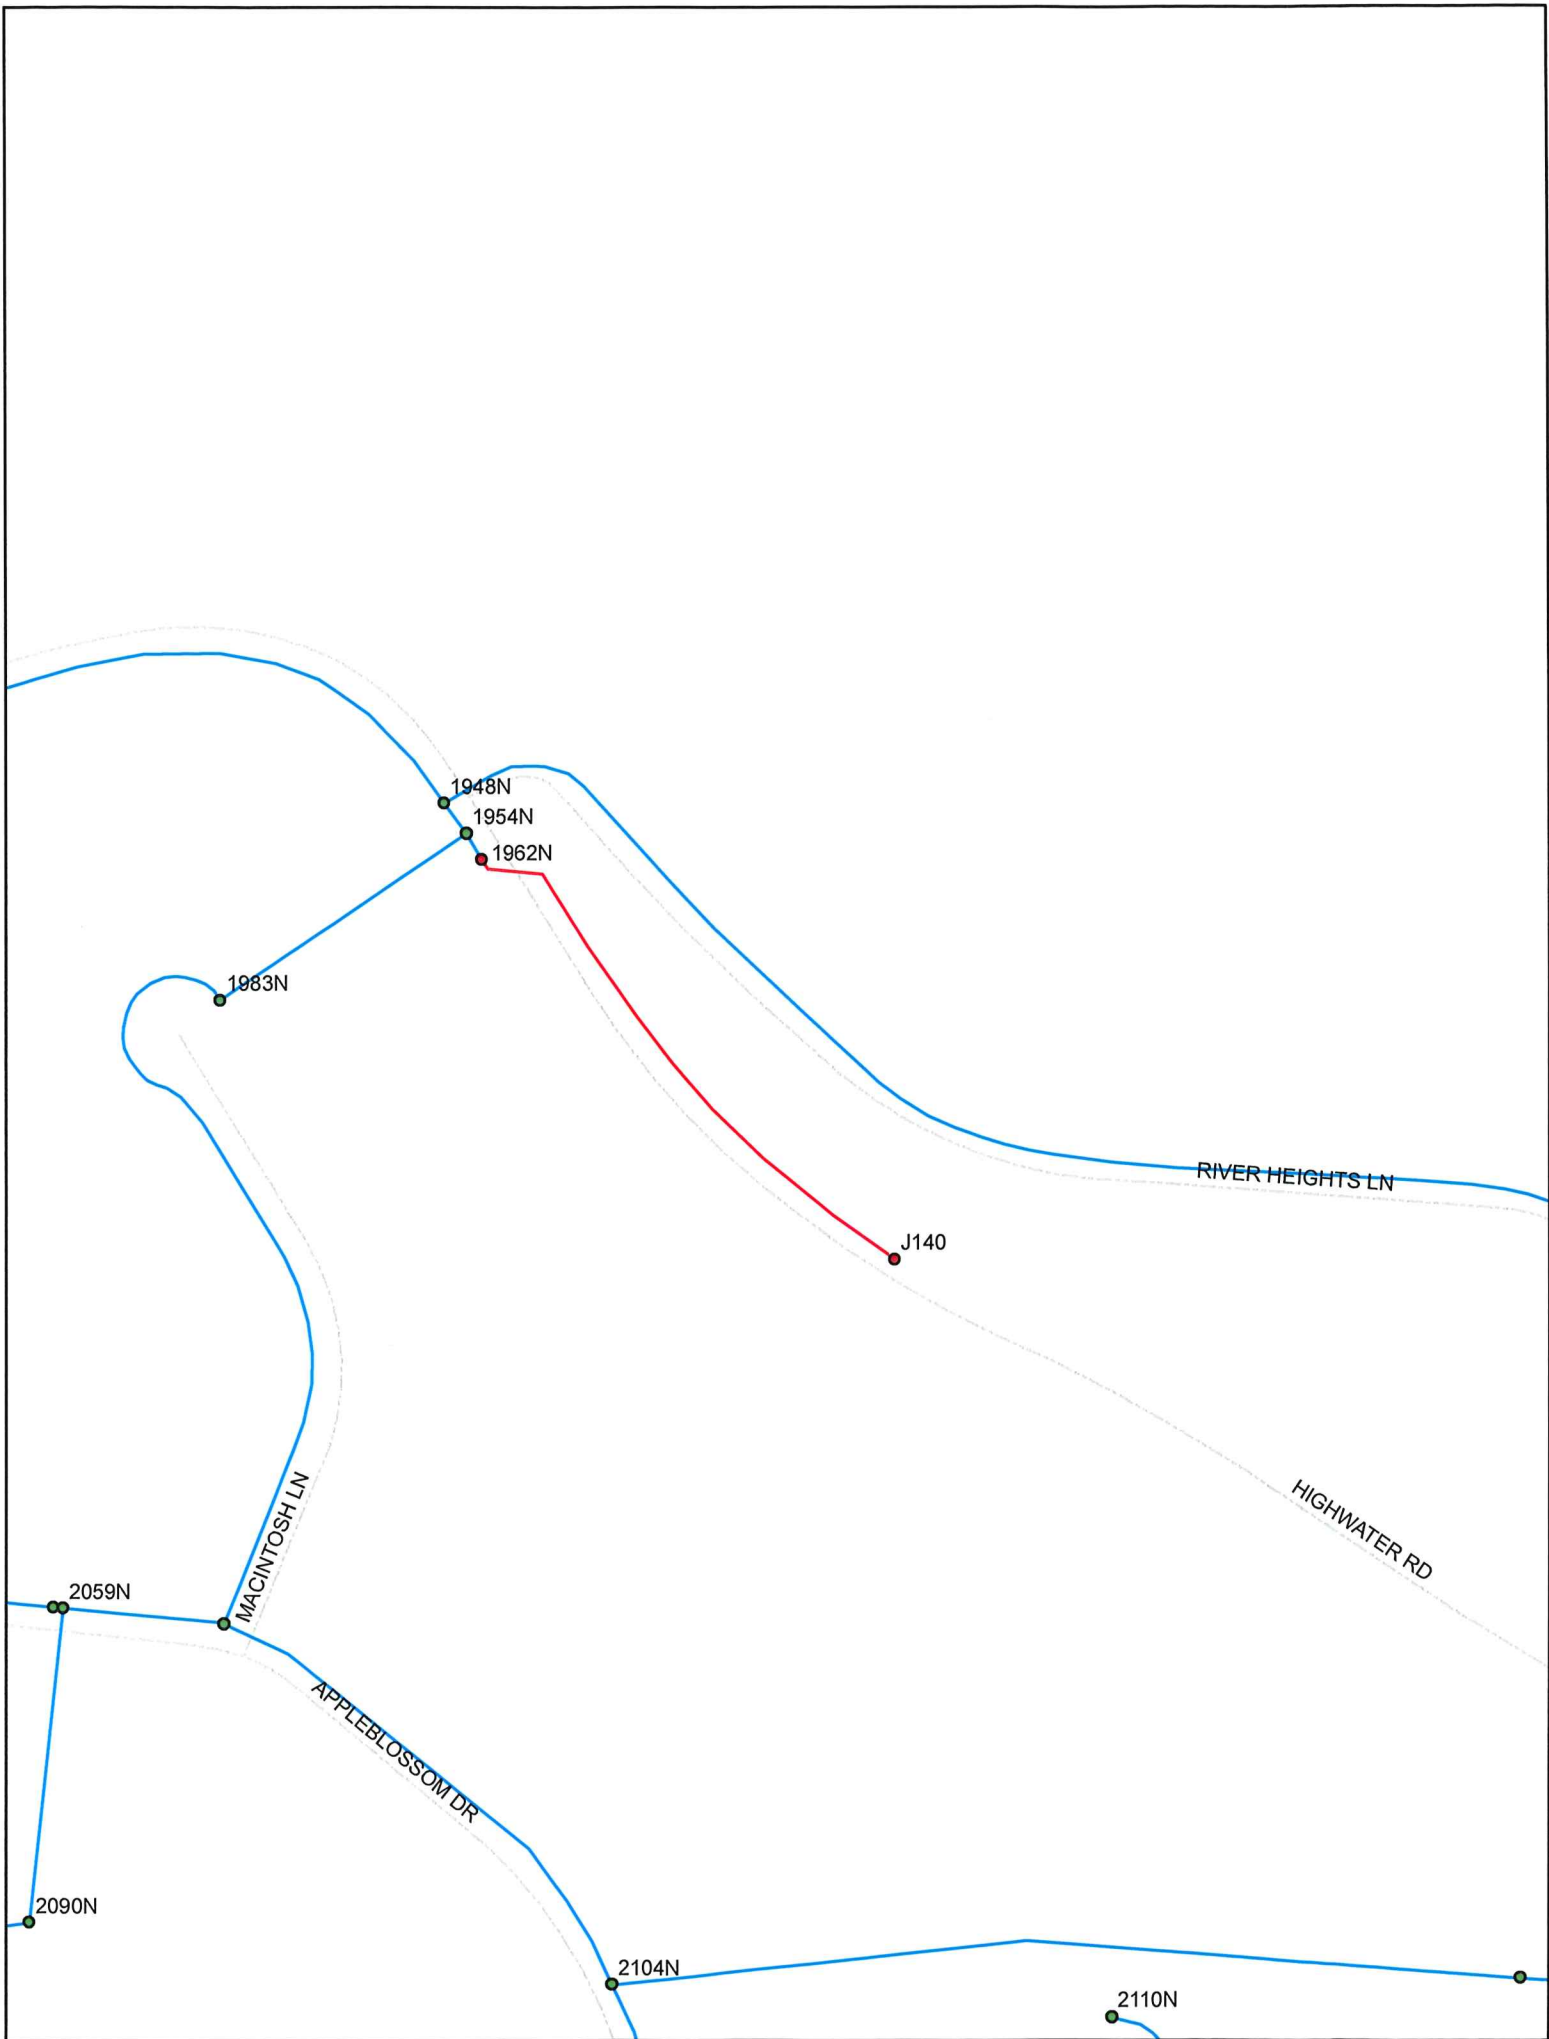
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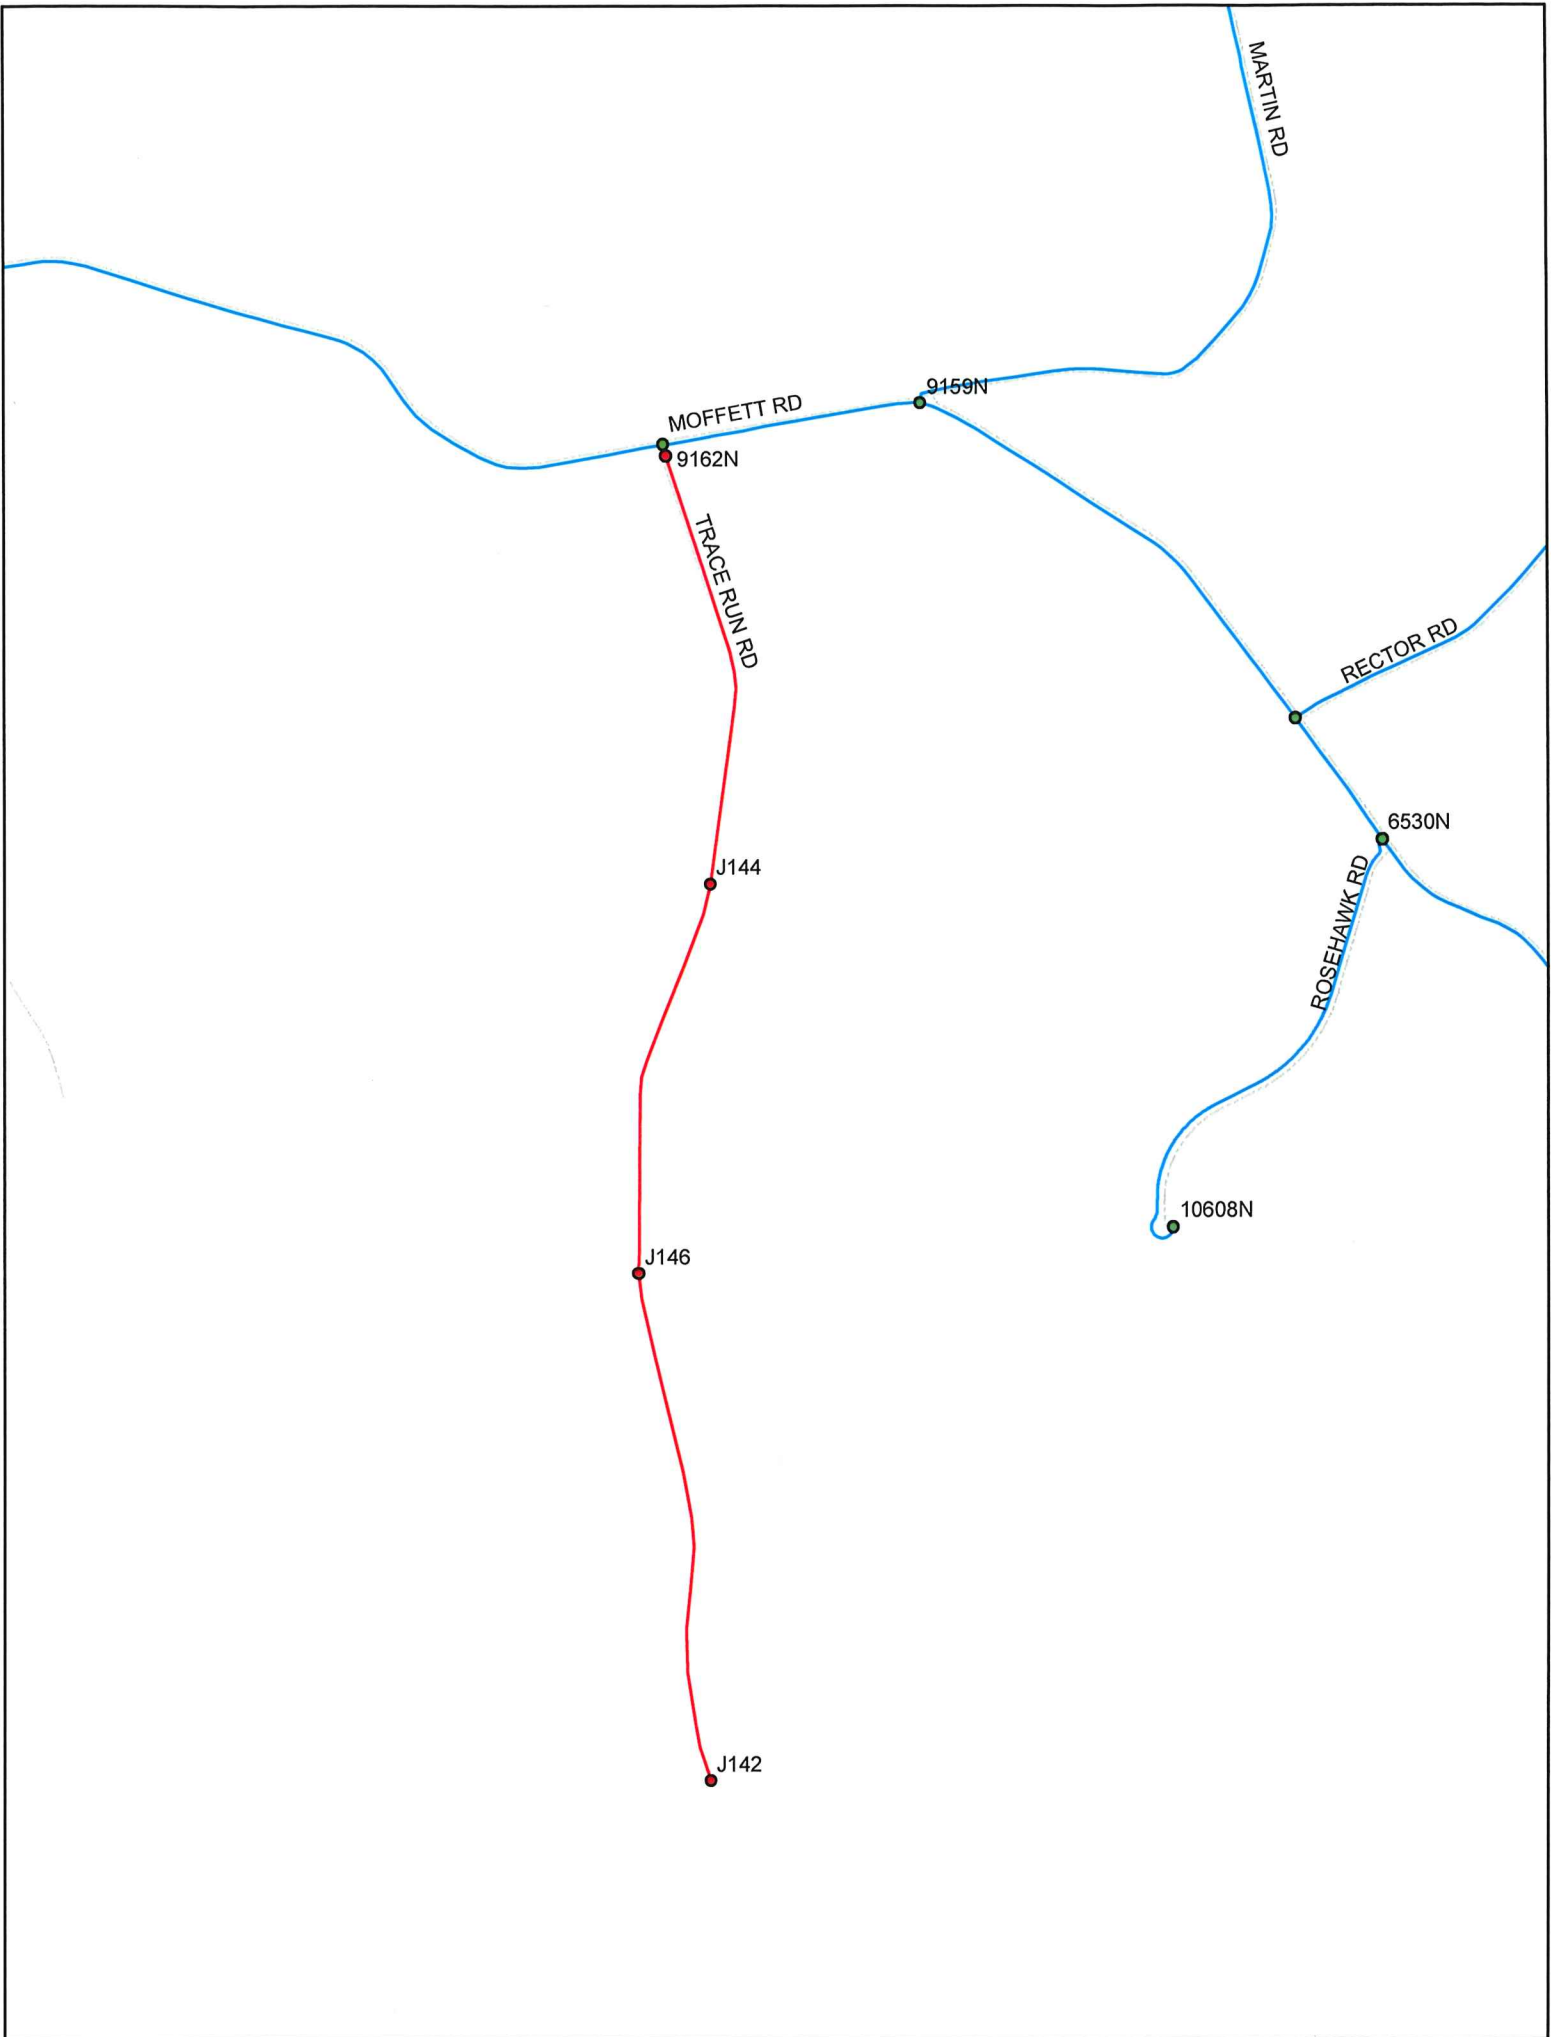












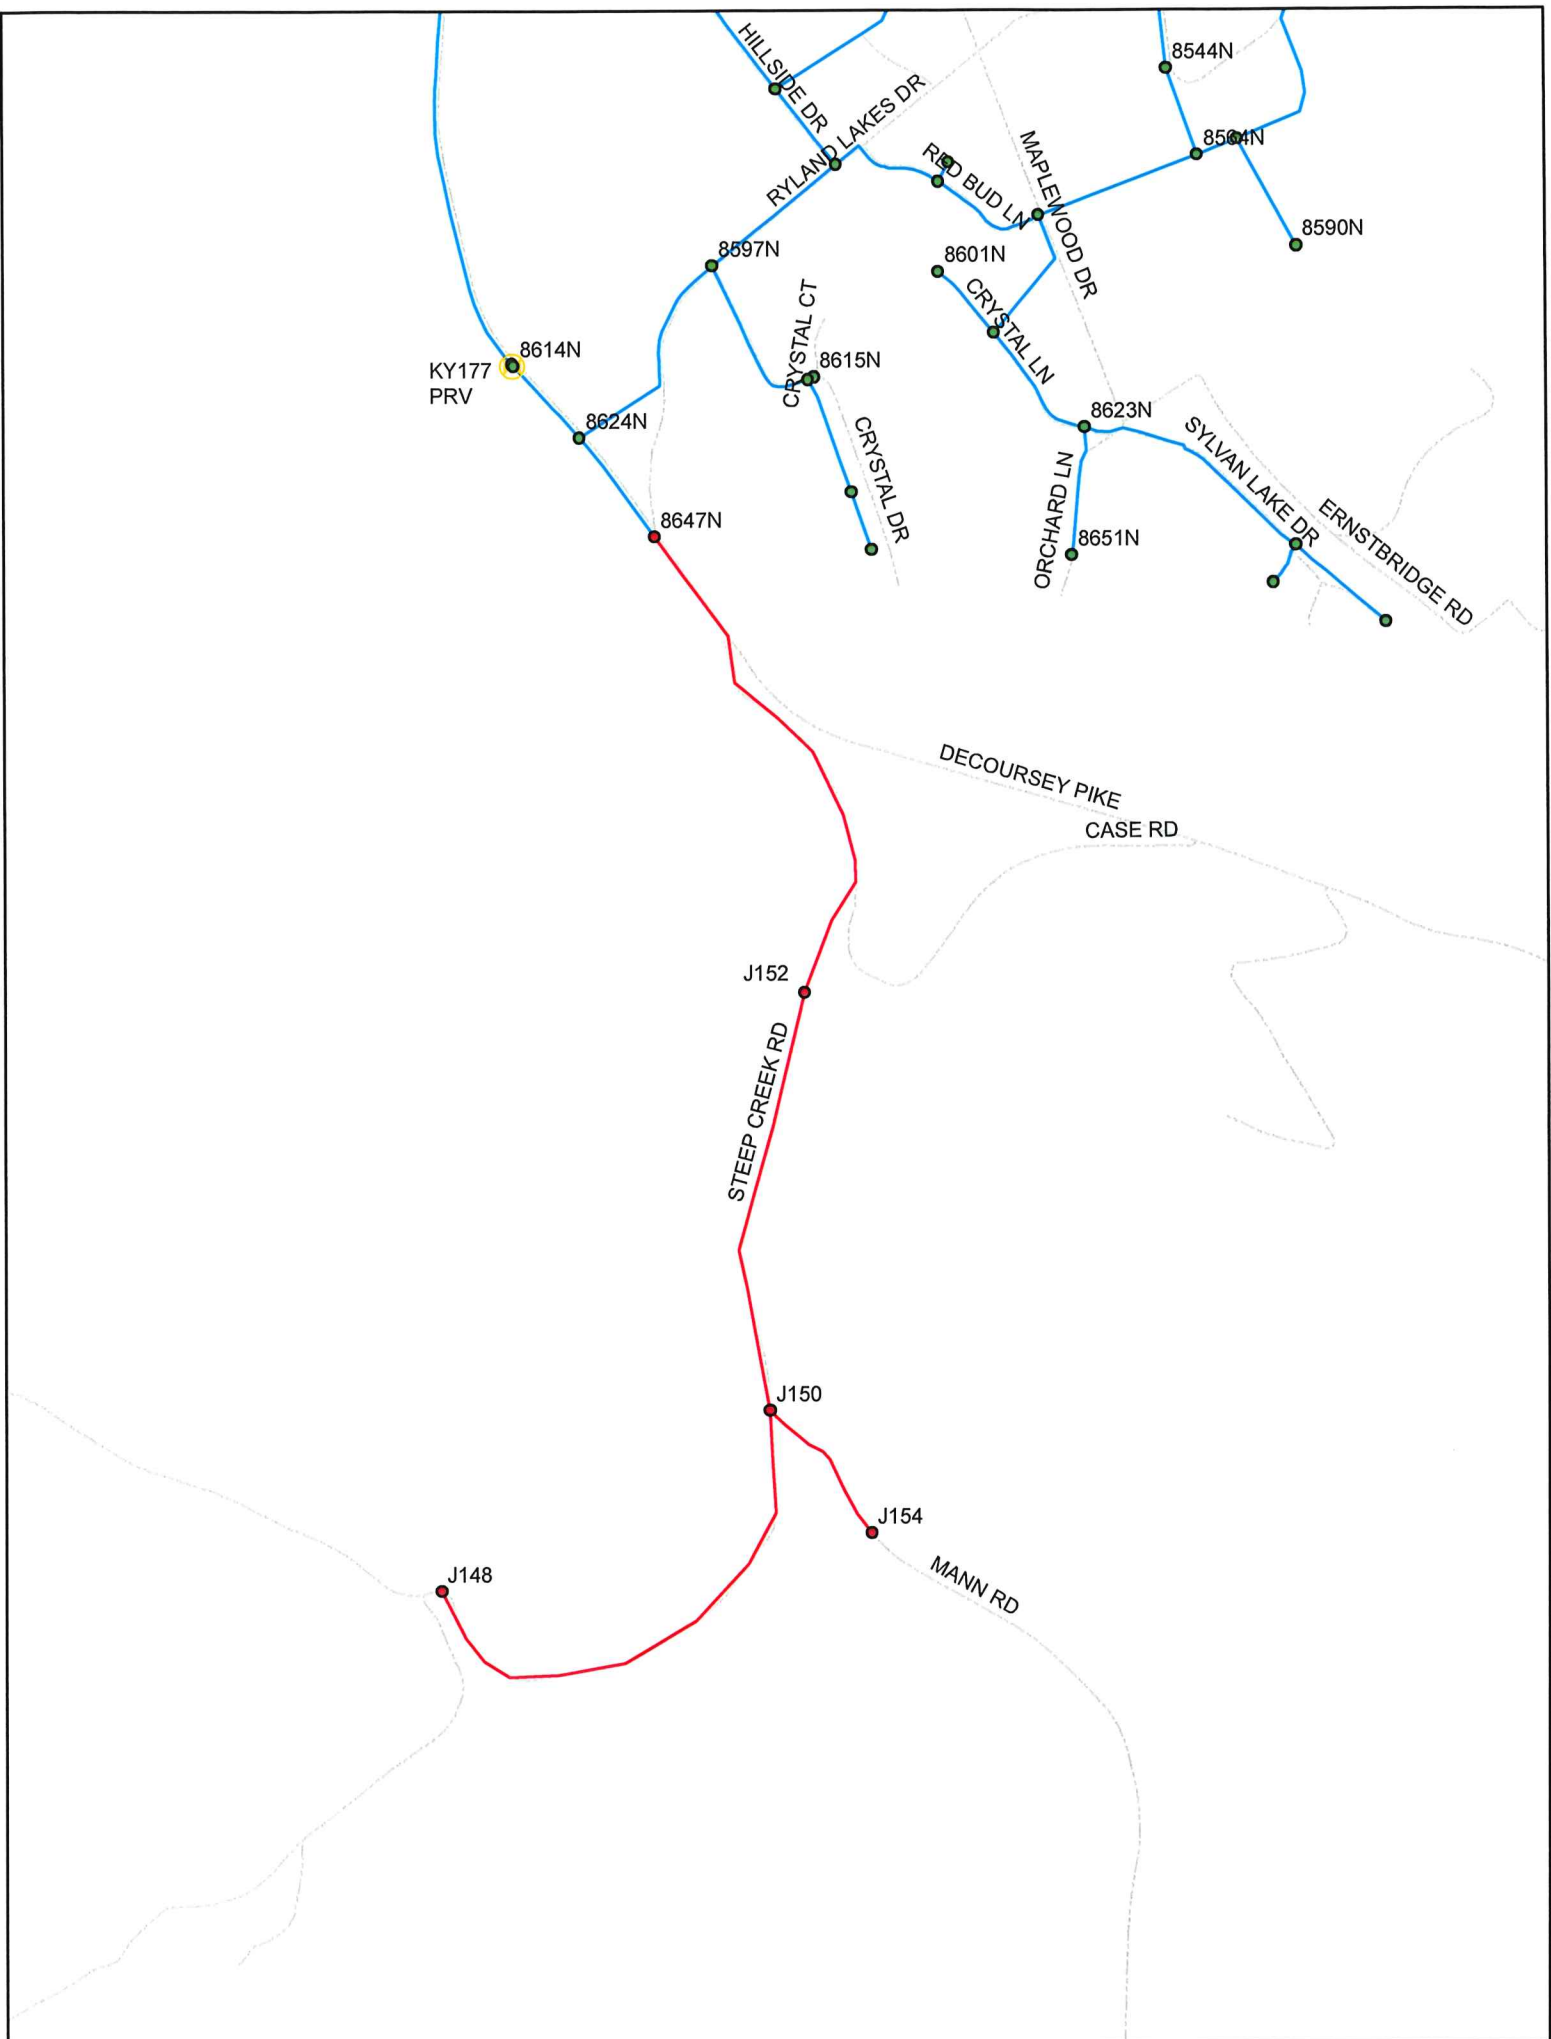


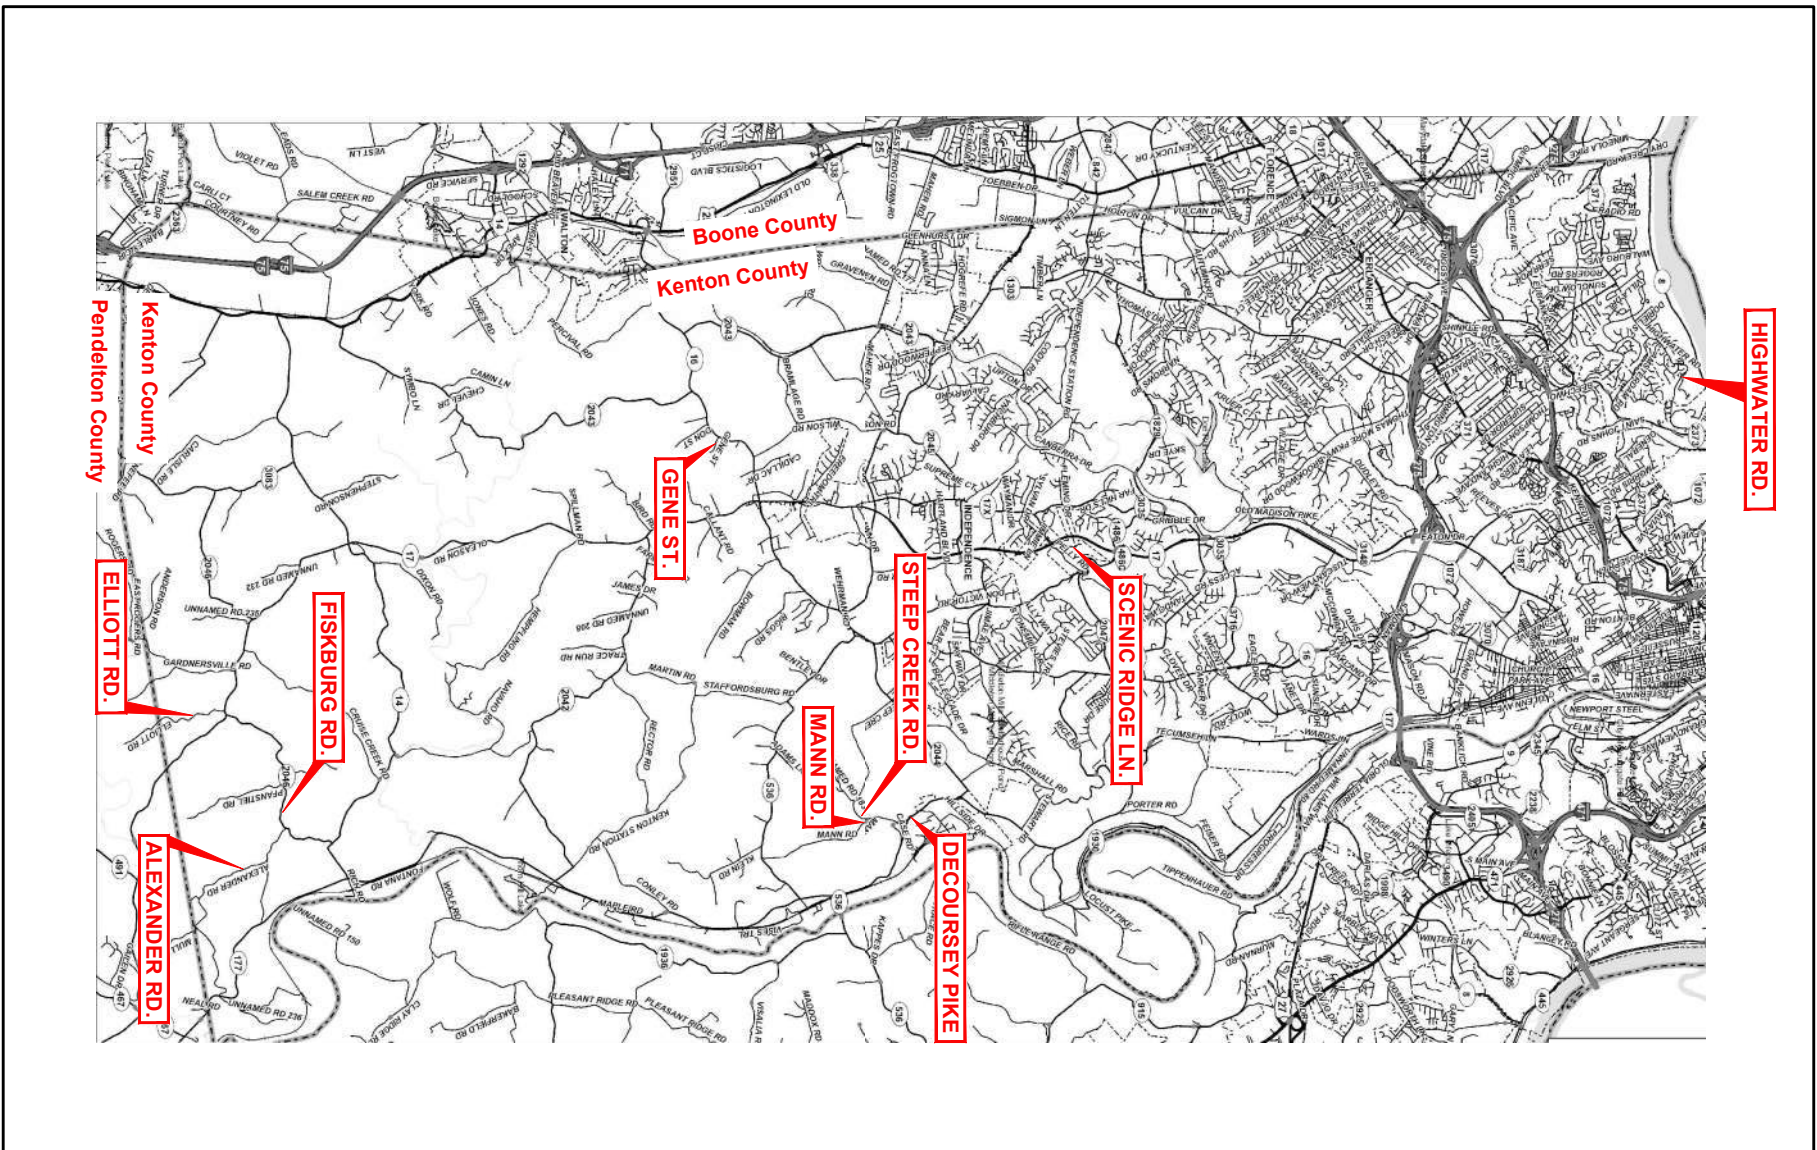


EXHIBIT A-4

PLANS

NORTHERN KENTUCKY WATER DISTRICT SUB-DISTRICT 'O' WATER MAIN EXTENSION KENTON COUNTY, KENTUCKY 231591

NORTHERN KENTUCKY WATER DISTRICT OFFICIALS
<div><div>PRESIDENT / CEO LINDSEY RECHTIN, CPA</div><div>COMMISSIONERS JODY R. LANGE (Chair) DOUGLAS C. WAGNER (Vice-Chair) NICHOLAS E. WINNIKE (Secretary) GARY E. HOLLAND (Treasurer) FRED A. MACKE, JR. (Commissioner) JOSEPH J. KOESTER (Commissioner)</div></div>



VICINITY MAP

NORTHERN KENTUCKY WATER DISTRICT SPECIFICATIONS

THE LATEST STANDARD SPECIFICATIONS AND DRAWINGS OF THE NORTHERN KENTUCKY WATER DISTRICT FOR THE INSTALLATION OF WATER MAIN AND METER PITS SHALL GOVERN ALL WATER MAIN CONSTRUCTION ITEMS ON THIS PROJECT.

KENTUCKY TRANSPORTATION CABINET SPECIFICATIONS

THE LATEST STANDARD SPECIFICATIONS OF THE KENTUCKY TRANSPORTATION CABINET, INCLUDING CHANGES AND SUPPLEMENTAL SPECIFICATIONS THERETO AND KENTON COUNTY SUBDIVISION REGULATIONS SHALL GOVERN THIS IMPROVEMENT.

SOURCE OF OUNDARY AND TOPOGRAPHIC INFORMATION

THE TOPOGRAPHIC INFORMATION SHOWN ON THESE PLANS IS BASED UPON A SURVEY BY CT CONSULTANTS, INC.
THE BOUNDARY INFORMATION SHOWN ON THESE PLANS IS BASED ON PLANNING AND DEVELOPMENT SERVICES (P.D.S.) G.I.S. MAPPING.

INDEX OF SHEETS		
NO.	DWG NAME	SHEET NAME
1	TTL	TITLE
2	G-01	GENERAL NOTES & LEGEND
3	G-02	DETAILS
4	G-03	DETAILS
5	G-04	DETAILS
6	G-05	DETAILS
7	G-06	EROSION CONTROL DETAILS
8	C-01	HIGHWAY ROAD
9-10	C-02 to C-03	SCENIC RIDGE DRIVE
11-15	C-04 to C-08	STEEP CREEK ROAD
16	C-09	STEEP CREEK / DECOURSEY
17	C-10	MANN ROAD
18	C-11	GENE STREET
19-22	C-12 to C-15	FISKBURG ROAD
23-24	C-16 to C-17	ALEXANDER ROAD
25-28	C-18 to C-21	ELLIOT ROAD



2161 CHAMBER CENTER DRIVE
FORT MITCHELL, KENTUCKY 41017
TEL. (859) 525-0544
WWW.VERDANTAS.COM

DATE	REVISION	NO	BID	ISSUED FOR:
				APRIL 2025
				AS SHOWN
				JCOR
				JCOR
				JSHU

NORTHERN KENTUCKY WATER DISTRICT SUBDISTRICT 'O' -KENTON COUNTY -	
TITLE SHEET	



JAMES M. SHUMATE

P.E. #18156

PROJECT NO.	231591
DISCIPLINE	CIVIL
SHEET NAME	TTL
SHEET	1
OF	28




GENERAL NOTES		UTILITY NOTES		WATER DISTRICT GENERAL NOTES		MAINTENANCE OF TRAFFIC NOTES		SYMBOL LEGEND			
<div>1. ALL CONSTRUCTION SHALL CONFORM TO THESE PLANS AND SPECIFICATIONS, STANDARD SPECIFICATIONS AND DRAWINGS AND THE KENTON COUNTY SUBDIVISION REGULATIONS AND THE KENTUCKY DEPARTMENT OF HIGHWAYS STANDARD SPECIFICATIONS FOR ROAD AND BRIDGE CONSTRUCTION.</div> <div>2. ALL DISTURBED AREAS ARE TO BE RESTORED (SEEDED AND MULCHED) BY THE CONTRACTOR TO THE ORIGINAL CONDITION. THE CONTRACTOR SHALL ALSO BE RESPONSIBLE FOR REMOVING ANY EXCESS MATERIALS AT THE SITE AND MAINTAINING ALL SEEDED AND MULCHED AREAS UNTIL PROJECT COMPLETION AND FINAL INSPECTION PER KDOT SPEC. 212. A RESIDENTIAL YARD SHALL BE RESTORED WITHIN TWENTY-ONE (21) DAYS AFTER CONSTRUCTION.</div> <div>3. ALL APPLICABLE RECOMMENDATIONS IN KENTUCKY'S BEST MANAGEMENT PRACTICES MANUAL SHALL BE FOLLOWED BY THE CONTRACTOR, INCLUDING SEEDING OF DISTURBED GROUND.</div> <div>4. RIGHT-OF-WAY AND PROPERTY LINES SHOWN ARE PLOTTED FROM PLANNING AND DEVELOPMENT SERVICES (PDS) G.I.S. MAPPING AND ARE APPROXIMATE AND NOT THE RESULT OF A FIELD BOUNDARY SURVEY.</div> <div>5. THE CONTRACTOR SHALL LIMIT THEIR WORK AREA TO THE EASEMENTS AND RIGHTS-OF-WAY SHOWN ON THESE PLANS UNLESS WRITTEN PERMISSION IS GIVEN BY THE PROPERTY OWNER AND APPROVED BY FORT N.K.W.D.</div> <div>6. ALL OSHA, STATE AND LOCAL SAFETY REGULATIONS SHALL BE FOLLOWED DURING CONSTRUCTION.</div> <div>7. NO CONSTRUCTION SHALL COMMENCE UNTIL ALL STATE, COUNTY AND LOCAL PERMITS HAVE BEEN ISSUED AS REQUIRED.</div> <div>8. THE CONTRACTOR SHALL COORDINATE ALL WORK WITHIN THE PUBLIC RIGHT-OF-WAY WITH THE KENTUCKY TRANSPORTATION CABINET AND KENTON COUNTY AND ANY LOCAL MUNICIPALITY. LOCAL TRAFFIC MUST BE MAINTAINED AT ALL TIMES DURING CONSTRUCTION UNLESS OTHERWISE NOTED IN THESE PLANS.</div> <div>9. ADDITIONAL BMPs AND EROSION AND SEDIMENT CONTROL MEASURES MAY BE REQUIRED AS DEEMED NECESSARY. ALL COST FOR ABOVE SHALL BE INCLUDED IN LUMP SUM BID FOR EROSION CONTROL AND WATER POLLUTION CONTROL.</div> <div>10. ALL CONSTRUCTION WORK SHALL BE IN CONFORMANCE WITH THE KENTUCKY TRANSPORTATION CABINET'S STANDARD SPECIFICATIONS REPORT PREPARED BY G.A.I. CONSULTANTS DATED FEBRUARY 2024.</div>		<div>1. THIS PLAN SHOWS THE APPROXIMATE LOCATION OF UNDERGROUND UTILITIES (GAS, WATER, STORM SEWER, SANITARY SEWER, TELEPHONE, ELECTRIC, ETC.). THE PREPARER DOES NOT GUARANTEE THEIR ACCURACY OR CORRECTNESS. THE INFORMATION PROVIDED THEIR FIELD VERIFIED PRIOR TO CONSTRUCTION. THE CONTRACTOR SHALL BE RESPONSIBLE FOR MAINTAINING THE UTILITY AS WELL AS THE SERVICE LATERALS AT ALL TIMES DURING CONSTRUCTION. THE CONTRACTOR SHALL PRACTICE CARE DURING THE GRADING AND TRENCH CONSTRUCTION AND MAINTAIN THE RESPONSIBILITY FOR ANY SERVICE LATERALS THAT ARE DAMAGED DURING CONSTRUCTION AT THEIR EXPENSE.</div> <div>2. PRIOR TO ANY EXCAVATION OVER AN EXISTING UTILITY LINE OR SERVICE, CONTRACTOR SHALL HAND EXCAVATE TO EXPOSE THE UTILITY AND DETERMINE LOCATION AND DEPTH. NOTIFY ENGINEER IMMEDIATELY OF ANY CONFLICTS.</div> <div>3. TOPS OF EXISTING AND PROPOSED CASTING ELEVATIONS ARE SUBJECT TO FINAL ADJUSTMENTS AS APPROVED BY THE ENGINEER AND REQUIREMENTS OF UTILITY OWNER. THIS WORK WILL BE INCIDENTAL TO THE CONTRACT.</div> <div>4. FORTY-EIGHT (48) HOURS BEFORE EXCAVATION IS TO COMMENCE, THE CONTRACTOR SHALL NOTIFY THE KENTON COUNTY AND KENTON COUNTY KENTUCKY UTILITY PROTECTION SERVICE AND ALL OTHER UTILITIES THAT MAY HAVE UNDERGROUND UTILITIES INVOLVING THIS PROJECT AND ARE NON-MEMBERS OF KENTUCKY UNDERGROUND PROTECTION.</div>		<div>1. THE EXISTING WATER MAIN ELEVATION AND LOCATION AT THE CONNECTION POINT WITH THE PROPOSED MAIN WAS ASSUMED AND HAS NOT BEEN FIELD VERIFIED. PRIOR TO COMMENCEMENT OF ANY WATER MAIN WORK, THE CONTRACTOR SHALL DIG A TEST HOLE AT THE CONNECTION POINT TO LOCATE EXISTING WATER MAIN TO LOCATION AND ELEVATION. THE EXISTING WATER MAIN LOCATION MAY REQUIRE SOME FIELD ADJUSTMENT TO BE MADE TO BE SURE THE WATER MAIN IS LOCATED AT THE CORRECT DEPTH. THE CONTRACTOR SHALL BE RESPONSIBLE FOR THE COST OF DOING THE ADJUST. THIS SHALL BE INCIDENTAL TO THE PERTINENT WATER MAIN ITEM.</div> <div>2. COST OF TRIMMING OR CLEARING ANY TREES, BUSHES, ETC., SHALL BE INCIDENTAL TO THE OVERALL CONTRACT PRICE AND SHALL BE APPROVED BY N.K.W.D. AND THE PROPERTY OWNER ALONG WITH COUNTY OR STATE WHEN REQUIRED.</div> <div>3. THE UTILITY INFORMATION SHOWN ON THE PLANS IS BASED ON INFORMATION RECEIVED FROM OTHERS AND HAS NOT BEEN VERIFIED BY THE ENGINEER OR OWNER. IT SHALL BE THE RESPONSIBILITY OF THE CONTRACTOR TO VERIFY THE LOCATION OF THE UTILITIES AND TO COORDINATE ANY IMPACT CAUSED BY THE PROPOSED WORK WITH ALL UTILITY OWNERS AND/OR THEIR CONTRACTORS. THE CONTRACTOR WILL BE RESPONSIBLE TO DO THE NECESSARY FIELD INVESTIGATIONS REQUIRED TO LOCATE EXISTING UTILITIES AND ELEVATIONS. THE CONTRACTOR SHALL BE RESPONSIBLE TO RE-EVALUATE THE ELEVATION OF THE PROPOSED WATER MAIN TO AVOID THE UTILITY. COST OF ALL THE ABOVE SHALL BE INCIDENTAL TO THE OVERALL CONTRACT PRICE.</div> <div>4. UNLESS SPECIFICALLY INSTRUCTED OTHERWISE, RETURN ALL REMOVED WATER EQUIPMENT INCLUDING: FINE HYDRANTS, VALVES, AND WATER METERS TO NORTHERN KENTUCKY WATER DISTRICT (N.K.W.D.).</div> <div>5. WATER LINES CROSSING UNDER OR OVER SEWER LINES (DEFINED AS ANY SANITARY/COMBINED SEWER, SEPTIC TANK OR SUBSOIL TREATMENT SYSTEM) MUST MAINTAIN A MINIMUM VERTICAL CLEARANCE OF 18" AND ONE FULL LENGTH OF PIPE SHALL BE LOCATED SO BOTH JOINTS ARE AS FAR FROM THE SEWER AS POSSIBLE. SPECIAL STRUCTURAL SUPPORT FOR THE WATER AND SEWER PIPES MAY BE REQUIRED.</div> <div>6. CONTRACTOR IS RESPONSIBLE FOR KEEPING FIELD NOTES THAT PROVIDE SUFFICIENT DATA FOR PREPARING "RECORD DRAWINGS" UPON COMPLETION OF CONSTRUCTION.</div> <div>7. ALL WATER MAIN CONSTRUCTION SHALL CONFORM TO THE NORTHERN KENTUCKY WATER DISTRICT SPECIFICATIONS. CONTRACTORS ARE RESPONSIBLE FOR OBTAINING THE STANDARD DRAWINGS FOR THE NORTHERN KENTUCKY WATER DISTRICT'S STANDARD DRAWINGS.</div> <div>8. ALL MATERIAL FOR THE PROP. WATER MAIN INSTALLATION INCLUDING ALL FITTINGS, BLOCKING, ETC., SHALL BE INCLUDED IN THE CONTRACTORS UNIT PRICE FOR WATER MAIN.</div> <div>9. COST OF ALL TRENCHING, PIPE, PIPE BEDDING, BACKFILL, YARD RESTORATION AND TEMPORARY PAVEMENT, DRIVEWAY AND SIDEWALK RESTORATION SHALL BE PART OF THE COST OF INSTALLING THE WATER MAIN. PERMANENT DRIVEWAY RESTORATION, SIDEWALK RESTORATION, CURB RESTORATION AND STREET RESTORATION WILL BE SEPARATE PAY ITEMS AND INCLUDE INCIDENTALS SUCH AS WALL BOX, STREET SIGN, AND FENCE REMOVAL AND REPLACEMENT.</div> <div>10. THE PROPOSED WATER MAIN SHALL BE CLASS 40 DUCTILE IRON PIPE OR D.R. 18 C900 PVC AS SHOWN ON THE PLANS, WITHIN STATE ROUTE RW/ PIPE MATERIAL SHALL BE CLASS 42 DUCTILE IRON.</div> <div>11. PROPOSED WATER MAIN SHALL BE THOROUGHLY CLEANED, FLUSHED, AND DISINFECTED, AS PER NORTHERN KENTUCKY WATER DISTRICT'S SPECIFICATIONS.</div> <div>12. PRESSURE TESTING SHALL BE DONE AS PER NORTHERN KENTUCKY WATER DISTRICT'S SPECIFICATIONS.</div> <div>13. FOR THRUST BLOCKING REFER TO THE NORTHERN KENTUCKY WATER DISTRICT'S STANDARD DRAWING NUMBERS 104 AND 104A.</div> <div>14. THE PROPOSED WATER MAIN SHALL HAVE A HORIZONTAL SEPARATION OF AT LEAST 2' (MEASURED FROM OUTSIDE OF PIPE TO OUTSIDE OF PIPE) FROM ANY GAS MAIN.</div> <div>15. A 10" MINIMUM LATERAL SEPARATION BETWEEN WATER MAINS AND SEWERS (DEFINED AS ANY SANITARY/COMBINED SEWER, SEPTIC TANK OR SUBSOIL TREATMENT SYSTEM) AND SEWER MANHOLES, MEASURED FROM THE OUTSIDE DIAMETER TO OUTSIDE, MUST BE MAINTAINED UNLESS A VARIANCE IS GRANTED FROM THE D.O.W.</div> <div>16. ALL NEW WATER SERVICES SHALL BE 3/4" (OR MATCH EXISTING, AS INDICATED ON THE PLANS) TYPE K COPPER WITH 98" OR 2" WATER METERS (UNLESS OTHERWISE NOTED) MATERIAL PROVIDED BY THE NORTHERN KENTUCKY WATER DISTRICT. ALL RECONNECTED WATER SERVICES SHALL BE 3/4" OR 2" TYPE K COPPER.</div> <div>17. THE CONTRACTOR SHALL COORDINATE ALL WORK WITHIN THE PUBLIC RIGHT-OF-WAY WITH KYTC, KENTON COUNTY AND/OR ANY LOCAL MUNICIPALITY. TRAFFIC MUST BE MAINTAINED AT ALL TIMES DURING CONSTRUCTION. MAINTENANCE OF TRAFFIC SHALL CONFORM TO THE "MANUAL OF UNIFORM TRAFFIC CONTROL DEVICES" REQUIREMENTS. NO ADDITIONAL PAYMENT WILL BE MADE FOR THIS WORK AND SHALL BE CONSIDERED INCIDENTAL TO THE CONTRACT.</div> <div>18. CONNECT SERVICE LINE (3/4" THRU 2") INCLUDES THE LABOR, EQUIPMENT, EXCAVATION, BEDDING, BACKFILL, ASPHALT PAVEMENT, CONCRETE PAVEMENT, CONCRETE CURB, CONCRETE WALK AND YARD RESTORATION TO INSTALL THE SERVICE LINE AT THE LOCATIONS SHOWN ON THE PLANS OR AS DIRECTED, IN ACCORDANCE WITH THE SPECIFICATIONS AND STANDARD DRAWINGS, COMPLETE AND READY FOR USE. LEAD SERVICE LINES ENCOUNTERED BY THE EXCAVATION SHALL BE REPAIRED FROM THE EXISTING SERVICE LINE TO THE EXCAVATION. THE CONTRACTOR SHALL BE RESPONSIBLE FOR THE COST OF DOING THE ADJUST. THIS SHALL BE INCIDENTAL TO THE SERVICE LINE MATERIAL WILL BE SUPPLIED BY NKWD. PAID EACH FEET.</div> <div>19. THE CONTRACTOR SHALL COORDINATE WITH THE NORTHERN KENTUCKY WATER DISTRICT FOR FIELD INSPECTIONS.</div> <div>20. FORTY-EIGHT (48) HOURS BEFORE EXCAVATION IS TO COMMENCE, THE CONTRACTOR SHALL NOTIFY THE KENTON COUNTY AND KENTON COUNTY KENTUCKY UTILITY PROTECTION SERVICE AND ALL OTHER UTILITIES THAT MAY HAVE UNDERGROUND UTILITIES INVOLVING THIS PROJECT AND ARE NON-MEMBERS OF KENTUCKY UNDERGROUND PROTECTION.</div> <div>21. NO CONSTRUCTION SHALL COMMENCE UNTIL ALL KYTC, COUNTY AND/OR LOCAL PERMITS HAVE BEEN ISSUED AS REQUIRED.</div> <div>22. CONTRACTOR IS RESPONSIBLE FOR DEMARKING TRENCH DURING INSTALLATION OF THE WATER MAIN.</div> <div>23. THE COST OF TESTING THE MAIN, TEMPORARY FLUSHING DEVICES, TEMPORARY PLUG AND BLOCKS, AND ABANDONING THE EXISTING MAIN SHALL BE INCIDENTAL TO THE PROJECT.</div> <div>24. ALL PAYMENT SHALL CONFORM TO THE LATEST EDITION OF THE KENTUCKY DEPARTMENT OF HIGHWAYS STANDARD SPECIFICATIONS FOR ROAD AND BRIDGE CONSTRUCTION AND KENTON COUNTY SUBDIVISION REGULATIONS.</div>		<div>1. ALL MAINTENANCE OF TRAFFIC PROCEDURES SHALL MEET THE REQUIREMENT OF THE MANUAL OF UNIFORM TRAFFIC CONTROL DEVICES AND SECTION 112 OF KTC STANDARD SPECIFICATIONS. THE CONTRACTOR SHALL MAINTAIN ACCESS TO LOCAL TRAFFIC (INCLUDING ACCESS TO RESIDENCES WITHIN CONSTRUCTION LIMITS) AT ALL TIMES UTILIZING KTC STANDARD DRAWING TTC-100-05 SINGLE LANE CLOSURE ON TWO-LANE HIGHWAY. THE CONTRACTOR SHALL PROVIDE SPECIFIC SIGN, WARNING LIGHTS, BARRIERS, AND FLAGMEN TO PROTECT THE WORK AREA. THE TRAFFIC PUBLIC LENGTH OF SINGLE LANE CLOSURES WILL BE HELD TO DISTANCES NOT ADVERSELY AFFECTING VEHICLE SAFETY.</div> <div>2. ALL UNBACKFILLED TRENCH EXCAVATION SHALL BE SECURELY PLATED AT THE END OF EACH WORK DAY AND DURING PERIODS OF INACTIVITY.</div> <div>3. IT SHALL BE THE CONTRACTORS RESPONSIBILITY TO SUBMIT TO THE ENGINEER AND THE OWNER A TRAFFIC CONTROL PLAN FOR THIS PROJECT.</div> <div>4. PRIOR TO ANY CONSTRUCTION, THE CONTRACTOR SHALL NOTIFY THE APPROPRIATE STATE, COUNTY AND/OR LOCAL POLICE DEPARTMENTS, AT ALL TIMES, EMERGENCY VEHICLES SHALL BE GIVEN ACCESS.</div> <div>5. RESIDENTS OF THE PROJECT AREA SHALL BE ALLOWED ACCESS TO THEIR PROPERTY AT ALL TIMES.</div> <div>6. EACH DRIVEWAY SHALL BE ACCESSIBLE WHENEVER POSSIBLE. WHEN PORTLAND CEMENT CONCRETE CONSTRUCTION AFFECTS A DRIVEWAY, THE CONTRACTOR SHALL NOTIFY THE AFFECTED OWNERS 24 HOURS IN ADVANCE AND ADVISE THEM TO FIND ALTERNATIVE PARKING FOR A PERIOD OF AT LEAST 10 CALENDAR DAYS AFTER THE POUR. ALTERNATIVE PARKING SHALL INCLUDE ON STREET PARKING WITH ACCESS TO THE PROPERTY AND DRIVEWAY. IN ORDER TO ENTER THEIR PROPERTY, TEMPORARY BRIDGES, RAILINGS ETC. WILL BECOME NECESSARY IN ORDER TO CROSS FORMED CURB LINES. 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EXCAVATED AREAS BEHIND CURB LINES AND WALKWAYS, ETC.</div>		<div>EXISTING FLAGPOLE</div> <div>PROPOSED FLAGPOLE</div> <div>EXISTING MAILBOX</div> <div>PROPOSED MAILBOX</div> <div>EXISTING SIGN</div> <div>PROPOSED SIGN</div> <div>EXISTING CABLE PEDESTAL</div> <div>PROPOSED CABLE PEDESTAL</div> <div>EXISTING ELECTRIC PEDESTAL</div> <div>PROPOSED ELECTRIC PEDESTAL</div> <div>EXISTING PULL BOX</div> <div>PROPOSED PULL BOX</div> <div>EXISTING GROUND LIGHT</div> <div>PROPOSED GROUND LIGHT</div> <div>EXISTING LIGHT POLE</div> <div>PROPOSED LIGHT POLE</div> <div>EXISTING ELECTRIC METER</div> <div>PROPOSED ELECTRIC METER</div> <div>EXISTING ELECTRIC MANHOLE</div> <div>PROPOSED ELECTRIC MANHOLE</div> <div>EXISTING GAS METER</div> <div>PROPOSED GAS METER</div> <div>EXISTING GAS VALVE</div> <div>PROPOSED GAS VALVE</div> <div>EXISTING GAS BOX</div> <div>PROPOSED GAS BOX</div> <div>EXISTING UTILITY POLE</div> <div>PROPOSED UTILITY POLE</div> <div>EXISTING GUY WIRE / ANCHOR</div> <div>PROPOSED GUY WIRE / ANCHOR</div> <div>EXISTING SANITARY MANHOLE</div> <div>PROPOSED SANITARY MANHOLE</div> <div>EXISTING SANITARY CLEANOUT</div> <div>PROPOSED SANITARY CLEANOUT</div> <div>EXISTING STORM MANHOLE</div> <div>PROPOSED STORM MANHOLE</div> <div>EXISTING SINGLE / DOUBLE CURB INLET</div> <div>PROPOSED SINGLE / DOUBLE CURB INLET</div> <div>EXISTING CATCH BASIN</div> <div>PROPOSED CATCH BASIN</div> <div>EXISTING STORM CLEANOUT</div> <div>PROPOSED STORM CLEANOUT</div> <div>EXISTING TELEPHONE MANHOLE</div> <div>PROPOSED TELEPHONE MANHOLE</div> <div>EXISTING TELEPHONE PEDESTAL</div> <div>PROPOSED TELEPHONE PEDESTAL</div> <div>EXISTING FIRE HYDRANT</div> <div>PROPOSED FIRE HYDRANT</div> <div>EXISTING WATER METER</div> <div>PROPOSED WATER METER</div> <div>EXISTING WATER VALVE</div> <div>PROPOSED WATER VALVE</div> <div>EXISTING BUSHES / TREES</div> <div>REMOVE EXISTING BUSH / TREE</div> <div>EXISTING SURVEY BENCHMARK</div> <div>PROPOSED SLOPE DIRECTION</div> <div>TEST BORING LOCATION</div>	
GENERAL TRENCH EXCAVATION NOTES		STORM & SANITARY NOTES		WATER DISTRICT GENERAL NOTES		MAINTENANCE OF TRAFFIC NOTES		SYMBOL LEGEND			
<div>1. CONTRACTOR IS TO PROVIDE CONSTANT STABLE SUPPORT FOR THE WATER MAIN TRENCH EXCAVATION (6 SHEETING, SHORING, ETC.) TO PROTECT ALL ADJACENT EXISTING UTILITIES, MAIN SEWER, ETC.) TO REMAIN UNDISTURBED. THE CONTRACTOR SHALL BE RESPONSIBLE FOR ANY ADDITIONAL PAYMENT WILL BE MADE FOR THIS WORK. ANY COSTS ASSOCIATED WITH TRENCH SUPPORT SHALL BE INCLUDED IN THE UNIT BID PRICE FOR THE ASSOCIATED WATER MAIN.</div> <div>TRENCH SUPPORT FAILURE RESULTING IN ADVERSE IMPACT TO EXISTING UTILITIES SHALL BE REPAIRED IMMEDIATELY AT THE CONTRACTORS EXPENSE.</div> <div>2. TRENCH EXCAVATION AND OPEN UNBACKFILLED LENGTH OF WATER MAIN TRENCH SHALL BE LIMITED AS NECESSARY ALONG THE ROADWAY IN ORDER TO PREVENT MOVEMENT OF OR DAMAGE TO THE SURROUNDING GROUND SURFACE. NEARBY STRUCTURES/INFRASTRUCTURE AND THE EXISTING ROADWAY PAVEMENT.</div> <div>TRENCH EXCAVATION SHALL ALSO BE LIMITED TO THE CONTRACTORS ABILITY TO PROVIDE TRENCH BOXES FOR SUPPORT UNDER NO CIRCUMSTANCES SHALL TRENCH EXCAVATION EXCEED LENGTH OF SUPPORT AVAILABLE.</div>		<div>1. ALL STORM AND SANITARY ITEMS SHALL BE IN ACCORDANCE WITH THE LATEST SPECIFICATIONS AND DETAILS FROM SD1. METAL PIPE MATERIALS SHALL NOT BE USED UNLESS OTHERWISE SPECIFIED ON THESE PLANS.</div> <div>2. CONTRACTOR SHALL BE REQUIRED TO MAINTAIN STORM AND SANITARY SEWER FLOW THROUGHOUT THE PROJECT. FOR THE DURATION OF CONSTRUCTION, ALL COST FOR THE ABOVE SHALL BE INCIDENTAL TO THE CONTRACT.</div> <div>3. IF REQUIRED, CONTRACTOR SHALL BE RESPONSIBLE FOR CONTACTING AND SCHEDULING STORM AND SANITARY SEWER INSPECTIONS AS SET OUT IN THE RECONSTRUCTION MEETING.</div> <div>4. CONNECTIONS INTO EXISTING OR PROPOSED STORM OR SANITARY SEWER STRUCTURES OR PIPES SHALL BE COMPLETED BY A CERTIFIED TAPPER BY SD1.</div>		<div>1. ALL WORK RELATING TO WATER MAINS OR WATER SERVICE LINES SHALL BE COMPLETED IN ACCORDANCE WITH THE RULES AND REGULATIONS OF THE NORTHERN KENTUCKY WATER DISTRICT (NKWD).</div> <div>2. CONTRACTOR MAY NOT USE WATER FROM FINE HYDRANTS WITHOUT PRIOR PERMISSION FROM NKWD.</div>		<div>1. ALL WORK RELATING TO GAS MAINS OR GAS SERVICE LINES SHALL BE COMPLETED IN ACCORDANCE WITH THE RULES AND REGULATIONS OF THE DUKE THE DUKE ENERGY</div>		<div>1. ALL MAINTENANCE OF TRAFFIC PROCEDURES SHALL MEET THE REQUIREMENT OF THE MANUAL OF UNIFORM TRAFFIC CONTROL DEVICES AND SECTION 112 OF KTC STANDARD SPECIFICATIONS. THE CONTRACTOR SHALL MAINTAIN ACCESS TO LOCAL TRAFFIC (INCLUDING ACCESS TO RESIDENCES WITHIN CONSTRUCTION LIMITS) AT ALL TIMES UTILIZING KTC STANDARD DRAWING TTC-100-05 SINGLE LANE CLOSURE ON TWO-LANE HIGHWAY. THE CONTRACTOR SHALL PROVIDE SPECIFIC SIGN, WARNING LIGHTS, BARRIERS, AND FLAGMEN TO PROTECT THE WORK AREA. THE TRAFFIC PUBLIC LENGTH OF SINGLE LANE CLOSURES WILL BE HELD TO DISTANCES NOT ADVERSELY AFFECTING VEHICLE SAFETY.</div> <div>2. ALL UNBACKFILLED TRENCH EXCAVATION SHALL BE SECURELY PLATED AT THE END OF EACH WORK DAY AND DURING PERIODS OF INACTIVITY.</div> <div>3. IT SHALL BE THE CONTRACTORS RESPONSIBILITY TO SUBMIT TO THE ENGINEER AND THE OWNER A TRAFFIC CONTROL PLAN FOR THIS PROJECT.</div> <div>4. PRIOR TO ANY CONSTRUCTION, THE CONTRACTOR SHALL NOTIFY THE APPROPRIATE STATE, COUNTY AND/OR LOCAL POLICE DEPARTMENTS, AT ALL TIMES, EMERGENCY VEHICLES SHALL BE GIVEN ACCESS.</div> <div>5. RESIDENTS OF THE PROJECT AREA SHALL BE ALLOWED ACCESS TO THEIR PROPERTY AT ALL TIMES.</div> <div>6. EACH DRIVEWAY SHALL BE ACCESSIBLE WHENEVER POSSIBLE. WHEN PORTLAND CEMENT CONCRETE CONSTRUCTION AFFECTS A DRIVEWAY, THE CONTRACTOR SHALL NOTIFY THE AFFECTED OWNERS 24 HOURS IN ADVANCE AND ADVISE THEM TO FIND ALTERNATIVE PARKING FOR A PERIOD OF AT LEAST 10 CALENDAR DAYS AFTER THE POUR. 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\\KENTON\99\WORK\BTRFCTG_231591\01\DETAIL SHEET\GWS NOTES_3/17/2025 15:56:57 JAW.JAMES.COWELL



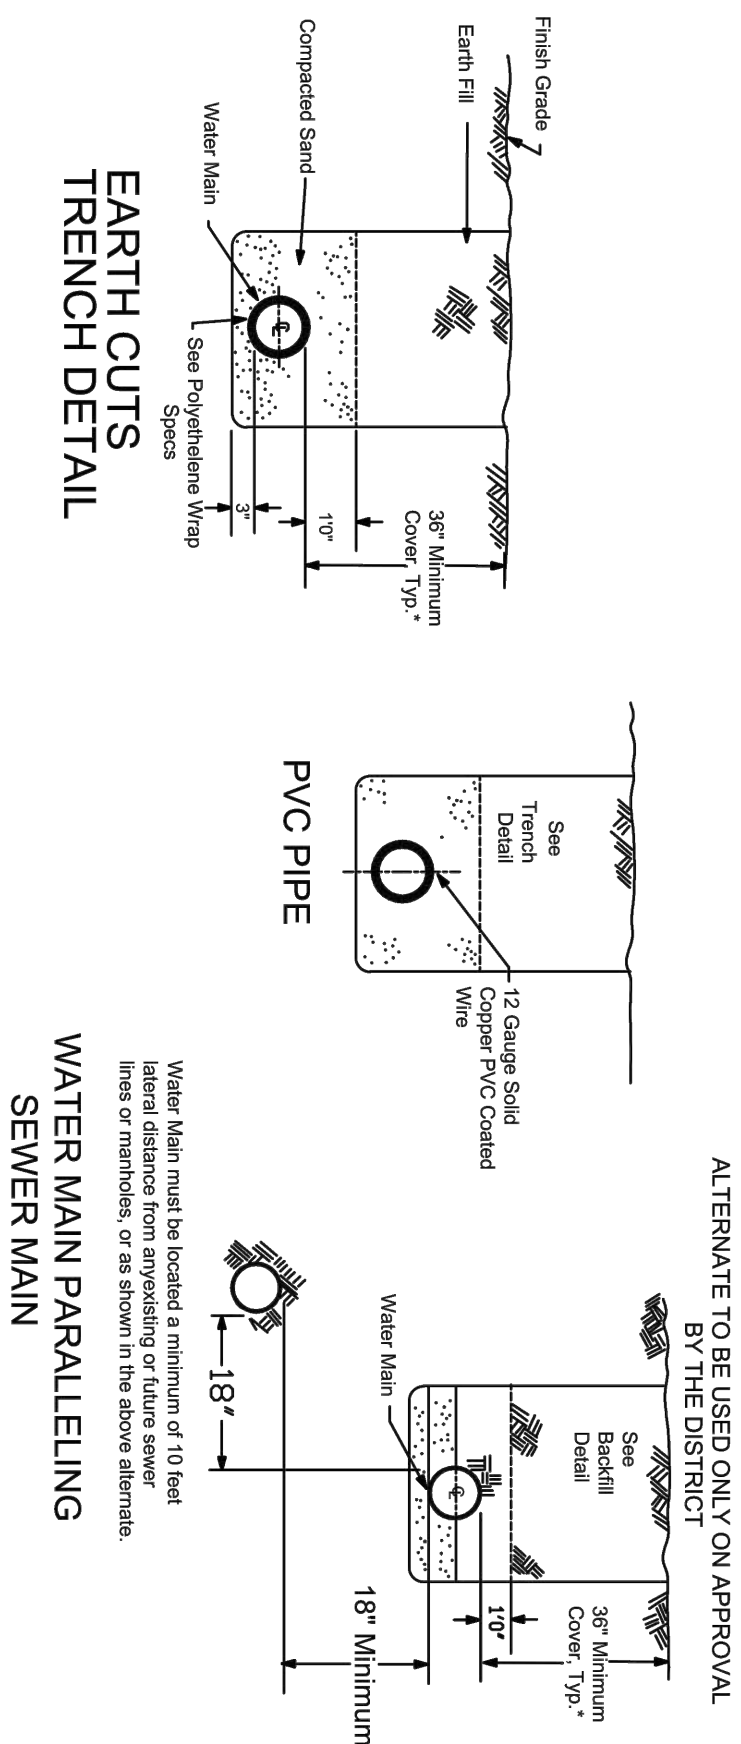2161 CHAMBER CENTER DRIVE
FORT MITCHELL, KENTUCKY 41017
TEL. (859) 525-0544
WWW.VERDANTAS.COM




ROCK CUTS & UNSTABLE SUBGRADE TRENCH DETAIL

SUBDIVISION CONSTRUCTION

* Unless Otherwise Noted

REVISION	BY	DATE
1	W	10/20/22
N. KY. WATER DISTRICT		
TYPICAL PIPELINE TRENCH DETAIL		
DATE	DRAWN BY	DATE
9/5/2014	SK	9/5/2014
STANDARD DRAWING NO.	APPROVED	STANDARD DRAWING NO.
103	103	103

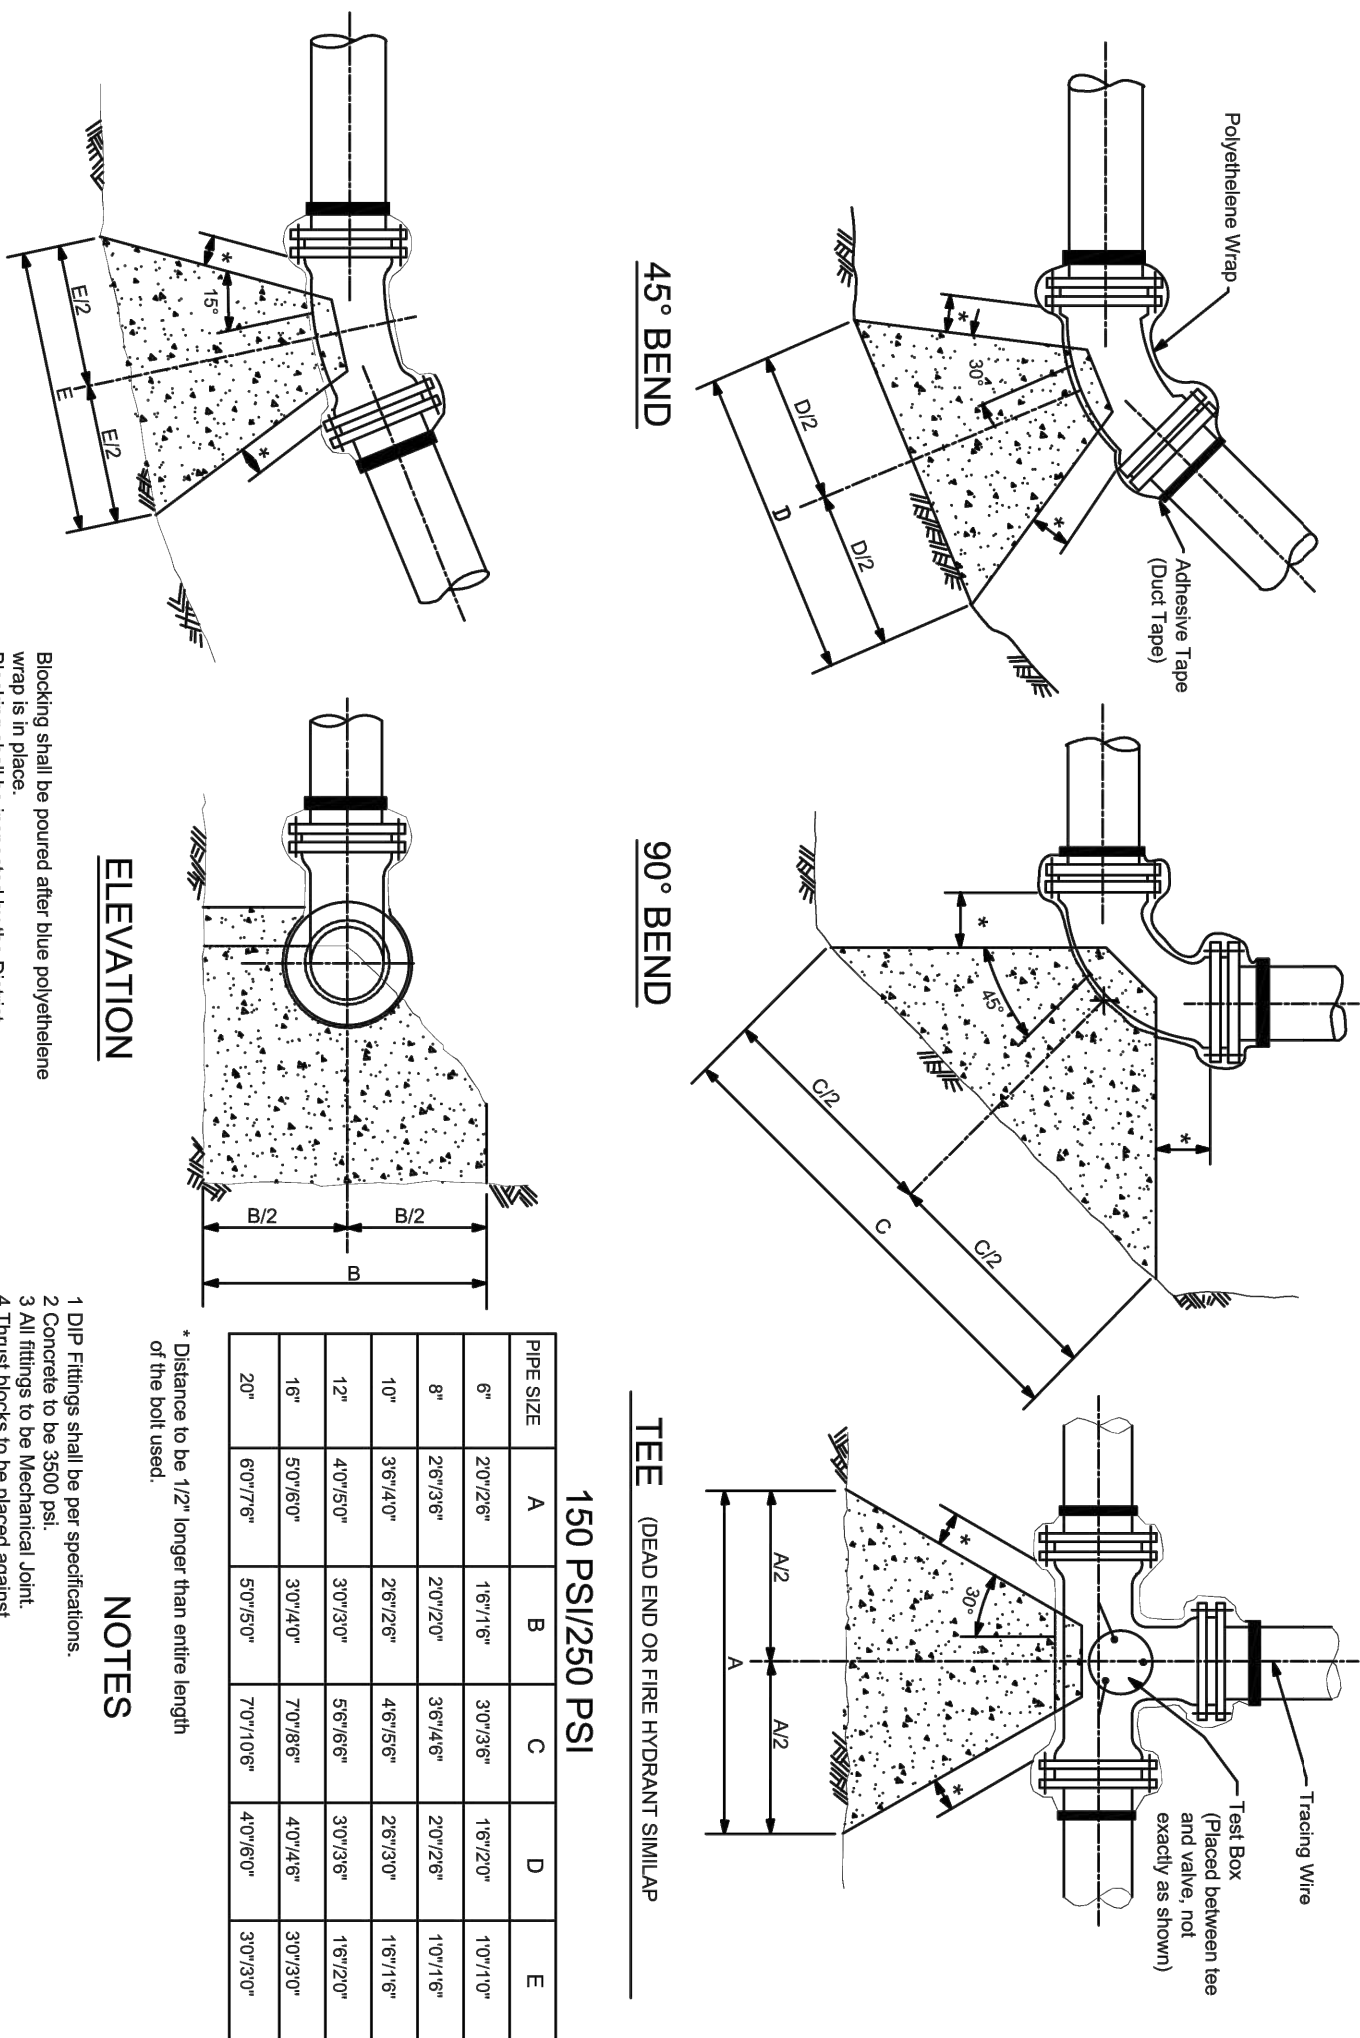


ELEVATION

NOTES

1. DTP Fillings shall be per specifications.
2. Concrete to be 3500 psi.
3. All fittings to be mechanical joint.
4. Thrust blocks to be placed against existing concrete.
5. Blocking to be placed in a manner so that bolts can be removed without disturbing the block.


REVISION	BY	DATE
1	W	10/20/22
N. KY. WATER DISTRICT		
CONCRETE THRUST BLOCK DETAIL		
DATE	DRAWN BY	DATE
9/5/2014	SK	9/5/2014
STANDARD DRAWING NO.	APPROVED	STANDARD DRAWING NO.
104	104	104

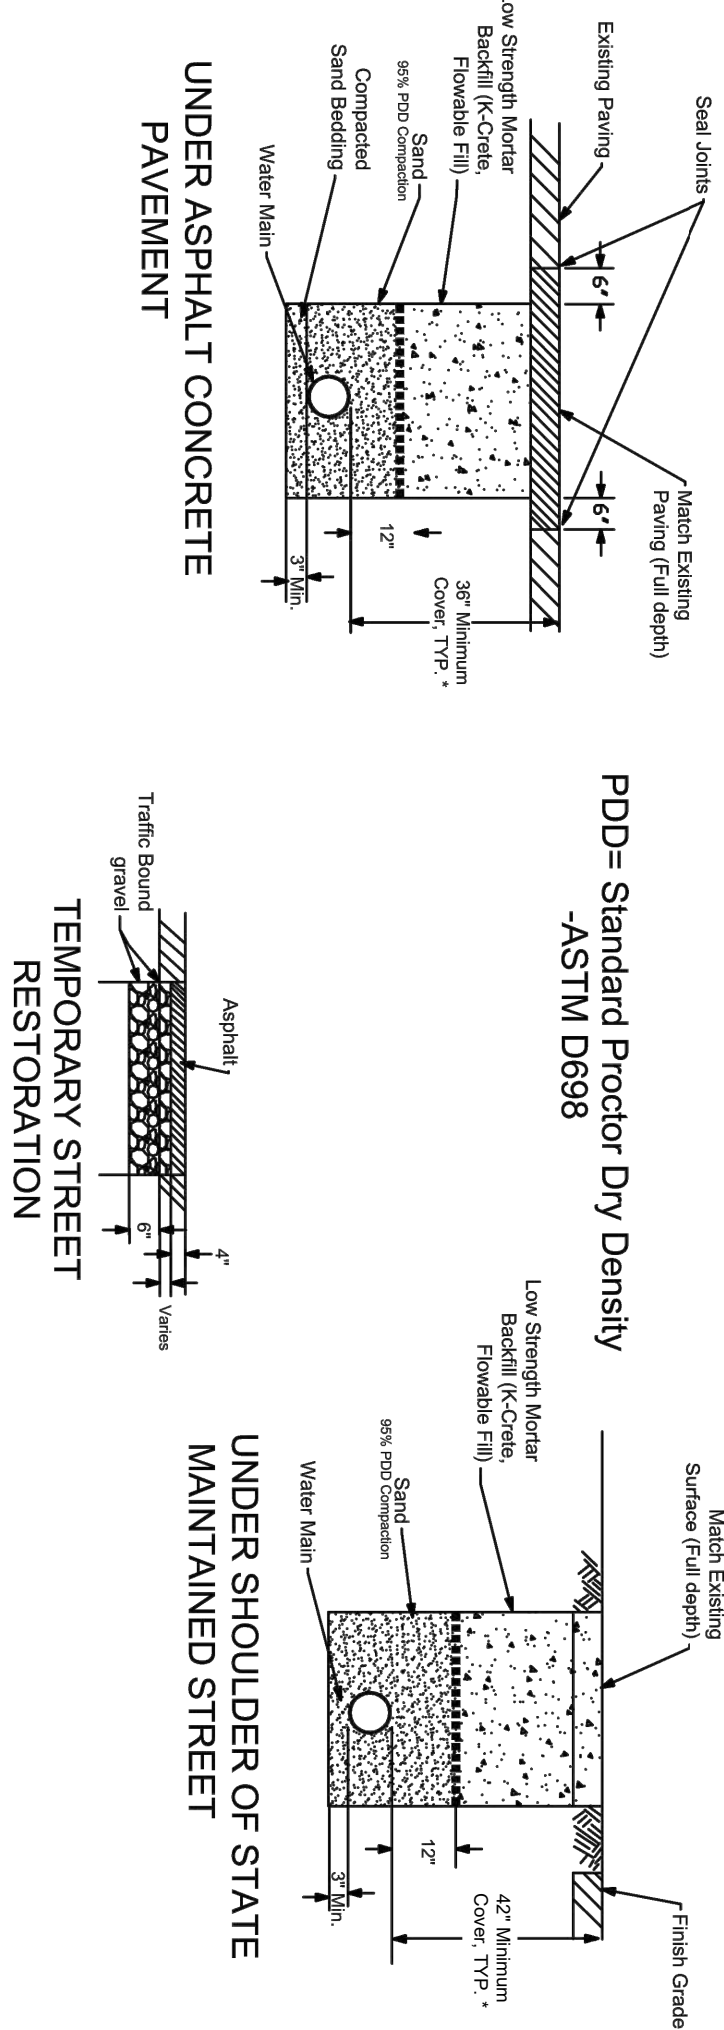

UNDER CONCRETE PAVEMENT

ALL CONSTRUCTION


REVISION	BY	DATE
1	W	10/20/22
N. KY. WATER DISTRICT		
TYPICAL PIPELINE TRENCH DETAIL		
DATE	DRAWN BY	DATE
9/5/2014	SK	9/5/2014
STANDARD DRAWING NO.	APPROVED	STANDARD DRAWING NO.
103A	103A	103A

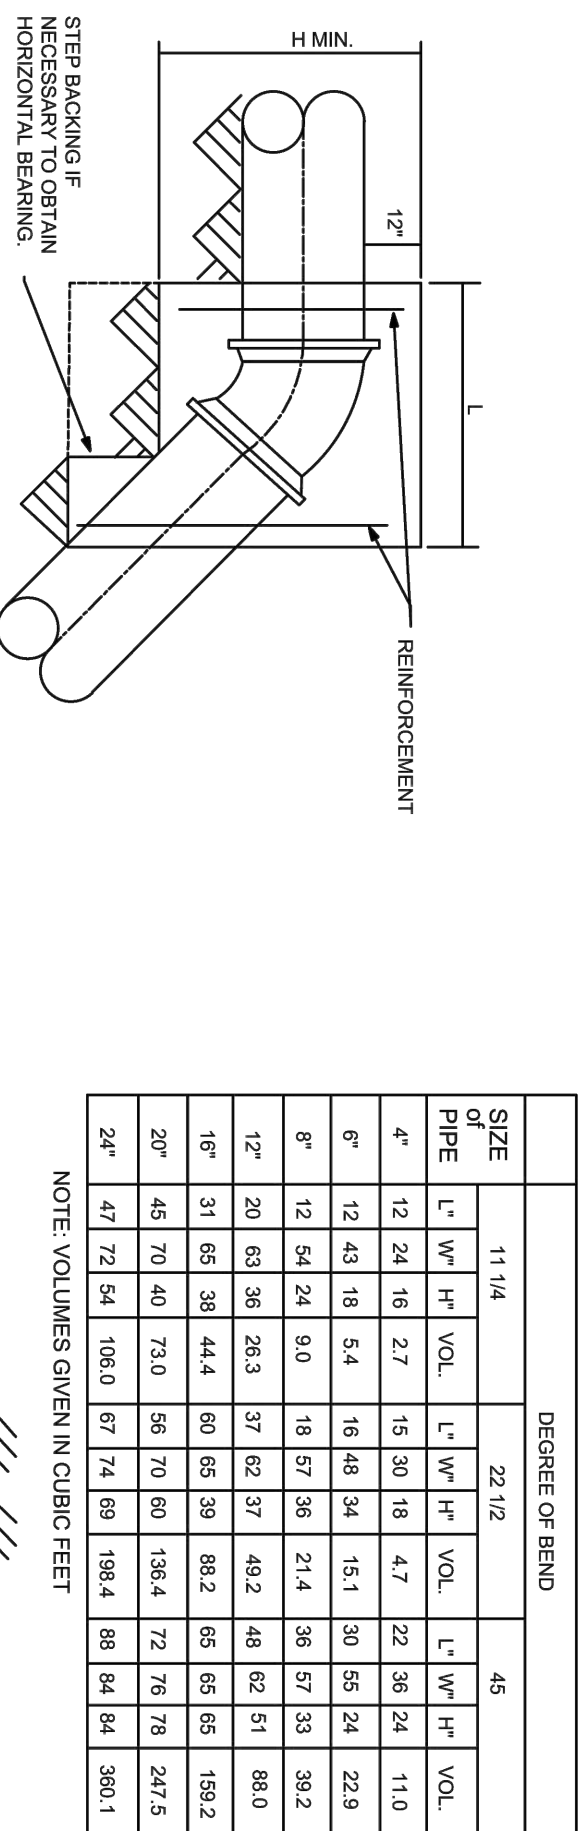

SECTION A-A

CONCRETE BACKING FOR VERTICAL BENDS

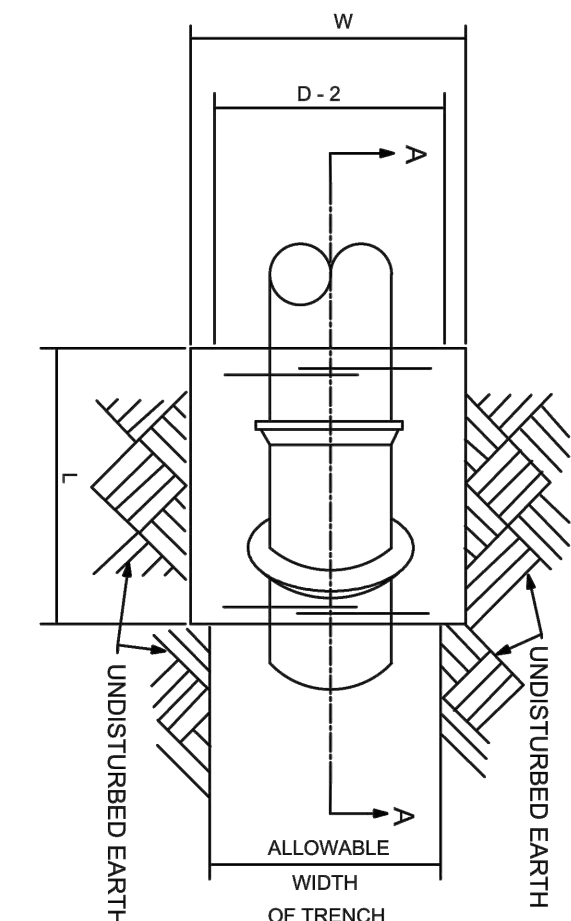
1. BACKING DESIGNED FOR 3000 POUNDS PER SQUARE FOOT SOIL BEARING AND 150 POUNDS PER SQUARE INCH INTERNAL PRESSURE.
2. PROVIDE MINIMUM CONCRETE REINFORCEMENT OF 2 BAR OF TWO 5" U BARS @ 12" C.
3. CENTER BACKING ON BEND.



REVISION	BY	DATE
1	W	10/20/22
N. KY. WATER DISTRICT		
CONCRETE THRUST BLOCKING FOR VERTICAL BENDS		
DATE	DRAWN BY	DATE
9/5/2014	SK	9/5/2014
STANDARD DRAWING NO.	APPROVED	STANDARD DRAWING NO.
104A	104A	104A


DATE	REVISION	NO	BID	ISSUED FOR:
				APRIL 2025
				AS SHOWN
				JCOR
				JCOR
				JSHU

PROJECT NO.	DISCIPLINE	SHEET NAME	SHEET	OF
231591	CIVIL	G-02	3	28

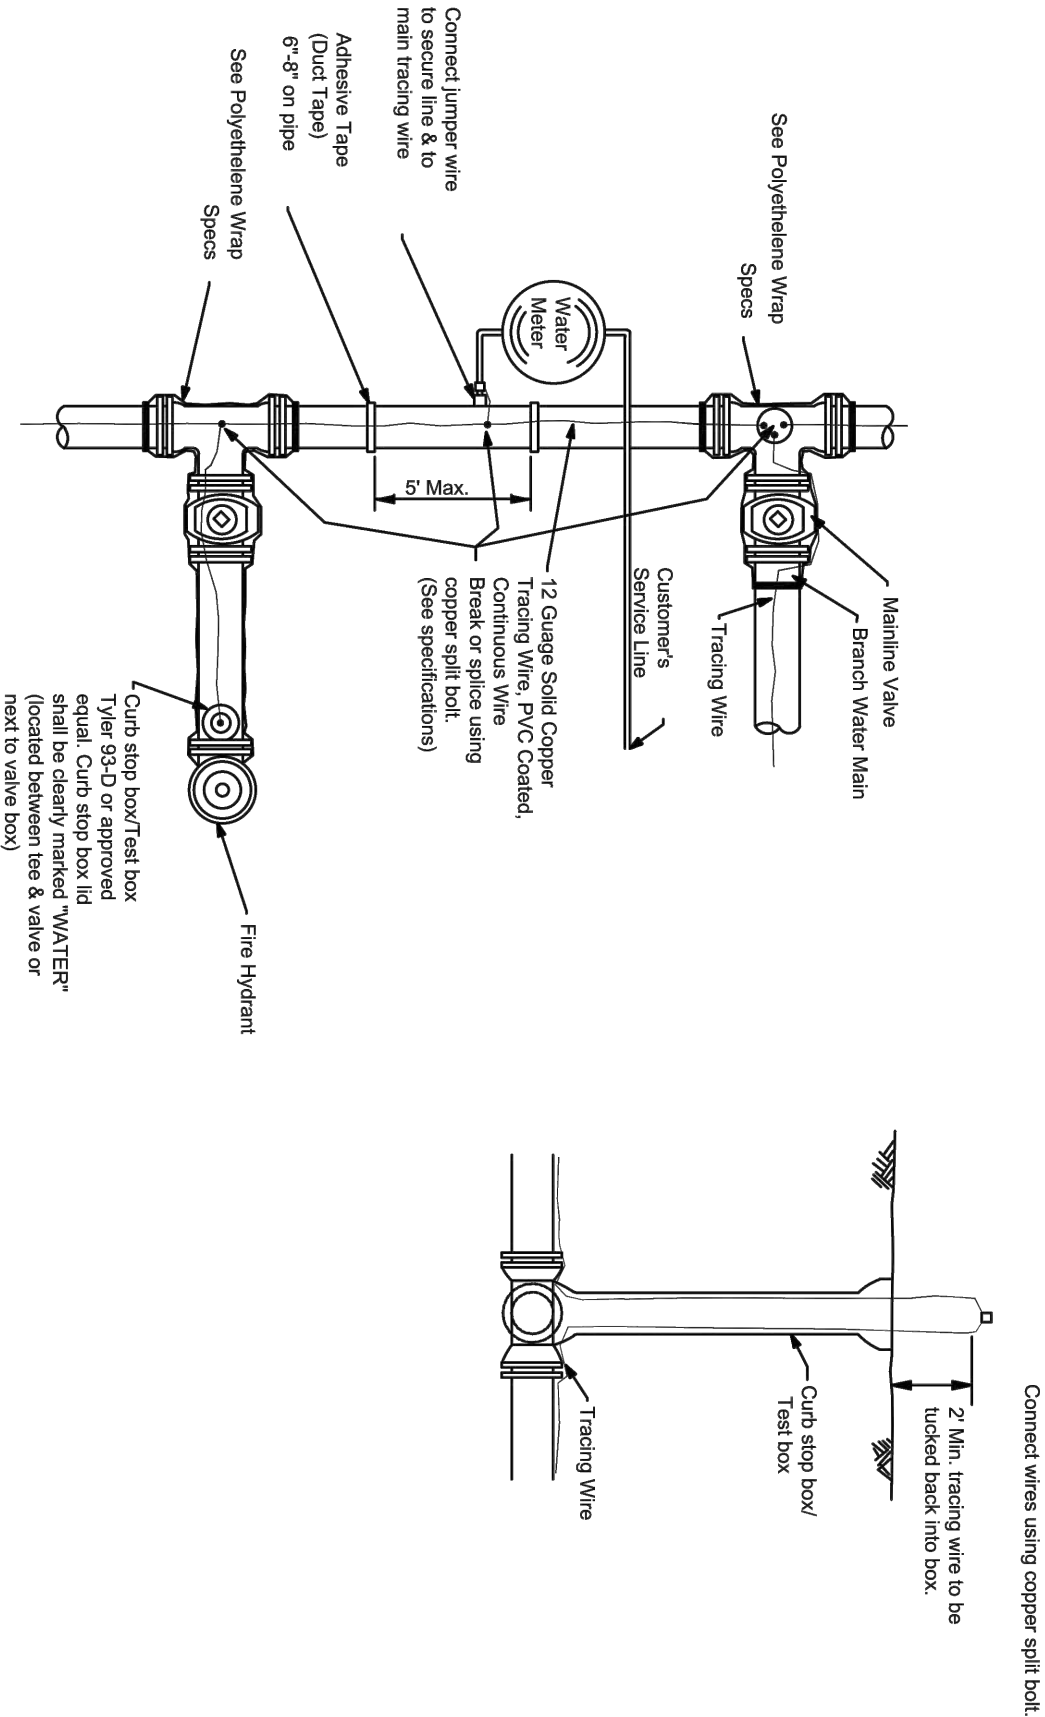


DUCTILE IRON AND PVC PIPE
WITH DUCTILE IRON FITTINGS

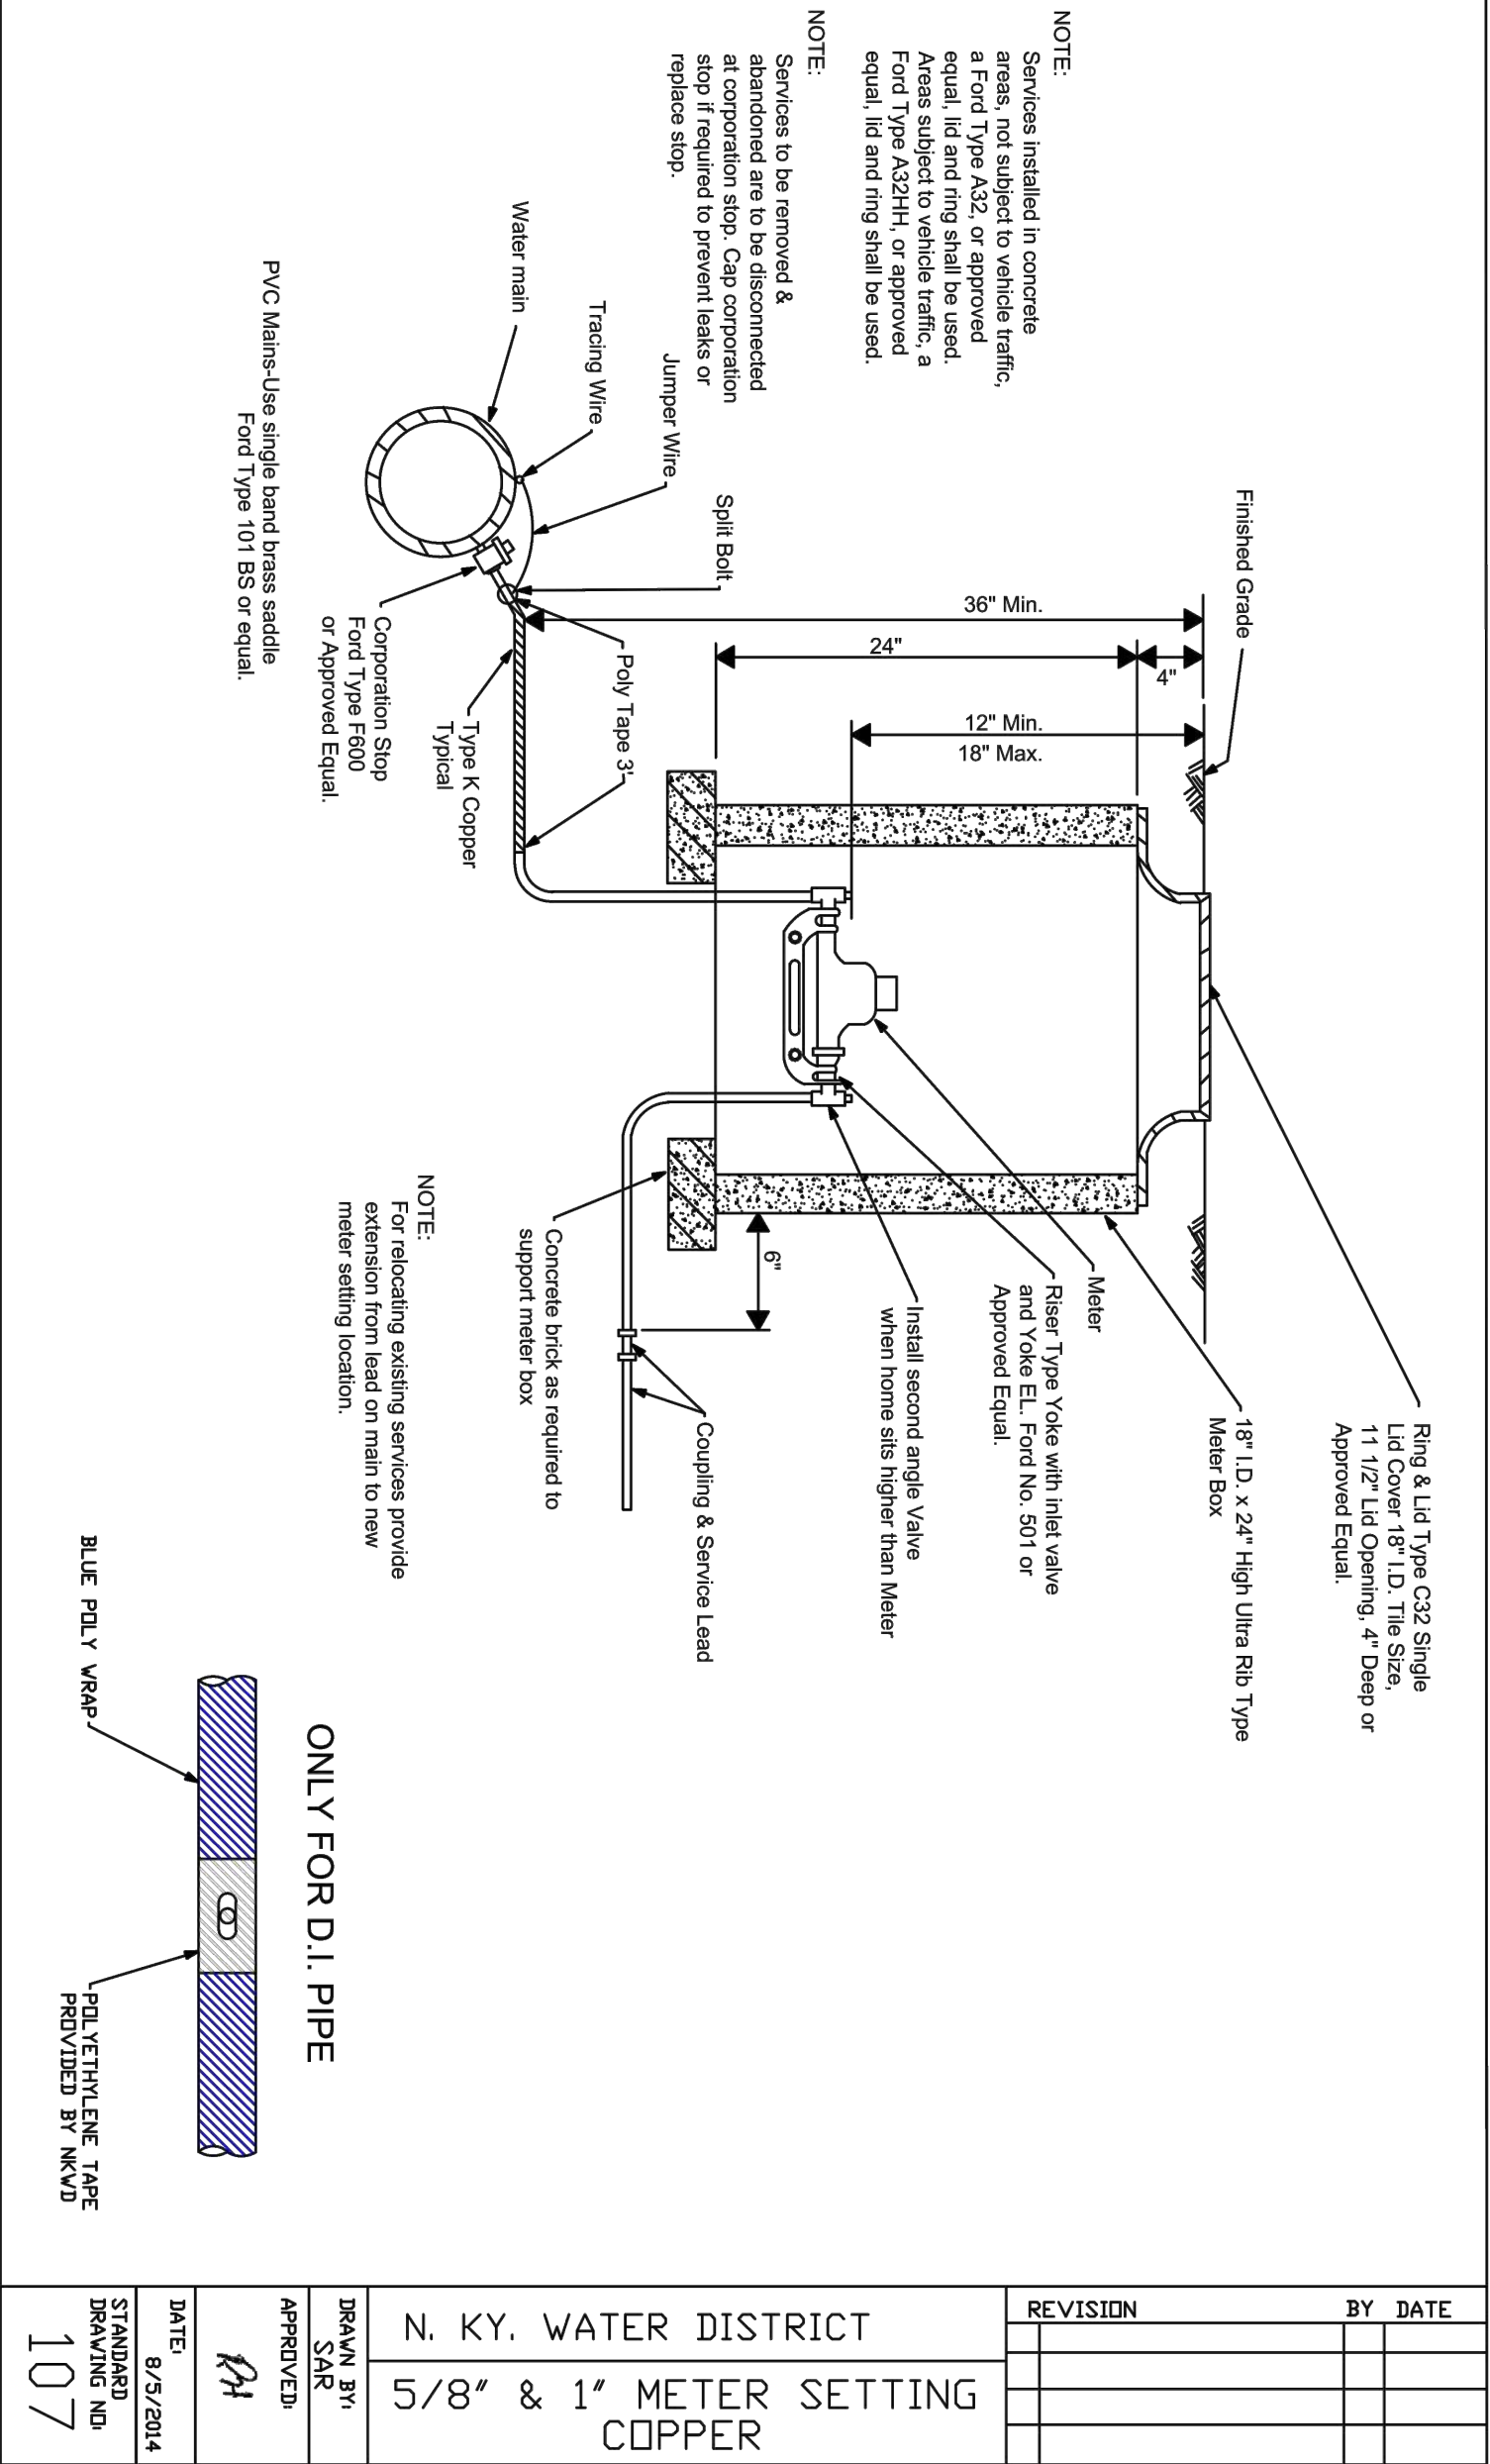Note: Cut stop box/break box shall not be installed in paved areas.



REVISION	BY	DATE
N. KY. WATER DISTRICT TRACING WIRE INSTALLATION DETAIL		
DRAWN BY: SAR	APPROVED: MH	DATE: 8/3/2014
STANDARD DRAWING NO 111		

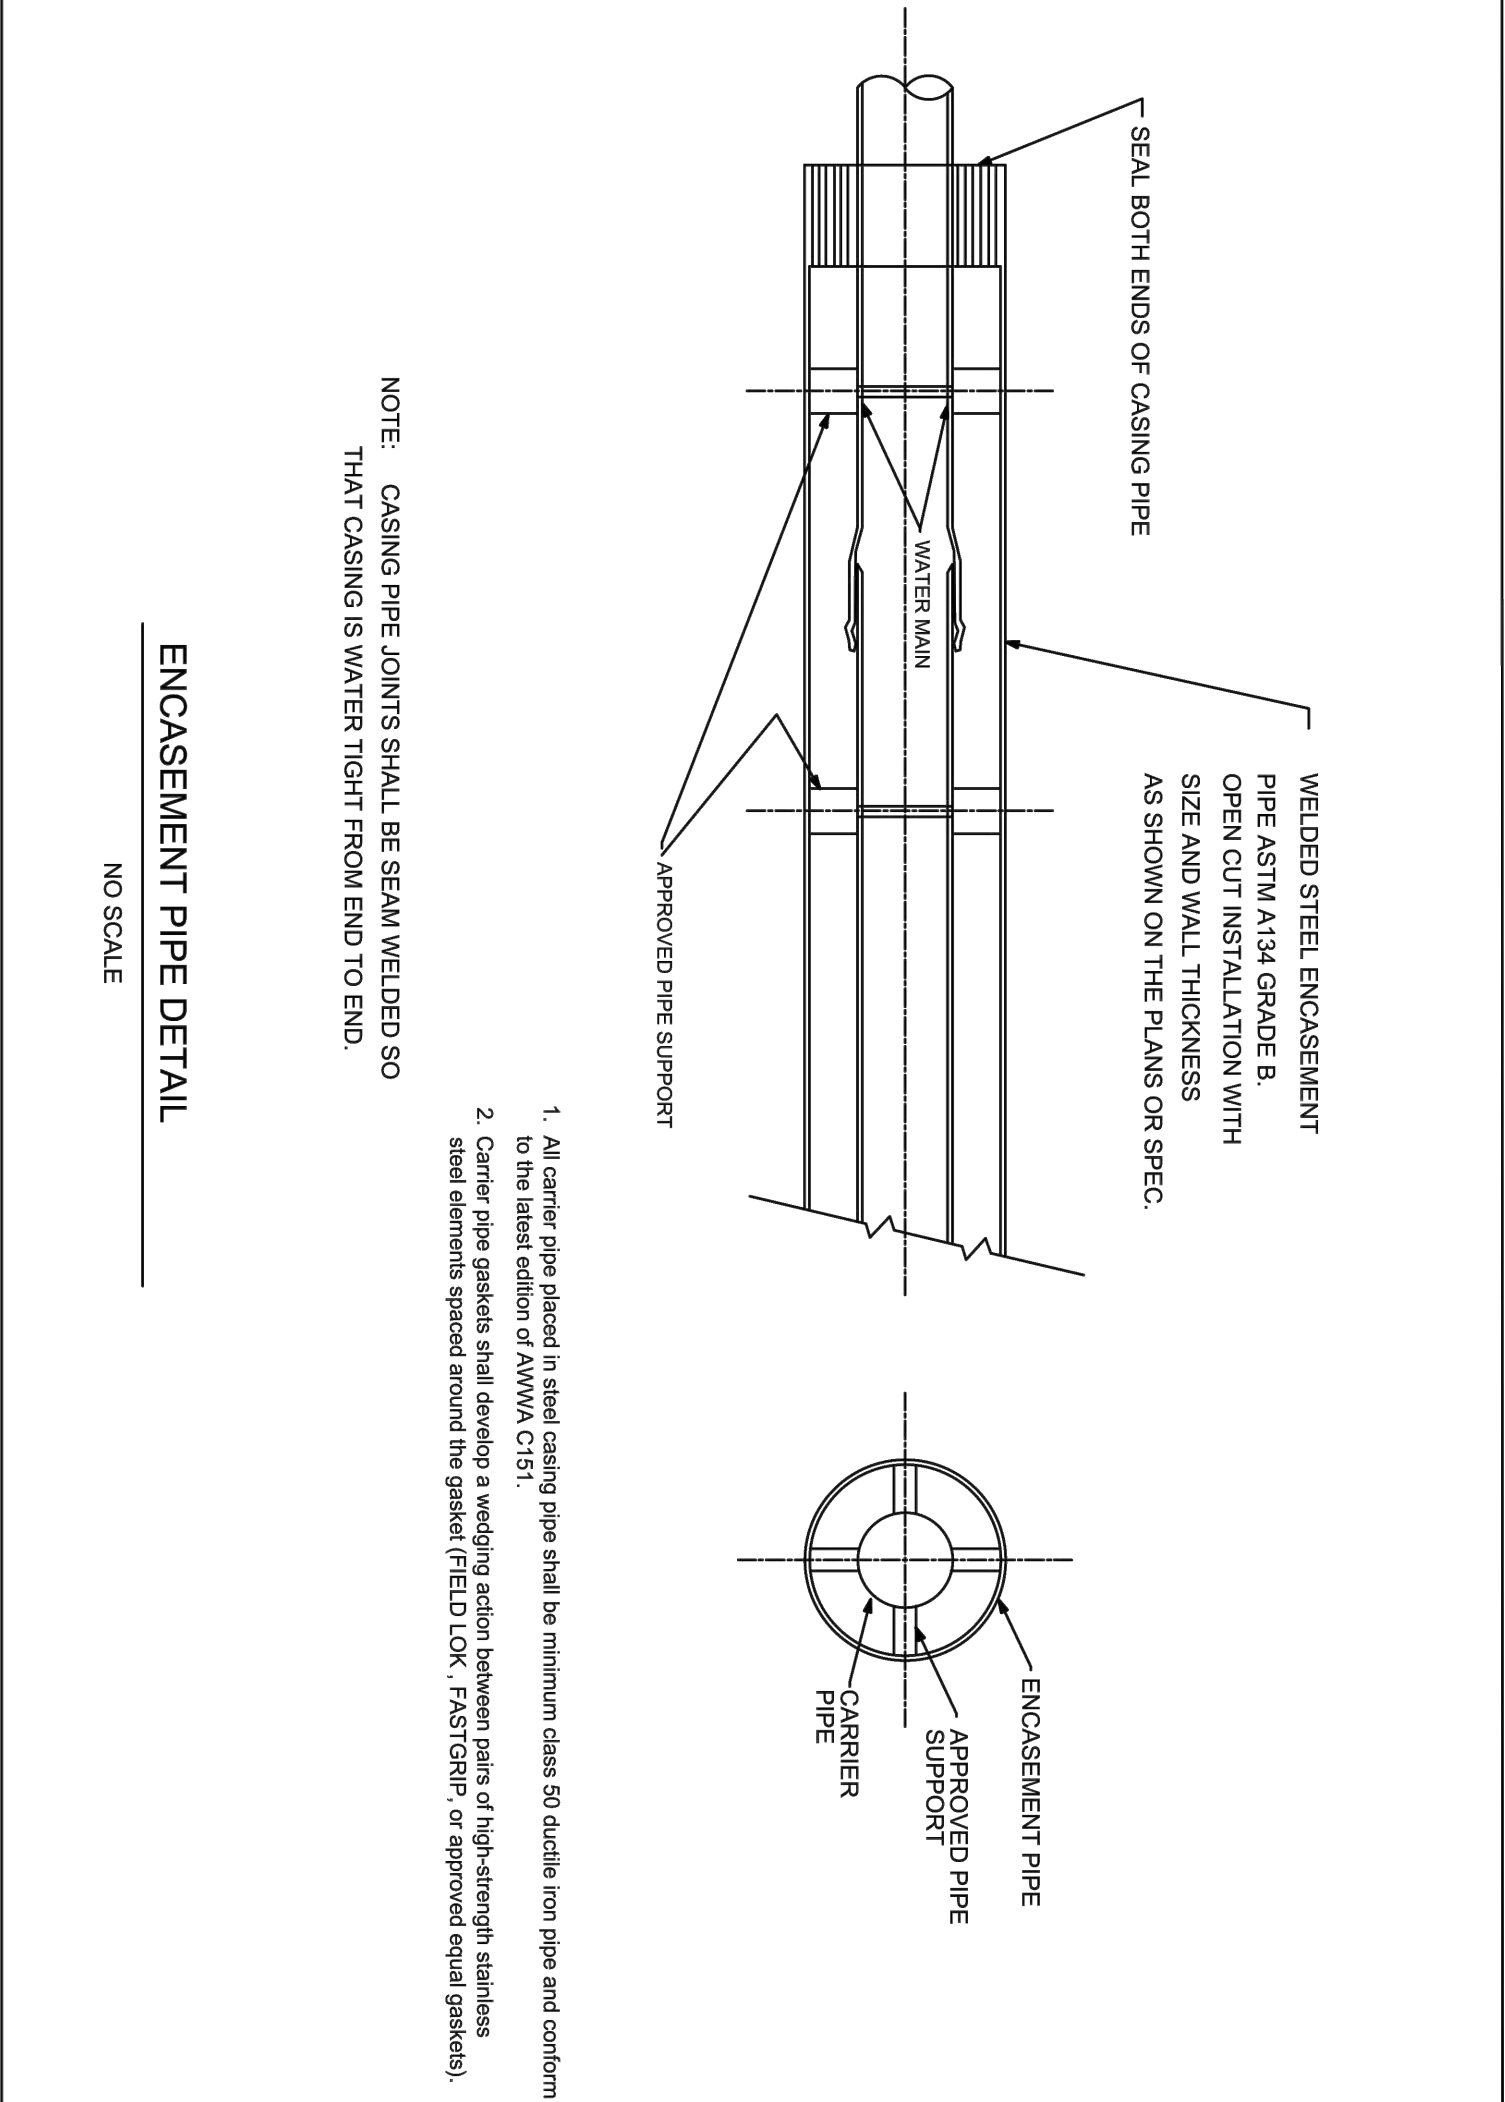

REVISION	BY	DATE
1. Revision: General Per. E.R.		
N. KY. WATER DISTRICT ENCASEMENT PIPE DETAIL		
DRAWN BY: SAR	APPROVED: MH	DATE: 8/3/2014
STANDARD DRAWING NO 114		

1. CONCRETE KEY BLOCKS SHALL BE 12" X 12" X 12" IN SIZE AND SHALL BE CAST IN PLACE. THE KEY BLOCKS SHALL BE CAST IN PLACE AND SHALL BE CAST IN PLACE AND SHALL BE CAST IN PLACE.

2. THE KEY BLOCKS SHALL BE CAST IN PLACE AND SHALL BE CAST IN PLACE AND SHALL BE CAST IN PLACE.

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9. THE KEY BLOCKS SHALL BE CAST IN PLACE AND SHALL BE CAST IN PLACE AND SHALL BE CAST IN PLACE.

NORTHERN KENTUCKY WATER DISTRICT
SUBDISTRICT 'O'
-KENTON COUNTY -

PROJECT NO.
231591

DISCIPLINE
CIVIL

SHEET NAME
G-04


SHEET
OF

5
28

ISSUED FOR:	BID	NO	REVISION	DATE
ISSUE DATE:	APRIL 2025			
SCALE:	AS SHOWN			
DESIGNED BY:	JCOR			
DRAWN BY:	JCOR			
CHECKED BY:	JSHU			

verdantas

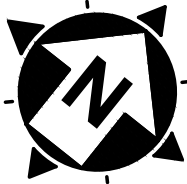2161 CHAMBER CENTER DRIVE
FORT MITCHELL, KENTUCKY 41017
TEL. (859) 525-0544
WWW.VERDANTAS.COM



0'
30'
60'
SCALE: 1" = 30'

CONSTRUCTION NOTES

- 1 MAINTAIN MANAGEABLE VERTICAL CLEARANCE BETWEEN THE PROPOSED WATER MAIN AND THE EXISTING STORM SEWER, WATER MAIN, TELEPHONE DUCTS, AND GAS MAIN. CONSTRUCT ALL SANITARY SEWER CROSSINGS PER N.K.W.D. SPECIFICATIONS. MAINTAIN MINIMUM 10' BETWEEN THE PROPOSED WATER MAIN AND EXISTING SANITARY SEWER. ACTUAL ELEVATION UNKNOWN. CONTRACTOR TO EXCAVATE & VERIFY ACTUAL LOCATION, SIZE AND ELEVATION OF EXISTING UTILITY PRIOR TO BEGINNING WATER MAIN CONSTRUCTION. THE CONTRACTOR SHALL NOTIFY THE ENGINEER PRIOR TO CONSTRUCTION OF ANY POTENTIAL CONFLICT. NO CONSTRUCTION SHALL BE UNDERTAKEN ON THIS WORK AND THE COST SHALL BE INCLUDED IN THE BID ITEM FOR WATER MAIN.
- 2 PROPOSED FIRE HYDRANT ASSEMBLY, VALVE AND BLOCKING AS PER N.K.W.D. STD. DRAWING NO. 109, COORDINATE LOCATION WITH N.K.W.D. INSPECTOR, ANCHOR VALVE TO TEE.
- 3 CONNECT TO EXISTING WATER MAIN (ACTUAL ELEVATION UNKNOWN). CONTRACTOR TO VERIFY DEPTH PRIOR TO CONSTRUCTION.
- 4 CHANNEL LINING CLASS II (C7) w/ NON-WOVEN GEOTEXTILE FILTER FABRIC.
- 5 CONTRACTOR TO VERIFY LOCATION AND ELEVATION OF UTILITY PRIOR TO EXCAVATION ACTIVITY AND NOTIFY ENGINEER AND N.K.W.D. OF CONFLICTS. (** SEE NOTE)
- 6 DO NOT DISTURB
- 7 CONTRACTOR TO SUPPORT UTILITY POLE DURING PIPE INSTALLATION. (** SEE NOTE)
- 8 REMOVE AND REPLACE SIGN. (** SEE NOTE)
- 9 REMOVE AND REPLACE MAILBOX. (** SEE NOTE)
- 10 INSTALL 58" METER SETTING PER NAKWD STD. DWG. NO. 108. CONTRACTOR TO VERIFY LOCATION AND ELEVATION OF EXISTING UTILITY PRIOR TO EXCAVATION ACTIVITY AND NOTIFY ENGINEER AND N.K.W.D. OF CONFLICTS. (** SEE NOTE)
- 11 REMOVE & REPLACE STORM STRUCTURE (C8 HM) AS NEEDED FOR WATER MAIN INSTALLATION. (** SEE NOTE)
- 12 DRIVEWAY RESTORATION (SEE DETAILS)
- 13 TREE TO BE REMOVED

** NOTE:

WORK FOR THIS ITEM SHALL BE CONSIDERED COMPLETED WHEN THE PROPOSED WATER MAIN IS INSTALLED. ADDITIONAL PAYMENT SHALL BE MADE FOR THIS WORK COST SHALL BE INCLUDED IN THE BID ITEM FOR WATER MAIN.

HATCH LEGEND

1-1/2" ASPHALT PAVEMENT MILL AND OVERLAY AREA

TRENCH RESTORATION - ASPHALT PAVEMENT - SEE DETAIL SHEET

TRENCH RESTORATION - CONCRETE PAVEMENT - SEE DETAIL SHEET

TRENCH RESTORATION - 8" AGGREGATE PAVEMENT

CONTROL DENSITY FILL - PAVT TRENCH

CONCRETE DRIVEWAY REPLACEMENT - SEE DETAIL SHEET

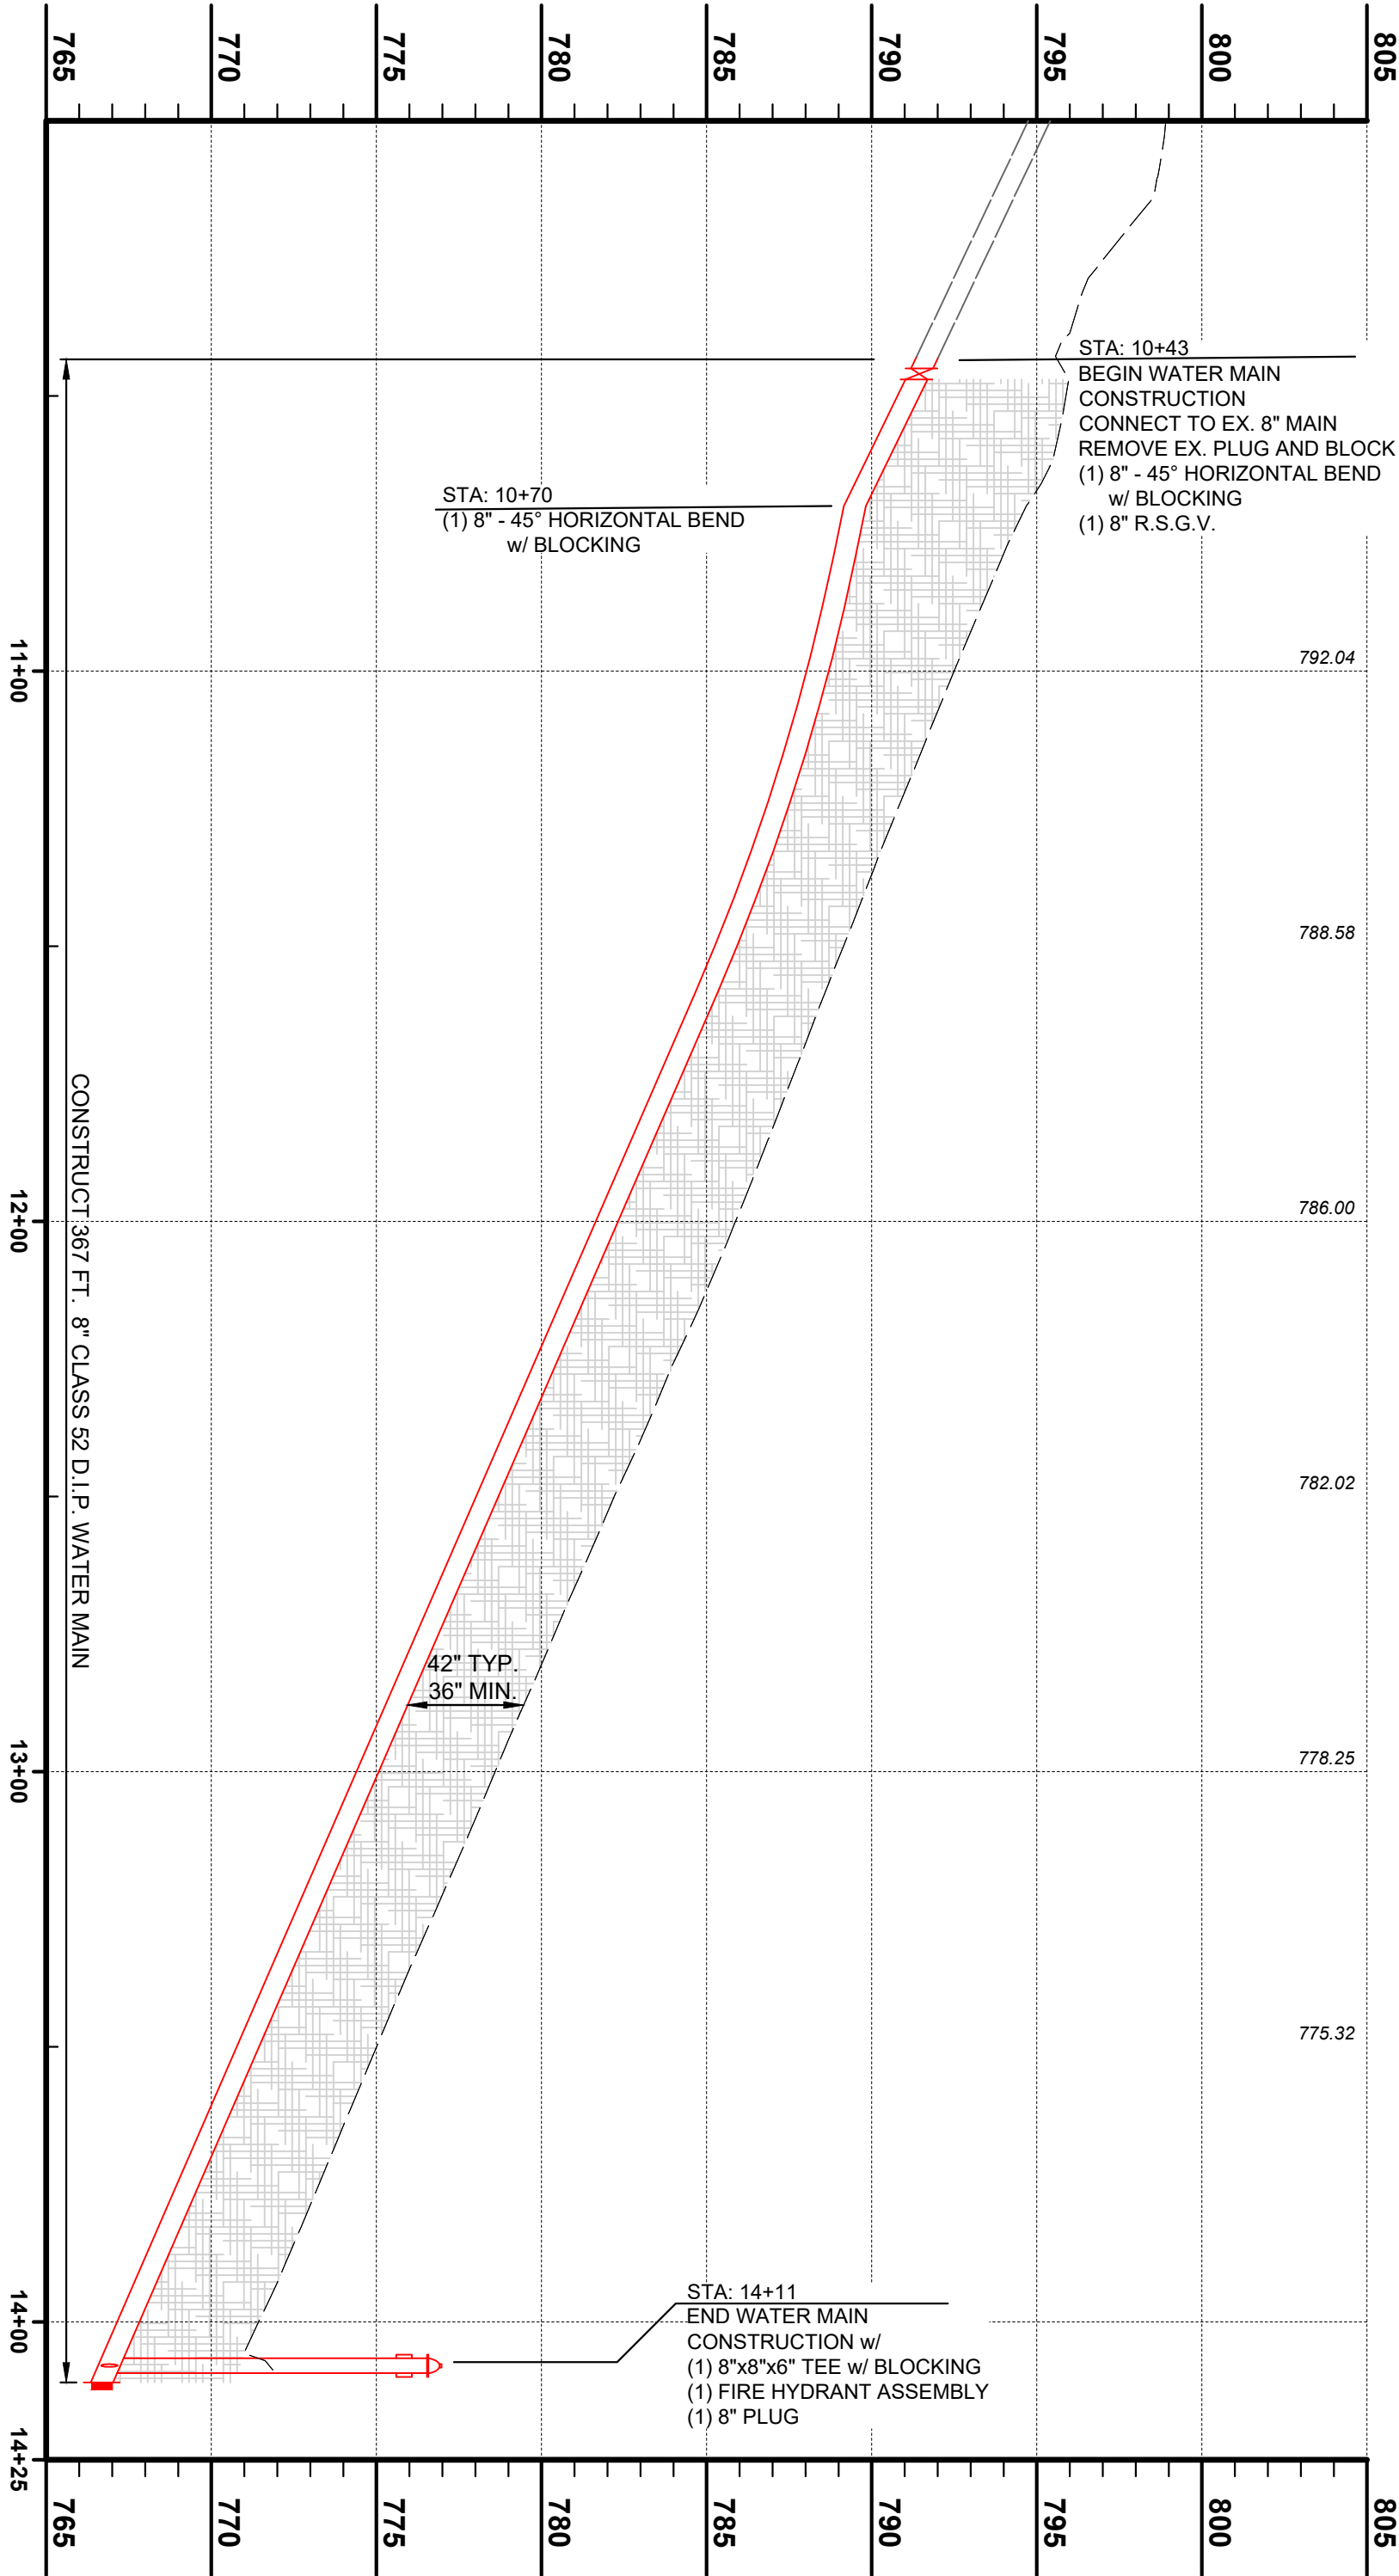
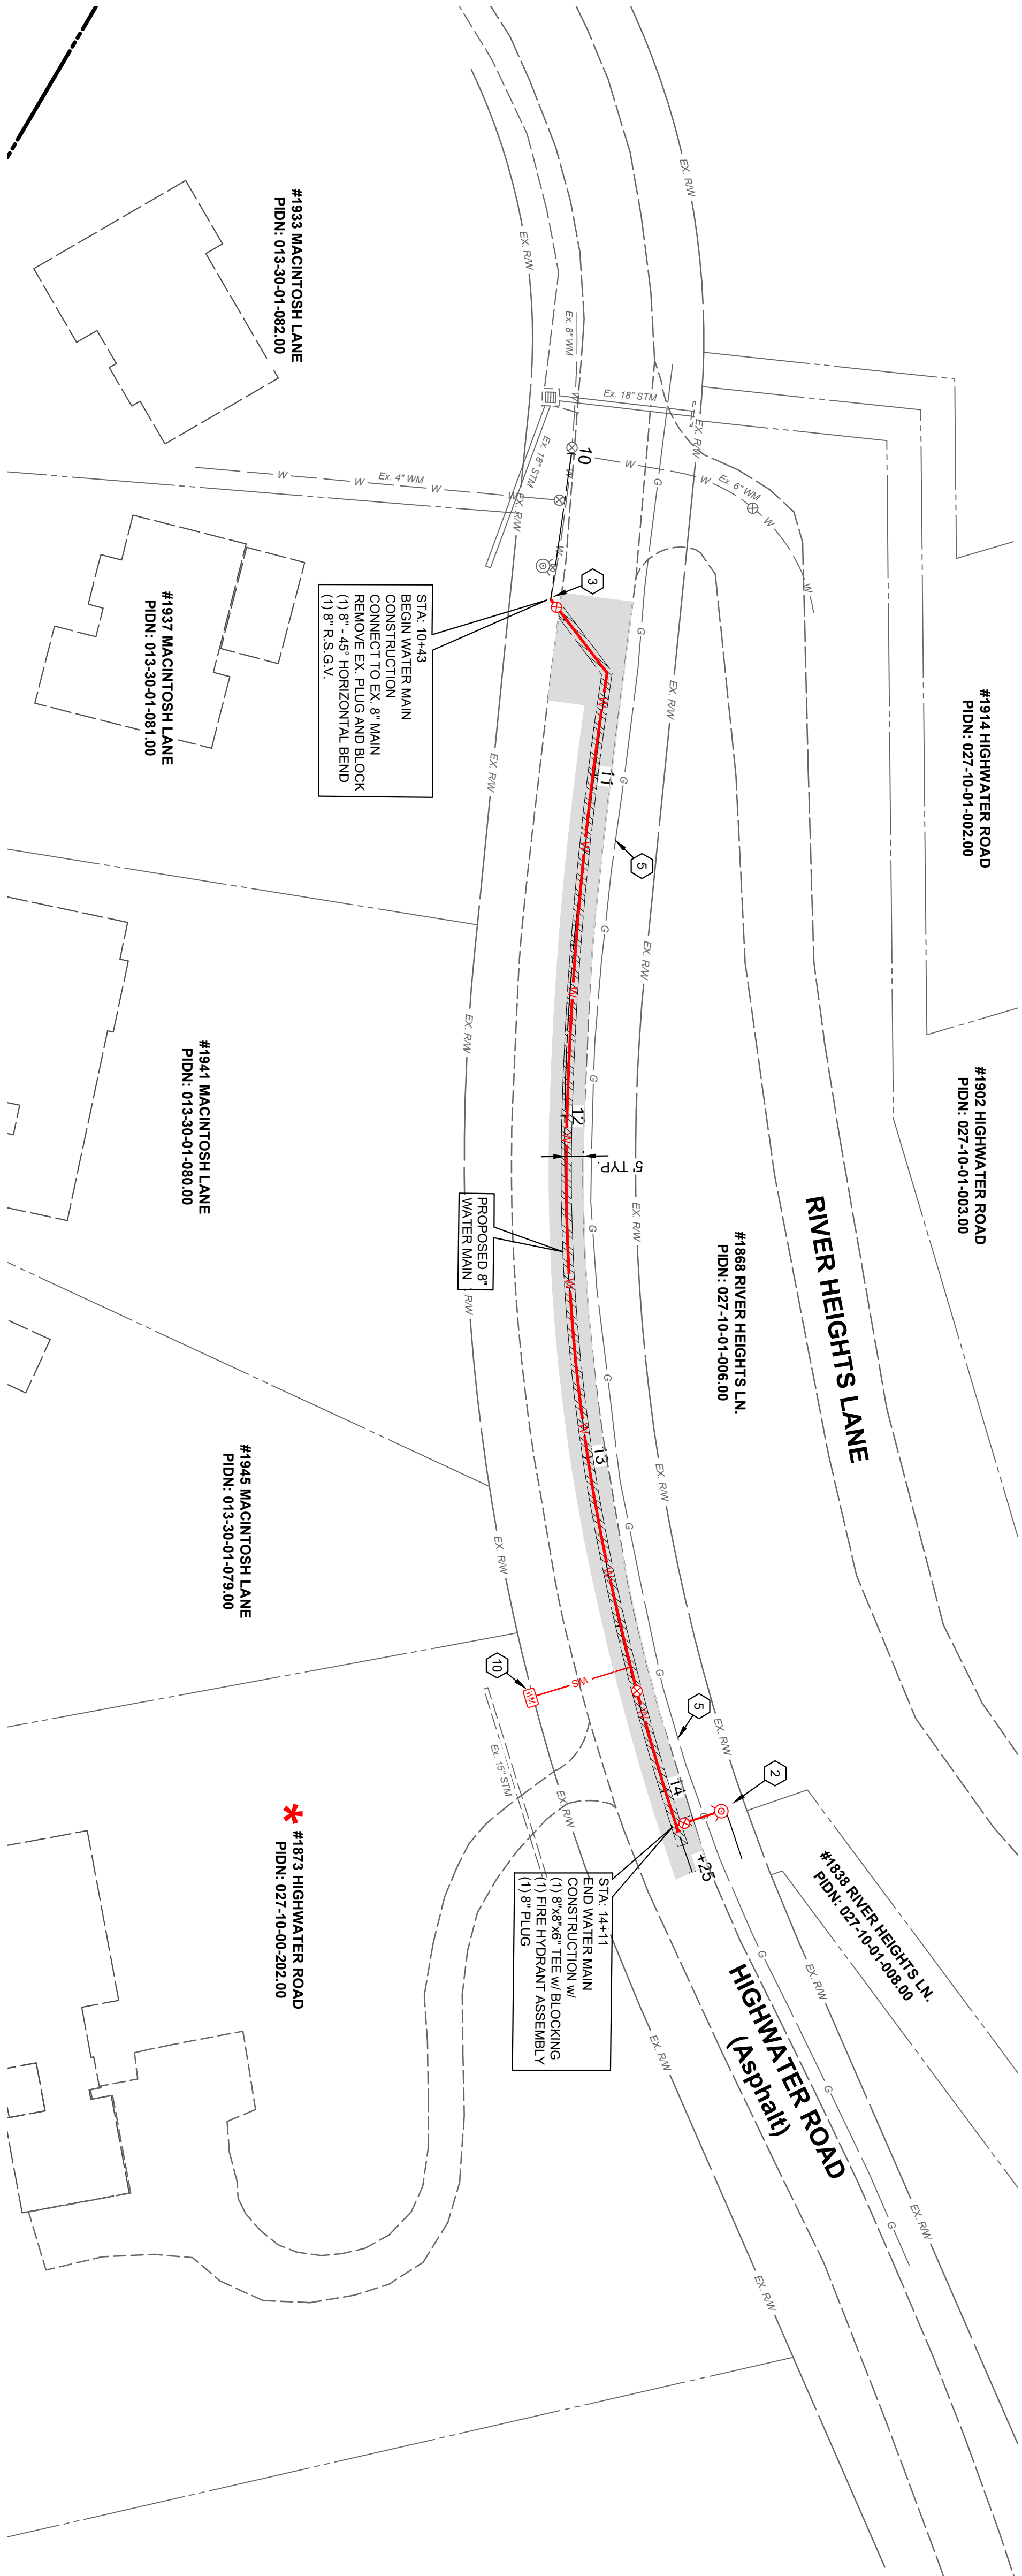
CONCRETE WALK REPLACEMENT - SEE DETAIL SHEET

ASPHALT DRIVEWAY REPLACEMENT - SEE DETAIL SHEET

GRAVEL DRIVEWAY REPLACEMENT - SEE DETAIL SHEET

CHANNEL LINING CLASS II - SEE DETAIL SHEET

* DENOTES PROPERTY WITH NEW SERVICE AND METER SETTING



SCALE:
H: 1" = 50'
V: 1" = 5'






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TEL. (859) 525-0544
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NORTHERN KENTUCKY WATER DISTRICT
SUBDISTRICT 'O'
-KENTON COUNTY -

HIGHWATER ROAD

DATE	REVISION	NO	BID	ISSUED FOR:
				APRIL 2025
				AS SHOWN
			JCOR	DESIGNED BY:
			JCOR	DRAWN BY:
			JSHU	CHECKED BY:

PROJECT NO.	231591
DISCIPLINE	CIVIL
SHEET NAME	C-01
SHEET	8
OF	28

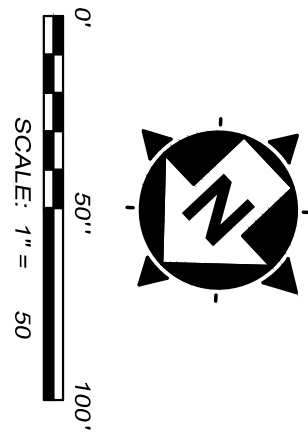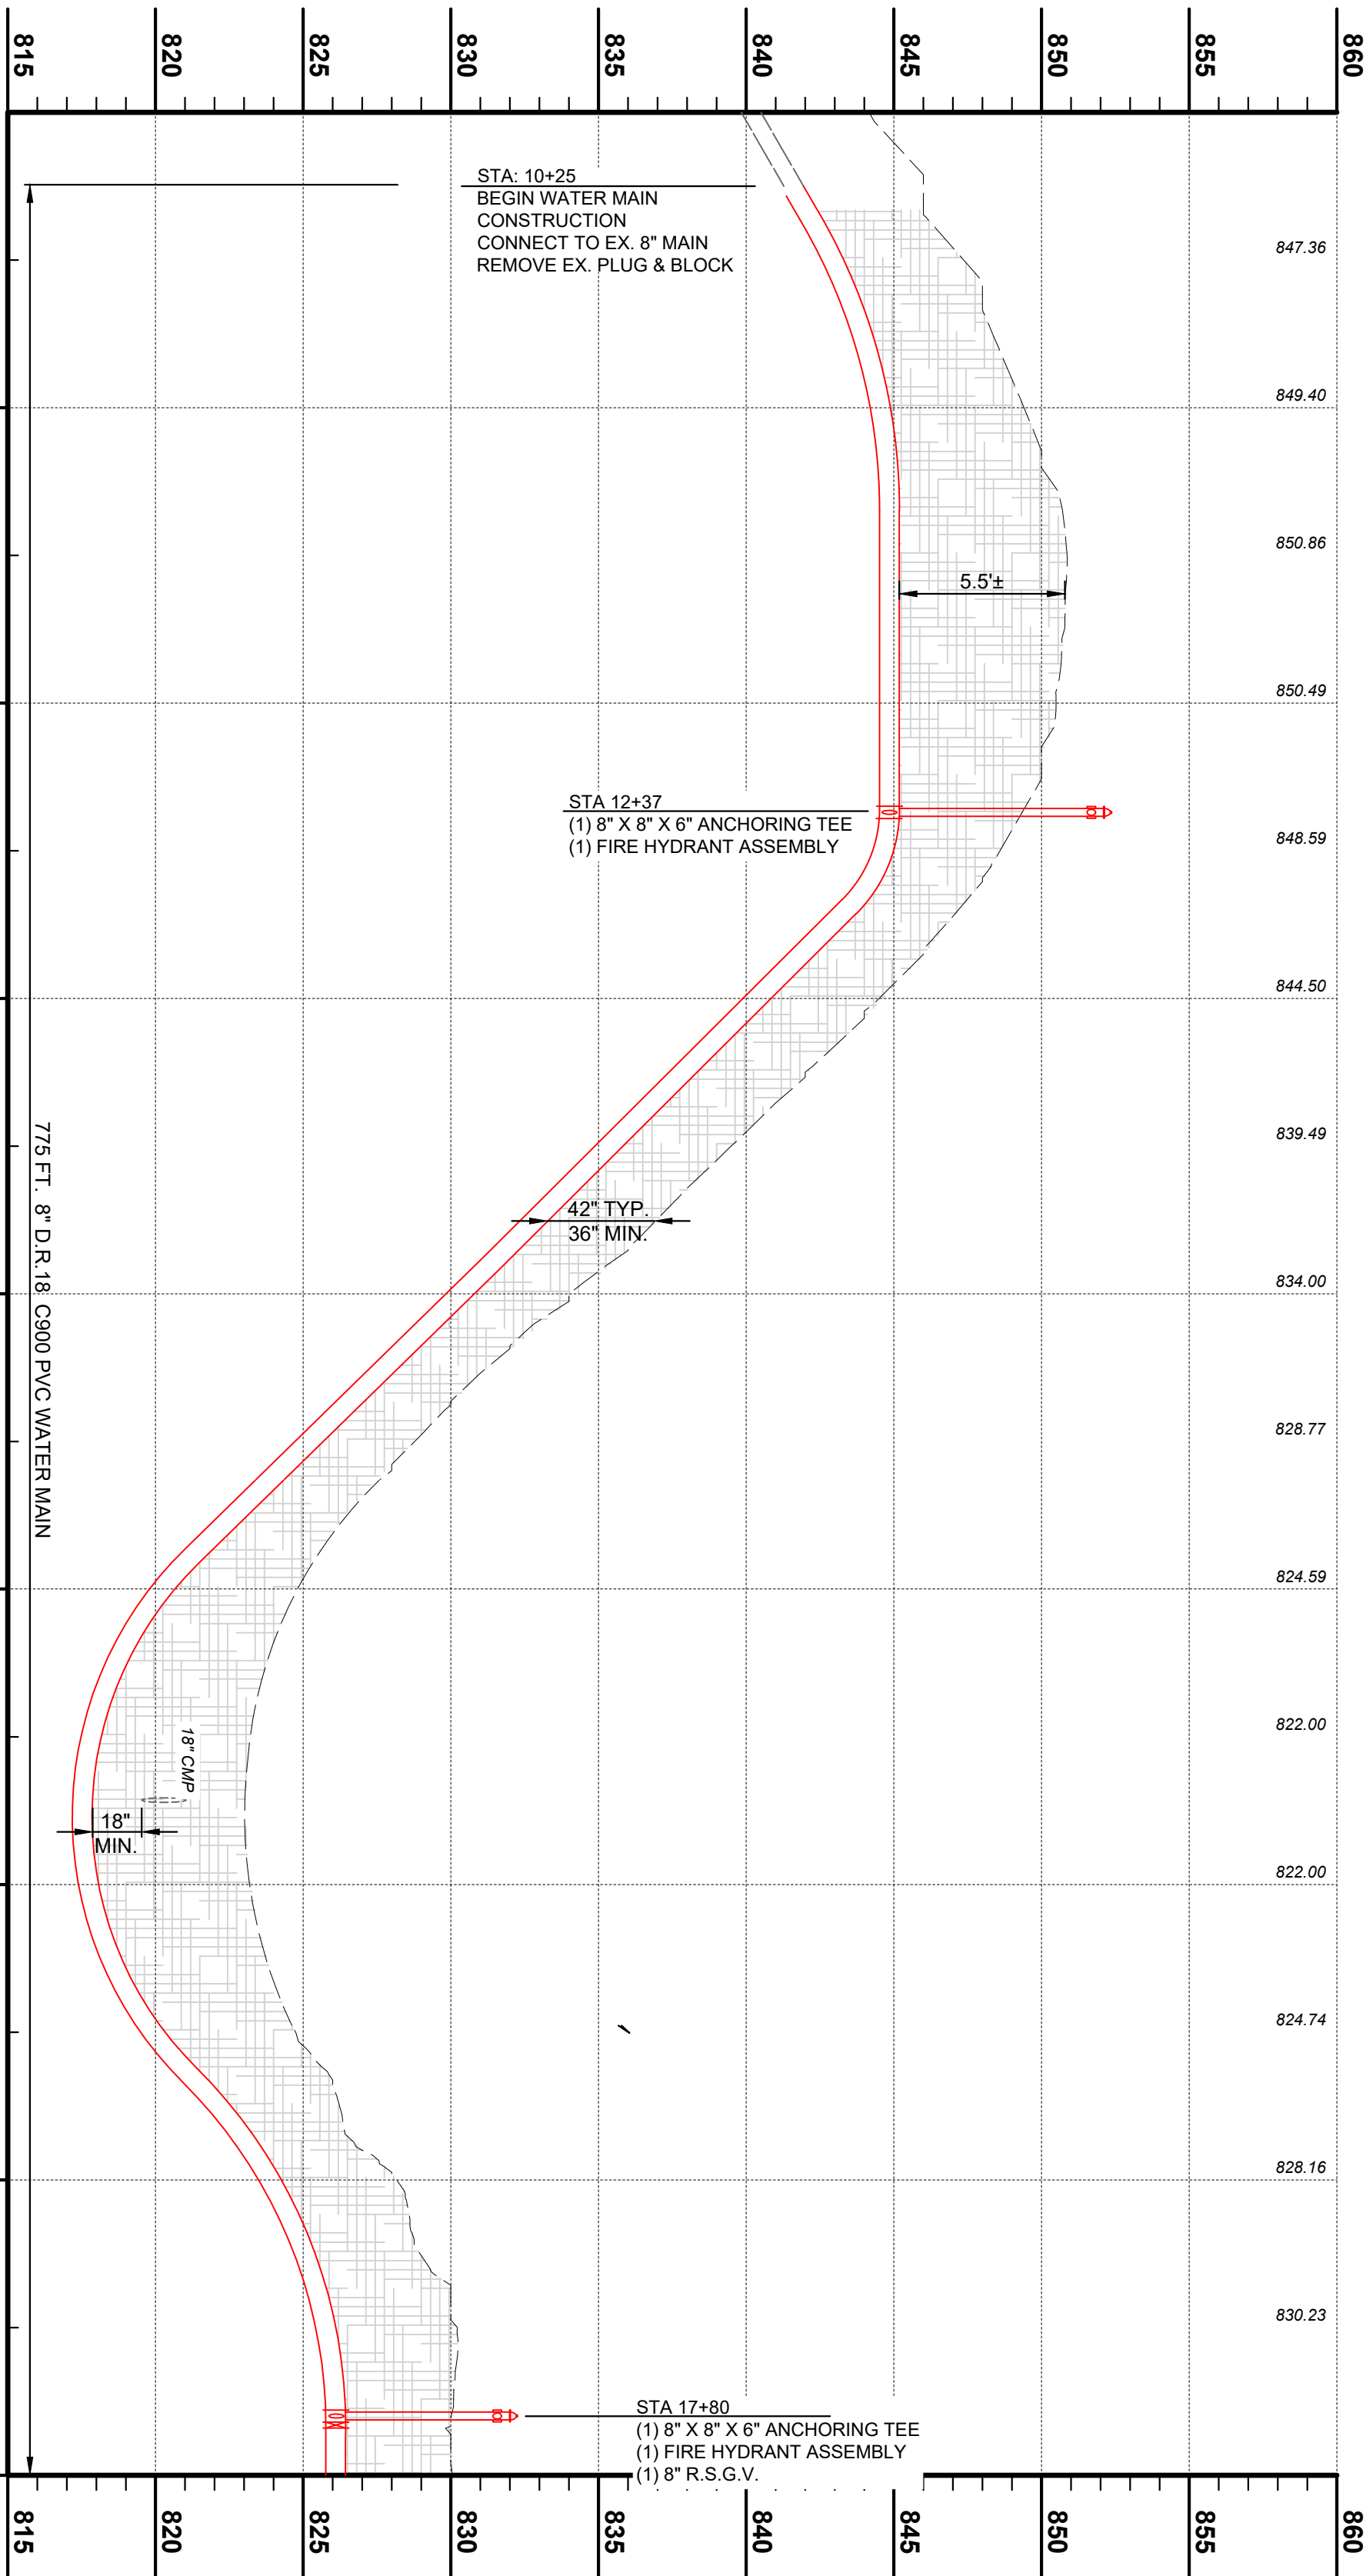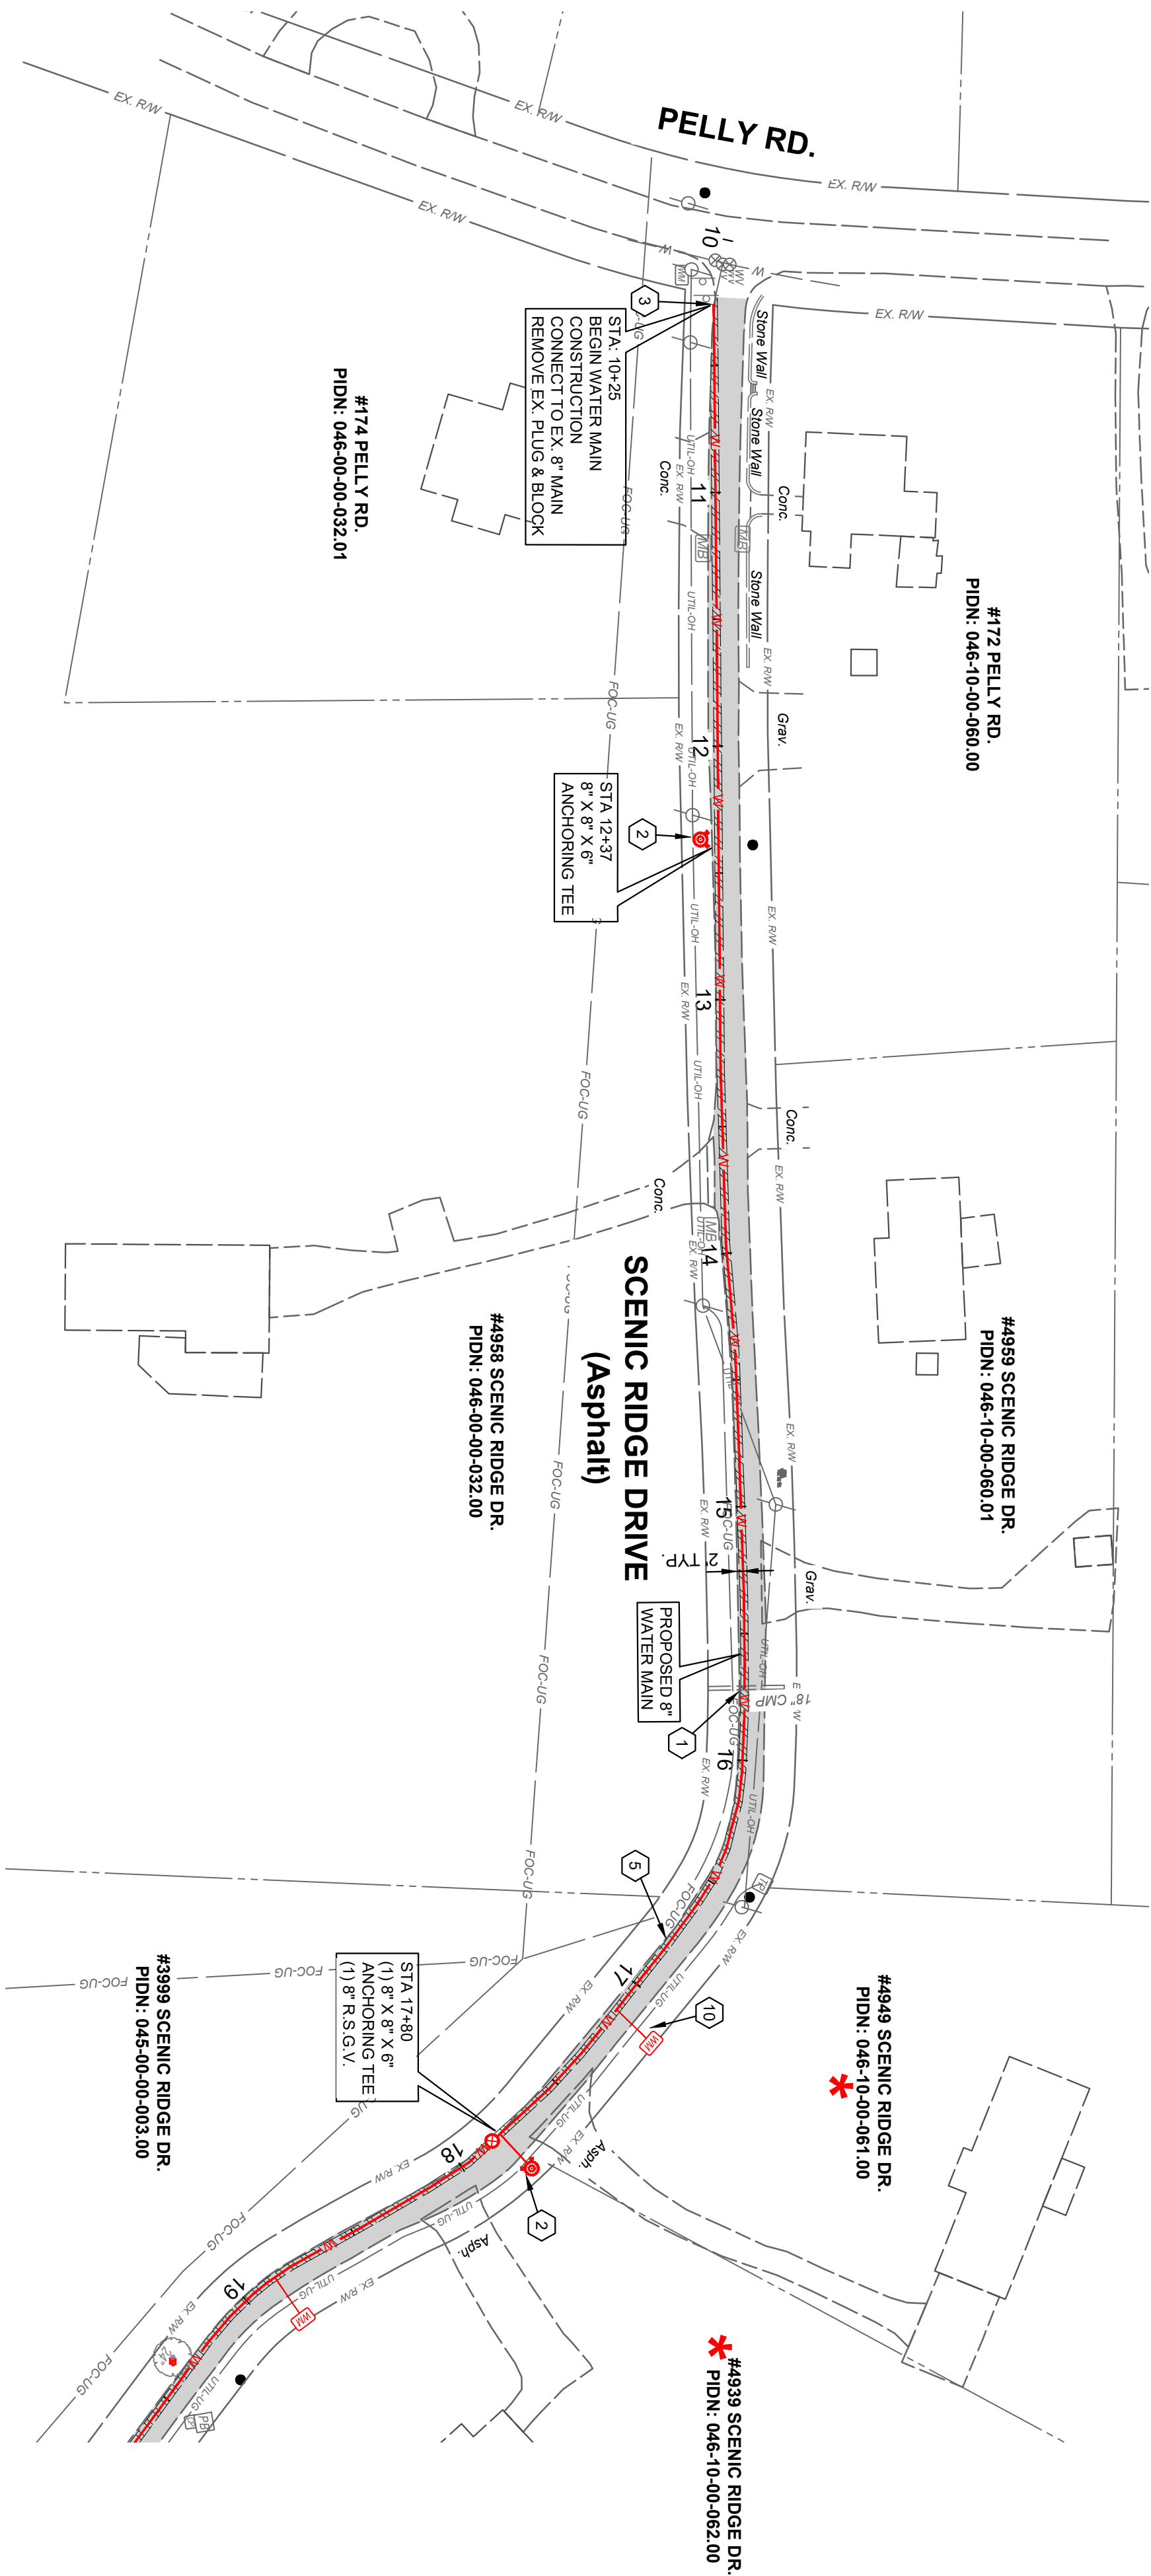

CONSTRUCTION NOTES

1. MAINTAIN MANAGEABLE VERTICAL CLEARANCE BETWEEN THE PROPOSED WATER MAIN AND THE EXISTING STORM SEWER, WATER MAIN, TELEPHONE AND CABLE LINES. MAINTAIN A MINIMUM 18\"/>
2. PROPOSED FIRE HYDRANT ASSEMBLY, VALVE AND ANCHOR VALVE TO TEE. COORDINATE LOCATION WITH N.K.W.D. INSPECTOR.
3. CONNECT TO EXISTING WATER MAIN (ACTUAL ELEVATION UNKNOWN). CONTRACTOR TO VERIFY DEPTH PRIOR TO CONSTRUCTION.
4. CHANNEL LINING, CLASS II (18\"/>
5. CONTRACTOR TO VERIFY LOCATION AND ELEVATION OF UTILITY PRIOR TO EXCAVATION ACTIVITY AND NOTIFY ENGINEER AND N.K.W.D. OF CONFLICTS. (** SEE NOTE)
6. DO NOT DISTURB
7. CONTRACTOR TO SUPPORT UTILITY POLE DURING PIPE INSTALLATION. (** SEE NOTE)
8. REMOVE AND REPLACE SIGN. (** SEE NOTE)
9. REMOVE AND REPLACE MAILBOX. (** SEE NOTE)
10. INSTALL 5/8\"/>
11. REMOVE & REPLACE STORM STRUCTURE (CB, HW) AS NEEDED FOR WATER MAIN INSTALLATION. (** SEE NOTE)
12. DRIVEWAY RESTORATION (SEE DETAILS)
13. TREE TO BE REMOVED

NOTE:

WORK FOR THIS ITEM SHALL BE CONSIDERED INCIDENTAL TO THE OVERALL PROJECT AND NO ADDITIONAL PAYMENT SHALL BE MADE FOR THIS WORK. COST SHALL BE INCLUDED IN THE BID ITEM FOR WATER MAIN.

HATCH LEGEND

- 1-1/2\"/>
- TRENCH RESTORATION - ASPHALT PAVEMENT - SEE DETAIL SHEET
- TRENCH RESTORATION - CONCRETE PAVEMENT - SEE DETAIL SHEET
- TRENCH RESTORATION - 8\"/>
- CONTROL DENSITY FILL - PAVT TRENCH
- CONCRETE DRIVEWAY REPLACEMENT - SEE DETAIL SHEET
- CONCRETE WALK REPLACEMENT - SEE DETAIL SHEET
- ASPHALT DRIVEWAY REPLACEMENT - SEE DETAIL SHEET
- GRAVEL DRIVEWAY REPLACEMENT - SEE DETAIL SHEET
- CHANNEL LINING, CLASS II - SEE DETAIL SHEET
- * DENOTES PROPERTY WITH NEW SERVICE AND METER SETTING





2161 CHAMBER CENTER DRIVE
FORT MITCHELL, KENTUCKY 41017
TEL. (859) 525-0544
WWW.VERDANTAS.COM

NORTHERN KENTUCKY WATER DISTRICT
SUBDISTRICT 'O'
-KENTON COUNTY -

SCENIC RIDGE DRIVE
STA. 10+25 TO STA. 18+00

DATE	REVISION	NO	BID	ISSUED FOR:
			APRIL 2025	ISSUE DATE:
			AS SHOWN	SCALE:
			JCOR	DESIGNED BY:
			JCOR	DRAWN BY:
			JSHU	CHECKED BY:

PROJECT NO.	231591
DISCIPLINE	CIVIL
SHEET NAME	C-02
SHEET	9
OF	28

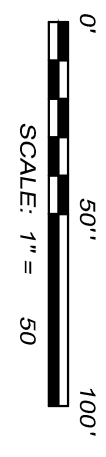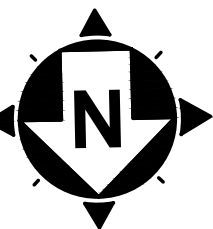

CONSTRUCTION NOTES

- 1) MAINTAIN MANAGEABLE VERTICAL CLEARANCE BETWEEN THE PROPOSED WATER MAIN AND THE EXISTING STORM SEWER, WATER MAIN, TELEPHONE DUCTS, AND OTHER UTILITIES. MAINTAIN MINIMUM 18" BETWEEN THE PROPOSED WATER MAIN AND THE EXISTING SANITARY SEWER. ACTUAL ELEVATION UNKNOWN. CONTRACTOR TO EXCAVATE & VERIFY ACTUAL LOCATION, SIZE AND ELEVATION OF EXISTING UTILITY PRIOR TO BEGINNING CONSTRUCTION OF ANY POTENTIAL CONFLICT. NO ADDITIONAL PAYMENT WILL BE MADE FOR THIS WORK AND THE COST SHALL BE INCLUDED IN THE BID ITEM FOR WATER MAIN.
- 2) PROPOSED FIRE HYDRANT ASSEMBLY, VALVE AND ANCHORING TEE SHALL BE CONSTRUCTED AT THE COORDINATE LOCATION WITH N.K.W.D. INSPECTOR. ANCHOR VALVE TO TEE.
- 3) CONNECT TO EXISTING WATER MAIN (ACTUAL ELEVATION UNKNOWN). CONTRACTOR TO VERIFY DEPTH PRIOR TO CONSTRUCTION.
- 4) CHANNEL LINING, CLASS II (18") W/ NON-WOVEN GEOTEXTILE FILTER FABRIC
- 5) CONTRACTOR TO VERIFY LOCATION AND ELEVATION OF UTILITY PRIOR TO EXCAVATION ACTIVITY AND NOTIFY ENGINEER AND N.K.W.D. OF CONFLICTS. (** SEE NOTE)
- 6) DO NOT DISTURB
- 7) CONTRACTOR TO SUPPORT UTILITY POLE DURING PIPE INSTALLATION. (** SEE NOTE)
- 8) REMOVE AND REPLACE SIGN. (** SEE NOTE)
- 9) REMOVE AND REPLACE MAILBOX. (** SEE NOTE)
- 10) INSTALL 56" METER SETTING PER N.K.W.D. STD. DWG. NO. 107. INSTALL WATER SERVICE LINE 1/4" TYPE K COPPER) FROM THE PROPOSED WATER MAIN TO THE METER SETTING. MATERIAL WILL BE PROVIDED BY N.K.W.D. FOR THIS WORK. UNIT PRICE INCLUDED LABOR, EQUIPMENT, EXCAVATION, BEDDING, BACKFILL, AND FINISH. CONTRACTOR TO VERIFY LOCATION AND ELEVATION OF EXISTING UTILITY PRIOR TO INSTALL SERVICE LINE AS SHOWN ON PLANS OR DIRECTED BY N.K.W.D. IN ACCORDANCE WITH SPECS & STD. DWGS., COMPLETE.
- 11) REMOVE & REPLACE STORM STRUCTURE (CB, HW) AS NEEDED FOR WATER MAIN INSTALLATION. (** SEE NOTE)
- 12) DRIVEWAY RESTORATION (SEE DETAIL)
- 13) TREE TO BE REMOVED

NOTE:

WORK FOR THIS ITEM SHALL BE CONSIDERED INCIDENTAL TO THE OVERALL PROJECT AND NO ADDITIONAL PAYMENT SHALL BE MADE FOR THIS WORK. COST SHALL BE INCLUDED IN THE BID ITEM FOR WATER MAIN.

HATCH LEGEND

- 1-1/2" ASPHALT PAVEMENT MILL AND OVERLAY AREA
- TRENCH RESTORATION - ASPHALT PAVEMENT - SEE DETAIL SHEET
- TRENCH RESTORATION - CONCRETE PAVEMENT - SEE DETAIL SHEET
- TRENCH RESTORATION - 8" AGGREGATE PAVEMENT
- CONTROL DENSITY FILL - PAVT TRENCH
- CONCRETE DRIVEWAY REPLACEMENT - SEE DETAIL SHEET
- CONCRETE WALK REPLACEMENT - SEE DETAIL SHEET
- ASPHALT DRIVEWAY REPLACEMENT - SEE DETAIL SHEET
- GRAVEL DRIVEWAY REPLACEMENT - SEE DETAIL SHEET
- CHANNEL LINING, CLASS II - SEE DETAIL SHEET
- DENOTES PROPERTY WITH NEW SERVICE AND METER SETTING

2161 CHAMBER CENTER DRIVE
FORT MITCHELL, KENTUCKY 41017
TEL. (859) 525-0544
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DATE	REVISION	NO	BID	ISSUED FOR:
			APRIL 2025	ISSUE DATE:
			AS SHOWN	SCALE:
			JCOR	DESIGNED BY:
			JCOR	DRAWN BY:
			JSHU	CHECKED BY:

NORTHERN KENTUCKY WATER DISTRICT
SUBDISTRICT 'O'
-KENTON COUNTY -

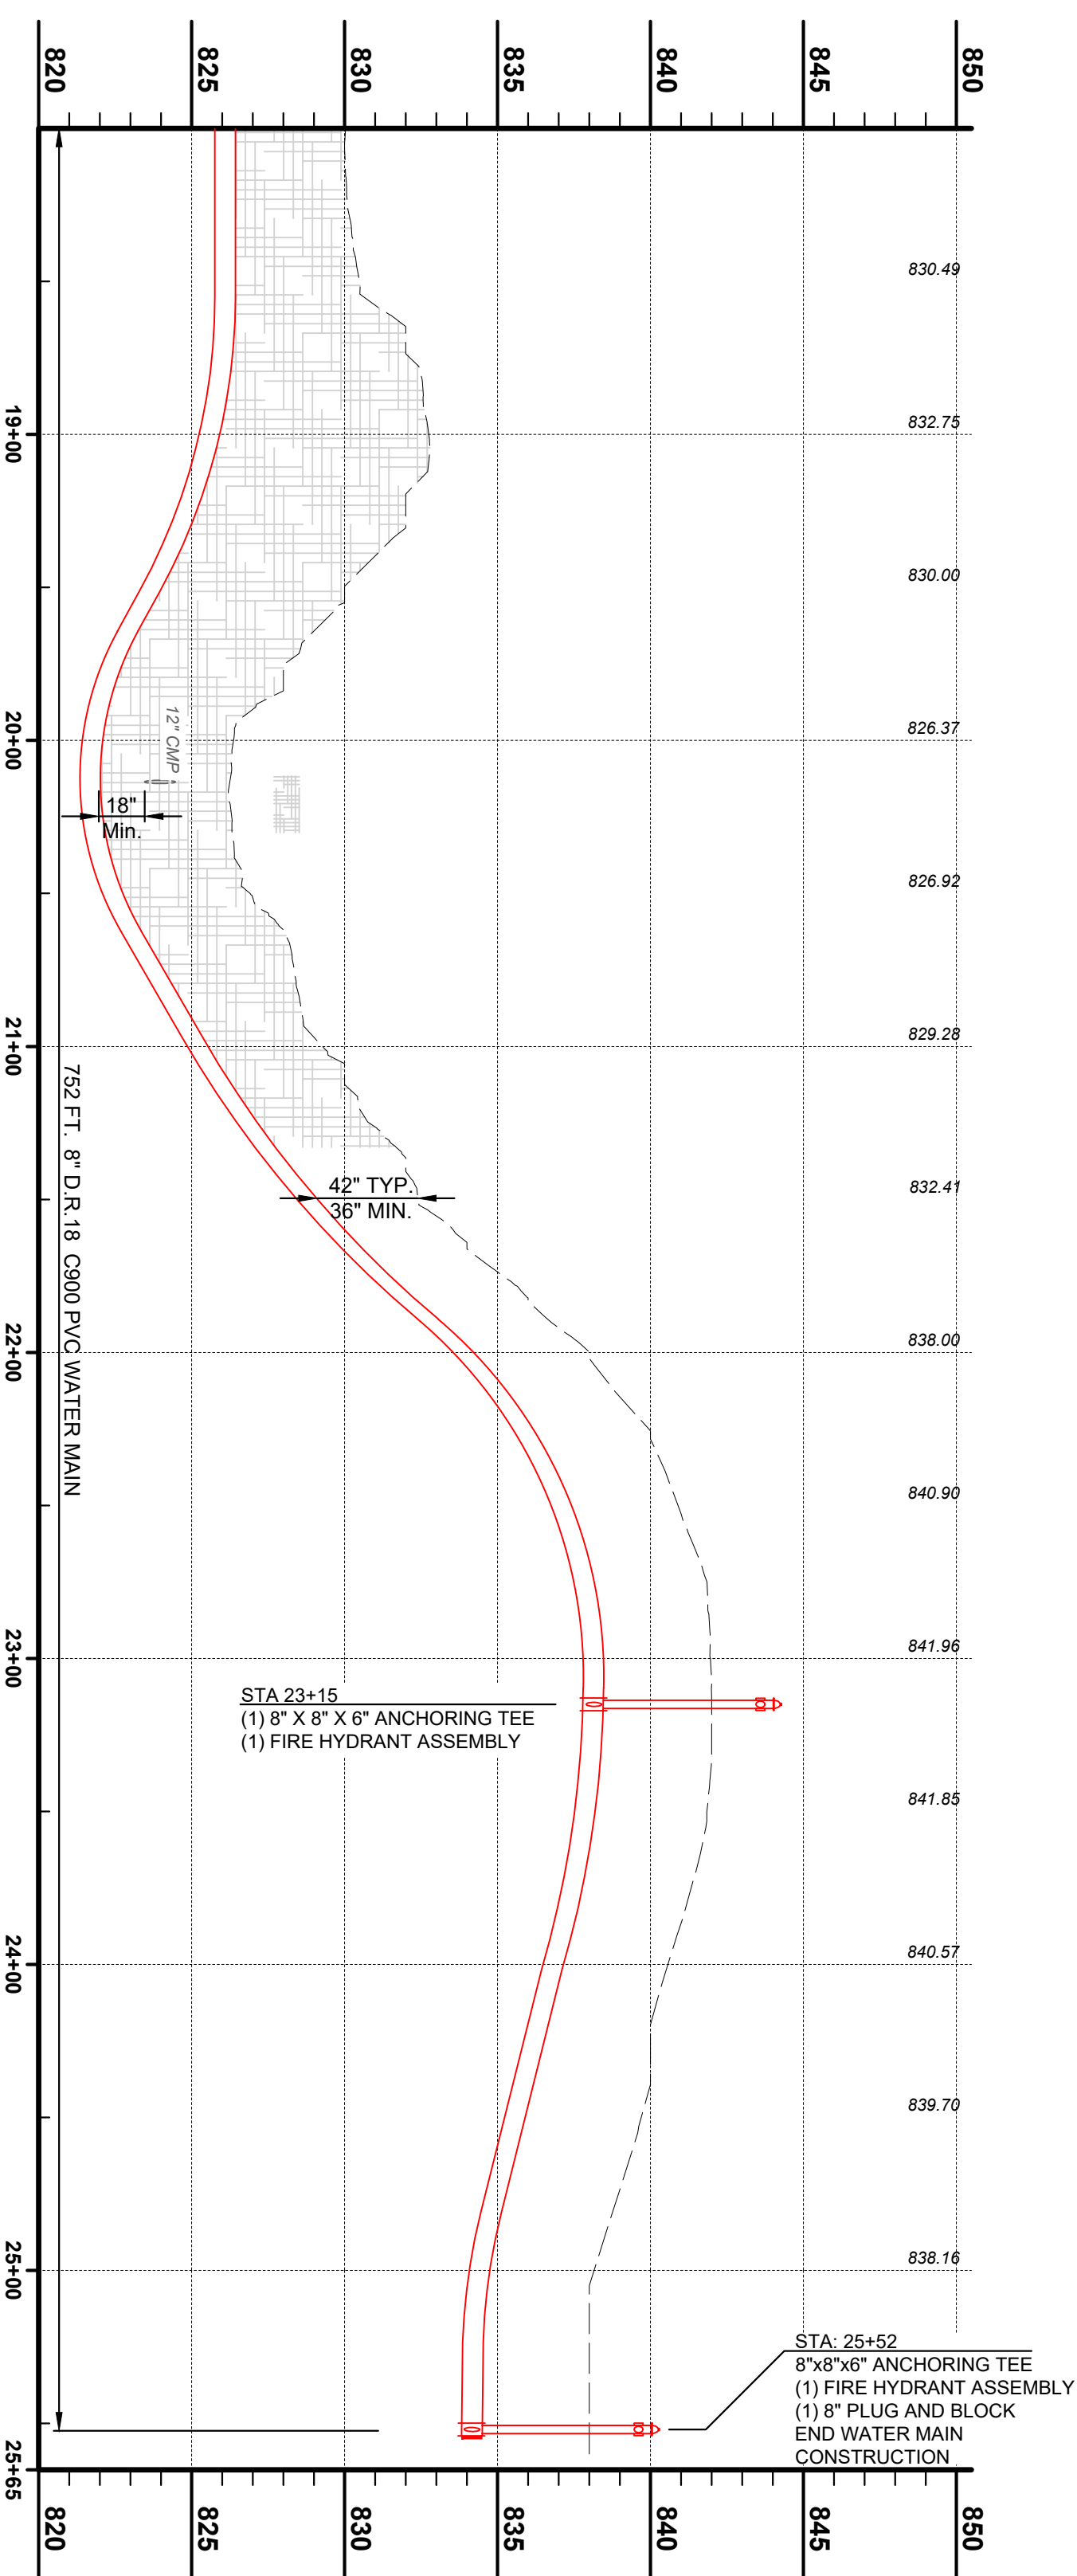
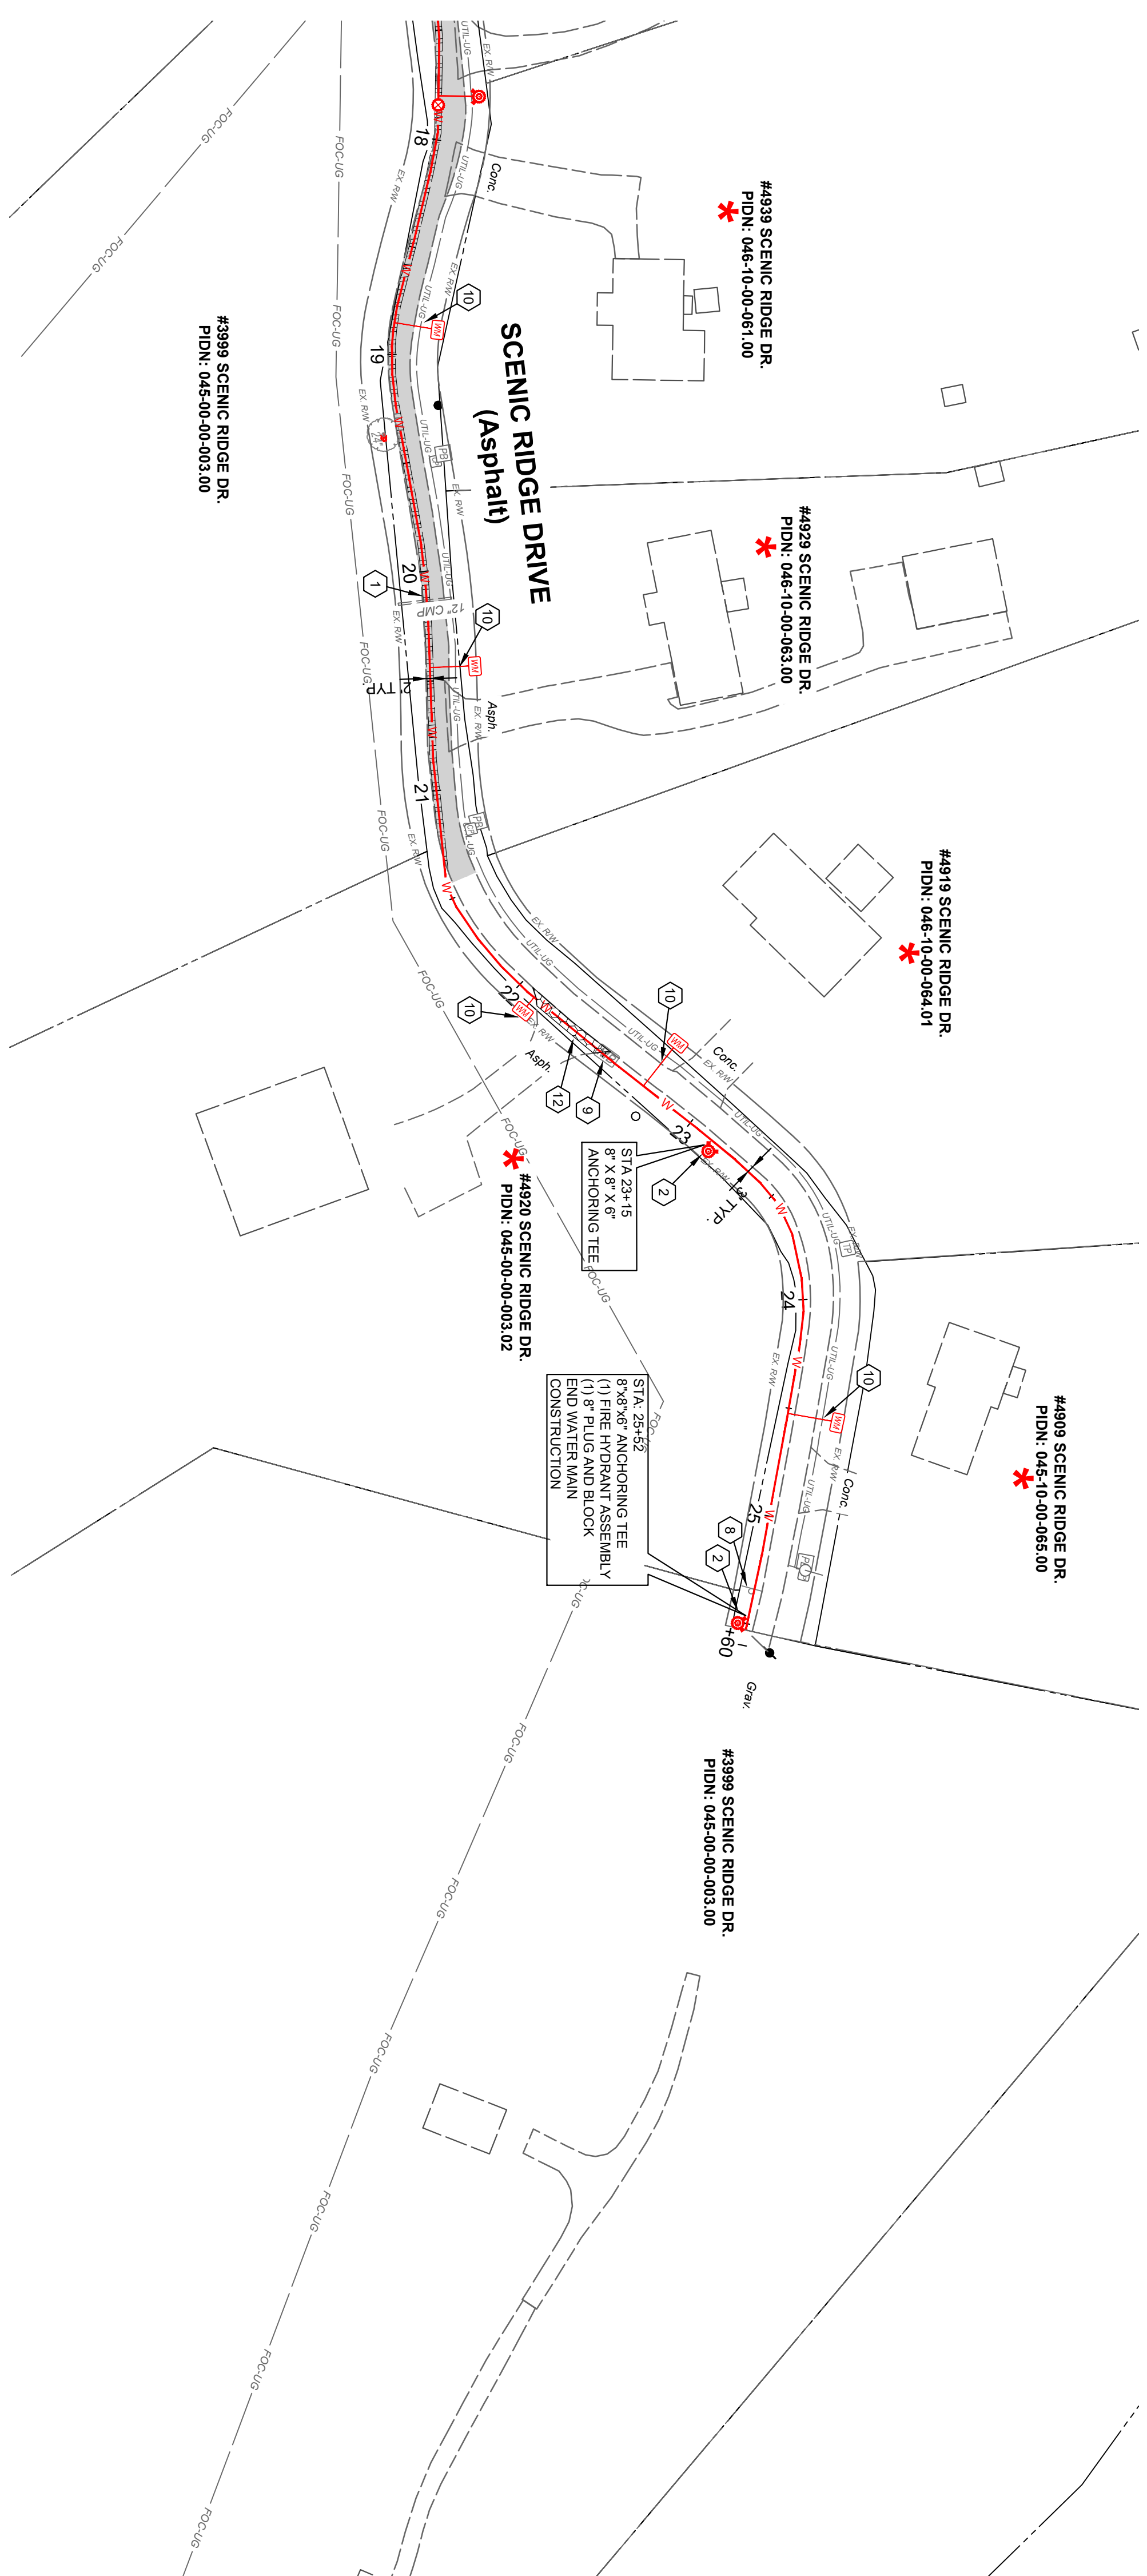
SCENIC RIDGE DRIVE
STA. 18+00 to STA. 25+60

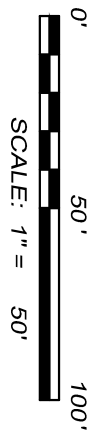
PROJECT NO.
231591

DISCIPLINE
CIVIL

SHEET NAME
C-03

SHEET
10 OF 28





CONSTRUCTION NOTES

- 1 MAINTAIN MANAGEABLE VERTICAL CLEARANCE BETWEEN THE PROPOSED WATER MAIN AND THE EXISTING STORM SEWER, WATER MAIN, TELEPHONE AND CABLE LINES. MAINTAIN MINIMUM 18" BETWEEN THE PROPOSED WATER MAIN AND THE EXISTING SANITARY SEWER. ACTUAL ELEVATION UNKNOWN. CONTRACTOR TO EXCAVATE & VERIFY ACTUAL LOCATION, SIZE AND ELEVATION OF EXISTING UTILITY PRIOR TO BEGINNING WATER MAIN CONSTRUCTION. THE CONTRACTOR SHALL NOTIFY THE OWNER PRIOR TO ANY POTENTIAL CONFLICT. NO ADDITIONAL PAYMENT WILL BE MADE FOR THIS WORK AND THE COST SHALL BE INCLUDED IN THE BID ITEM FOR WATER MAIN.
- 2 PROPOSED FIRE HYDRANT ASSEMBLY, VALVE AND ANCHOR VALVE TO TEE. COORDINATE LOCATION WITH N.K.W.D. INSPECTOR.
- 3 CONNECT TO EXISTING WATER MAIN (ACTUAL ELEVATION UNKNOWN). CONTRACTOR TO VERIFY DEPTH PRIOR TO CONSTRUCTION.
- 4 CHANNEL LINING, CLASS II (18") W/ NON-WOVEN GEOTEXTILE FILTER FABRIC
- 5 CONTRACTOR TO VERIFY LOCATION AND ELEVATION OF UTILITY PRIOR TO EXCAVATION ACTIVITY AND NOTIFY ENGINEER AND N.K.W.D. OF CONFLICTS. (" SEE NOTE)
- 6 DO NOT DISTURB
- 7 CONTRACTOR TO SUPPORT UTILITY POLE DURING PIPE INSTALLATION (" SEE NOTE)
- 8 REMOVE AND REPLACE SIGN (" SEE NOTE)
- 9 REMOVE AND REPLACE MAILBOX (" SEE NOTE)
- 10 INSTALL 5/8" METER SETTING PER NKWD STD. DWG. NO. 107. INSTALL WATER SERVICE LINE (3/4" TYPE K COPPER) FROM THE PROPOSED WATER MAIN TO THE METER SETTING. MATERIAL WILL BE PROVIDED BY EQUIPMENT EXCAVATION, BEDDING, BACKFILL, AND FINISH SHALL BE PROVIDED BY THE CONTRACTOR. INSTALL SERVICE LINE AS SHOWN ON PLANS OR DIRECTED BY NKWD IN ACCORDANCE WITH SPECS & STD. DWGS., COMPLETE.
- 11 REMOVE & REPLACE STORM STRUCTURE (CB/HW) AS NEEDED FOR WATER MAIN INSTALLATION (" SEE NOTE)
- 12 DRIVEWAY RESTORATION (SEE DETAILS)
- 13 TREE TO BE REMOVED

** NOTE:

WORK FOR THIS ITEM SHALL BE CONSIDERED INCIDENTAL TO THE OVERALL PROJECT AND NO ADDITIONAL PAYMENT SHALL BE MADE FOR THIS WORK. COST SHALL BE INCLUDED IN THE BID ITEM FOR WATER MAIN.

HATCH LEGEND

- 1-1/2" ASPHALT PAVEMENT MILL AND OVERLAY AREA
- TRENCH RESTORATION - ASPHALT PAVEMENT - SEE DETAIL SHEET
- TRENCH RESTORATION - CONCRETE PAVEMENT - SEE DETAIL SHEET
- TRENCH RESTORATION - 8" AGGREGATE PAVEMENT
- CONTROL DENSITY FILL - PAVT TRENCH
- CONCRETE DRIVEWAY REPLACEMENT - SEE DETAIL SHEET
- CONCRETE WALK REPLACEMENT - SEE DETAIL SHEET
- ASPHALT DRIVEWAY REPLACEMENT - SEE DETAIL SHEET
- GRAVEL DRIVEWAY REPLACEMENT - SEE DETAIL SHEET
- CHANNEL LINING, CLASS II - SEE DETAIL SHEET
- * DENOTES PROPERTY WITH NEW SERVICE AND METER SETTING

NORTHERN KENTUCKY WATER DISTRICT
SUBDISTRICT 'O'
-KENTON COUNTY -



STEEL CREEK ROAD
STA. 20+00 TO STA. 30+00





PROJECT NO.	231591
DISCIPLINE	CIVIL
SHEET NAME	C-05
SHEET	12 OF 28

ISSUED FOR:	BID	NO	REVISION	DATE
ISSUE DATE:	APRIL 2025			
SCALE:	AS SHOWN			
DESIGNED BY:	JCOR			
DRAWN BY:	JCOR			
CHECKED BY:	JSHU			

verdantas

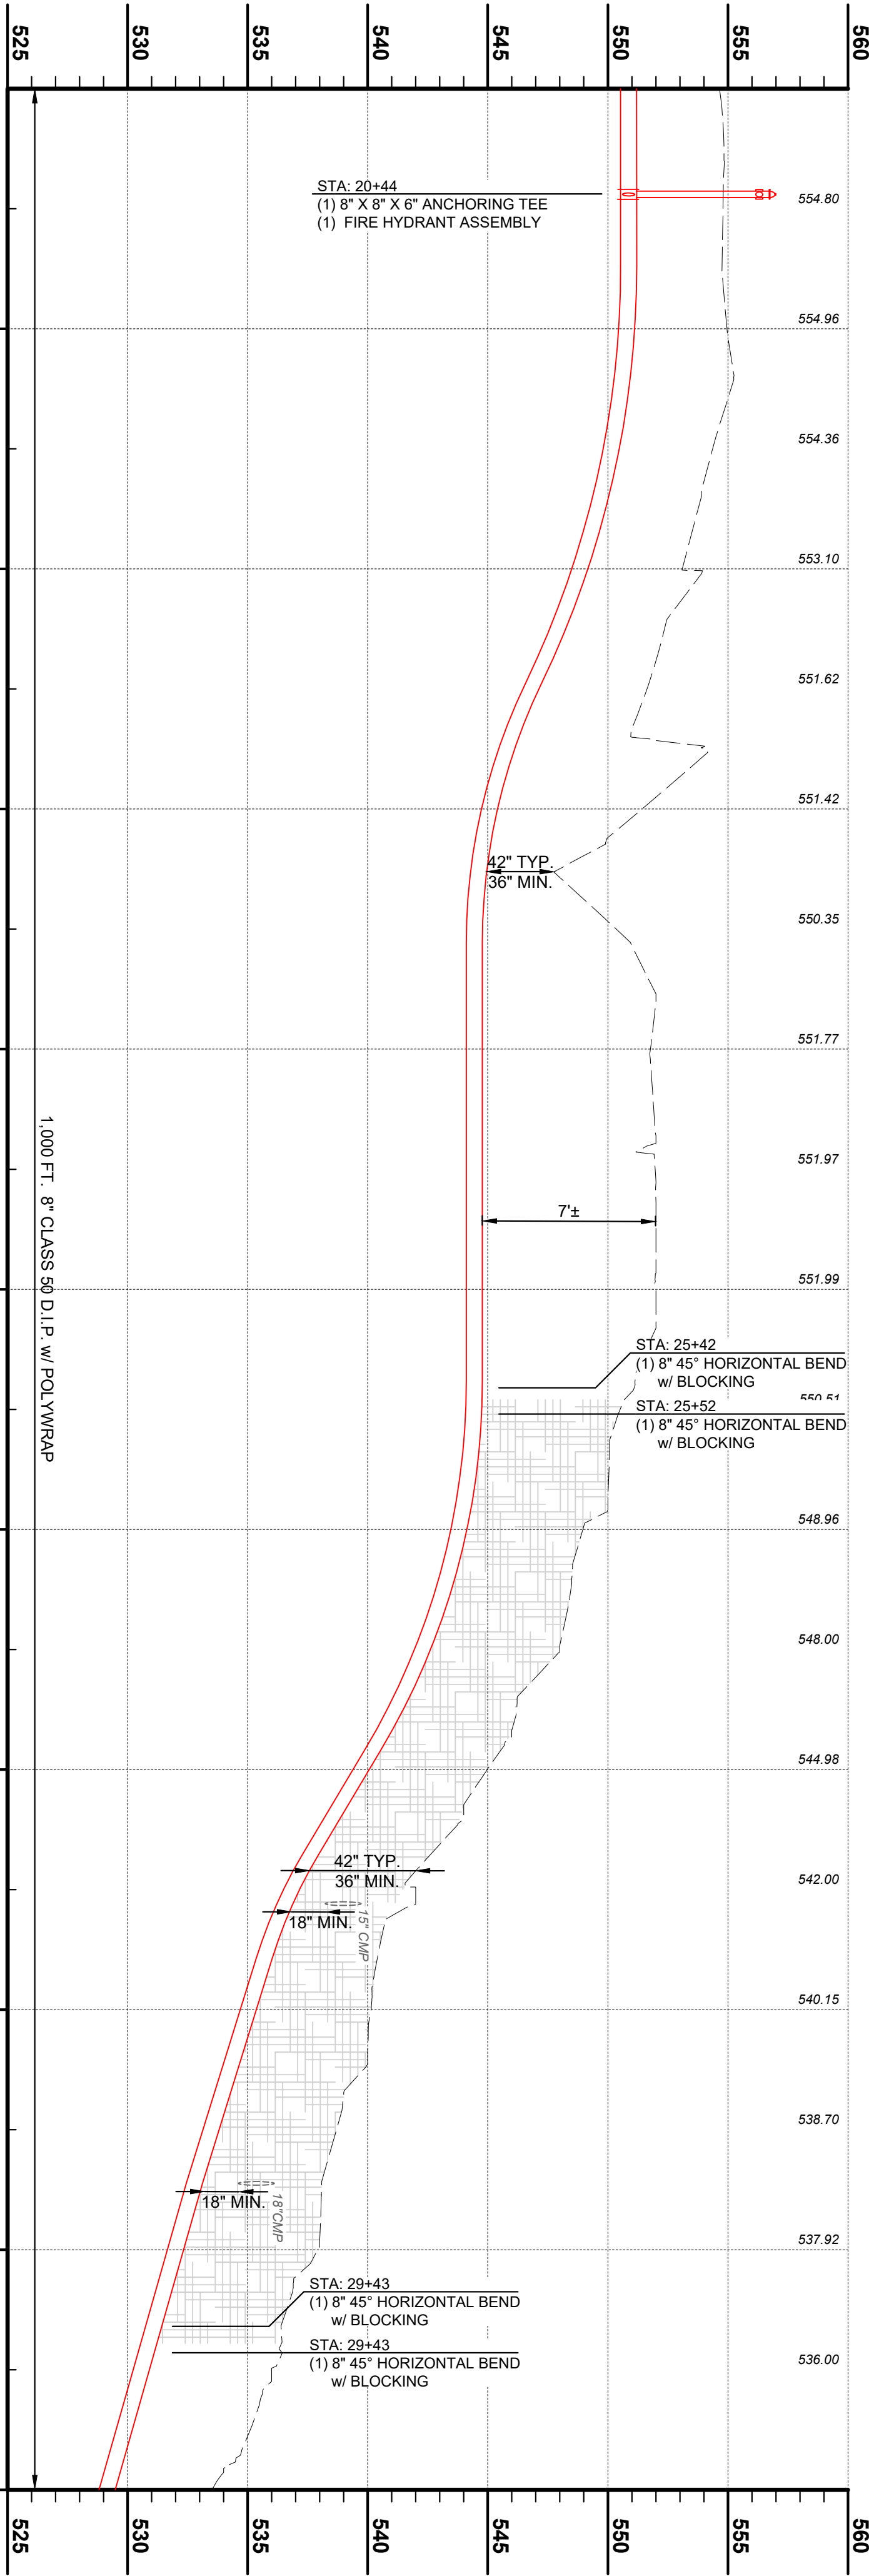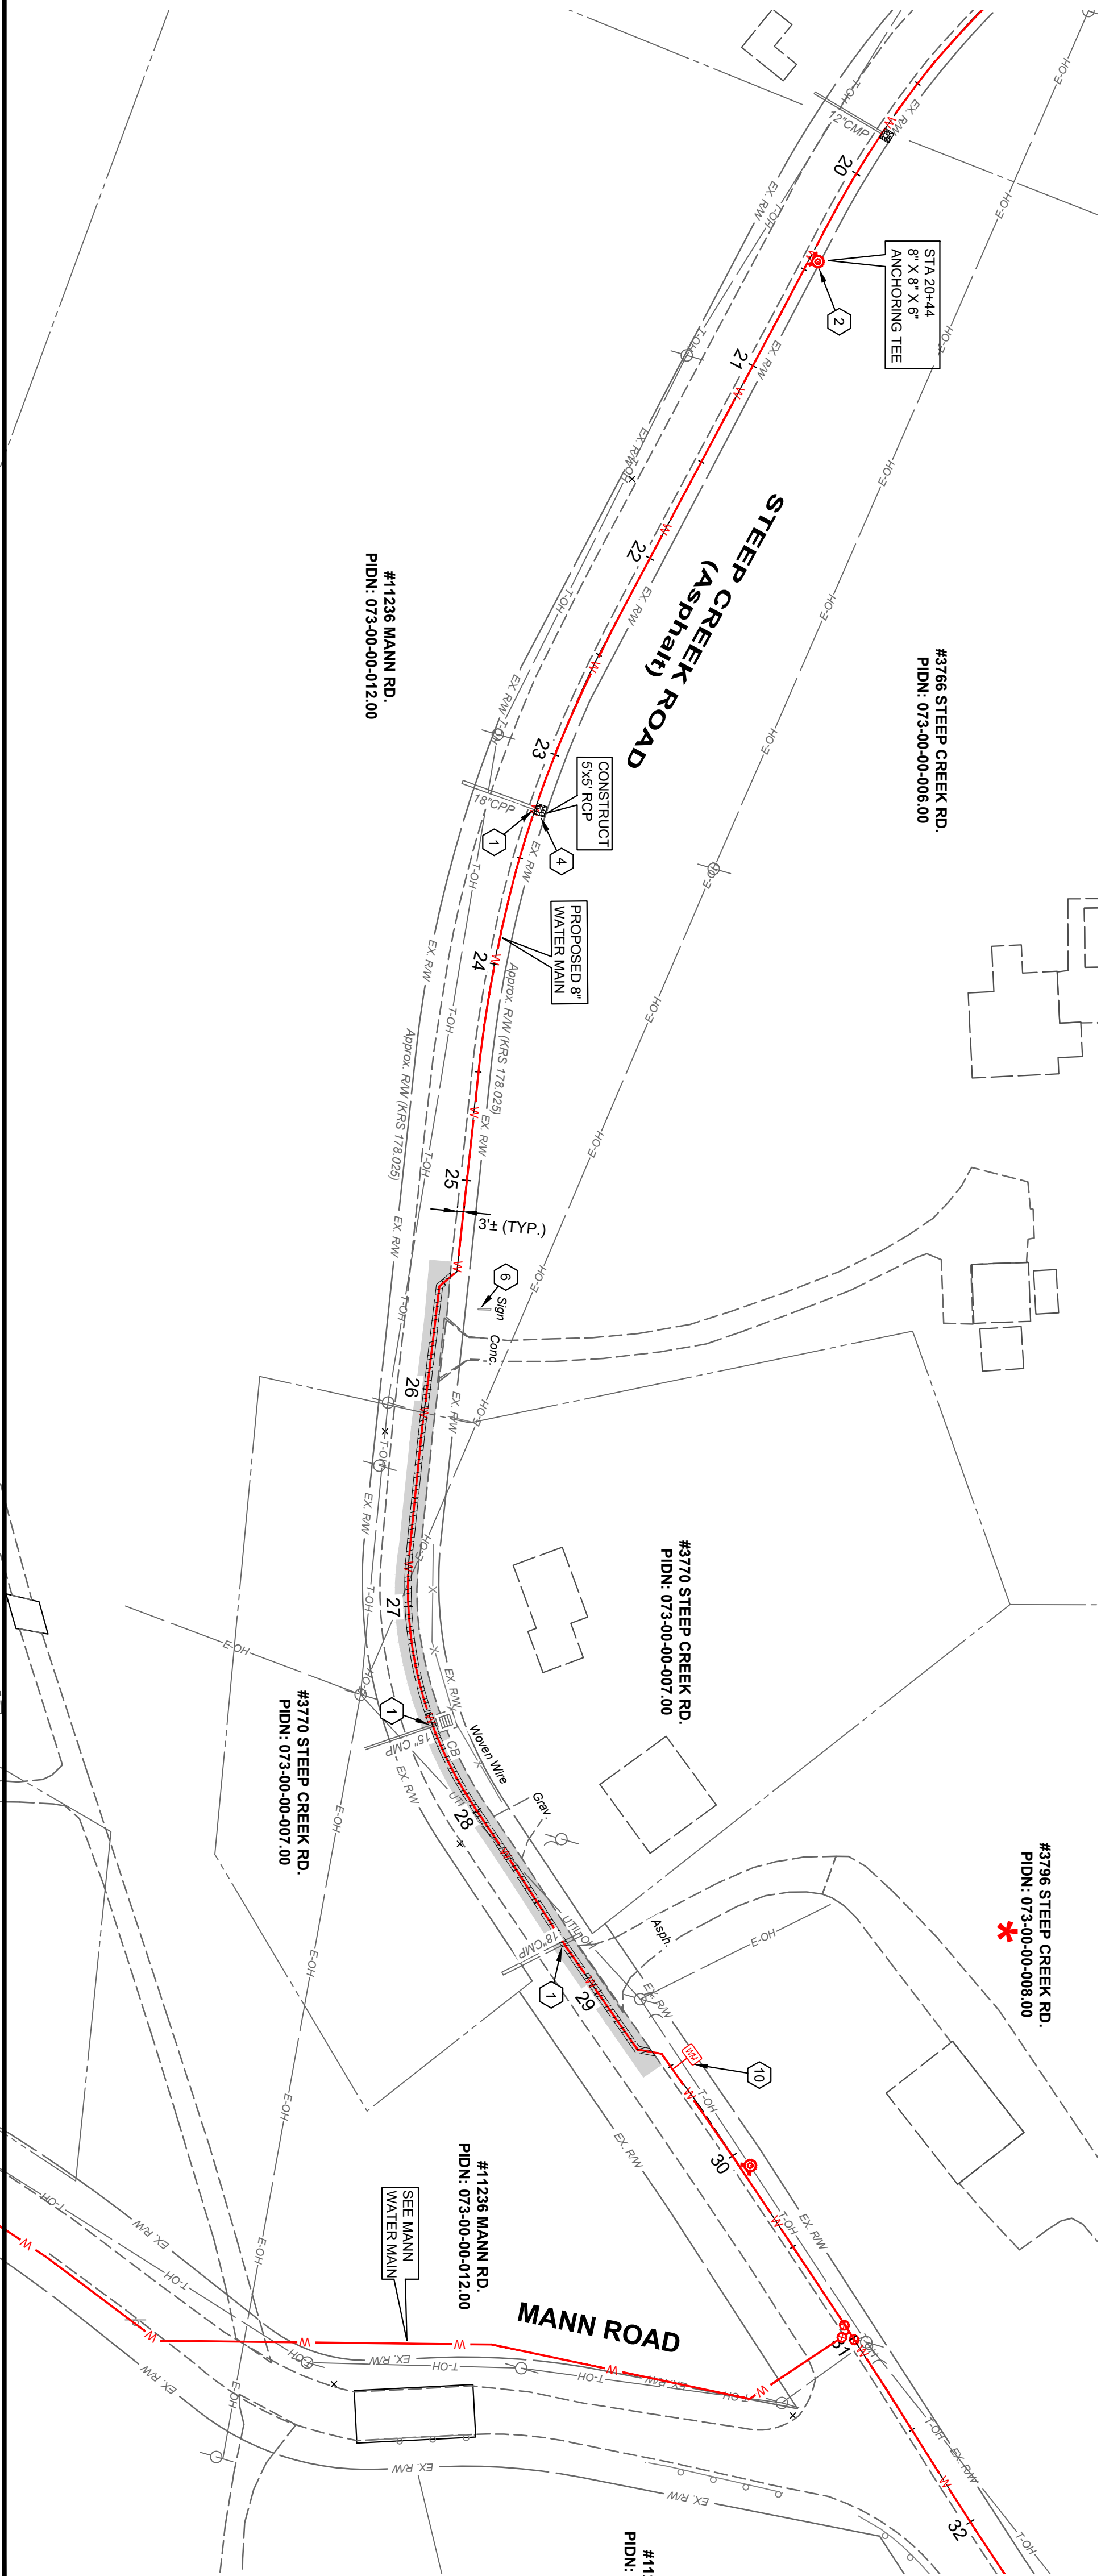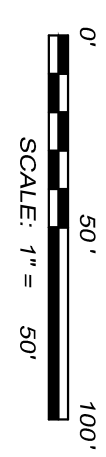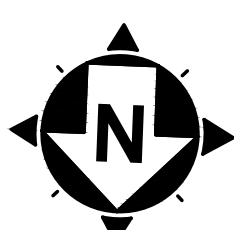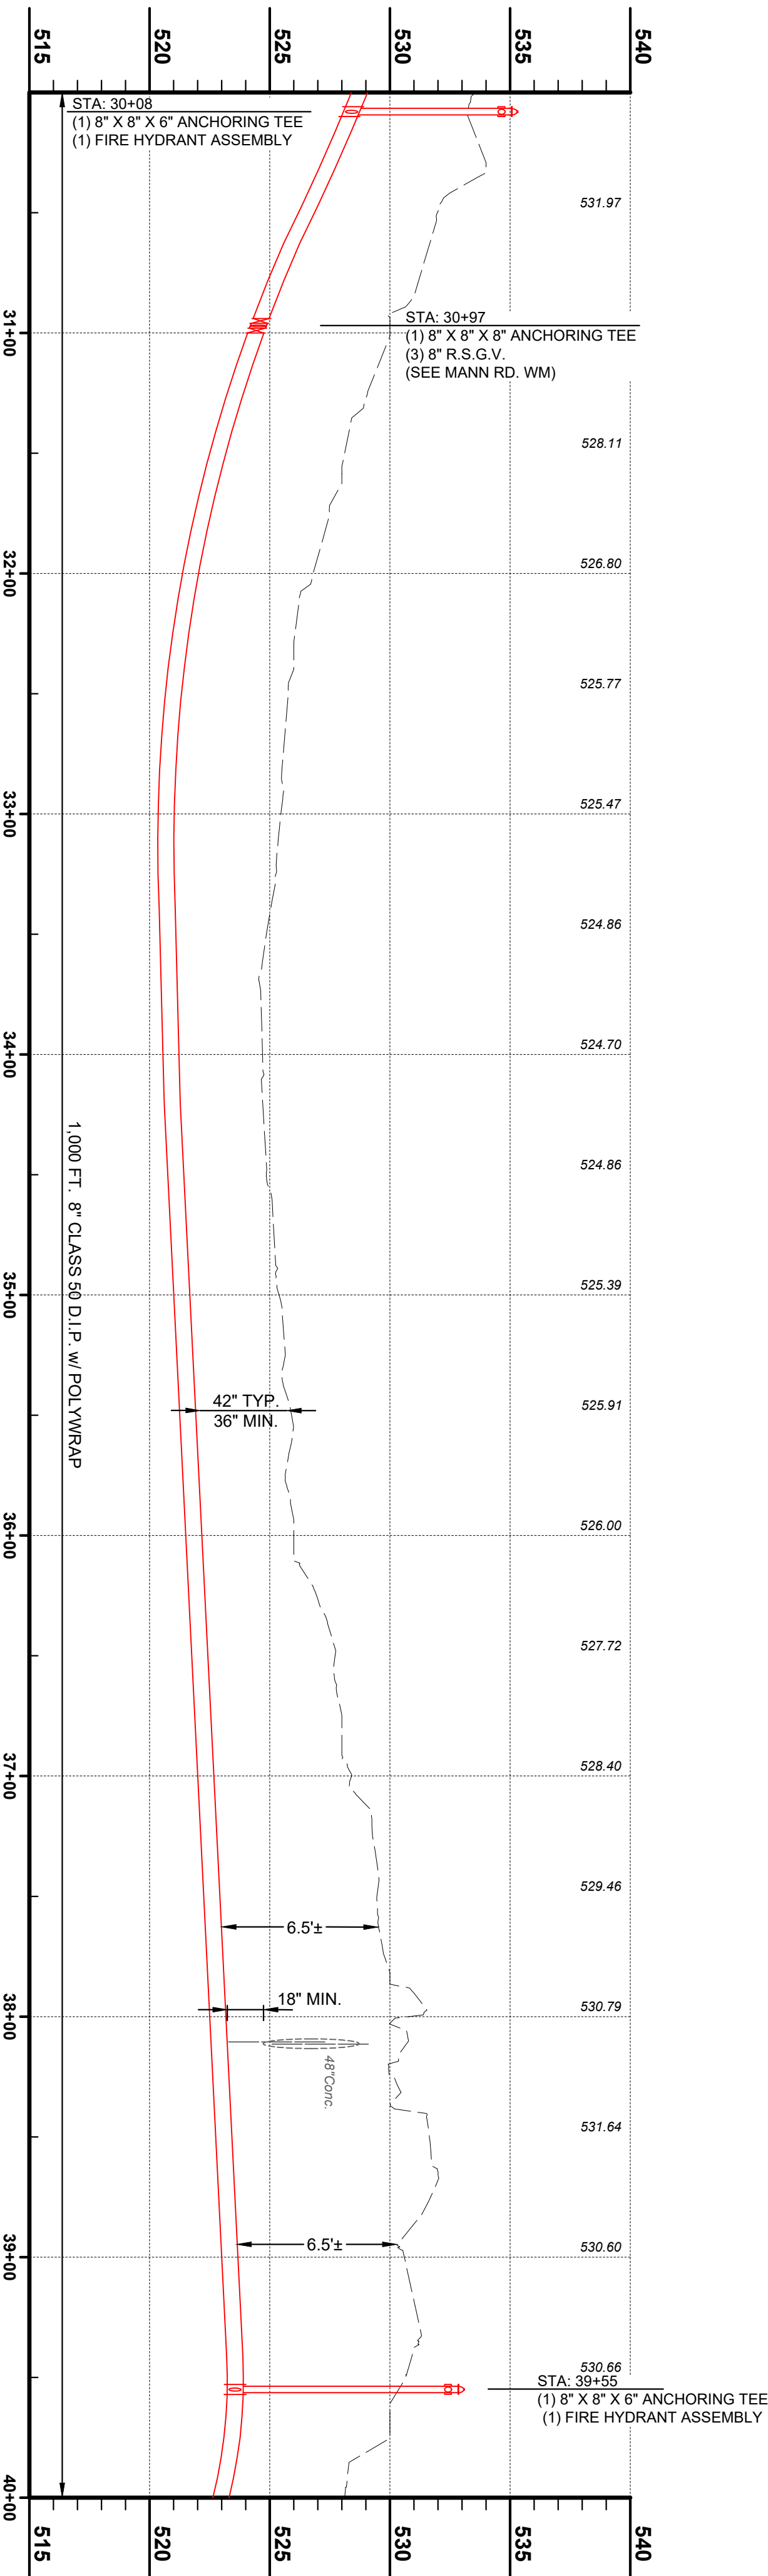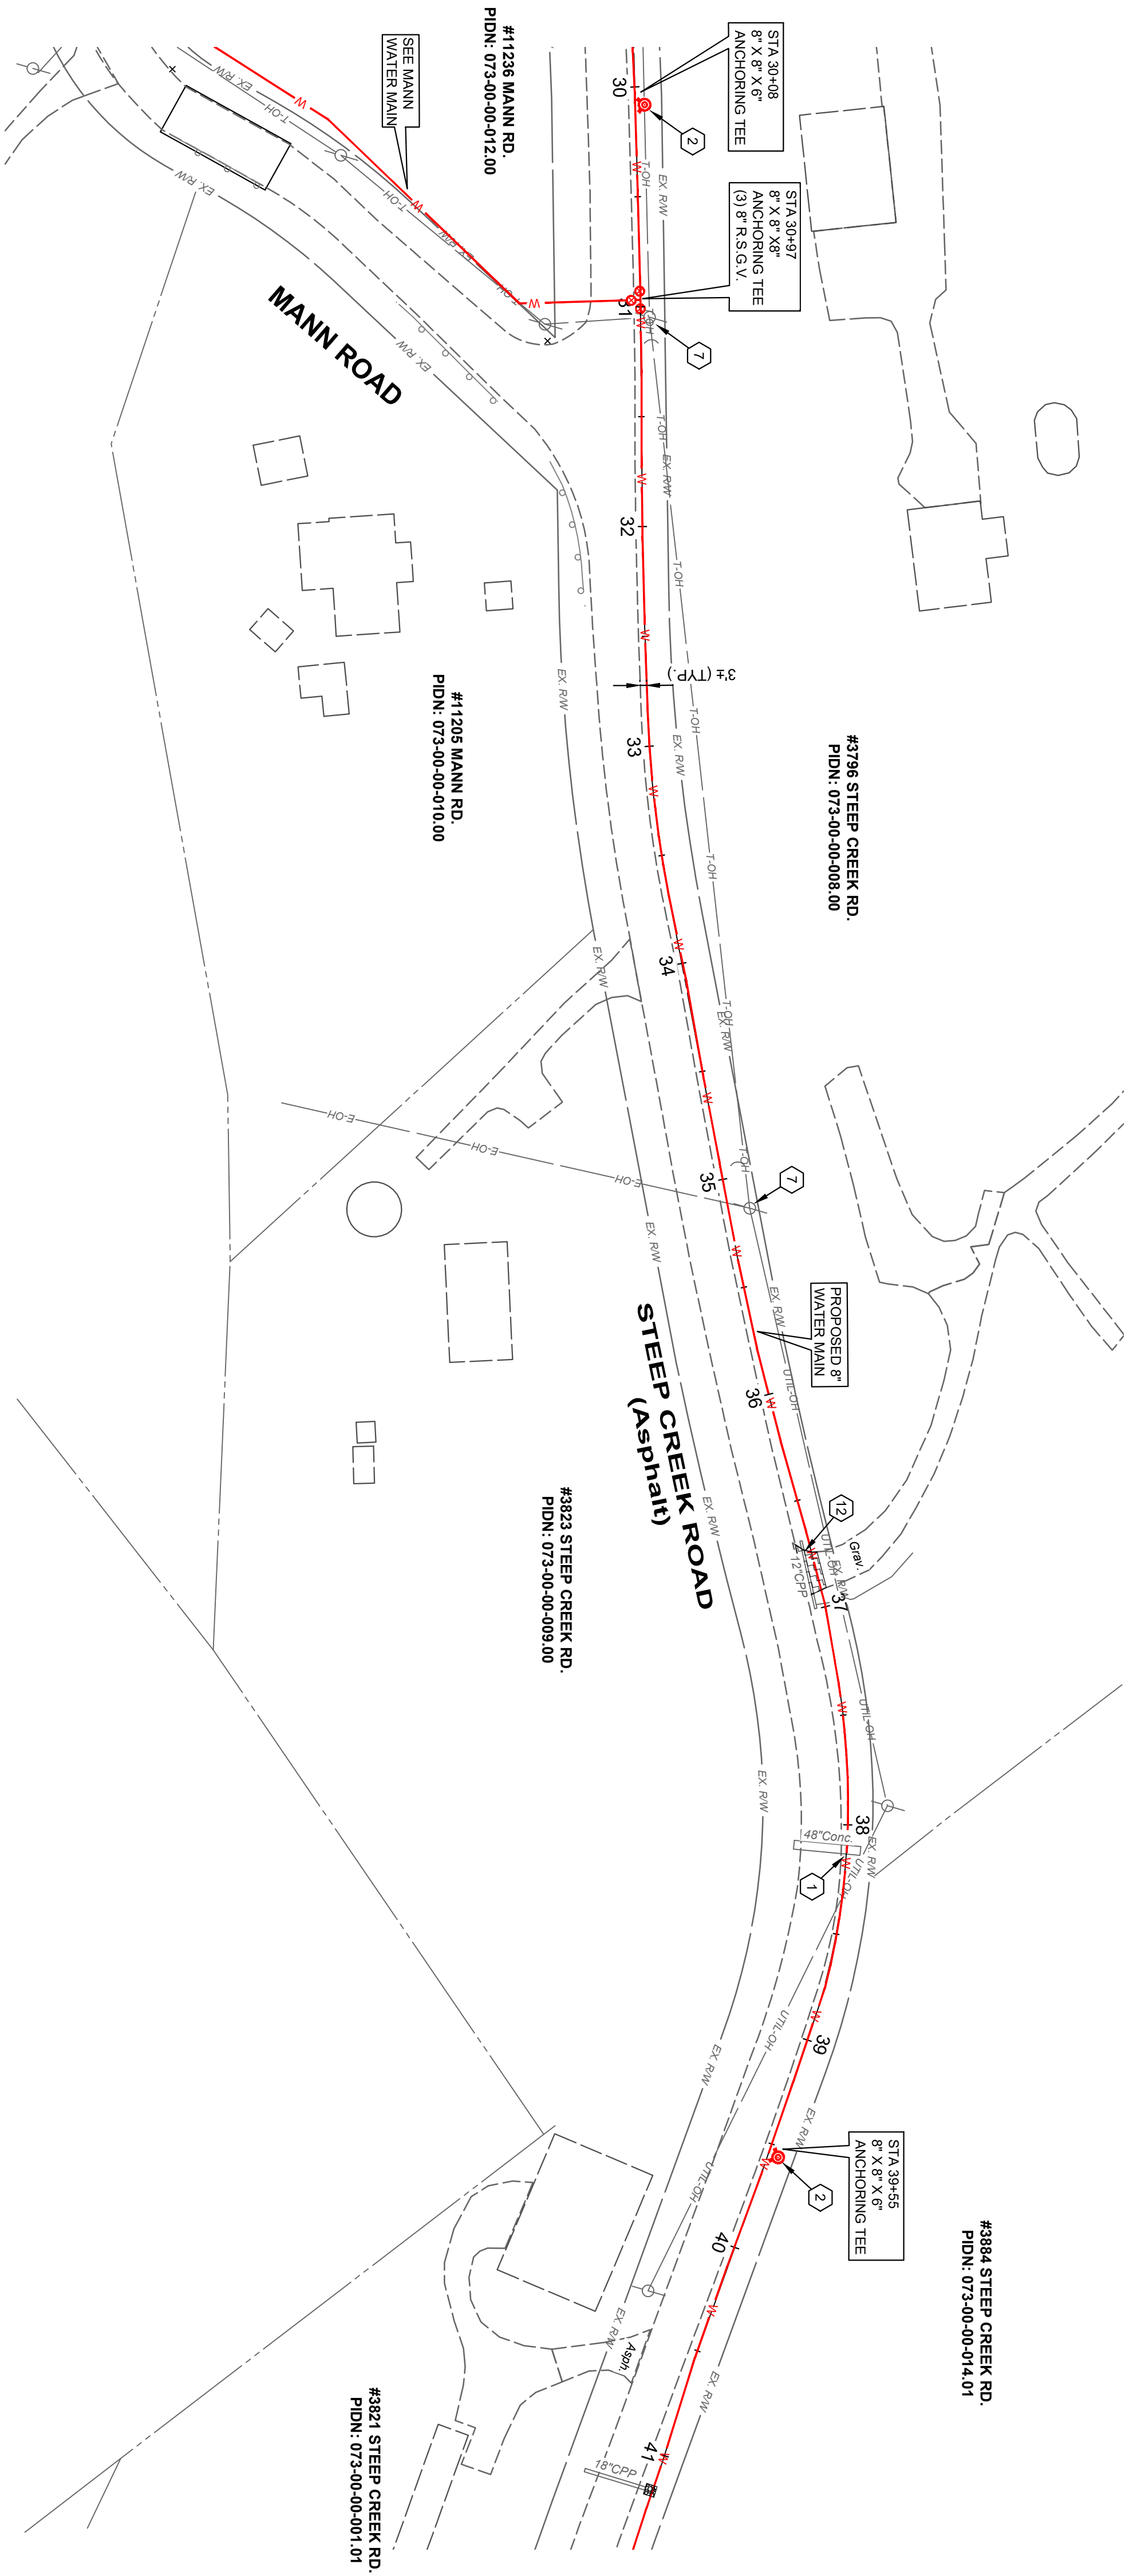2161 CHAMBER CENTER DRIVE
FORT MITCHELL, KENTUCKY 41017
TEL. (859) 525-0544
WWW.VERDANTAS.COM






CONSTRUCTION NOTES

- 1 MAINTAIN MANAGEABLE VERTICAL CLEARANCE BETWEEN THE PROPOSED WATER MAIN AND THE EXISTING STORM SEWER. WATER MAIN: TELEPHONE DUCT, 18" MINIMUM CLEARANCE. STORM SEWER: SEWER CROSSINGS PER K&W, SPECIFICATIONS ITEM 1.14. MAINTAIN MINIMUM 18" BETWEEN THE PROPOSED WATER MAIN AND THE EXISTING SANITARY SEWER. ACTUAL ELEVATION UNKNOWN. CONTRACTOR TO EXCAVATE & VERIFY ACTUAL LOCATION, SIZE AND ELEVATION OF EXISTING UTILITY PRIOR TO BEGINNING WATER MAIN CONSTRUCTION. THE CONTRACTOR SHALL BE RESPONSIBLE FOR OBTAINING ALL NECESSARY CONSTRUCTION OF ANY POTENTIAL CONFLICT. NO ADDITIONAL PAYMENT WILL BE MADE FOR THIS WORK AND THE COST SHALL BE INCLUDED IN THE BID ITEM FOR WATER MAIN.
- 2 PROPOSED FIRE HYDRANT ASSEMBLY, VALVE AND CONNECTIONS AS PER K&W, STD. DRAWING NO. 109. CONDUIT SHALL BE 12" MINIMUM WITH K&W INSPECTION. ANCHOR VALVE TO TEE.
- 3 CONNECT TO EXISTING WATER MAIN (ACTUAL ELEVATION UNKNOWN). CONTRACTOR TO VERIFY DEPTH PRIOR TO CONSTRUCTION.
- 4 CHANNEL LINING CLASS 1 (18") w/ NON-HOVEN GEOTEXTILE FILTER FABRIC
- 5 CONTRACTOR TO VERIFY LOCATION AND ELEVATION OF UTILITY PRIOR TO EXCAVATION ACTIVITY AND NOTIFY ENGINEER AND N.K.W.D. OF CONFLICTS. ("SEE NOTE")
- 6 DO NOT DISTURB
- 7 CONTRACTOR TO SUPPORT UTILITY POLE DURING PIPE INSTALLATION. ("SEE NOTE")
- 8 REMOVE AND REPLACE SIGN. ("SEE NOTE")
- 9 REMOVE AND REPLACE WALLBOX. ("SEE NOTE")
- 10 INSTALL 5/8" METER SETTING PER N.W.D. STD. DWG. NO. 107. INSTALL WATER SERVICE LINE 1/4" TYPE K COPPER FROM THE PROPOSED WATER MAIN TO THE METER SETTING. MATERIAL WILL BE PROVIDED BY N.W.D. FOR THIS WORK. UNIT PRICE INCLUDES LABOR, EQUIPMENT, EXCAVATION, BEDDING, BACKFILL, ASPHALT CONCRETE AND YARD RESTORATION TO INSTALL SERVICE LINE AS SHOWN ON PLANS OF PROJECT. CONTRACTOR TO CONFORMANCE WITH SPECS & STD. DWGS. COMPLETE.
- 11 REMOVE & REPLACE STORM STRUCTURE (CB HW) AS NEEDED FOR WATER MAIN INSTALLATION. ("SEE NOTE")
- 12 DRIVEWAY RESTORATION (SEE DETAILS)
- 13 TREE TO BE REMOVED

NOTE:

WORK FOR THIS ITEM SHALL BE CONSIDERED INCIDENTAL TO THE OVERALL PROJECT AND NO ADDITIONAL PAYMENT SHALL BE MADE FOR THIS WORK. COST SHALL BE INCLUDED IN THE BID ITEM FOR WATER MAIN.

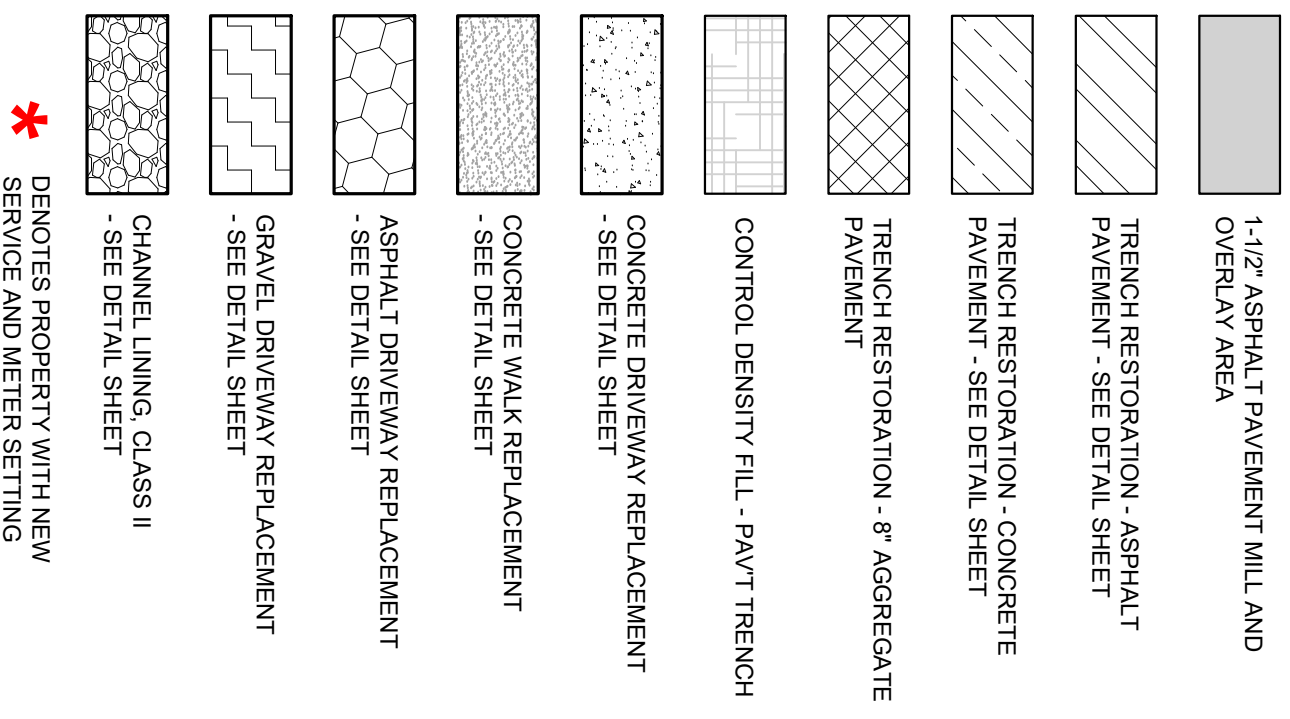HATCH LEGEND




**NORTHERN KENTUCKY WATER DISTRICT
SUBDISTRICT 'O'
-KENTON COUNTY -**

**STEEP CREEK ROAD
STA. 30+00 TO STA. 40+00**

ISSUED FOR:	BID	NO	REVISION	DATE
ISSUE DATE:	APRIL 2025	.	.	.
SCALE:	AS SHOWN			
DESIGNED BY:	JCOR			
DRAWN BY:	JCOR			
CHECKED BY:	JSHU			



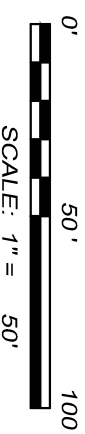

#3884 STEEP CREEK RD
PIDN: 073-00-00-014.01

- ## NOTES

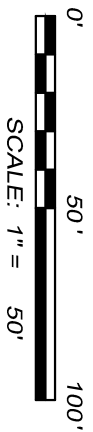
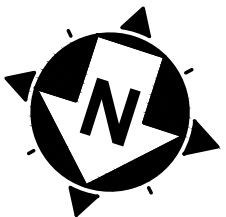
HATCH LEGEND



**NORTHERN KENTUCKY WATER DISTRICT
SUBDISTRICT 'O'
-KENTON COUNTY -**

STEEP CREEK ROAD
sta. 40+00 to sta. 50+00

SHEET NAME	
C-07	
SHEET	OF
14	28



CONSTRUCTION NOTES

- 1 MAINTAIN MANAGEABLE VERTICAL CLEARANCE BETWEEN THE PROPOSED WATER MAIN AND THE EXISTING STORM SEWER, WATER MAIN, TELEPHONE AND CABLE LINES. MAINTAIN MINIMUM 18" BETWEEN THE PROPOSED WATER MAIN AND THE EXISTING SANITARY SEWER. ACTUAL ELEVATION UNKNOWN. CONTRACTOR TO EXCAVATE & VERIFY ACTUAL LOCATION, SIZE AND ELEVATION OF EXISTING UTILITY PRIOR TO BEGINNING WATER MAIN CONSTRUCTION. THE CONTRACTOR SHALL NOTIFY THE SANITARY INSPECTOR PRIOR TO CONSTRUCTION OF ANY POTENTIAL CONFLICT. NO ADDITIONAL PAYMENT WILL BE MADE FOR THIS WORK AND THE COST SHALL BE INCLUDED IN THE BID ITEM FOR WATER MAIN.
- 2 PROPOSED FIRE HYDRANT ASSEMBLY, VALVE AND ANCHORING TEE SHALL BE INSTALLED AT THE COORDINATE LOCATION WITH N.K.W.D. INSPECTOR, ANCHOR VALVE TO TEE.
- 3 CONNECT TO EXISTING WATER MAIN (ACTUAL ELEVATION UNKNOWN). CONTRACTOR TO VERIFY DEPTH PRIOR TO CONSTRUCTION.
- 4 CHANNEL LINING, CLASS II (18") W/ NON-WOVEN GEOTEXTILE FILTER FABRIC
- 5 CONTRACTOR TO VERIFY LOCATION AND ELEVATION OF UTILITY PRIOR TO EXCAVATION ACTIVITY AND NOTIFY ENGINEER AND N.K.W.D. OF CONFLICTS. (" SEE NOTE)
- 6 DO NOT DISTURB
- 7 CONTRACTOR TO SUPPORT UTILITY POLE DURING PIPE INSTALLATION (" SEE NOTE)
- 8 REMOVE AND REPLACE SIGN (" SEE NOTE)
- 9 REMOVE AND REPLACE MAILBOX (" SEE NOTE)
- 10 INSTALL 56" METER SETTING PER NKWD STD. DWG. NO. 107. INSTALL WATER SERVICE LINE (3/4" TYPE K COPPER) FROM THE PROPOSED WATER MAIN TO THE METER SETTING. MATERIAL WILL BE PROVIDED BY EQUIP'D FOR THIS WORK. UNIT PRICE INCLUDES LABOR, EQUIPMENT EXCAVATION, BEDDING, BACKFILL, AND FINISHING. CONTRACTOR SHALL BE RESPONSIBLE TO INSTALL SERVICE LINE AS SHOWN ON PLANS OR DIRECTED BY NKWD IN ACCORDANCE WITH SPECS & STD. DWGS, COMPLETE.
- 11 REMOVE & REPLACE STORM STRUCTURE (CB/HW) AS NEEDED FOR WATER MAIN INSTALLATION (" SEE NOTE)
- 12 DRIVEWAY RESTORATION (SEE DETAILS)
- 13 TREE TO BE REMOVED

** NOTE:

WORK FOR THIS ITEM SHALL BE CONSIDERED INCIDENTAL TO THE OVERALL PROJECT AND NO ADDITIONAL PAYMENT SHALL BE MADE FOR THIS WORK. COST SHALL BE INCLUDED IN THE BID ITEM FOR WATER MAIN.

HATCH LEGEND

- 1-1/2" ASPHALT PAVEMENT MILL AND OVERLAY AREA
- TRENCH RESTORATION - ASPHALT PAVEMENT - SEE DETAIL SHEET
- TRENCH RESTORATION - CONCRETE PAVEMENT - SEE DETAIL SHEET
- TRENCH RESTORATION - 8" AGGREGATE PAVEMENT
- CONTROL DENSITY FILL - PAVT TRENCH
- CONCRETE DRIVEWAY REPLACEMENT - SEE DETAIL SHEET
- CONCRETE WALK REPLACEMENT - SEE DETAIL SHEET
- ASPHALT DRIVEWAY REPLACEMENT - SEE DETAIL SHEET
- GRAVEL DRIVEWAY REPLACEMENT - SEE DETAIL SHEET
- CHANNEL LINING, CLASS II - SEE DETAIL SHEET
- DENOTES PROPERTY WITH NEW SERVICE AND METER SETTING

NORTHERN KENTUCKY WATER DISTRICT
SUBDISTRICT 'O'
-KENTON COUNTY -



STEEP CREEK ROAD
STA. 50+00 TO STA. 60+00


PROJECT NO.	231591
DISCIPLINE	CIVIL
SHEET NAME	C-08
SHEET	15
OF	28

ISSUED FOR:	BID	NO	REVISION	DATE
ISSUE DATE:	APRIL 2025			
SCALE:	AS SHOWN			
DESIGNED BY:	JCOR			
DRAWN BY:	JCOR			
CHECKED BY:	JSHU			

verdantas

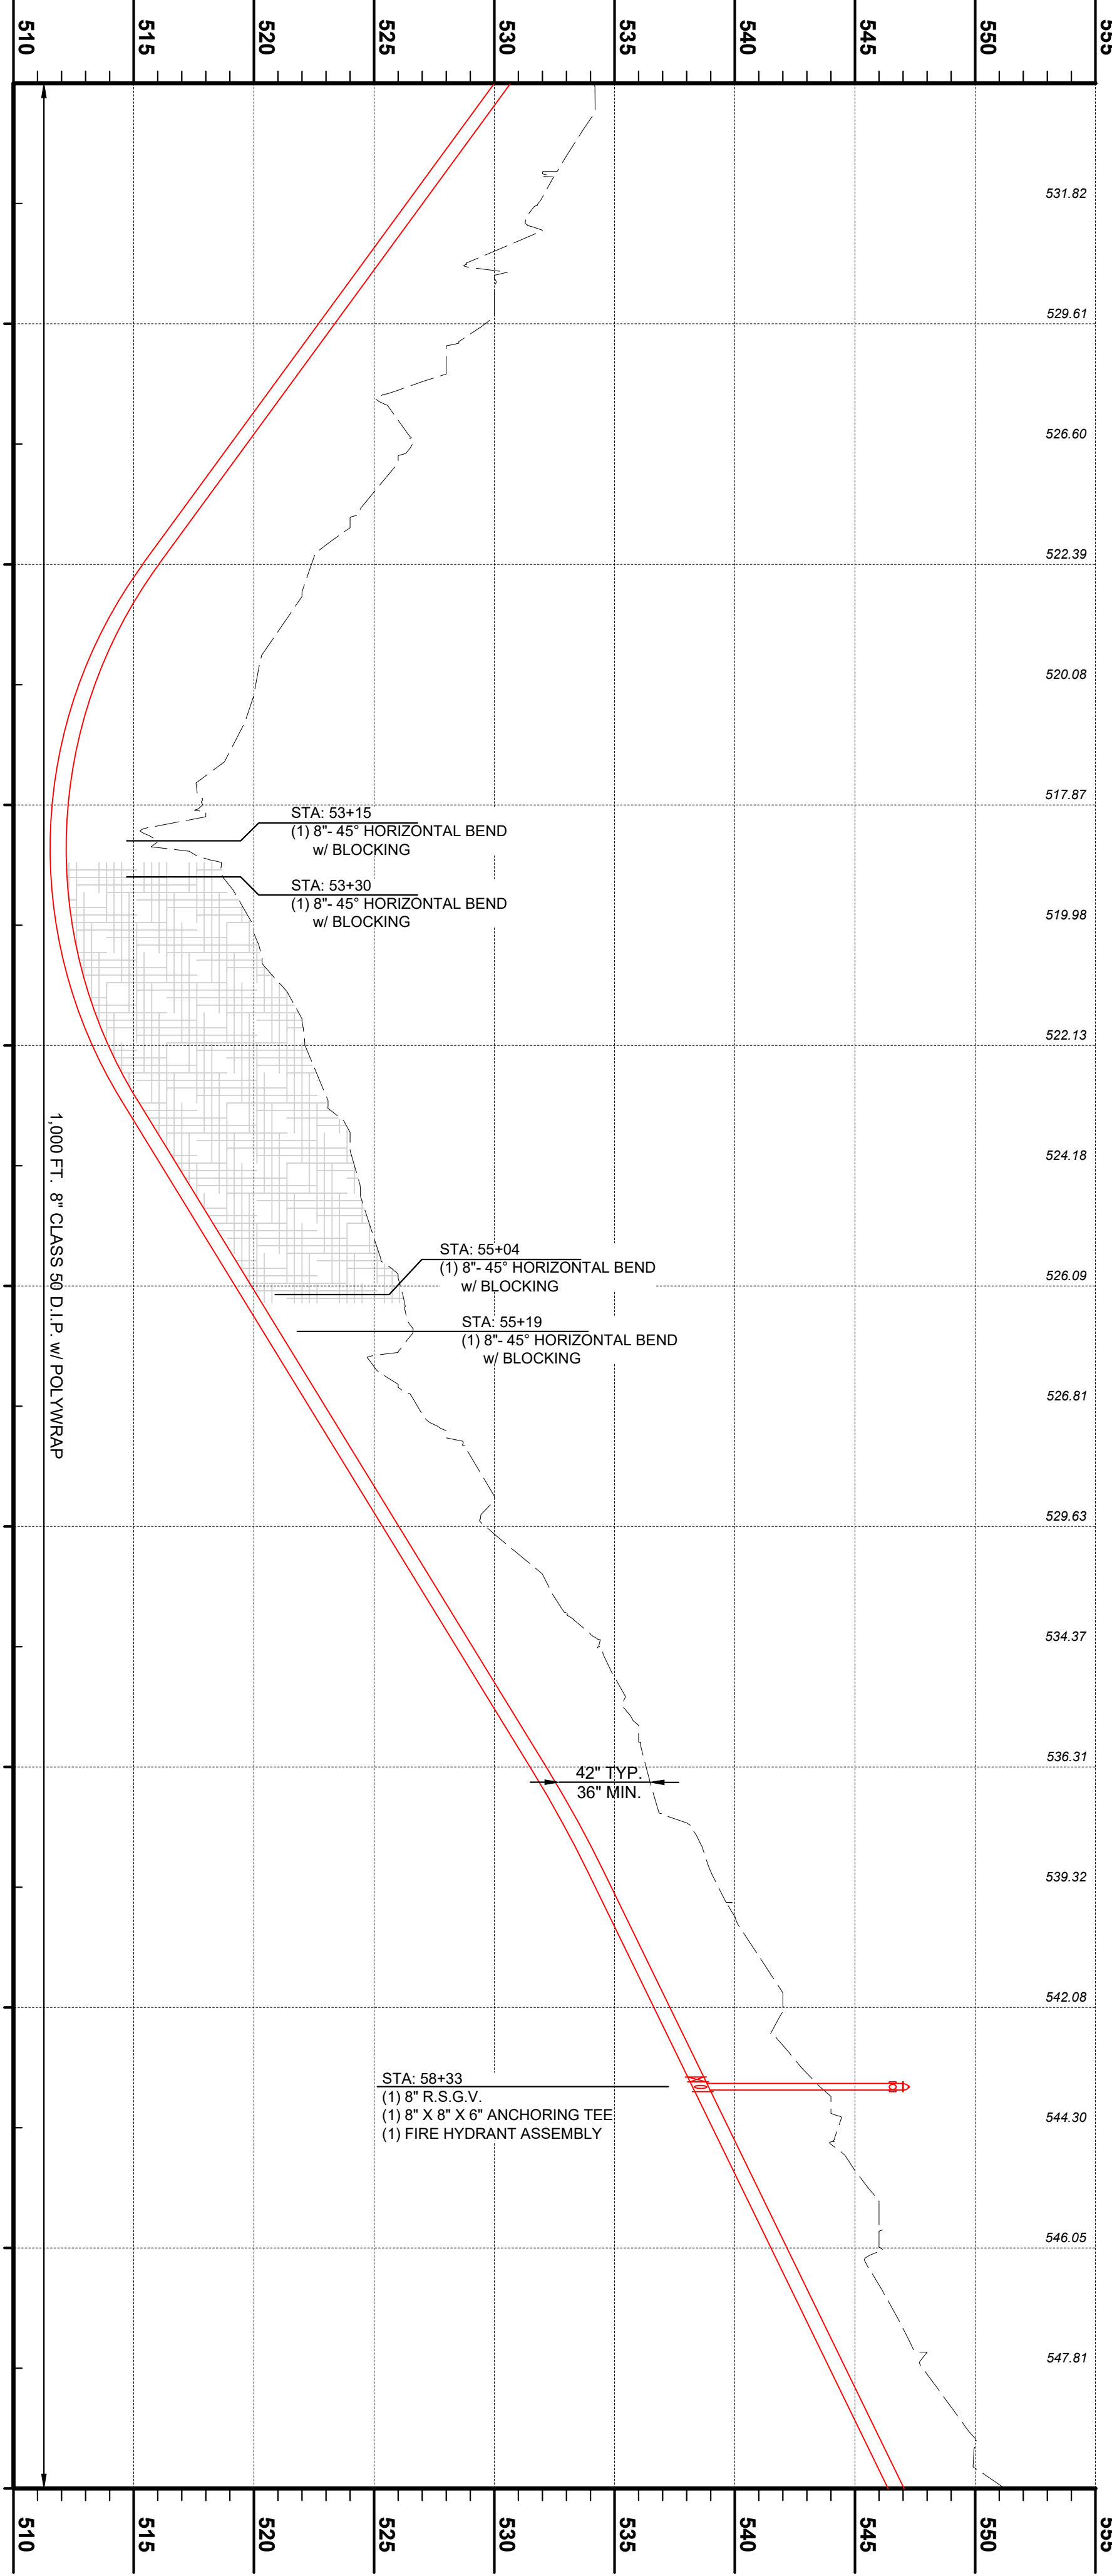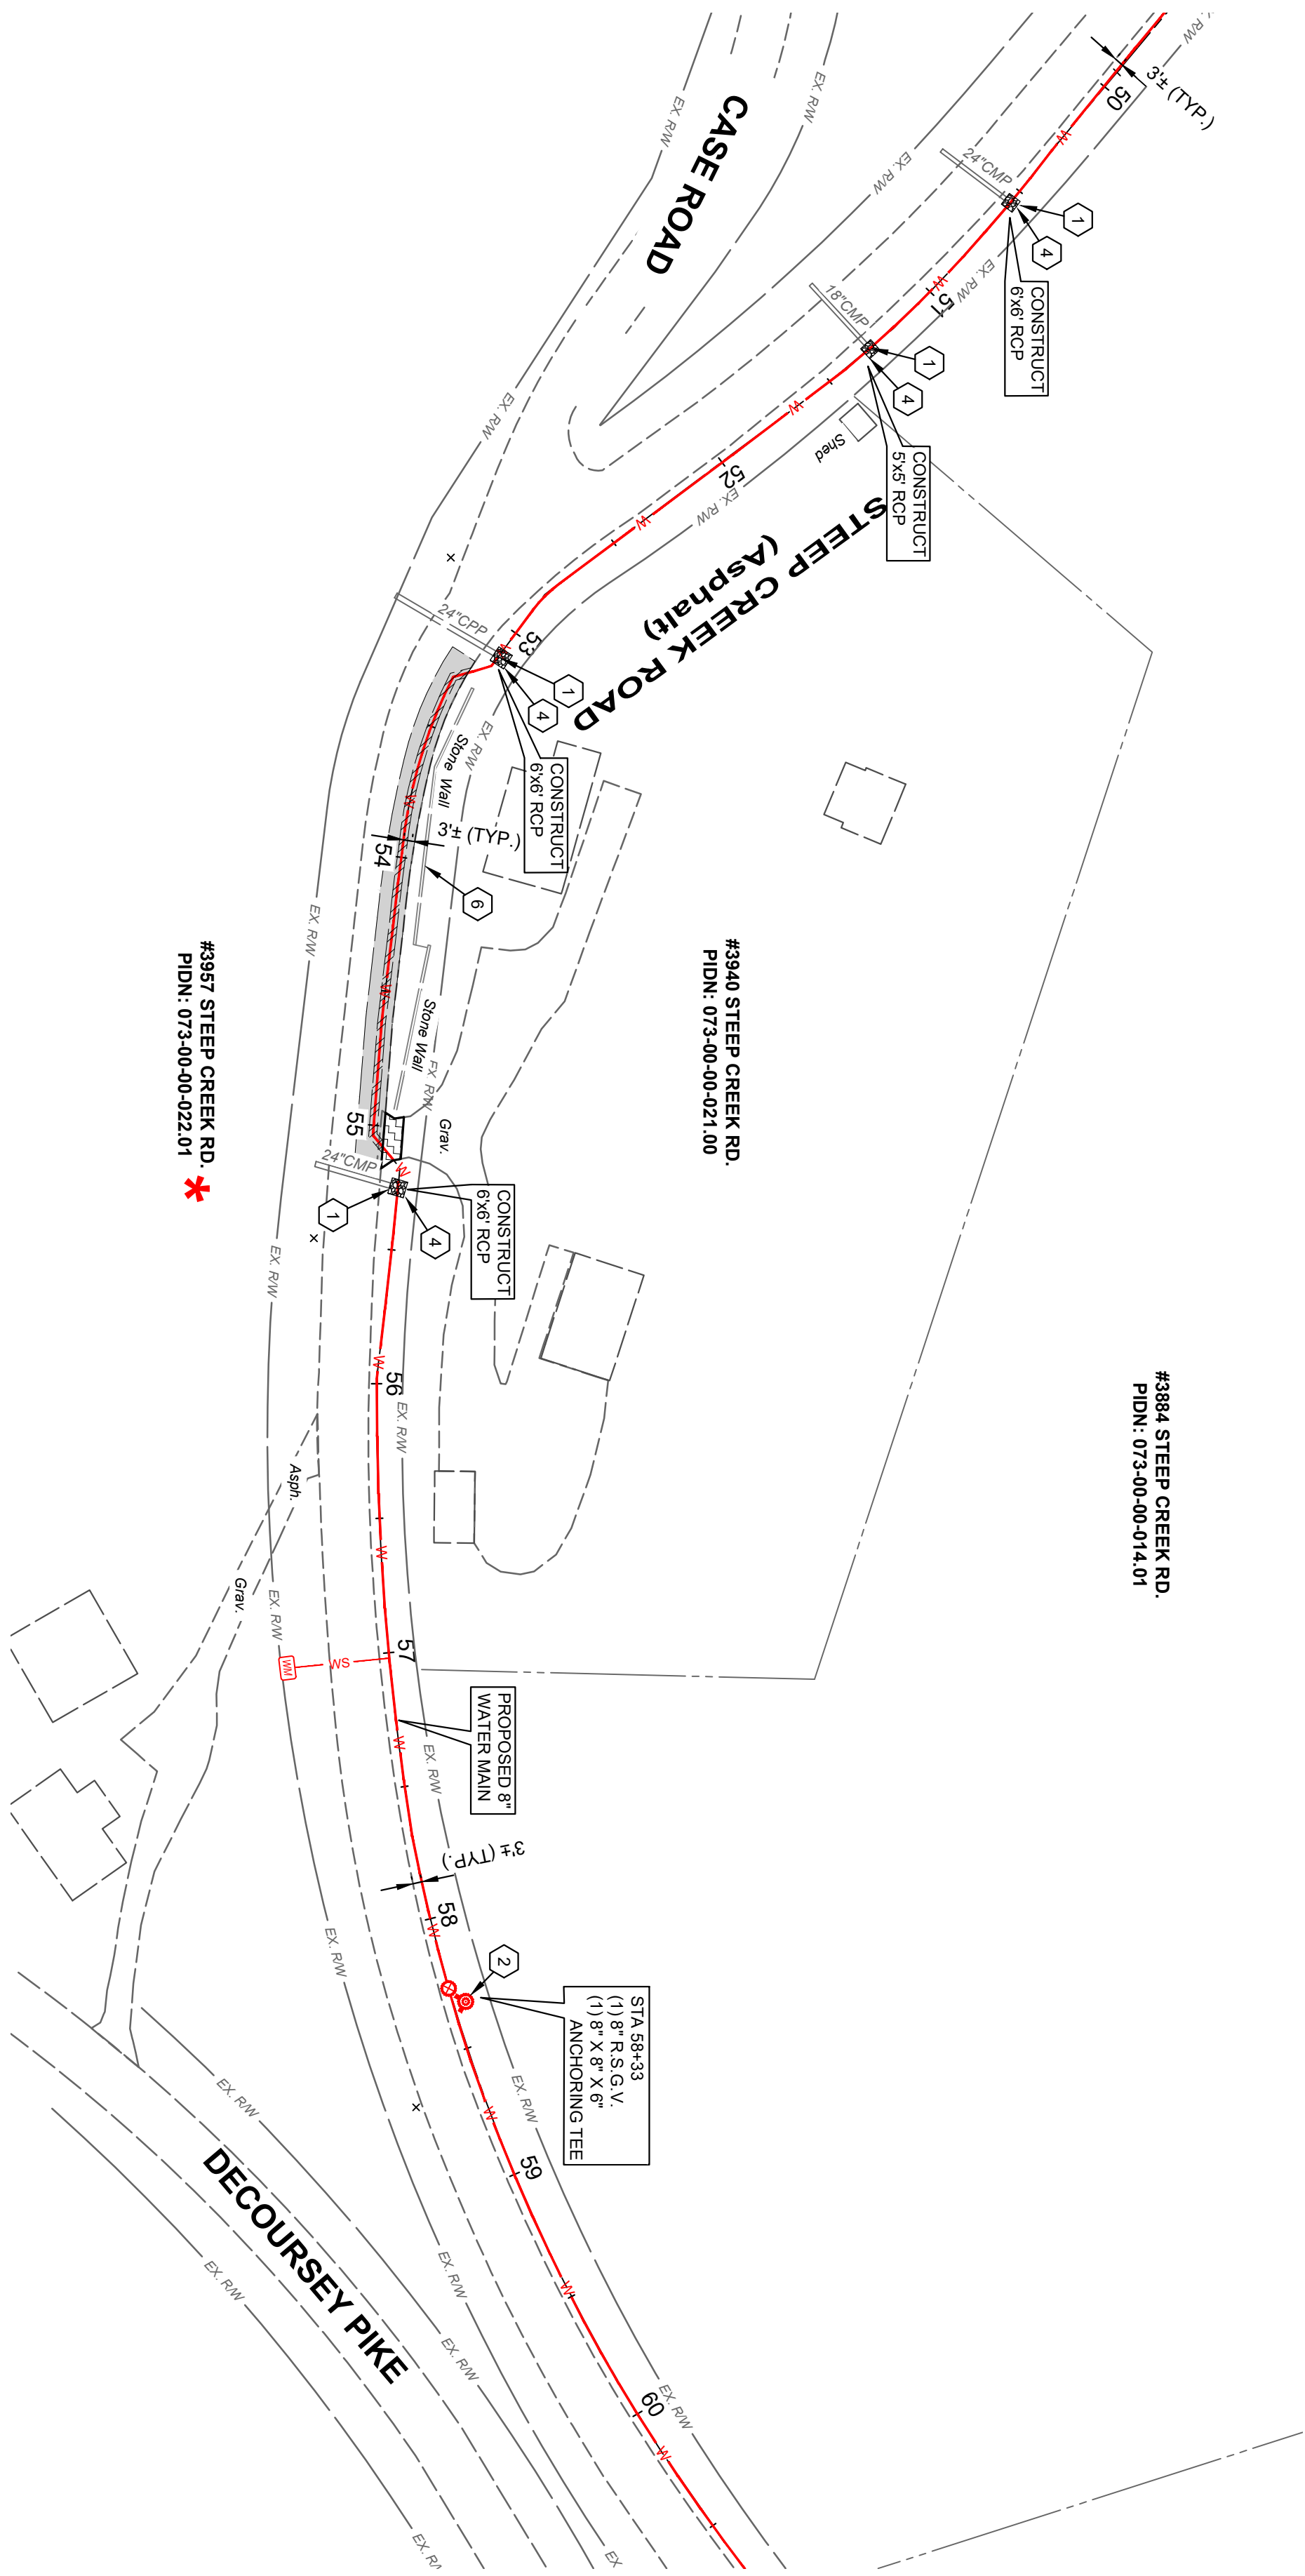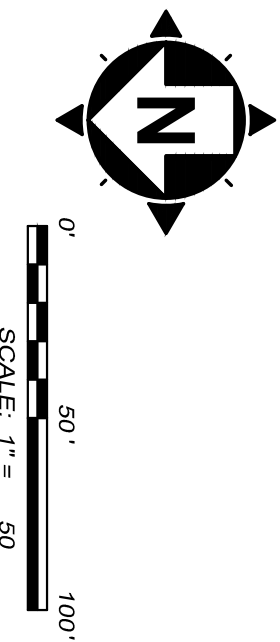2161 CHAMBER CENTER DRIVE
FORT MITCHELL, KENTUCKY 41017
TEL. (859) 525-0544
WWW.VERDANTAS.COM





CONSTRUCTION NOTES

1. MAINTAIN MANAGEABLE VERTICAL CLEARANCE BETWEEN THE PROPOSED WATER MAIN AND THE EXISTING STORM SEWER, WATER MAIN, TELEPHONE AND CABLE LINES. MAINTAIN MINIMUM 18" BETWEEN THE PROPOSED WATER MAIN AND THE EXISTING SANITARY SEWER. ACTUAL ELEVATION UNKNOWN. CONTRACTOR TO EXCAVATE & VERIFY ACTUAL LOCATION, SIZE AND ELEVATION OF EXISTING UTILITY PRIOR TO BEGINNING CONSTRUCTION. CONTRACTOR SHALL NOTIFY THE ENGINEER PRIOR TO CONSTRUCTION OF ANY POTENTIAL CONFLICT. NO ADDITIONAL PAYMENT WILL BE MADE FOR THIS WORK AND THE COST SHALL BE INCLUDED IN THE BID ITEM FOR WATER MAIN.
2. PROPOSED FIRE HYDRANT ASSEMBLY, VALVE AND ANCHORING TEE SHALL BE INSTALLED IN ACCORDANCE WITH THE ANCHOR VALVE TO TEE.
3. CONNECT TO EXISTING WATER MAIN (ACTUAL ELEVATION UNKNOWN). CONTRACTOR TO VERIFY DEPTH PRIOR TO CONSTRUCTION.
4. CHANNEL LINING, CLASS II (18") W/ NON-WOVEN GEOTEXTILE FILTER FABRIC
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6. DO NOT DISTURB
7. CONTRACTOR TO SUPPORT UTILITY POLE DURING PIPE INSTALLATION. (** SEE NOTE)
8. REMOVE AND REPLACE SIGN. (** SEE NOTE)
9. REMOVE AND REPLACE MAILBOX. (** SEE NOTE)
10. INSTALL 5/8" WETER SETTING PER NKWD STD. DWG. NO. 107. INSTALL WATER SERVICE LINE 1/34" TYPE K COPPER) FROM THE PROPOSED WATER MAIN TO THE METER SETTING. MATERIAL WILL BE PROVIDED BY NKWD FOR THIS WORK. UNIT PRICE INCLUDES LABOR, EQUIPMENT, EXCAVATION, BENDING, BACKFILL, AND CONSTRUCTION OF SERVICE LINE. CONTRACTOR TO INSTALL SERVICE LINE AS SHOWN ON PLANS OR DIRECTED BY NKWD IN ACCORDANCE WITH SPECS & STD. DWGS. COMPLETE.
11. REMOVE & REPLACE STORM STRUCTURE (CB, HW) AS NEEDED FOR WATER MAIN INSTALLATION. (** SEE NOTE)
12. DRIVEWAY RESTORATION (SEE DETAIL S)
13. TREE TO BE REMOVED

** NOTE:

WORK FOR THIS ITEM SHALL BE CONSIDERED INCIDENTAL TO THE OVERALL PROJECT AND NO ADDITIONAL PAYMENT SHALL BE MADE FOR THIS WORK. COST SHALL BE INCLUDED IN THE BID ITEM FOR WATER MAIN.

HATCH LEGEND

- 1-1/2" ASPHALT PAVEMENT MILL AND OVERLAY AREA
- TRENCH RESTORATION - ASPHALT PAVEMENT - SEE DETAIL SHEET
- TRENCH RESTORATION - CONCRETE PAVEMENT - SEE DETAIL SHEET
- TRENCH RESTORATION - 8" AGGREGATE PAVEMENT
- CONTROL DENSITY FILL - PAVT TRENCH
- CONCRETE DRIVEWAY REPLACEMENT - SEE DETAIL SHEET
- CONCRETE WALK REPLACEMENT - SEE DETAIL SHEET
- ASPHALT DRIVEWAY REPLACEMENT - SEE DETAIL SHEET
- GRAVEL DRIVEWAY REPLACEMENT - SEE DETAIL SHEET
- CHANNEL LINING, CLASS II - SEE DETAIL SHEET
- * DENOTES PROPERTY WITH NEW SERVICE AND METER SETTING





2161 CHAMBER CENTER DRIVE
FORT MITCHELL, KENTUCKY 41017
TEL: (859) 525-0544
WWW.VERDANTAS.COM


DATE	REVISION	NO	BID	ISSUED FOR:
				APRIL 2025
				AS SHOWN
				JCOR
				JCOR
				JSHU

NORTHERN KENTUCKY WATER DISTRICT
SUBDISTRICT 'O'
-KENTON COUNTY -

MANN ROAD




PROJECT NO.	231591
DISCIPLINE	CIVIL
SHEET NAME	C-10
SHEET	17
OF	28

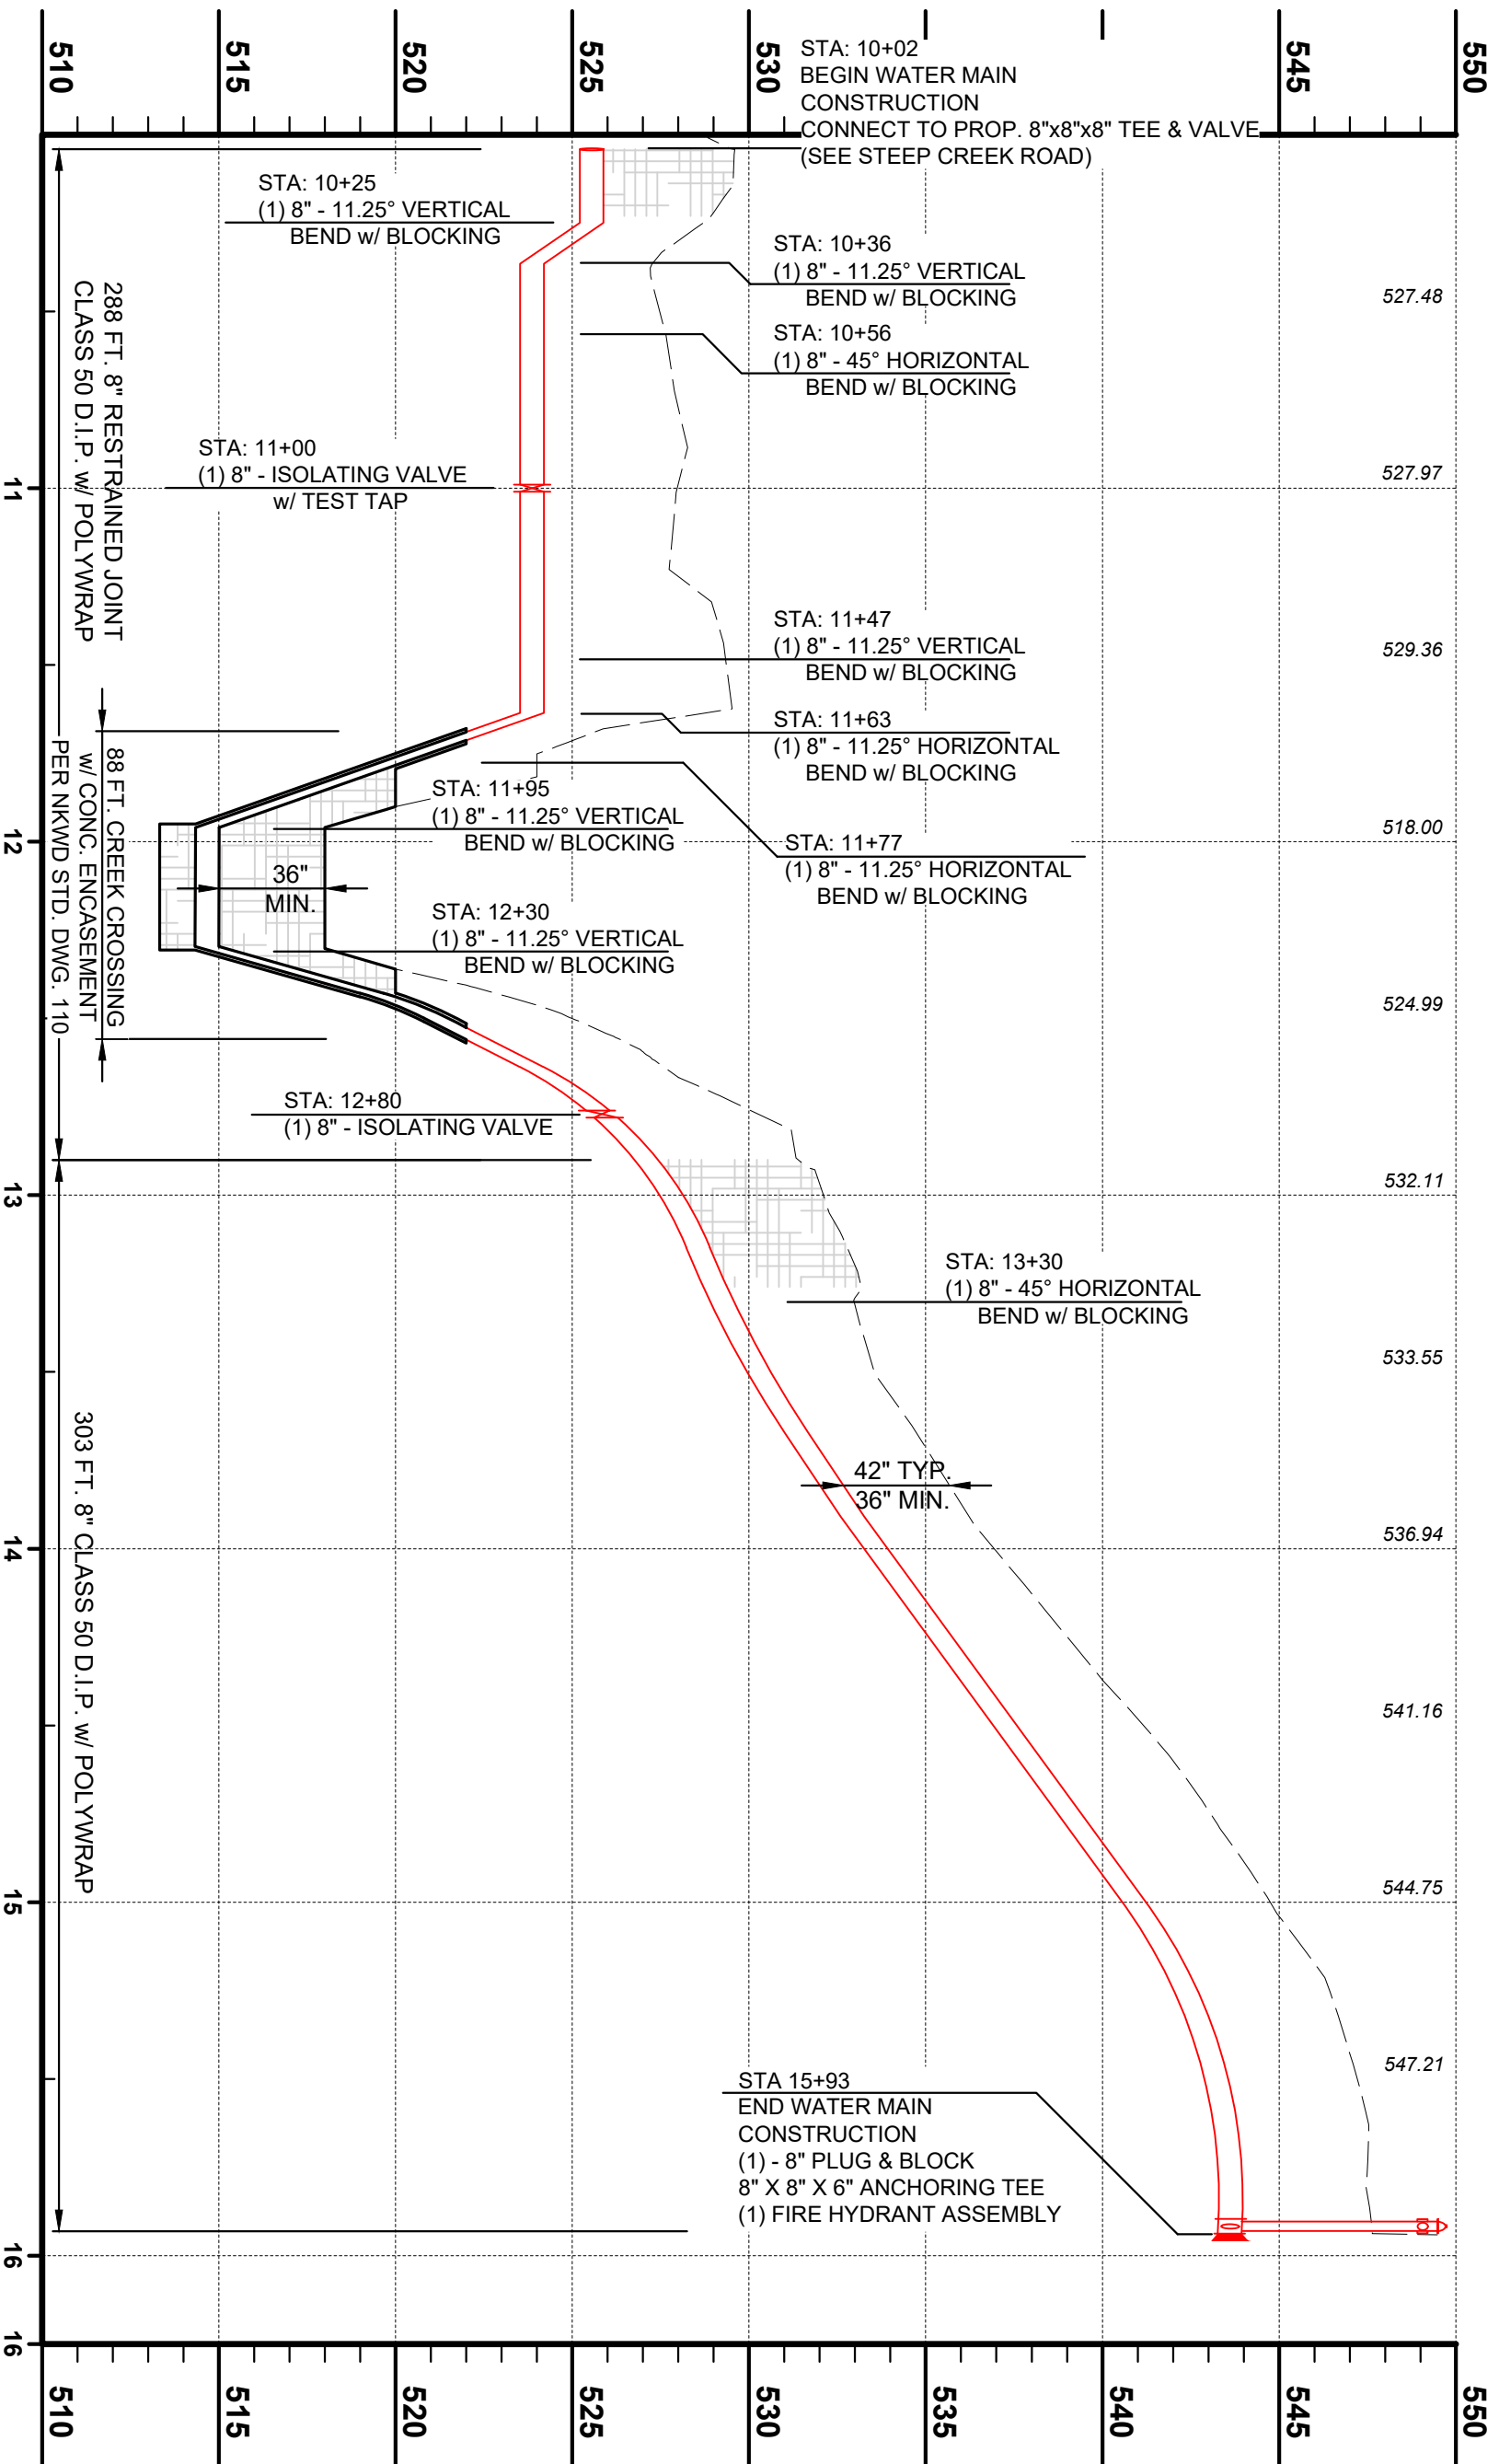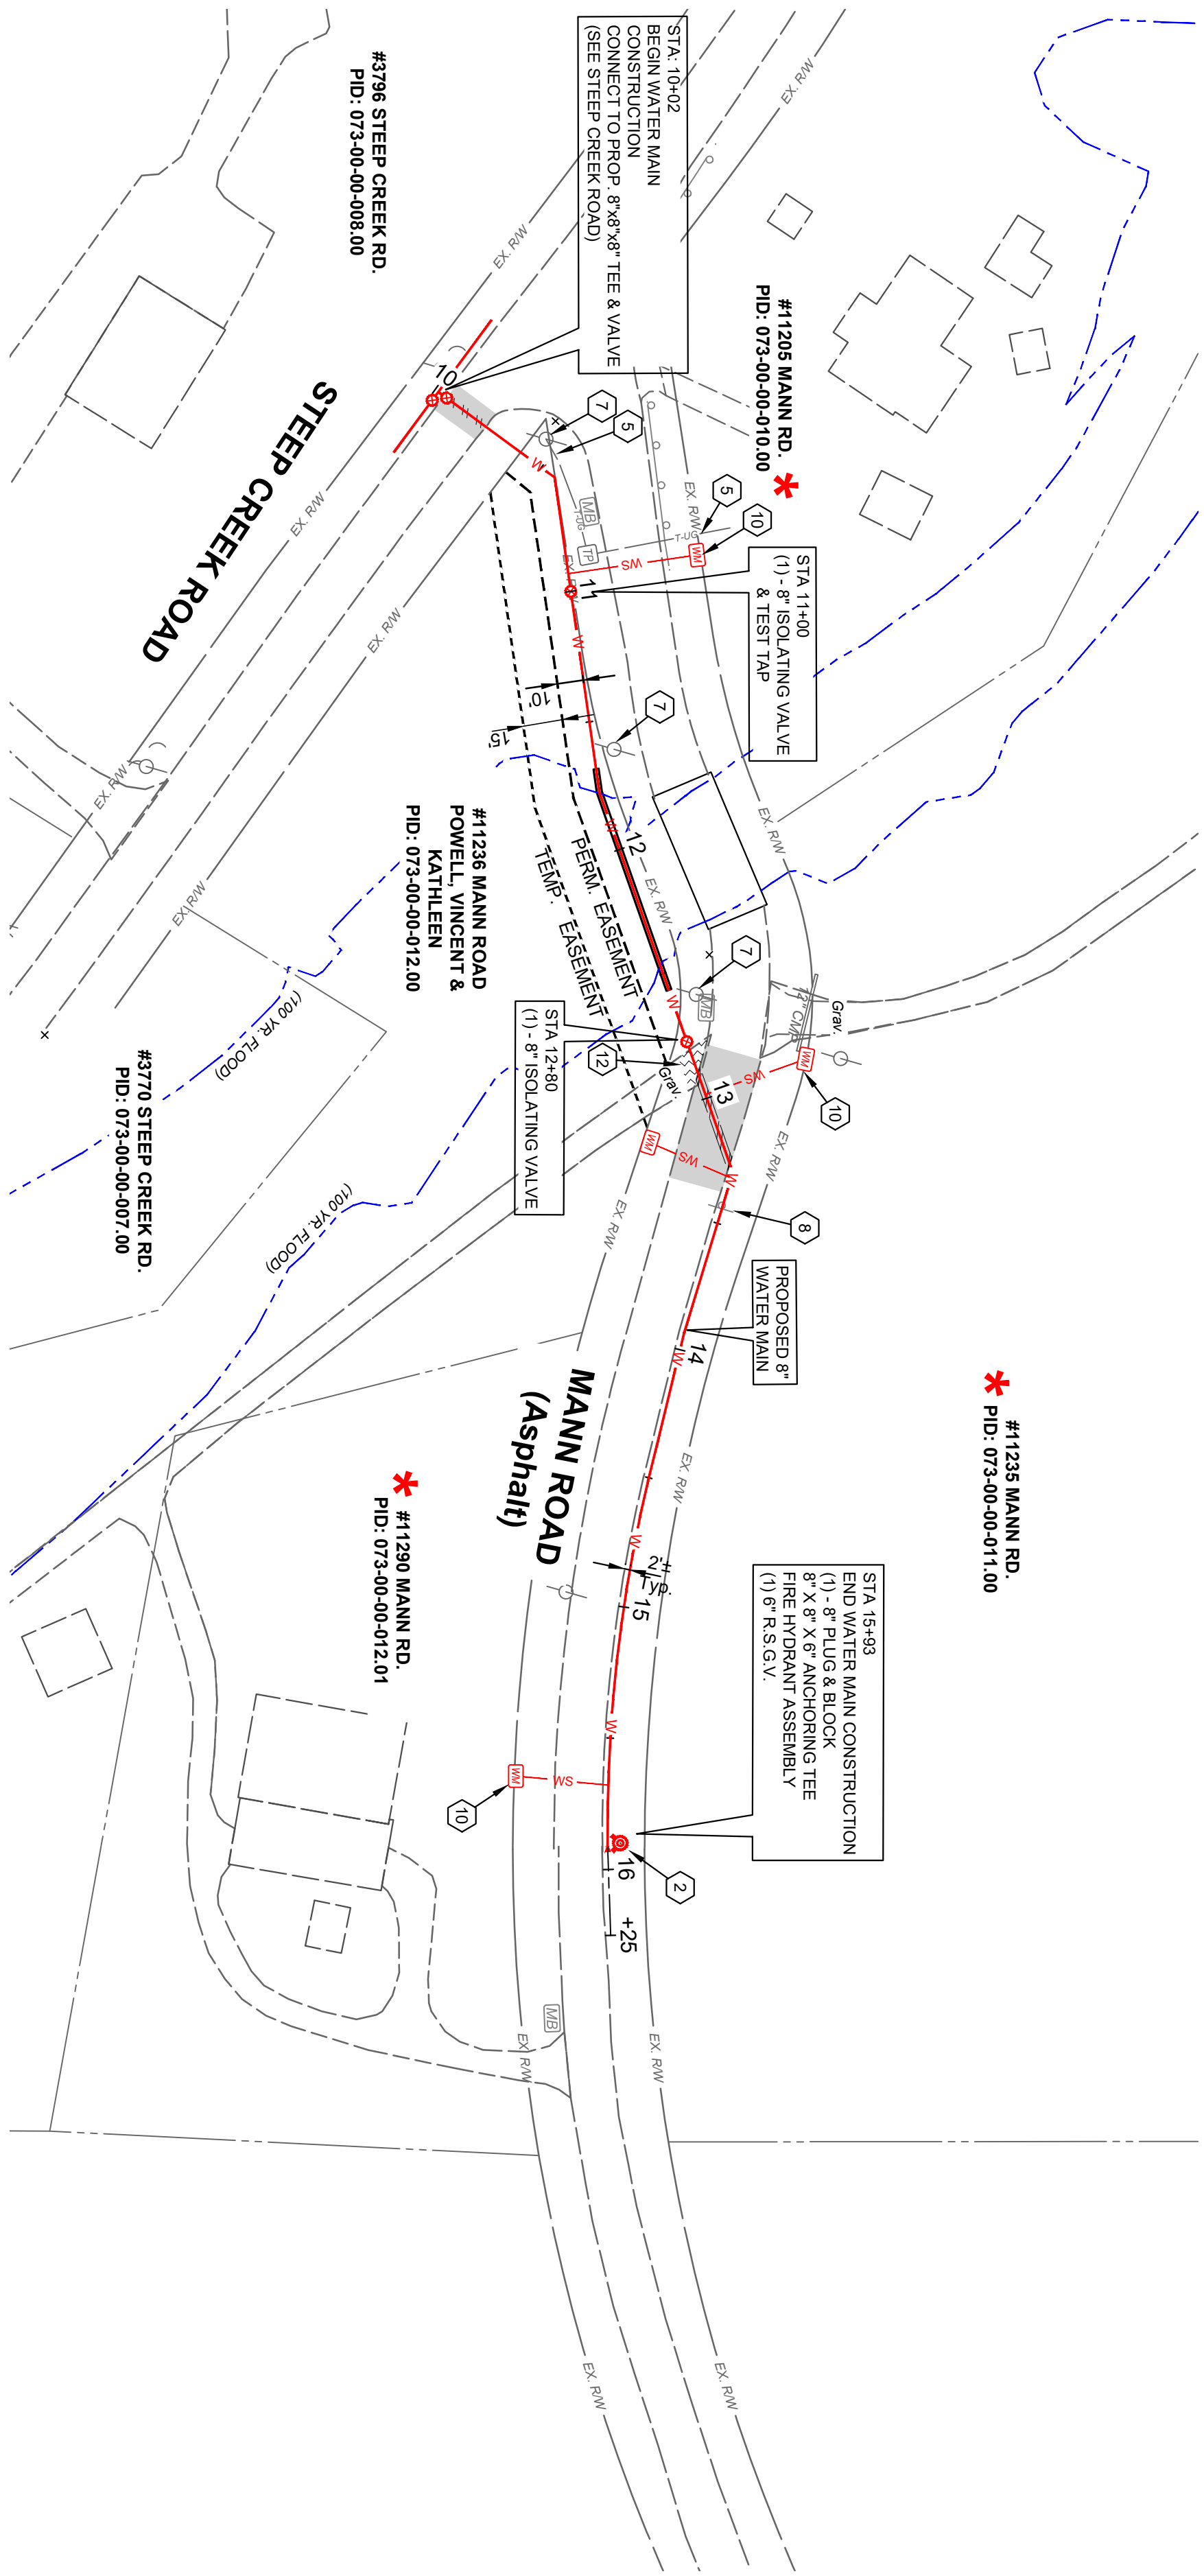

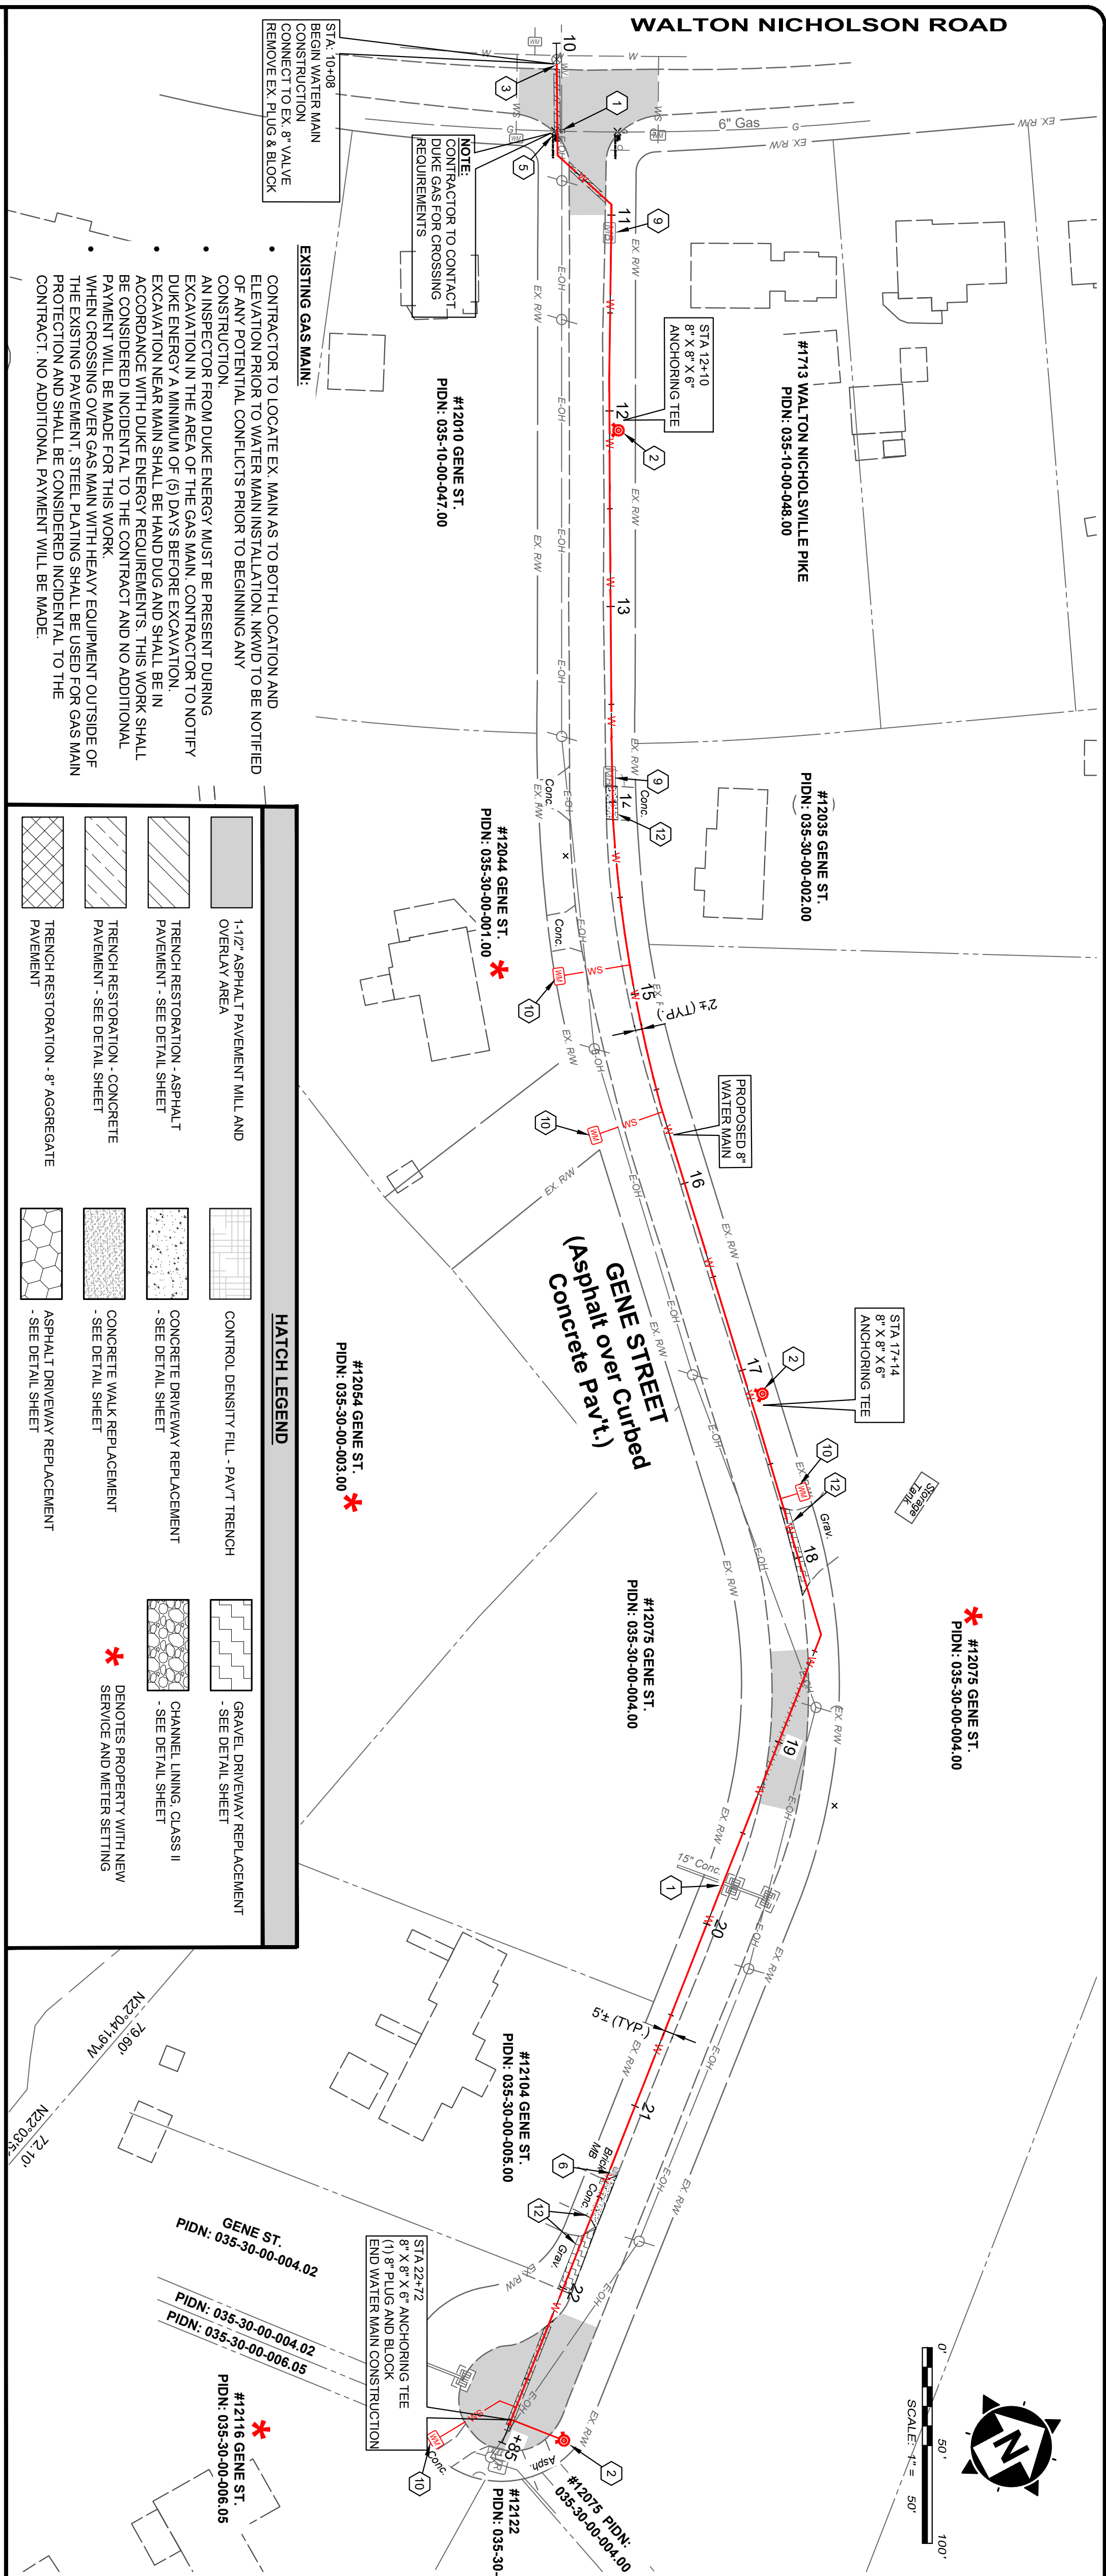

ISSUED FOR:	BID	NO	REVISION	DATE
ISSUE DATE:	APRIL 2025	.	.	.
SCALE:	AS SHOWN			
DESIGNED BY:	JCOR			
DRAWN BY:	JCOR			
CHECKED BY:	JSHU			



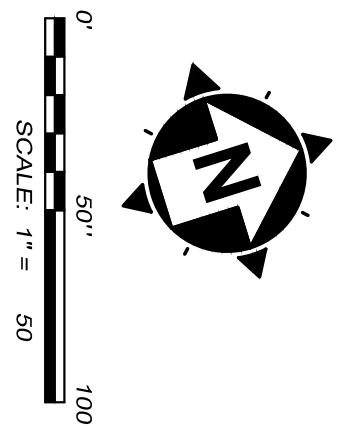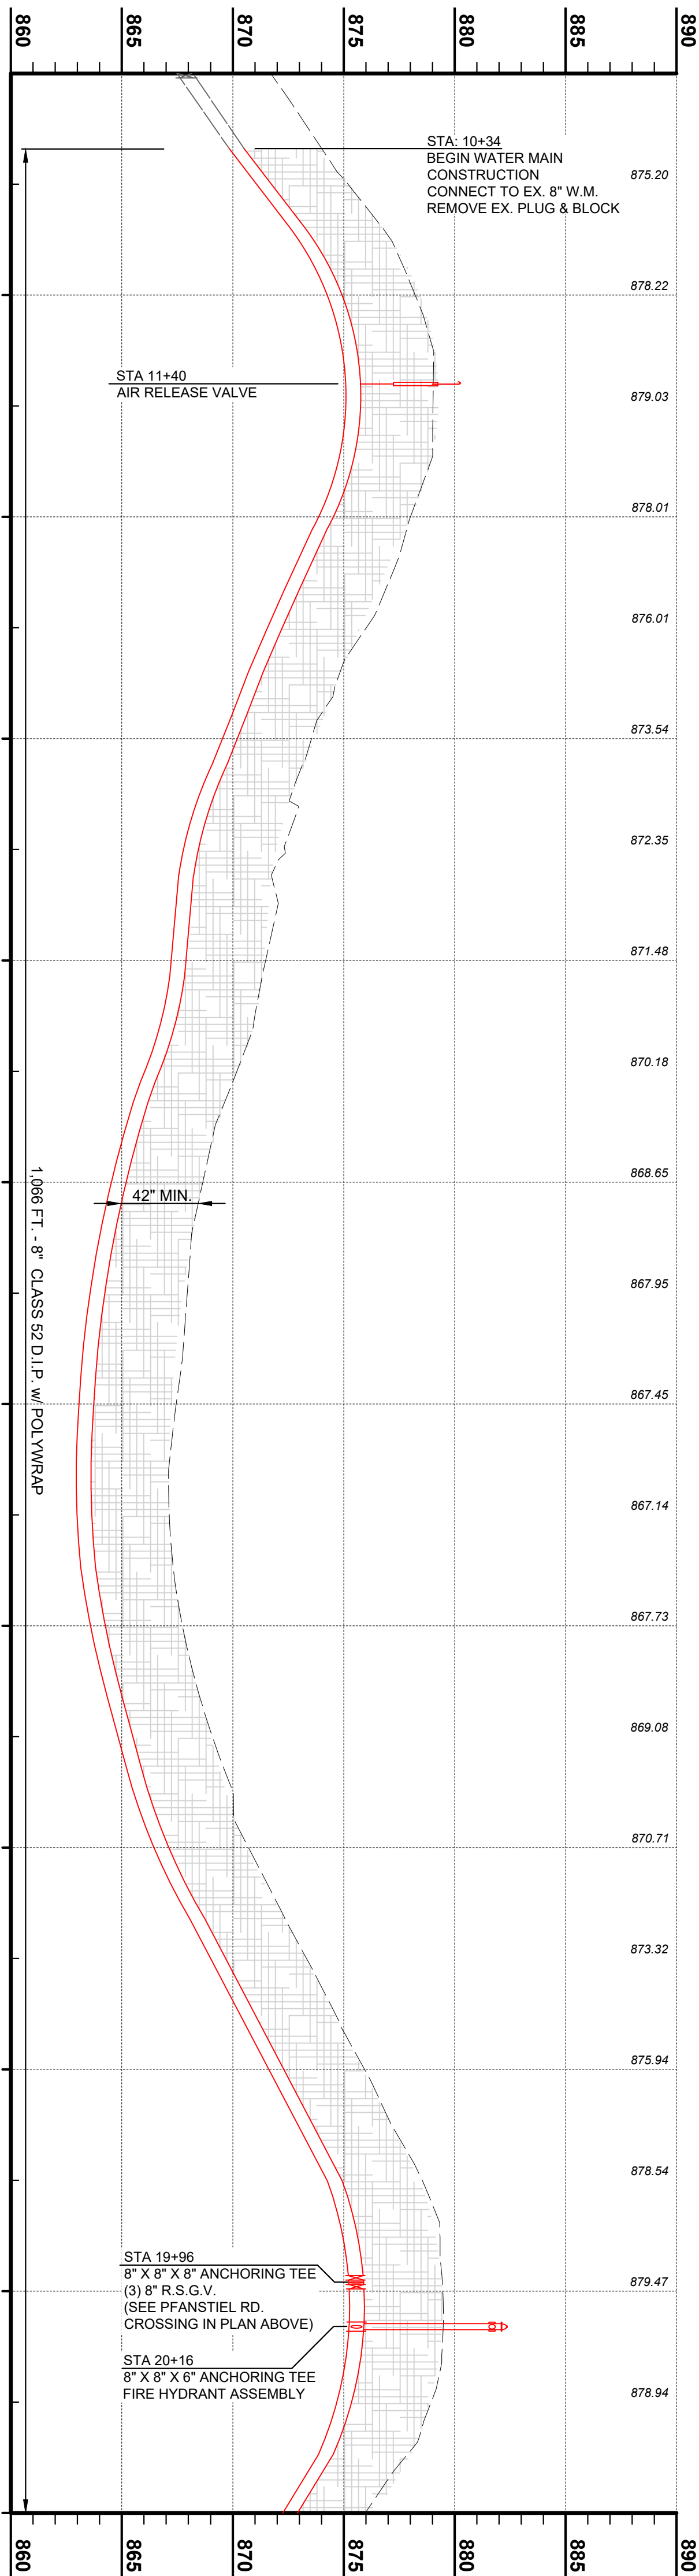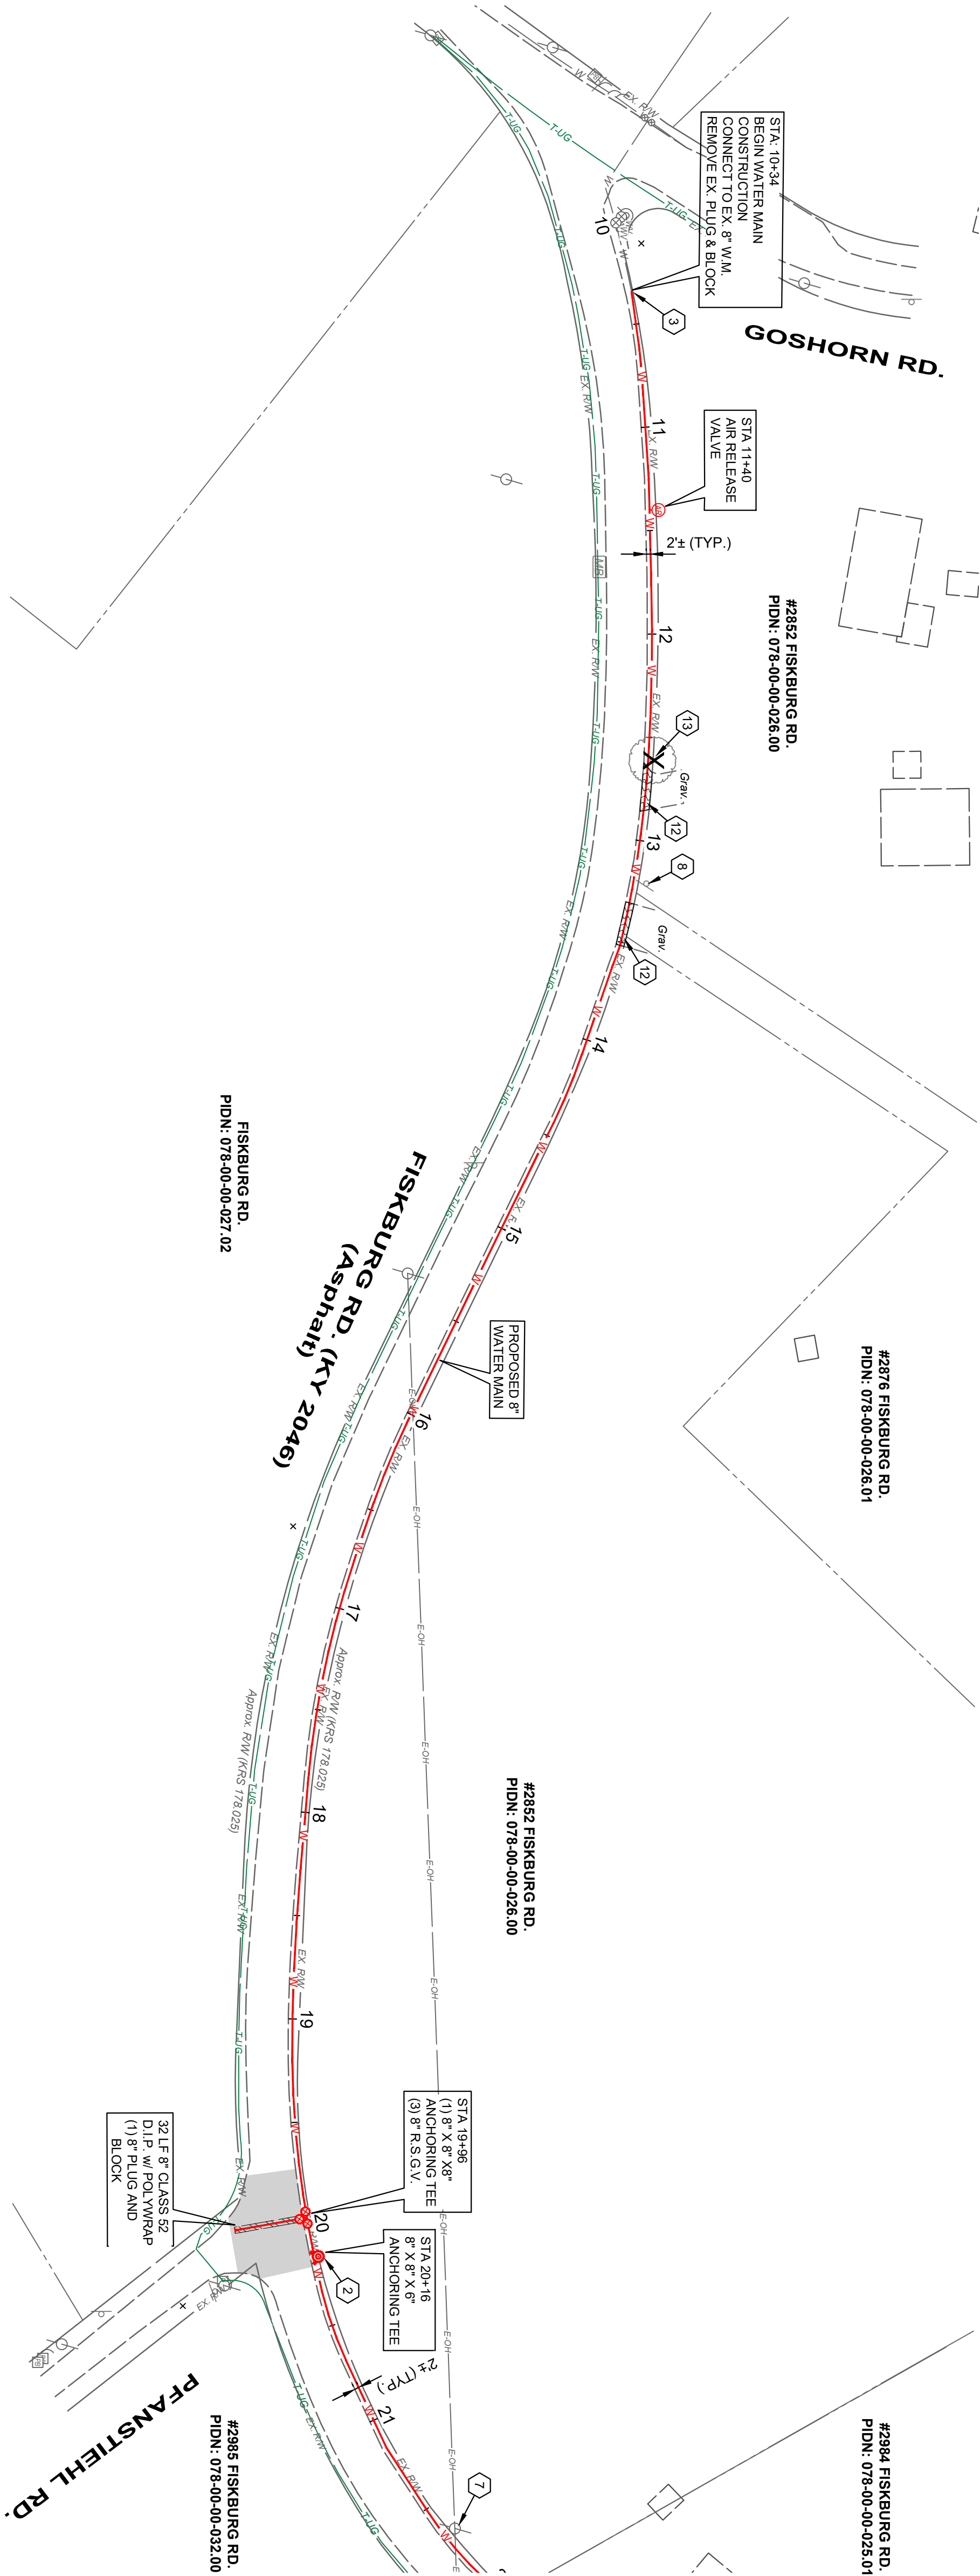

CONSTRUCTION NOTES

- 1 MAINTAIN MANAGEABLE VERTICAL CLEARANCE BETWEEN THE PROPOSED WATER MAIN AND THE EXISTING STORM SEWER WATER MAIN. TELEPHONE DIALING DEPTH SHALL BE MAINTAINED. SEE ITEM 1.14, MAINTAIN MINIMUM 18\"
- 2 PROPOSED FIRE HYDRANT ASSEMBLY, VALVE AND COORDINATE LOCATION WITH N.K.W.D. INSPECTOR. ANCHOR VALVE TO TEE.
- 3 CONNECT TO EXISTING WATER MAIN (ACTUAL ELEVATION UNKNOWN). CONTRACTOR TO VERIFY DEPTH PRIOR TO CONSTRUCTION.
- 4 CHANNEL LINING, CLASS II (18\"
- 5 CONTRACTOR TO VERIFY LOCATION AND ELEVATION OF UTILITY PRIOR TO EXCAVATION ACTIVITY AND NOTIFY ENGINEER AND N.K.W.D. OF CONFLICTS. (* SEE NOTE)
- 6 DO NOT DISTURB
- 7 CONTRACTOR TO SUPPORT UTILITY POLE DURING PIPE INSTALLATION. (* SEE NOTE)
- 8 REMOVE AND REPLACE SIGN (* SEE NOTE)
- 9 REMOVE AND REPLACE MAILBOX (* SEE NOTE)
- 10 INSTALL 5/8\"
- 11 REMOVE & REPLACE STORM STRUCTURE (CB, HW) AS NEEDED FOR WATER MAIN INSTALLATION. (* SEE NOTE)
- 12 DRIVEWAY RESTORATION (SEE DETAILS)
- 13 TREE TO BE REMOVED

NOTE:

WORK FOR THIS ITEM SHALL BE CONSIDERED INCIDENTAL TO THE OVERALL PROJECT AND NO ADDITIONAL PAYMENT SHALL BE MADE FOR THIS WORK. COST SHALL BE INCLUDED IN THE BID ITEM FOR WATER MAIN.

HATCH LEGEND

- 1-1/2\"
- TRENCH RESTORATION - ASPHALT PAVEMENT - SEE DETAIL SHEET
- TRENCH RESTORATION - CONCRETE PAVEMENT - SEE DETAIL SHEET
- TRENCH RESTORATION - 8\"
- CONTROL DENSITY FILL - PAVT TRENCH
- CONCRETE DRIVEWAY REPLACEMENT - SEE DETAIL SHEET
- CONCRETE WALK REPLACEMENT - SEE DETAIL SHEET
- ASPHALT DRIVEWAY REPLACEMENT - SEE DETAIL SHEET
- GRAVEL DRIVEWAY REPLACEMENT - SEE DETAIL SHEET
- CHANNEL LINING, CLASS II - SEE DETAIL SHEET
- * DENOTES PROPERTY WITH NEW SERVICE AND METER SETTING

2161 CHAMBER CENTER DRIVE
FORT MITCHELL, KENTUCKY 41017
TEL. (859) 525-0544
WWW.VERDANTAS.COM

DATE	REVISION	NO	BID	ISSUED FOR:
			APRIL 2025	ISSUE DATE:
			AS SHOWN	SCALE:
			JCOR	DESIGNED BY:
			JCOR	DRAWN BY:
			JSHU	CHECKED BY:

NORTHERN KENTUCKY WATER DISTRICT
SUBDISTRICT 'O'
-KENTON COUNTY -

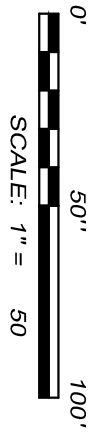
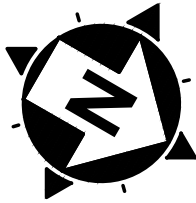
FISKBURG ROAD
STA. 10+00 TO STA. 21+00

PROJECT NO.
231591

DISCIPLINE
CIVIL

SHEET NAME
C-12

SHEET
19 OF 28



CONSTRUCTION NOTES

- 1 MAINTAIN MANAGEABLE VERTICAL CLEARANCE BETWEEN THE PROPOSED WATER MAIN AND THE EXISTING STORM SEWER WATER MAIN. TELEPHONE DUCTS SHALL BE MAINTAINED UNDER EXISTING SEWER CROSSINGS PER N.K.W.D. SPECIFICATIONS ITEM 1-14. MAINTAIN MINIMUM 18" BETWEEN THE PROPOSED WATER MAIN AND THE EXISTING SANITARY SEWER. ACTUAL ELEVATION UNKNOWN. CONTRACTOR TO EXCAVATE & VERIFY ACTUAL LOCATION, SIZE AND ELEVATION OF EXISTING UTILITY PRIOR TO BEGINNING WATER MAIN CONSTRUCTION. CONTRACTOR SHALL NOTIFY THE ENGINEER PRIOR TO CONSTRUCTION OF ANY POTENTIAL CONFLICT. NO ADDITIONAL PAYMENT WILL BE MADE FOR THIS WORK AND THE COST SHALL BE INCLUDED IN THE BID ITEM FOR WATER MAIN.
- 2 PROPOSED FIRE HYDRANT ASSEMBLY, VALVE AND ANCHOR VALVE TO TEE. COORDINATE LOCATION WITH N.K.W.D. INSPECTOR.
- 3 CONNECT TO EXISTING WATER MAIN (ACTUAL ELEVATION UNKNOWN). CONTRACTOR TO VERIFY DEPTH PRIOR TO CONSTRUCTION.
- 4 CHANNEL LINING, CLASS II (18") W/ NON-WOVEN GEOTEXTILE FILTER FABRIC
- 5 CONTRACTOR TO VERIFY LOCATION AND ELEVATION OF UTILITY PRIOR TO EXCAVATION ACTIVITY AND NOTIFY ENGINEER AND N.K.W.D. OF CONFLICTS. (** SEE NOTE)
- 6 DO NOT DISTURB
- 7 CONTRACTOR TO SUPPORT UTILITY POLE DURING PIPE INSTALLATION. (** SEE NOTE)
- 8 REMOVE AND REPLACE SIGN. (** SEE NOTE)
- 9 REMOVE AND REPLACE MAILBOX. (** SEE NOTE)
- 10 INSTALL 56" R/W METER SETTING PER N.K.W.D. STD. DWG. NO. 107. INSTALL WATER SERVICE LINE (3/4" TYPE K COPPER) FROM THE PROPOSED WATER MAIN TO THE METER SETTING. MATERIAL WILL BE PROVIDED BY N.K.W.D. FOR THIS WORK. UNIT PRICE INCLUDES LABOR, EQUIPMENT, EXCAVATION, BEDDING, BACKFILL, AND FINISH. CONTRACTOR TO VERIFY LOCATION AND ELEVATION OF UTILITY PRIOR TO EXCAVATION ACTIVITY AND NOTIFY ENGINEER AND N.K.W.D. OF CONFLICTS. (** SEE NOTE)
- 11 REMOVE & REPLACE STORM STRUCTURE (CB HW) AS NEEDED FOR WATER MAIN INSTALLATION. (** SEE NOTE)
- 12 DRIVEWAY RESTORATION (SEE DETAIL S)
- 13 TREE TO BE REMOVED

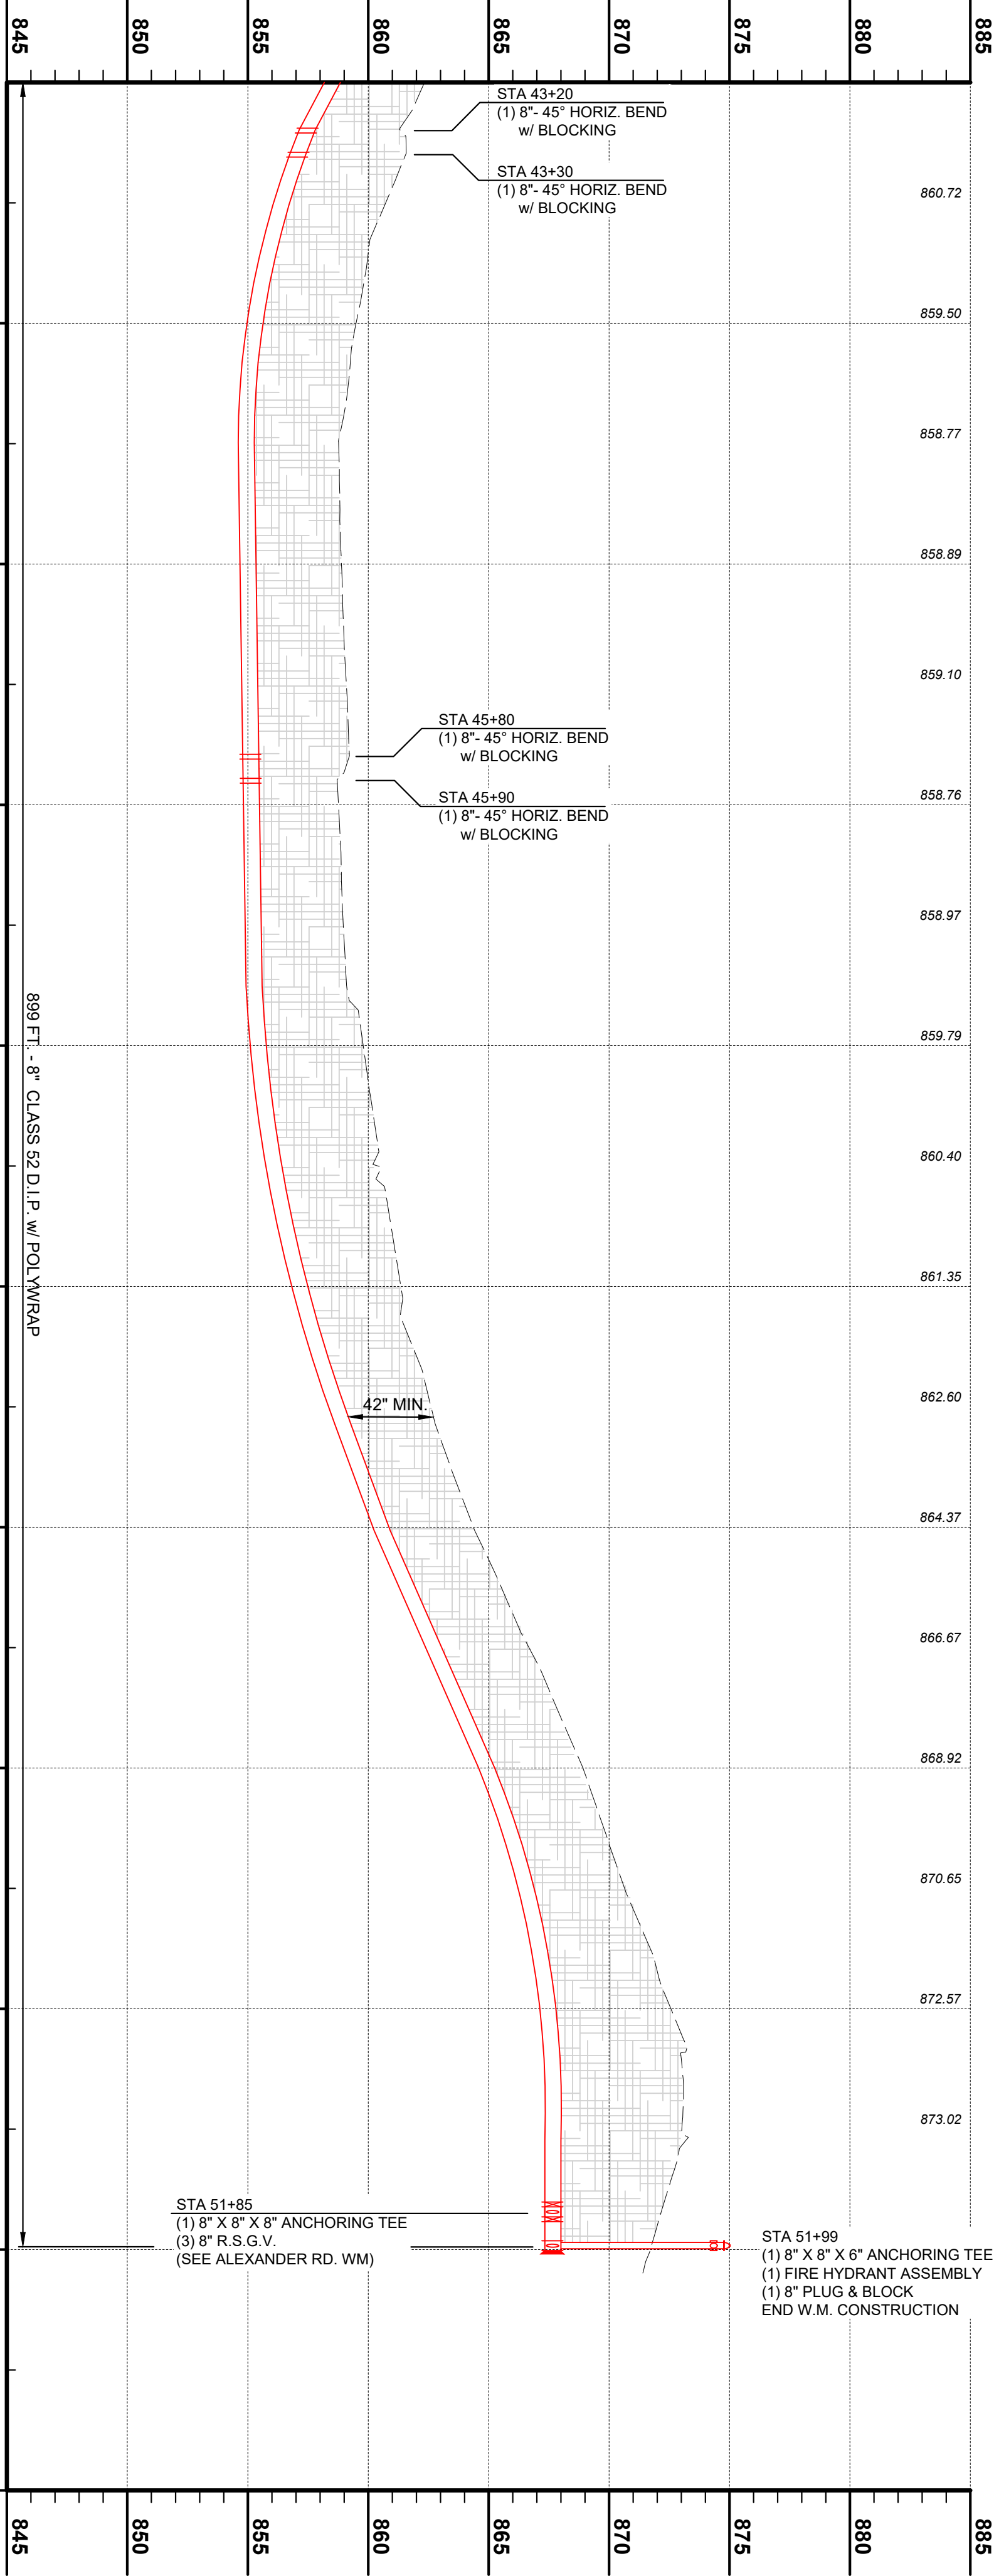
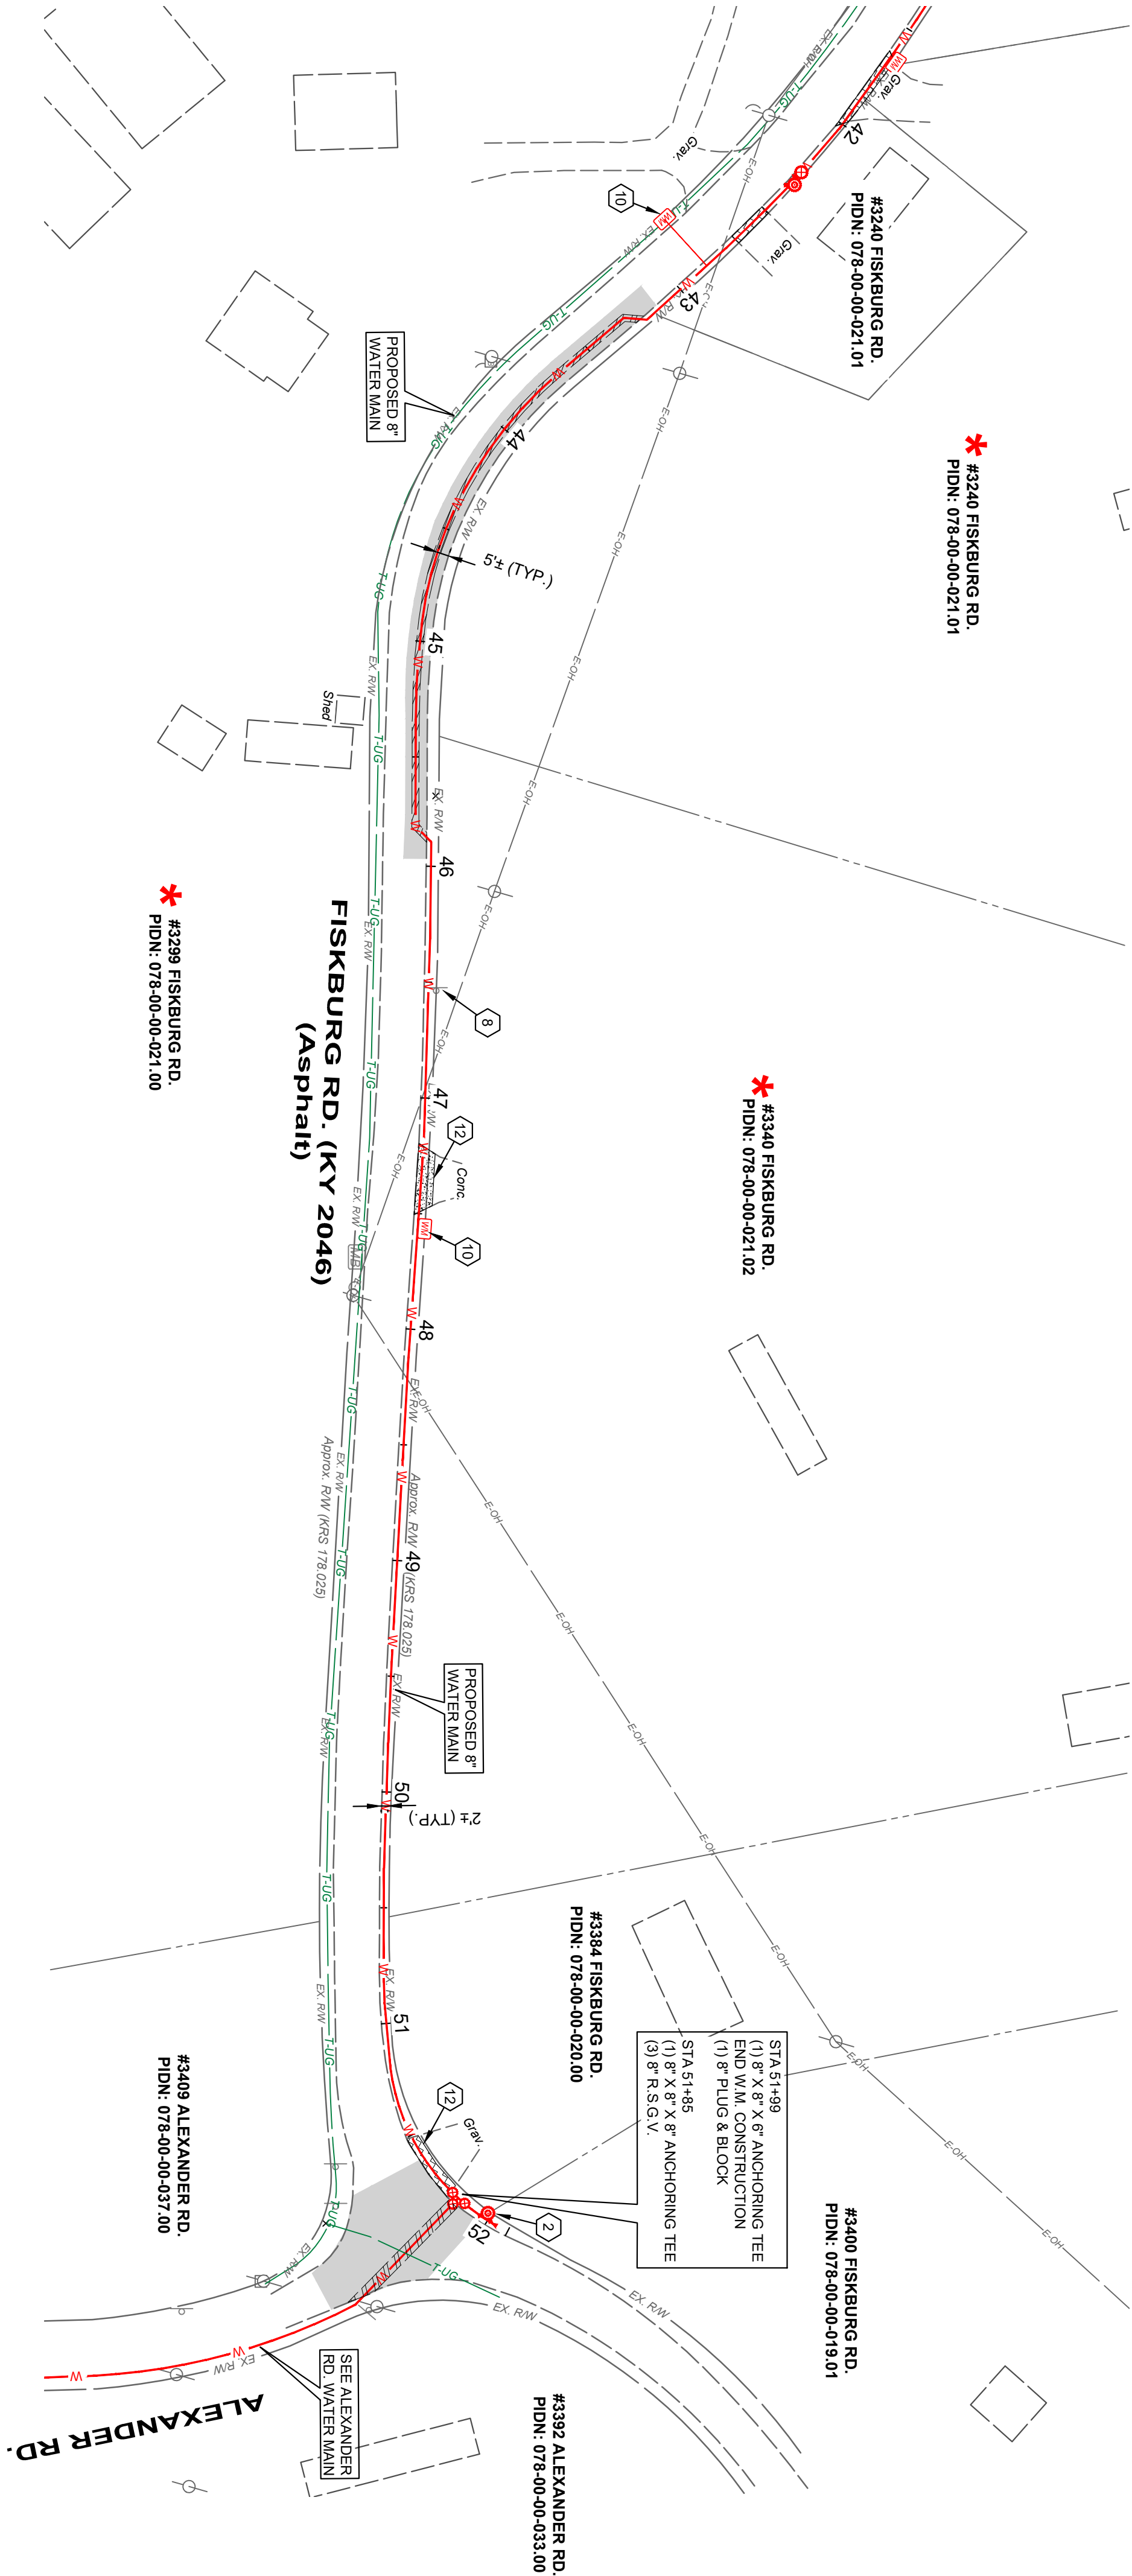
NOTE:

WORK FOR THIS ITEM SHALL BE CONSIDERED INCIDENTAL TO THE OVERALL PROJECT AND NO ADDITIONAL PAYMENT SHALL BE MADE FOR THIS WORK. COST SHALL BE INCLUDED IN THE BID ITEM FOR WATER MAIN.

HATCH LEGEND

- 1-1/2" ASPHALT PAVEMENT MILL AND OVERLAY AREA
- TRENCH RESTORATION - ASPHALT PAVEMENT - SEE DETAIL SHEET
- TRENCH RESTORATION - CONCRETE PAVEMENT - SEE DETAIL SHEET
- TRENCH RESTORATION - 8" AGGREGATE PAVEMENT
- CONTROL DENSITY FILL - PAVT TRENCH
- CONCRETE DRIVEWAY REPLACEMENT - SEE DETAIL SHEET
- CONCRETE WALK REPLACEMENT - SEE DETAIL SHEET
- ASPHALT DRIVEWAY REPLACEMENT - SEE DETAIL SHEET
- GRAVEL DRIVEWAY REPLACEMENT - SEE DETAIL SHEET
- CHANNEL LINING, CLASS II - SEE DETAIL SHEET

* DENOTES PROPERTY WITH NEW SERVICE AND METER SETTING



NORTHERN KENTUCKY WATER DISTRICT
SUBDISTRICT 'O'
-KENTON COUNTY -


FISKBURG ROAD
STA. 43+00 TO STA. 52+27

PROJECT NO.	231591
DISCIPLINE	CIVIL
SHEET NAME	C-15
SHEET	22
OF	28

verdantas

2161 CHAMBER CENTER DRIVE
FORT MITCHELL, KENTUCKY 41017
TEL. (859) 525-0544
WWW.VERDANTAS.COM

DATE	REVISION	NO	BID	ISSUED FOR:
			APRIL 2025	ISSUE DATE:
			AS SHOWN	SCALE:
			JCOR	DESIGNED BY:
			JCOR	DRAWN BY:
			JSHU	CHECKED BY:



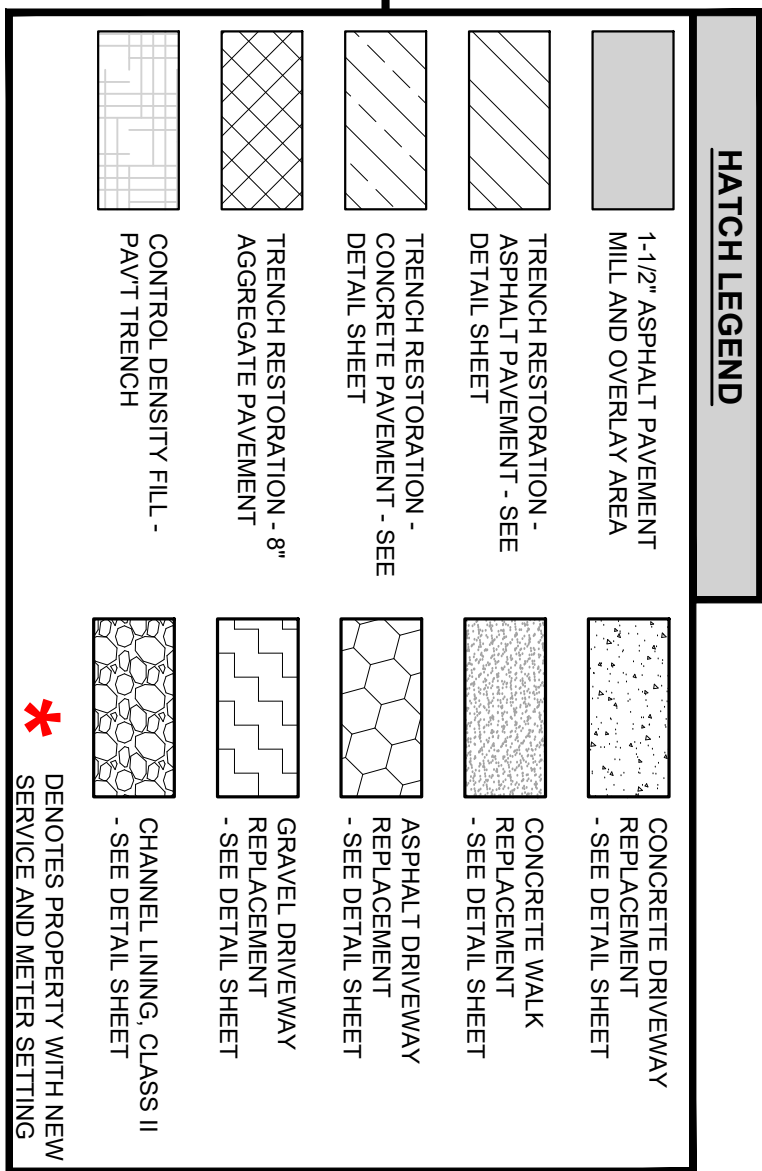


CONSTRUCTION NOTES

NORTHERN KENTUCKY WATER DISTRICT
SUBDISTRICT 'O'
-KENTON COUNTY -

ALEXANDER ROAD
STA. 10+00 TO STA. 23+00

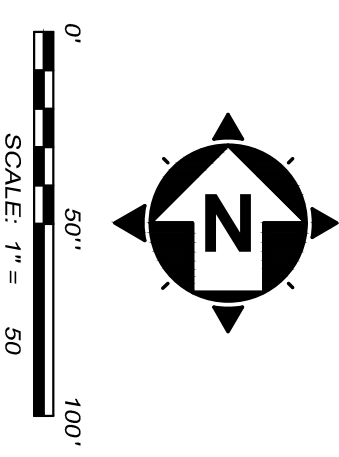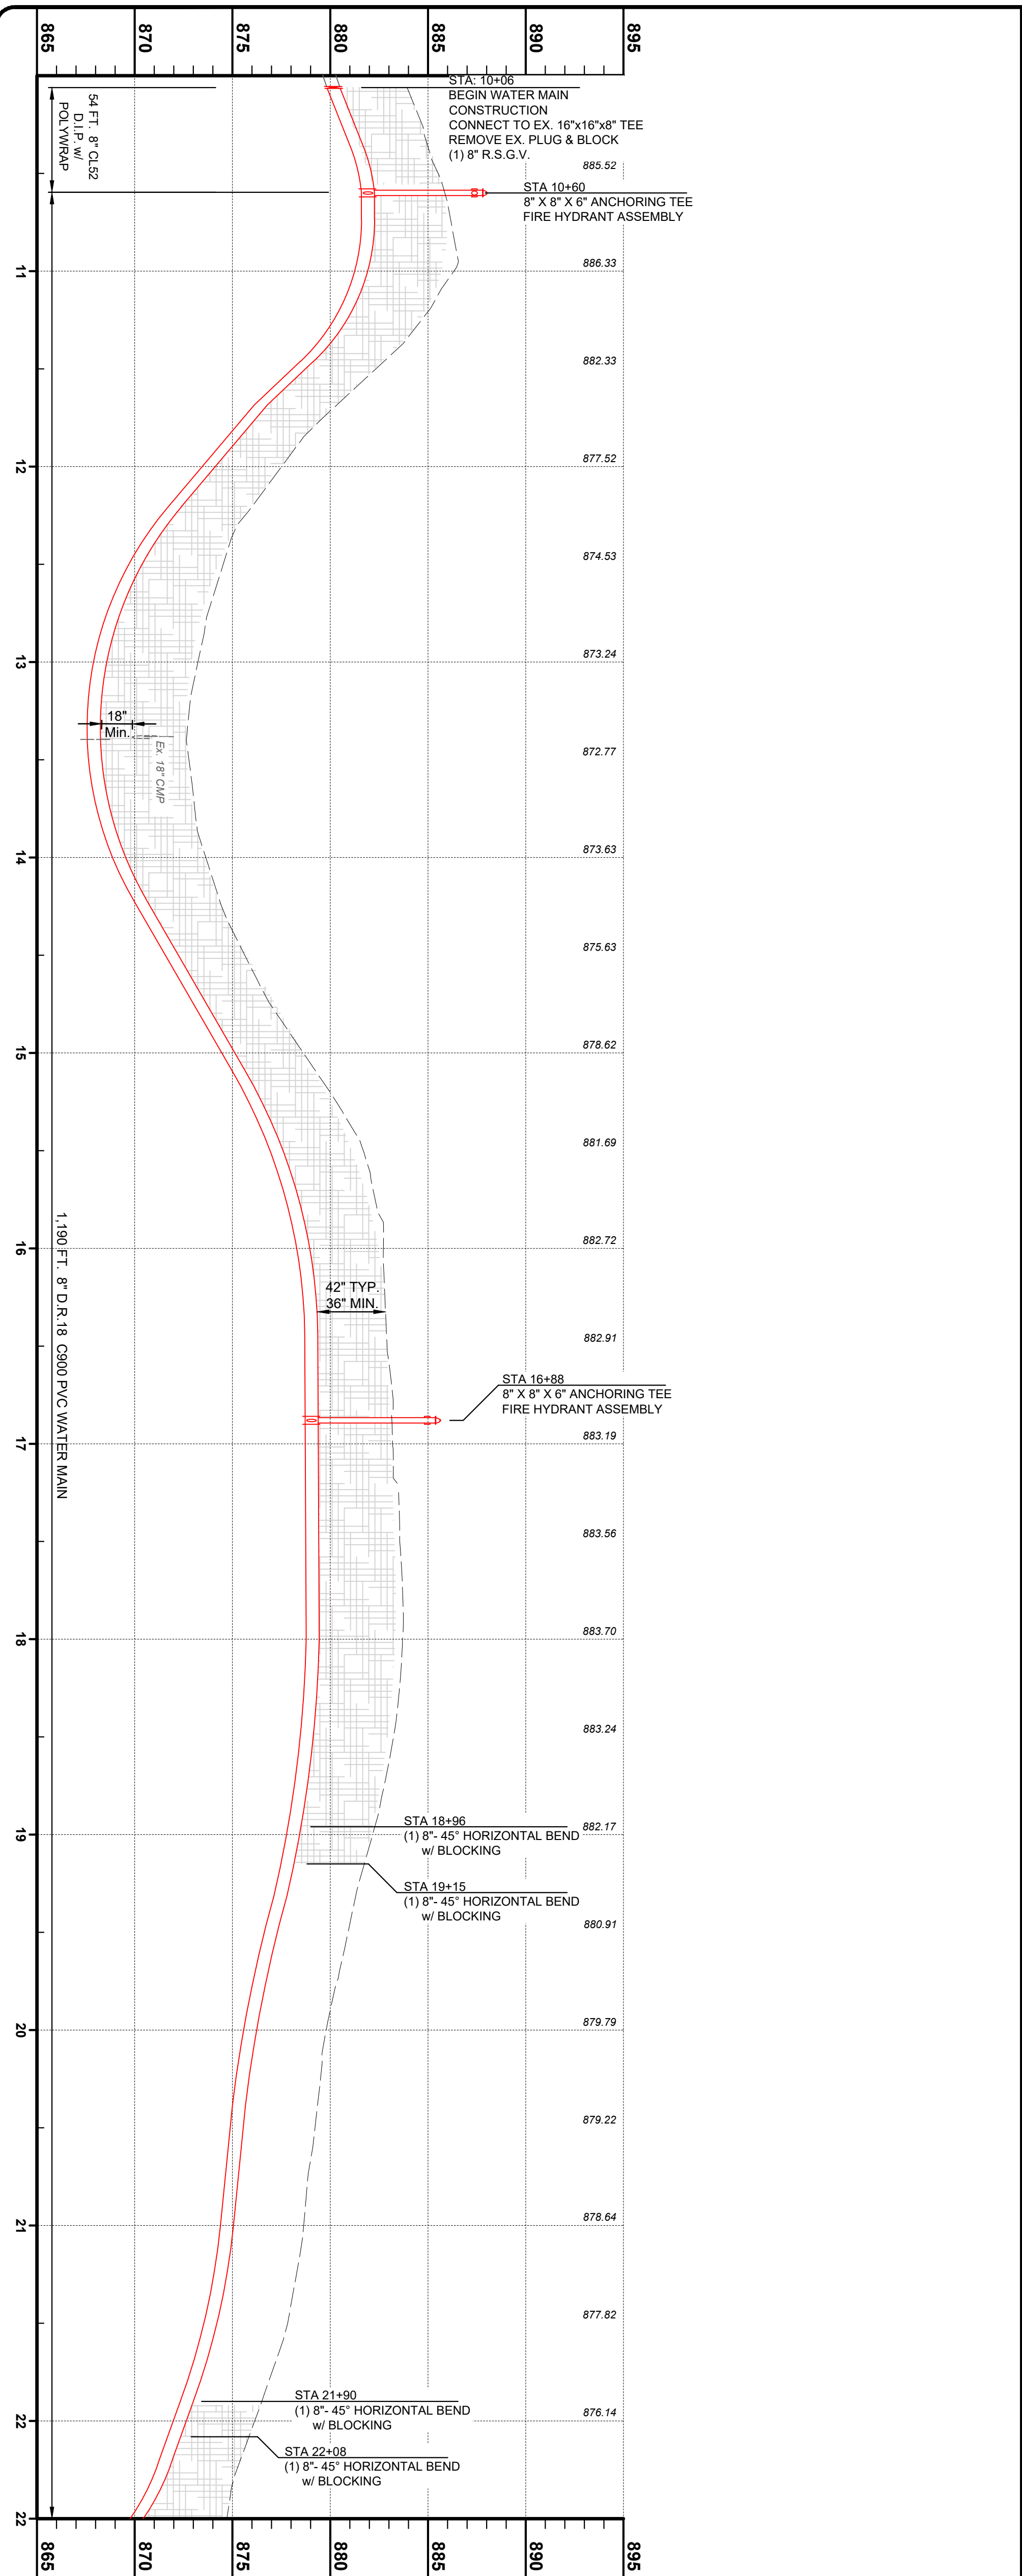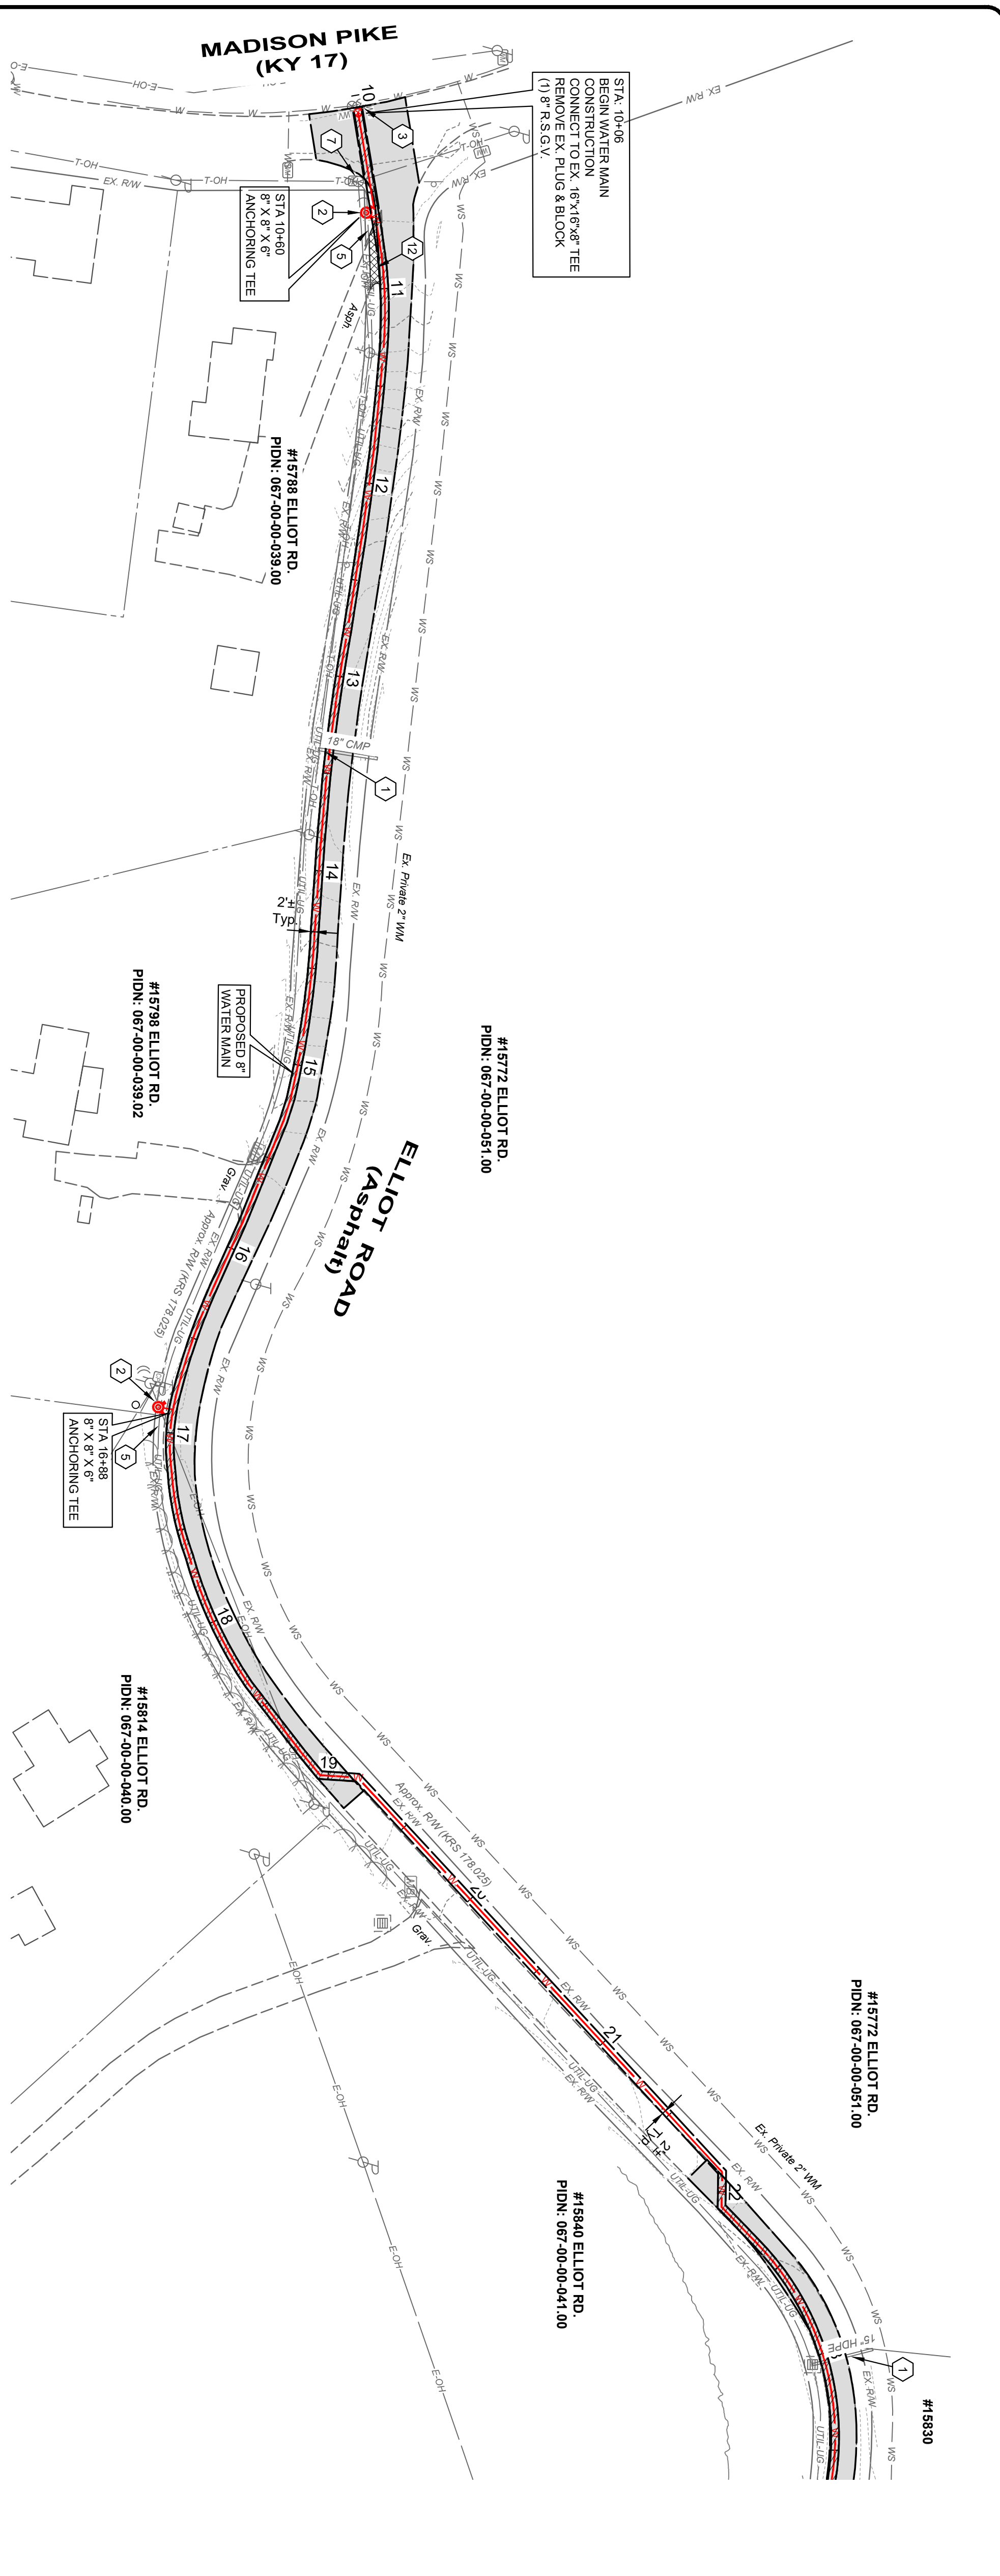**ALEXANDER ROAD
STA. 10+00 TO STA. 23+00**



CONSTRUCTION NOTES

- 1 MAINTAIN MANAGEABLE VERTICAL CLEARANCE BETWEEN THE PROPOSED WATER MAIN AND THE EXISTING STORM SEWER WATER MAIN. TELEPHONE POLES SHALL BE MAINTAINED AT EXISTING LOCATIONS. SEWER CROSSINGS PER N.K.W.D. SPECIFICATIONS ITEM 1.14. MAINTAIN MINIMUM 18" BETWEEN THE PROPOSED WATER MAIN AND THE EXISTING SANITARY SEWER. ACTUAL ELEVATION UNKNOWN. CONTRACTOR TO EXCAVATE & VERIFY ACTUAL LOCATION, SIZE AND ELEVATION OF EXISTING UTILITY PRIOR TO BEGINNING CONSTRUCTION. CONTRACTOR SHALL VERIFY THE EXISTING UTILITY PRIOR TO BEGINNING CONSTRUCTION OF ANY POTENTIAL CONFLICT. NO ADDITIONAL PAYMENT WILL BE MADE FOR THIS WORK AND THE COST SHALL BE INCLUDED IN THE BID ITEM FOR WATER MAIN.
- 2 PROPOSED FIRE HYDRANT ASSEMBLY, VALVE AND COORDINATE LOCATION WITH N.K.W.D. INSPECTOR. ANCHOR VALVE TO TEE.
- 3 CONNECT TO EXISTING WATER MAIN (ACTUAL ELEVATION UNKNOWN). CONTRACTOR TO VERIFY DEPTH PRIOR TO CONSTRUCTION.
- 4 CHANNEL LINING, CLASS II (18" w/ NON-WOVEN GEOTEXTILE FILTER FABRIC
- 5 CONTRACTOR TO VERIFY LOCATION AND ELEVATION OF UTILITY PRIOR TO EXCAVATION ACTIVITY AND NOTIFY ENGINEER AND N.K.W.D. OF CONFLICTS. (" SEE NOTE)
- 6 DO NOT DISTURB
- 7 CONTRACTOR TO SUPPORT UTILITY POLE DURING PIPE INSTALLATION (" SEE NOTE)
- 8 REMOVE AND REPLACE SIGN (" SEE NOTE)
- 9 REMOVE AND REPLACE MAILBOX (" SEE NOTE)
- 10 INSTALL 56" METER SETTING PER NKWD STD. DWG. No. 107. INSTALL WATER SERVICE LINE (3/4" TYPE K COPPER) FROM THE PROPOSED WATER MAIN TO THE METER SETTING. MATERIAL WILL BE PROVIDED BY NKWD FOR THIS WORK. UNIT PRICE INCLUDES LABOR, EQUIPMENT, EXCAVATION, BEDDING, BACKFILL, AND FINISH. CONTRACTOR SHALL VERIFY THE EXISTING UTILITY PRIOR TO BEGINNING CONSTRUCTION OF ANY POTENTIAL CONFLICT. NO ADDITIONAL PAYMENT WILL BE MADE FOR THIS WORK AND THE COST SHALL BE INCLUDED IN THE BID ITEM FOR WATER MAIN.
- 11 REMOVE & REPLACE STORM STRUCTURE (C9, HW) AS NEEDED FOR WATER MAIN INSTALLATION (" SEE NOTE)
- 12 DRIVEWAY RESTORATION (SEE DETAILS)
- 13 TREE TO BE REMOVED

NOTE:

WORK FOR THIS ITEM SHALL BE CONSIDERED INCIDENTAL TO THE OVERALL PROJECT AND NO ADDITIONAL PAYMENT SHALL BE MADE FOR THIS WORK. COST SHALL BE INCLUDED IN THE BID ITEM FOR WATER MAIN.

HATCH LEGEND

	1-1/2" ASPHALT PAVEMENT MILL AND OVERLAY AREA
	TRENCH RESTORATION - ASPHALT PAVEMENT - SEE DETAIL SHEET
	TRENCH RESTORATION - CONCRETE PAVEMENT - SEE DETAIL SHEET
	TRENCH RESTORATION - 8" AGGREGATE PAVEMENT
	CONTROL DENSITY FILL - PAVT TRENCH
	CONCRETE DRIVEWAY REPLACEMENT - SEE DETAIL SHEET
	CONCRETE WALK REPLACEMENT - SEE DETAIL SHEET
	ASPHALT DRIVEWAY REPLACEMENT - SEE DETAIL SHEET
	GRAVEL DRIVEWAY REPLACEMENT - SEE DETAIL SHEET
	CHANNEL LINING, CLASS II - SEE DETAIL SHEET
	DEVOTES PROPERTY WITH NEW SERVICE AND METER SETTING

PROJECT NO.
231591

DISCIPLINE
CIVIL

SHEET NAME
C-18

SHEET
25

OF
28

NORTHERN KENTUCKY WATER DISTRICT

SUBDISTRICT 'O'

-KENTON COUNTY -

ELLIOT ROAD

STA. 10+00 TO STA. 22+50

ISSUED FOR:
BID

ISSUE DATE:
APRIL 2025

SCALE:
AS SHOWN

DESIGNED BY:
JCOR

DRAWN BY:
JCOR

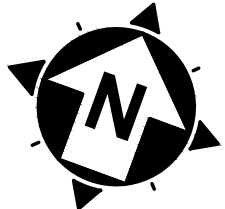
CHECKED BY:
JSHU

NO

REVISION

DATE

2161 CHAMBER CENTER DRIVE
FORT MITCHELL, KENTUCKY 41017
TEL. (859) 525-0544
WWW.VERDANTAS.COM



0'
50'
100'
SCALE: 1" = 50'

CONSTRUCTION NOTES

- 1 MAINTAIN MANAGEABLE VERTICAL CLEARANCE BETWEEN THE PROPOSED WATER MAIN AND THE EXISTING STORM SEWER, WATER MAIN, TELEPHONE AND CABLES. MAINTAIN MINIMUM 18" BETWEEN PROPOSED WATER MAIN AND THE EXISTING SANITARY SEWER. ACTUAL ELEVATION UNKNOWN. CONTRACTOR TO EXCAVATE & VERIFY ACTUAL LOCATION, SIZE AND ELEVATION OF EXISTING UTILITY PRIOR TO BEGINNING WATER MAIN CONSTRUCTION. CONTRACTOR SHALL NOTIFY THE TOWN ENGINEER PRIOR TO CONSTRUCTION OF ANY POTENTIAL CONFLICT. NO ADDITIONAL PAYMENT WILL BE MADE FOR THIS WORK AND THE COST SHALL BE INCLUDED IN THE BID ITEM FOR WATER MAIN.
- 2 PROPOSED FIRE HYDRANT ASSEMBLY, VALVE AND ANCHOR VALVE TO TEE. CONTRACTOR TO COORDINATE LOCATION WITH N.K.W.D. INSPECTOR.
- 3 CONNECT TO EXISTING WATER MAIN (ACTUAL ELEVATION UNKNOWN). CONTRACTOR TO VERIFY DEPTH PRIOR TO CONSTRUCTION.
- 4 CHANNEL LINING, CLASS II (18") W/ NON-WOVEN GEOTEXTILE FILTER FABRIC
- 5 CONTRACTOR TO VERIFY LOCATION AND ELEVATION OF UTILITY PRIOR TO EXCAVATION ACTIVITY AND NOTIFY ENGINEER AND N.K.W.D. OF CONFLICTS. ("SEE NOTE")
- 6 DO NOT DISTURB
- 7 CONTRACTOR TO SUPPORT UTILITY POLE DURING PIPE INSTALLATION ("SEE NOTE")
- 8 REMOVE AND REPLACE SIGN ("SEE NOTE")
- 9 REMOVE AND REPLACE MAILBOX ("SEE NOTE")
- 10 INSTALL 56" METER SETTING PER NKWD STD. DWG. NO. 107. INSTALL WATER SERVICE LINE (3/4" TYPE K COPPER) FROM THE PROPOSED WATER MAIN TO THE METER SETTING. MATERIAL WILL BE PROVIDED BY NKWD FOR THIS WORK. UNIT PRICE INCLUDES LABOR, EQUIPMENT EXCAVATION, BEDDING, BACKFILL, AND FINISH GRADE. CONTRACTOR TO BE RESPONSIBLE TO INSTALL SERVICE LINE AS SHOWN ON PLANS OR DIRECTED BY NKWD IN ACCORDANCE WITH SPECS & STD. DWGS. COMPLETE.
- 11 REMOVE & REPLACE STORM STRUCTURE (CB/HW) AS NEEDED FOR WATER MAIN INSTALLATION ("SEE NOTE")
- 12 DRIVEWAY RESTORATION (SEE DETAILS)
- 13 TREE TO BE REMOVED

DATE	REVISION	NO	BID	ISSUED FOR:
			APRIL 2025	ISSUE DATE:
			AS SHOWN	SCALE:
			JCOR	DESIGNED BY:
			JCOR	DRAWN BY:
			JSHU	CHECKED BY:

2161 CHAMBER CENTER DRIVE
FORT MITCHELL, KENTUCKY 41017
TEL. (859) 525-0544
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NOTE:
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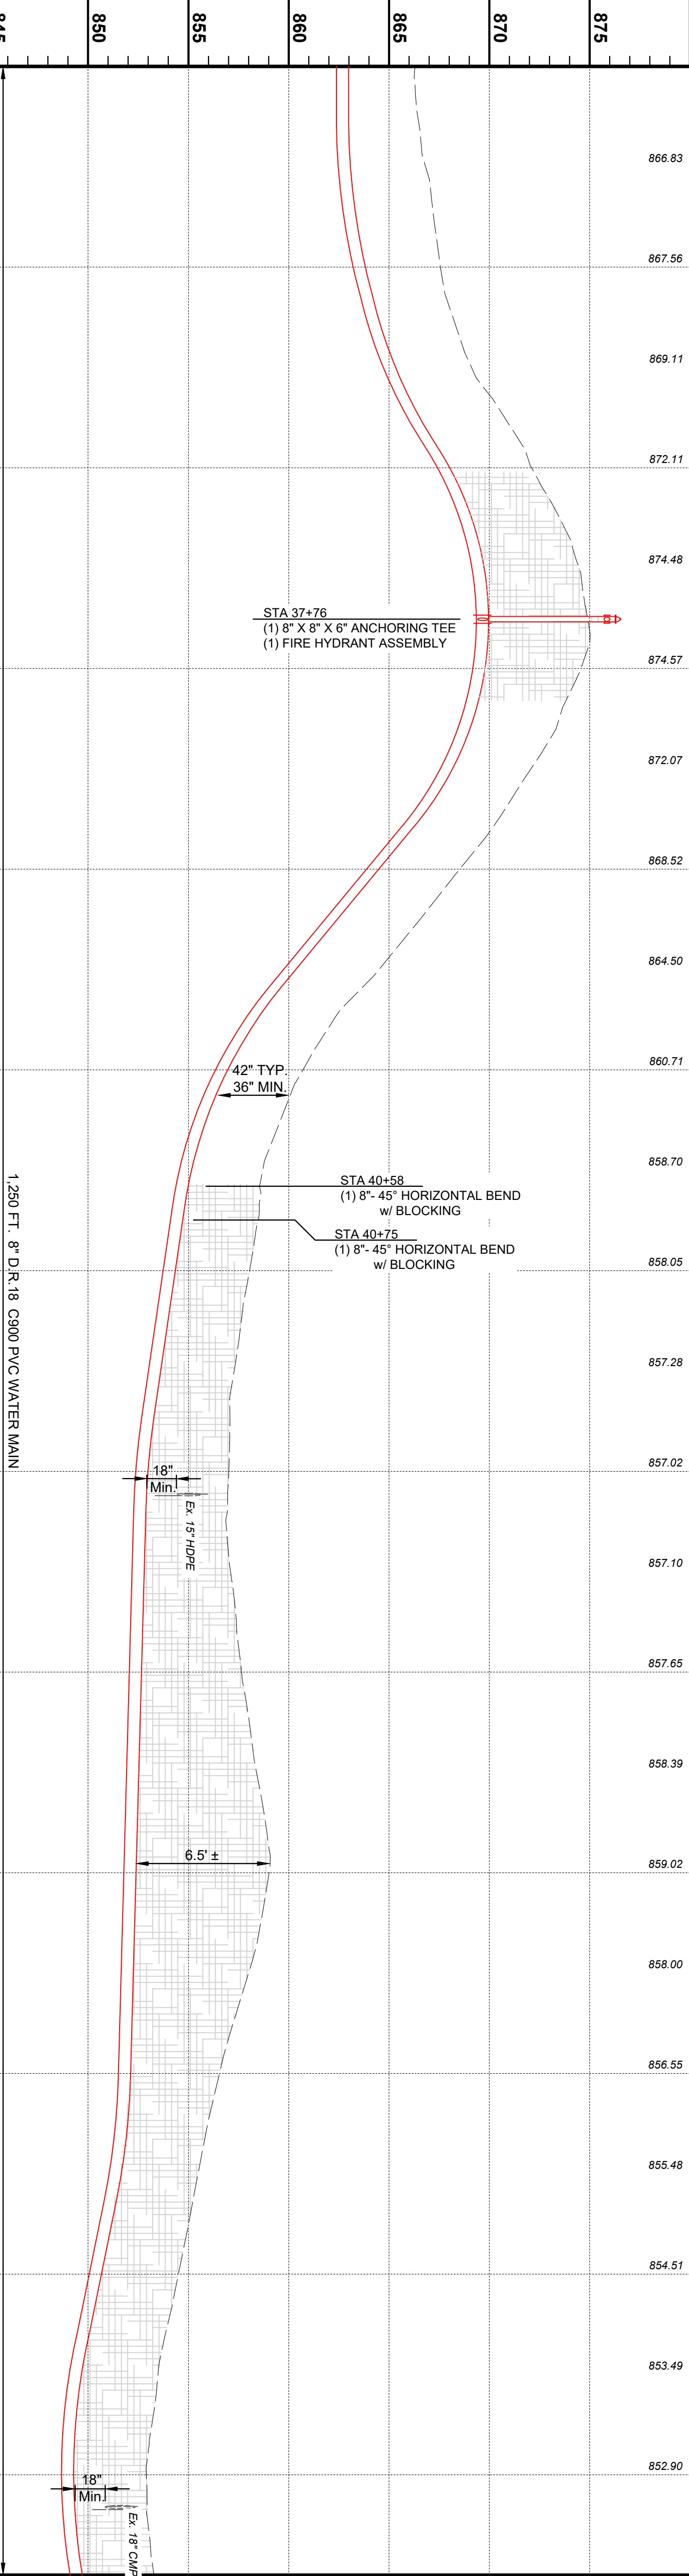
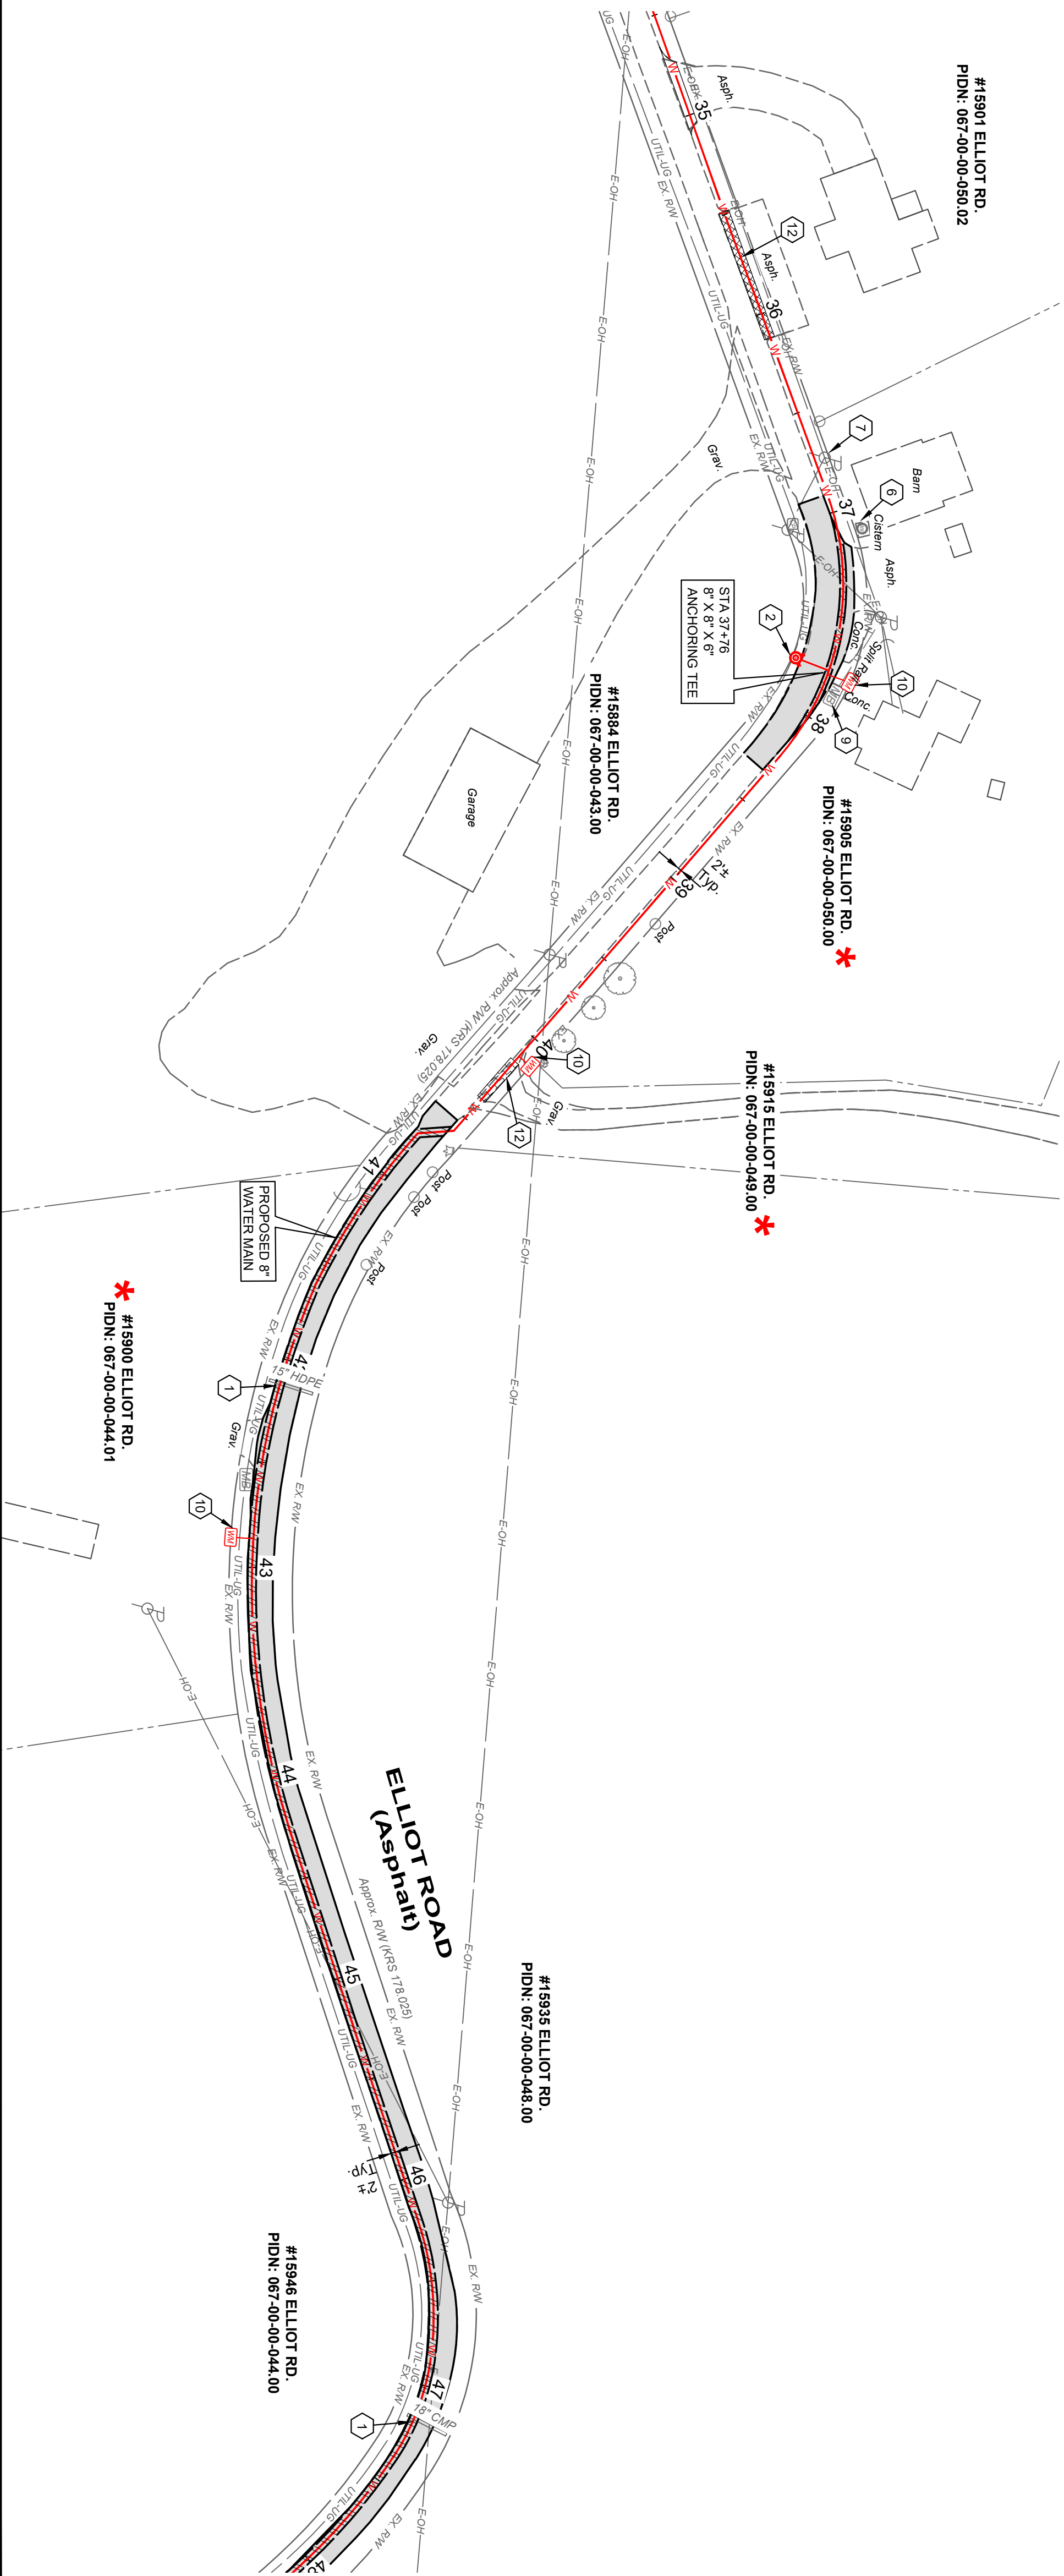
HATCH LEGEND

- 1-1/2" ASPHALT PAVEMENT MILL AND OVERLAY AREA
- TRENCH RESTORATION - ASPHALT PAVEMENT - SEE DETAIL SHEET
- TRENCH RESTORATION - CONCRETE PAVEMENT - SEE DETAIL SHEET
- TRENCH RESTORATION - 8" AGGREGATE PAVEMENT
- CONTROL DENSITY FILL - PAVT TRENCH
- CONCRETE DRIVEWAY REPLACEMENT - SEE DETAIL SHEET
- CONCRETE WALK REPLACEMENT - SEE DETAIL SHEET
- ASPHALT DRIVEWAY REPLACEMENT - SEE DETAIL SHEET
- GRAVEL DRIVEWAY REPLACEMENT - SEE DETAIL SHEET
- CHANNEL LINING, CLASS II - SEE DETAIL SHEET
- DEVOTES PROPERTY WITH NEW SERVICE AND METER SETTING

NORTHERN KENTUCKY WATER DISTRICT
SUBDISTRICT 'O'
-KENTON COUNTY -

ELLIOT ROAD
STA. 35+00 TO STA. 47+50

PROJECT NO.	231591
DISCIPLINE	CIVIL
SHEET NAME	C-20
SHEET	27
OF	28



\\P0203019\WORK\BENTLEY_231591\DWG_231591_01.ELLIOT ROAD.ELLIOT STA. 35+00 TO STA. 47+50.DWG



0'
50'
100'
SCALE: 1" = 50'

CONSTRUCTION NOTES

1. MAINTAIN MANAGEABLE VERTICAL CLEARANCE BETWEEN THE PROPOSED WATER MAIN AND THE EXISTING STORM SEWER, WATER MAIN, TELEPHONE AND CABLE LINES. MAINTAIN MINIMUM 18" BETWEEN PROPOSED WATER MAIN AND THE EXISTING SANITARY SEWER. ACTUAL ELEVATION UNKNOWN. CONTRACTOR TO EXCAVATE & VERIFY ACTUAL LOCATION, SIZE AND ELEVATION OF EXISTING UTILITY PRIOR TO BEGINNING WATER MAIN CONSTRUCTION. CONTRACTOR SHALL NOTIFY THE OWNER PRIOR TO ANY POTENTIAL CONFLICT. NO ADDITIONAL PAYMENT WILL BE MADE FOR THIS WORK AND THE COST SHALL BE INCLUDED IN THE BID ITEM FOR WATER MAIN.
2. PROPOSED FIRE HYDRANT ASSEMBLY, VALVE AND ANCHOR VALVE TO TEE. COORDINATE LOCATION WITH N.K.W.D. INSPECTOR.
3. CONNECT TO EXISTING WATER MAIN (ACTUAL ELEVATION UNKNOWN). CONTRACTOR TO VERIFY DEPTH PRIOR TO CONSTRUCTION.
4. CHANNEL LINING, CLASS II (18") W/ NON-WOVEN GEOTEXTILE FILTER FABRIC.
5. CONTRACTOR TO VERIFY LOCATION AND ELEVATION OF UTILITY PRIOR TO EXCAVATION ACTIVITY AND NOTIFY ENGINEER AND N.K.W.D. OF CONFLICTS. (" SEE NOTE)
6. DO NOT DISTURB
7. CONTRACTOR TO SUPPORT UTILITY POLE DURING PIPE INSTALLATION (" SEE NOTE)
8. REMOVE AND REPLACE SIGN (" SEE NOTE)
9. REMOVE AND REPLACE MAILBOX (" SEE NOTE)
10. INSTALL 56" METER SETTING PER NKWD STD. DWG. NO. 107. INSTALL WATER SERVICE LINE (3/4" TYPE K COPPER) FROM THE PROPOSED WATER MAIN TO THE METER SETTING. MATERIAL WILL BE PROVIDED BY NKWD FOR THIS WORK. UNIT PRICE INCLUDES LABOR, EQUIPMENT EXCAVATION, BEDDING, BACKFILL, AND FINISH. CONTRACTOR TO BE RESPONSIBLE TO INSTALL SERVICE LINE AS SHOWN ON PLANS OR DIRECTED BY NKWD IN ACCORDANCE WITH SPECS & STD. DWGS. COMPLETE.
11. REMOVE & REPLACE STORM STRUCTURE (CB/HW) AS NEEDED FOR WATER MAIN INSTALLATION (" SEE NOTE)
12. DRIVEWAY RESTORATION (SEE DETAILS)
13. TREE TO BE REMOVED

NOTE:

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HATCH LEGEND

- 1-1/2" ASPHALT PAVEMENT MILL AND OVERLAY AREA
- TRENCH RESTORATION - ASPHALT PAVEMENT - SEE DETAIL SHEET
- TRENCH RESTORATION - CONCRETE PAVEMENT - SEE DETAIL SHEET
- TRENCH RESTORATION - 8" AGGREGATE PAVEMENT
- CONTROL DENSITY FILL - PAVT TRENCH
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- CONCRETE WALK REPLACEMENT - SEE DETAIL SHEET
- ASPHALT DRIVEWAY REPLACEMENT - SEE DETAIL SHEET
- GRAVEL DRIVEWAY REPLACEMENT - SEE DETAIL SHEET
- CHANNEL LINING, CLASS II - SEE DETAIL SHEET
- ★ DENOTES PROPERTY WITH NEW SERVICE AND METER SETTING

NORTHERN KENTUCKY WATER DISTRICT
SUBDISTRICT 'O'
-KENTON COUNTY -

ELLIOT ROAD
STA. 47+50 TO STA. 58+69

PROJECT NO.
231591
DISCIPLINE
CIVIL
SHEET NAME
C-21
SHEET
28 OF
28

verdantas

2161 CHAMBER CENTER DRIVE
FORT MITCHELL, KENTUCKY 41017
TEL. (859) 525-0544
WWW.VERDANTAS.COM