

**COMMONWEALTH OF KENTUCKY
BEFORE THE PUBLIC SERVICE COMMISSION**

In the Matter of:

THE APPLICATION OF)
CELLCO PARTNERSHIP D/B/A VERIZON WIRELESS &)
TAG TOWERS, LLC FOR ISSUANCE OF A CERTIFICATE) CASE NO. 2023-00368
OF PUBLIC CONVENIENCE AND NECESSITY TO)
CONSTRUCT A WIRELESS COMMUNICATIONS)
FACILITY IN THE COMMONWEALTH OF KENTUCKY)
IN THE COUNTY OF ROCK CASTLE)

SITE NAME: MT VERNON EAST

* * * * *

**APPLICATION FOR
CERTIFICATE OF PUBLIC CONVENIENCE AND NECESSITY
FOR CONSTRUCTION OF A WIRELESS COMMUNICATIONS FACILITY**

Cellco Partnership, d/b/a Verizon Wireless and TAG Towers, LLC (“Co-Applicants”), by counsel, pursuant to (i) KRS §§278.020, 278.040, 278.650, 278.665, and other statutory authority, and the rules and regulations applicable thereto, and (ii) the Telecommunications Act of 1996, respectfully submits this Application requesting issuance of a Certificate of Public Convenience and Necessity (“CPCN”) from the Kentucky Public Service Commission (“PSC”) to construct, maintain, and operate a Wireless Communications Facility (“WCF”) to serve the customers of the Applicant with wireless communications services.

In support of this Application, Co-Applicants respectfully provide and state the following information:

1. The complete name and address of the Co-Applicants:
 - a. Cellco Partnership, d/b/a Verizon Wireless, having a local address of 2902 Ring Road, Elizabethtown, KY, 42701.

- b. TAG Towers, LLC, having a local address of 108 Forbes Court, Suite 1 Richmond, KY 40475
2. Co-Applicants:
- a. Cellco Partnership, d/b/a Verizon Wireless is a Delaware general partnership and a copy of the Statement of Good Standing from Delaware, and the Certificate of Assumed Name is on file with the Secretary of State of Commonwealth of Kentucky and included as part of **Exhibit A**.
- b. TAG Towers, LLC is a Delaware general partnership and a copy of the Statement of Good Standing from Delaware, and the Certificate of Authorization is on file with the Secretary of State of Commonwealth of Kentucky and included as part of Exhibit A.
3. Co-Applicants propose construction of an antenna tower for communications services, which is to be located in an area outside the jurisdiction of a planning commission, and Applicant submits this application to the PSC for a certificate of public convenience and necessity pursuant to KRS §§ 278.020(1), 278.040, 278.650, 278.665, and other statutory authority.
4. The Co-Applicant operates on frequencies licensed by the Federal Communications Commission ("FCC") pursuant to applicable FCC requirements. A copy of the Co-Applicant's FCC Registration and Licenses with Authorization to provide wireless services are attached to this Application or described as part of **Exhibit B**, and the facility will be constructed and operated in accordance with applicable FCC regulations.
5. The public convenience and necessity require the construction of the proposed WCF. The construction of the WCF will bring or improve the Co-Applicant's services to an area

currently not served or not adequately served by the Co-Applicants by increasing coverage or capacity and thereby enhancing the public's access to innovative and competitive wireless communications services. A statement from Co-Applicant's RF Design Engineer outlining said need is attached as **Exhibit Q** along with Propagation Maps attached as **Exhibit Q-a**. The WCF is an integral link in the Applicant's network design that must be in place to provide adequate coverage to the service area.

6. To address the above-described service needs, Co-Applicants propose to construct a WCF at 321 Frosty Hollow Road, Mt. Vernon, KY 40456, (North Latitude: (37° 19' 32.58, West Longitude 84° 15' 28.77"), on a parcel of land located entirely within the county referenced in the caption of this application. The property on which the WCF will be located is owned by Clyde and Magdaline Collins pursuant to a Deed recorded at Deed Book 154, Page 282 in the office of the County Clerk. The proposed WCF will consist of a 300-foot tall tower, with an approximately 4-foot tall lightning arrestor attached at the top, for a total height of 304-feet. The WCF will also include concrete foundations and a shelter or cabinets to accommodate the placement of the Co-Applicant's radio electronics equipment and appurtenant equipment. The Applicant's equipment cabinet or shelter will be approved for use in the Commonwealth of Kentucky by the relevant building inspector. The WCF compound will be fenced and all access gate(s) will be secured. A description of the manner in which the proposed WCF will be constructed is attached as **Exhibit C** and **Exhibit D**.

7. A list of utilities, corporations, or persons with whom the proposed WCF is likely to compete along with a map showing the proposed location as well as the identified like facilities is attached as **Exhibit E**.

8. The site development plan and a vertical profile sketch of the WCF signed and sealed by a professional engineer registered in Kentucky depicting the tower height, as well as a proposed configuration for the antennas of the Applicant has also been included as part of **Exhibit C**.

9. Foundation design plans signed and sealed by a professional engineer registered in Kentucky and a description of the standards according to which the tower was designed are included as part of **Exhibit D**.

10. Co-Applicants have considered the likely effects of the installation of the proposed WCF on nearby land uses and values and has concluded that there is no more suitable location reasonably available from which adequate services can be provided, and that there are no reasonably available opportunities to co-locate Applicant's antennas on an existing structure. When suitable towers or structures exist, Co-Applicant attempts to co-locate on existing structures such as communications towers or other structures capable of supporting Applicant's facilities; however, no other suitable or available co-location site was found to be located in the vicinity of the site. A statement from Co-Applicant, Cellco Partnership, d/b/a Verizon Wireless's RF Design Engineer outlining exploration of co-location opportunities is attached as **Exhibit Q**.

11. A copy of the Application and Determination of No Hazard from the Federal Aviation Administration ("FAA") is attached as **Exhibit F**.

12. A copy of the Kentucky Airport Zoning Commission ("KAZC") Application and Approval to construct the tower is attached as **Exhibit G**.

13. A geotechnical engineering report was performed at the WCF site by Engineered Tower Solutions, PLLC, 3227 Wellington Court, Raleigh, NC 27615, dated September 13, 2023 and is attached as **Exhibit H**. The name and address of the geotechnical engineering firm and the professional engineer registered in Kentucky who prepared the report are included as part

of **Exhibit H** and **Exhibit R**.

14. Clear directions to the proposed WCF site from the County seat are attached as **Exhibit I**. The name and telephone number of the preparer of **Exhibit I** are included as part of this exhibit.

15. Co-Applicants, pursuant to a written agreement, has acquired the right to use the WCF site and associated property rights. A copy of the agreement or an abbreviated agreement recorded with the County Clerk is attached as **Exhibit J**.

16. Personnel directly responsible for the design and construction of the proposed WCF are well qualified and experienced. The tower and foundation drawings for the proposed tower submitted as part of **Exhibit D** bear the signature and stamp of a professional engineer registered in the Commonwealth of Kentucky. All tower designs meet or exceed the minimum requirements of applicable laws and regulations. The identity and qualifications of each person directly responsible for design and construction of the proposed tower are contained in **Exhibit R**.

17. The Construction Manager for the proposed facility is Larry Rhoads and the identity and qualifications of each person directly responsible for design and construction of the proposed tower are contained in **Exhibit R**.

18. As noted on the Survey attached as part of **Exhibit C**, the surveyor has determined that the tower site and access easement are not within any flood hazard area per Flood Hazard Boundary Map, Community Panel Number 21203C0200C, Dated August 3, 2009.

19. **Exhibit C** includes a map drawn to an appropriate scale that shows the location of the proposed tower and identifies every owner of real estate within 500 feet of the proposed tower (according to the records maintained by the County Property Valuation Administrator).

20. **Exhibit L** contains the Notification List with screen shots of the PVA records verified and updated using the Rock Castle County PVA on November 16, 2023.

21. Co-Applicants have sent certified notices every person who, according to the records of the County Property Valuation Administrator, owns property which is within 500 feet of the proposed tower or contiguous to the site property, by certified mail, return receipt requested, of the proposed construction. Each notified property owner has been provided with a map of the location of the proposed construction, the PSC docket number for this application, the address of the PSC, and informed of his or her right to request intervention. A list of the notified property owners, verified on November 16, 2023, using the Rock Castle County Kentucky Property Valuation Administration records and a copy of the form of the notice sent by certified mail to each landowner on November 17, 2023 are attached as **Exhibit K** and **Exhibit L**, respectively. Nineteen (19) notices were sent to surrounding property owners on November 17, 2024. As of December 6, 2024 fourteen (14) notice green cards had been returned. USPS tracking indicated that one (1) notice was delivered on November 22, 2023, one (1) notice was picked up at the Post Office on December 5, 2023, two (2) notices were attempted delivery on November 21, 2023 with notices left at respective addresses, and one (1) notice is noted as “moving through the system”. On December 11, 2023 notice was resent to the 3 property owners that had not received notice. To date two (2) additional notice green cards have been returned and USPS tracking indicated one (1) notice as “moving through the system”. This is the same notice to Allen Hayes and Terry Goff that experienced the same notation from the November mailing. There are no unaccountable notices. Copies of the November 17, 2023 and the December 11, 2023, mailed envelopes, returned green cards and USPS tracking are included in **Exhibit L & La**.

22. Co-Applicants have notified the applicable County Judge/Executive by certified mail, return receipt requested, of the proposed construction. This notice included the PSC docket

number under which the application will be processed and informed the County Judge/Executive of his/her right to request intervention. As of December 6, 2023 the green card had not been returned. On December 11, 2023, new notice was mailed to the Judge/Executive. A copy of this original notice is attached as **Exhibit M** and a copy of the December 11, 2023 notice along with a copy of the mailed envelope and returned green card is attached as **Exhibit Ma**.

23. Notice signs meeting the requirements prescribed by 807 KAR 5:063, Section 1(2) that measure at least 2 feet in height and 4 feet in width and that contain all required language in letters of required height, have been posted, one in a visible location on the proposed site and one on the nearest public road. Such signs shall remain posted for at least two weeks after filing of the Application, and a copy of the posted text is attached as **Exhibit N**.

24. A legal notice advertisement regarding the location of the proposed facility has been published in a newspaper of general circulation in the county in which the WCF is proposed to be located. A copy of the newspaper legal notice advertisement is attached as **Exhibit O**.

25. The area of the proposed facility is in the unincorporated area of Rock Castle County, Kentucky. The site is approximately 5.5 miles southeast of Mount Vernon, KY. The area is wooded and rural in nature with a scattering of residential properties. The terrain in this area is hilly. There is no zoning or Plan Commission in Rock Castle County. The general area where the proposed facility is proposed is wooded and, removed a significant distance from any residential structures. The nearest residential structure is 470 feet from the proposed tower site.

26. The process that was used by the Co-Applicant's radio frequency engineers in selecting the site for the proposed WCF was consistent with the general process used for selecting all other existing and proposed WCF facilities within the proposed network design area. Applicant's radio frequency engineers have conducted studies and tests in order to develop a highly efficient network that is designed to handle voice and data traffic in the service area. The engineers

determined an optimum area for the placement of the proposed facility in terms of elevation and location to provide the best quality service to customers in the service area. A radio frequency design search area prepared in reference to these radio frequency studies was considered by the Applicant when searching for sites for its antennas that would provide the coverage deemed necessary by the Applicant. A map of the area in which the tower is proposed to be located which is drawn to scale and clearly depicts the necessary search area within which the site should be located pursuant to radio frequency requirements is attached as **Exhibit P**.

27. The tower must be located at the proposed location and proposed height to provide necessary service to wireless communications users in the subject area, as set out and documented in the RF Design Engineer's Statement of Need and Propagation Maps attached as **Exhibit Q** and **Exhibit Qa**, respectively. The proposed tower will expand and improve voice and data service for Verizon Wireless customers.

28. Attached hereto as **Exhibit S** please find an Affidavit of Certification for all information contained in this application.


29. All Exhibits to this Application are hereby incorporated by reference as if fully set out as part of the Application.

30. All responses and requests associated with this Application may be directed to:

Russell L. Brown
Clark, Quinn, Moses, Scott & Grahn, LLP
320 North Meridian Street, Suite 1100
Indianapolis, IN 46204
Phone: (317) 637-1321
FAX: (317) 687-2344
Email: rbrown@clarkquinnlaw.com

WHEREFORE, Co-Applicants respectfully request that the PSC accept the foregoing Application for filing, and having met the requirements of KRS §§278.020(1), 278.650, and 278 .665 and all applicable rules and regulations of the PSC, grant a Certificate of Public Convenience and Necessity to construct and operate the WCF at the location set forth herein.

Respectfully submitted,

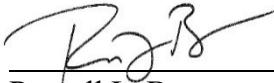

Russell L. Brown
Clark, Quinn, Moses, Scott & Grahn, LLP
320 North Meridian Street, Suite 1100
Indianapolis, IN 46204
Phone: (317) 637-1321 / FAX: (317) 687-2344
Email: rbrown@clarkquinnlaw.com
Attorney for Cellco Partnership d/b/a Verizon Wireless

Dated : January 9, 2023

LIST OF EXHIBITS

- A Applicant Entity
- B FCC Registration and License Documentation
- C Site Development Plan:
 - 500' Vicinity Map Legal Descriptions
 - Flood Plain Certification Site Plan
 - Vertical Tower Profile
- D Tower and Foundation Design
- E Competing Utilities, Corporations, or Persons List
And Map of Like Facilities in Vicinity
- F FAA Application and Determination of No Hazard
- G KAZC Application and Approval
- H Geotechnical Report
- I Directions to WCF Site
- J Copy of Real Estate Agreement
- K Notification Listing with PVA Verification
- L Copy of Property Owner Notification
- La Copy of 2nd mailing December 11, 2023
- M Copy of County Judge/Executive notice
- Ma Copy of 2nd mailing December 11, 2023
- N Copy of Posted Notices
- O Copy of Newspaper Legal Notice Advertisement
- P Copy of Radio Frequency Design Search Area
- Q Copy of RF Design Engineer State of Need
- Qa Propagation Maps
- R List of Qualified Professionals
- S Affidavit of Certification



**Michael G. Adams
Secretary of State**

Certificate

I, Michael G. Adams, Secretary of State for the Commonwealth of Kentucky, do hereby certify that the foregoing writing has been carefully compared by me with the original thereof, now in my official custody as Secretary of State and remaining on file in my office, and found to be a true and correct copy of

CERTIFICATE OF ASSUMED NAME OF VERIZON WIRELESS ADOPTED BY
GENERAL PARTNERS OF CELLCO PARTNERSHIP FILED JUNE 21, 2006.

IN WITNESS WHEREOF, I have hereunto set my hand and affixed my Official Seal at Frankfort, Kentucky, this 10th day of May, 2023.



A handwritten signature of Michael G. Adams.

Michael G. Adams
Secretary of State
Commonwealth of Kentucky
kdcoleman/0641227 - Certificate ID: 290787

COMMONWEALTH OF KENTUCKY
TREY GRAYSON
SECRETARY OF STATE



0641227.07

Dcornish
C226

Trey Grayson

Secretary of State

Received and Filed

06/21/2006 12:06:09 PM

Fee Receipt: \$20.00

CERTIFICATE OF ASSUMED NAME

This certifies that the assumed name of

Verizon Wireless

[Name under which the business will be conducted]

has been adopted by See Addendum

[Registration - KRS 365.015(1)]

which is the "real name" of [YOU MUST CHECK ONE]

- | | |
|--|---|
| <input type="checkbox"/> a Domestic General Partnership | <input checked="" type="checkbox"/> a Foreign General Partnership |
| <input type="checkbox"/> a Domestic Registered Limited Liability Partnership | <input type="checkbox"/> a Foreign Registered Limited Liability Partnership |
| <input type="checkbox"/> a Domestic Limited Partnership | <input type="checkbox"/> a Foreign Limited Partnership |
| <input type="checkbox"/> a Domestic Business Trust | <input type="checkbox"/> a Foreign Business Trust |
| <input type="checkbox"/> a Domestic Corporation | <input type="checkbox"/> a Foreign Corporation |
| <input type="checkbox"/> a Domestic Limited Liability Company | <input type="checkbox"/> a Foreign Limited Liability Company |
| <input type="checkbox"/> a Joint Venture | |

organized and existing in the state or country of Delaware, and whose address is

One Verizon Way

Basking Ridge

NJ

07920

Street address, if any

City

State

Zip Code

The certificate of assumed name is executed by

NYNEX PCS Inc.

Jane A. Schapker

Jane A. Schapker-Assistant Secretary

Date or type name and title

June 15, 2006

Date

Signature

Print or type name and title

Date

Addendum

The full name of the Partnership is Cellco Partnership; a Delaware general partnership with its headquarters located One Verizon Way, Basking Ridge NJ 07920-1097.

General Partners of Cellco Partnership	Address
Bell Atlantic Cellular Holdings, L.P.	One Verizon Way Basking Ridge, NJ 07920
NYNEX PCS Inc.	One Verizon Way Basking Ridge, NJ 07920
PCSCO Partnership	One Verizon Way Basking Ridge, NJ 07920
GTE Wireless Incorporated	One Verizon Way Basking Ridge, NJ 07920
GTE Wireless of Ohio Incorporated	One Verizon Way Basking Ridge, NJ 07920
PCS Nucleus, L.P.	2999 Oak Road, 7 th Floor Walnut Creek, CA 94597
JV PartnerCo, LLC	2999 Oak Road, 7 th Floor Walnut Creek, CA 94597

Delaware

Page 1

The First State

*I, JEFFREY W. BULLOCK, SECRETARY OF STATE OF THE STATE OF
DELAWARE, DO HEREBY CERTIFY "CELLCO PARTNERSHIP" IS DULY FORMED
UNDER THE LAWS OF THE STATE OF DELAWARE AND IS IN GOOD STANDING AND
HAS A LEGAL EXISTENCE SO FAR AS THE RECORDS OF THIS OFFICE SHOW, AS
OF THE TWENTY-SEVENTH DAY OF APRIL, A.D. 2023.*

*AND I DO HEREBY FURTHER CERTIFY THAT THE ANNUAL TAXES HAVE BEEN
PAID TO DATE.*

3341134 8300

SR# 20231665976

You may verify this certificate online at corp.delaware.gov/authver.shtml



Jeffrey W. Bullock, Secretary of State

Authentication: 203227418

Date: 04-27-23

Delaware

Page 1

The First State

*I, JEFFREY W. BULLOCK, SECRETARY OF STATE OF THE STATE OF
DELAWARE, DO HEREBY CERTIFY "TAG TOWERS LLC" IS DULY FORMED UNDER
THE LAWS OF THE STATE OF DELAWARE AND IS IN GOOD STANDING AND HAS A
LEGAL EXISTENCE SO FAR AS THE RECORDS OF THIS OFFICE SHOW, AS OF
THE TWENTY-SECOND DAY OF AUGUST, A.D. 2023.*



6311703 8300

SR# 20233314766

You may verify this certificate online at corp.delaware.gov/authver.shtml



A handwritten signature of Jeffrey W. Bullock in black ink, followed by a horizontal line and the printed name "Jeffrey W. Bullock, Secretary of State".

Authentication: 204019585

Date: 08-22-23

1318088.06

mwellman
ADD

COMMONWEALTH OF KENTUCKY
MICHAEL G. ADAMS, SECRETARY OF STATE

Division of Business Filings
P.O. Box 718
Frankfort, KY 40602
(502) 564-3490
www.sos.ky.gov

Certificate of Authority
(Foreign Business Entity)

FBE

Michael G. Adams
Kentucky Secretary of State
Received and Filed:
10/30/2023 2:59 PM
Fee Receipt: \$90.00

Pursuant to the provisions of KRS 14A – 030 the undersigned hereby applies for authority to transact business in Kentucky on behalf of the entity named below and, for that purpose, submits the following statements:

- | | | | |
|---------------------|--|---|---|
| 1. The entity is a: | <input type="checkbox"/> profit corporation | <input type="checkbox"/> nonprofit corporation | <input type="checkbox"/> professional limited liability company |
| | <input checked="" type="checkbox"/> business trust | <input type="checkbox"/> limited liability company | <input type="checkbox"/> statutory trust |
| | <input type="checkbox"/> limited partnership | <input type="checkbox"/> lld cooperative association | <input type="checkbox"/> public benefit corporation |
| | <input type="checkbox"/> non-profit llc | <input type="checkbox"/> professional service corporation | <input type="checkbox"/> other |

2. The name of the entity is TAG Towers LLC

(The name must be identical to the name on record with the Secretary of State.)

3. The name of the entity to be used in Kentucky is (if applicable): _____

(Only provide if "real name" is unavailable for use; otherwise, leave blank.)

4. The state or country under whose law the entity is organized is Delaware

5. The date of organization is 2/09/2017 and the period of duration is _____
(If left blank, duration is considered perpetual.)

6. The mailing address of the entity's principal office is

1905 Woodstock Road Suite 2100	Roswell	GA	30075
Street Address	City	State	Zip Code

7. The street address of the entity's registered office in Kentucky is

108 Forbes Court	Richmond	KY	40475
Street Address (No P.O. Box Numbers)	City	State	Zip Code

and the name of the registered agent at that office is David Ginter

8. The names and business addresses of the entity's representatives (secretary, officers and directors, managers, trustees or general partners):

Mark Gergel	1905 Woodstock Road Suite 2100	Roswell	GA	30075
Name	Street or P.O. Box	City	State	Zip Code
David Ginter	108 Forbes Court	Richmond	KY	40475
Name	Street or P.O. Box	City	State	Zip Code
Richie Pennington	108 Forbes Court	Richmond	KY	40475
Name	Street or P.O. Box	City	State	Zip Code

9. If a professional service corporation, all the individual shareholders, not less than one half (1/2) of the directors, and all of the officers other than the secretary and treasurer are licensed in one or more states or territories of the United States or District of Columbia to render a professional service described in the statement of purposes of the corporation.

10. I certify that, as of the date of filing this application, the above-named entity validly exists under the laws of the jurisdiction of its formation.

11. If a limited partnership, it elects to be a limited liability limited partnership. Check the box if applicable:

12. If a limited liability company, check box if manager-managed:

13. This application will be effective upon filing.

David Ginter

Digitally signed by David Ginter
Date: 2023.10.24 08:38:33 -0400

Signature of Authorized Representative

David Ginter, President and Owner

10/23/2023

Date

I, David Ginter

Type/Print Name of Registered Agent

, consent to serve as the registered agent on behalf of the business entity.

David Ginter

Digitally signed by David Ginter
Date: 2023.10.24 07:44:45 -0400

Signature of Registered Agent

David Ginter

Printed Name

President

Title

10/23/2023

Date

FCC Form 854
Main Form

Approved by OMD – 3060-0139
See instructions for public burden estimate

Application for Antenna Structure Registration

Purpose of Filing

- 1) Enter the application purpose: (AM)

AM – Amendment of a Pending Application

AU – Administrative Update

CA – Cancellation of an Antenna Structure Registration

DI – Notification of an Antenna Structure Dismantlement

MD – Modification of a Antenna Structure Registration

NE – Registration of a New Antenna Structure

NT – Required Construction/Alteration Notification

OC – Ownership Change

RE – Registration of a Replacement Antenna Structure

WD – Withdrawal of a Pending Application

2a) If the answer to 1 is AU, CA, DI, MD, NT, OC or RE, provide the FCC Antenna Structure Registration (ASR) Number:	FCC ASR Number:
2b) If the answer to 1 is AM or WD, provide the File Number of the pending application on file.	File Number: A1248873
2c) If the answer to 1 is MD or NT, provide the date the Antenna Structure was constructed or the date it was last altered (mm/dd/yyyy).	Date:
2d) If the answer to 1 is DI, provide the date the Antenna Structure was dismantled (mm/dd/yyyy).	Date:

Antenna Structure Ownership Information

- 3) Select one of the entity types:

() Individual () Unincorporated Association () Trust () Government Entity
() Corporation () Limited Liability Company () General Partnership () Limited Partnership
() Consortium () Limited Liability Partnership () Other: _____

4) FCC Registration Number (FRN):
0030199905

5) Assignor FCC Registration Number (FRN):

6) First Name (if individual):

MI:

Last Name:

Suffix:

7) Legal Entity Name (if not an individual):

TAG Towers, LLC

8) Attention To:
David Ginter

9) P.O. Box:

And/Or

10a) Street Address 1:
108 Forbes Court

10b) Street Address 2:
Suite 1

11) City:
Richmond

12) State:
KY

13) Zip Code:
40475

14) Telephone Number (xxx-xxx-xxxx):
(859) 544-5000

15) Fax Number: (xxx-xxx-xxxx):

16) E-mail Address:
dginter@tagtowers.com

Contact Representative Information

17) First Name (if individual): David	MI:	Last Name: Ginter	Suffix:
18) Business Name: TAG Towers, LLC			
19) Attention To: David Ginter	20) P.O. Box		And/Or
21a) Street Address 1: 108 Forbes Court		21b) Street Address 2: Suite 1	
22) City: Richmond	23) State: KY	24) Zip Code: 40475	
25) Telephone Number (xxx-xxx-xxxx): (859) 544-5000		26) Fax Number: (xxx-xxx-xxxx):	
27) E-mail Address: dginter@tagtowers.com			

Antenna Structure Information

28a) Latitude (DD-MM-SS.S): 37- 19- 32.6	28b) North or South: North	
29a) Longitude (DDD-MM-SS.S): 084- 15- 28.8	29b) East or West: West	
30) Street Address or Geographic Location: Off of Frosty Hollow Road	31) City: Mt Vernon	
32) County: ROCKCASTLE	33) State: KENTUCKY	34) Zip Code: 40456
35) Elevation of site above mean sea level (meters): 366.2 meters		
36) Overall height above ground level (AGL) of the supporting structure without appurtenances: 91.4 meters		
37) Overall height above ground level (AGL) of the antenna structure including all appurtenances: 92.7 meters		
38) Overall height above mean sea level (add items 35 and 37 together): 458.9 meters		

39a) Enter the type of structure on which the antenna will be mounted: (**LTOWER**)

B – Building
BANT – Building with Antenna on Top
BMAST – Building with Mast
BPIPE – Building with Pipe
BPOLE – Building with Pole
BRIDG – Bridge
BTWR – Building with Tower
GTOWER – Guyed Structure Used For Communication Purposes
LTOWER – Lattice Tower
MAST – Mast
MTOWER – Monopole
NNGTANN – Guyed Tower Array

NNLTANN – Lattice Tower Array
NNMTANN – Monopole Array
PIPE – Any type of Pipe
POLE – Any type of Pole
RIG – Oil or Other Type of Rig
SIGN – Any type of Sign or Billboard
SILO – Any type of Silo
STACK – Smoke Stack
TANK – Any type of Tank (water, gas, etc.)
TREE – When used as a support for an antenna
UPOLE – Utility Pole/Tower used to provide service (electric, telephone, etc.)

39b) Number of Towers in Array:	39c) Position of this Tower in the Array:
40a) Array Center Latitude (DD-MM-SS.S):	40b) North or South
41a) Array Center Longitude (DDD-MM-SS.S):	41b) East or West:

Proposed Marking and/or Lighting

42) Enter the proposed marking and/or lighting: (7)
See Form 854 Item 42 Instructions for detailed tier and lighting information.

1) None
2) Paint Only
3) Other _____

4) FAA Style B
5) FAA Style D
6) FAA Style C

7) FAA Style E
8) FAA Style F
9) FAA Style A
10) FAA Style G

FAA Notification

43) FAA Study Number:

44) Date Issued:

Environmental Compliance

45) Does the applicant request a waiver of the Commission's rules for environmental notice prior to construction due to an emergency situation?	(No) Yes or No
46a) If the answer to 45 is No, is another federal agency taking responsibility for environmental review of the Antenna Structure?	(No) Yes or No
46b) If the answer to 46a is Yes, indicate why: 1) The Antenna Structure is on Federal Land and the landholding agency is taking responsibility for the environmental review of the Antenna Structure. 2) Another federal agency has agreed with the FCC in writing to take responsibility for the environmental review of the Antenna Structure.	() 1 or 2
46c) If the answer to 46a is Yes, provide the name of the federal agency taking responsibility for the environmental review of the Antenna Structure.	Name:
47) If the answers to 45 and 46a are No, provide the National Notice Date for the application to be posted on the FCC's website (mm/dd/yyyy).	Date: 08/16/2023
48) Is the applicant submitting an environmental assessment?	(No) Yes or No
49) Does the applicant certify that grant of Authorizations at this location would not have a significant environmental effect pursuant to Section 1.1307 of the FCC's rules?	() Yes or No
50) If the answer to 49 is Yes, select the basis for this certification. 1) The construction is exempt from environmental notification (other than due to another agency's review) and it does not fall within one of the categories in Section 1.1307(a) or (b) of the FCC's rules? 2) The construction is exempt from environmental notification due to another agency's review, and the other agency has issued a Finding of No Significant Impact. 3) The environmental notification has been completed, and the FCC has notified the applicant that an Environmental Assessment is not required under Section 1.1307(c) or (d) of the FCC's rules, and the Construction does not fall within one of the categories in Section 1.1307(a) or (b) of the FCC's rules. 4) The FCC has issued a Finding of No Significant Impact.	() 1, 2, 3, 4
51) If the answer to 50 is 3 or 4, enter the date that Local Notice was provided (mm/dd/yyyy).	Date:

Certification Statements

- | |
|---|
| 1) The applicant certifies that all statements made in this application and in the exhibits, attachments, or documents incorporated by reference are material, are part of this application, and are true, complete, correct, and made in good faith. |
| 2) The applicant certifies that neither the applicant nor any other party to the application is subject to a denial of Federal benefits pursuant to Section 5301 of the Anti-Drug Abuse Act of 1988, 21 U.S.C. § 862, because of a conviction for possession or distribution of a controlled substance. See Section 1.2002(b) of the rules, 47 CFR § 1.2002(b), for the definition of "party to the application" as used in this certification. |

Signature (Typed or Printed Name of Party Authorized to Sign) (For OC Applications, to be completed by Assignee)

52) First Name: David	MI:	Last Name: Ginter	Suffix:
53) Title: Manager			
54) Signature: David Ginter	55) Date: Aug 15, 2023		

Signature (Typed or Printed Name of Party Authorized to Sign) (For OC Applications, to be completed by Assignor)

56) First Name:	MI:	Last Name:	Suffix:
57) Title:			
58) Signature:	59) Date:		

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Federal Communications Commission
Wireless Telecommunications Bureau

RADIO STATION AUTHORIZATION

LICENSEE: RURAL CELLULAR CORPORATION

ATTN: REGULATORY
RURAL CELLULAR CORPORATION
5055 NORTH POINT PKWY, NP2NE NETWORK ENGINEERING
ALPHARETTA, GA 30022

Call Sign KNKN940	File Number 0009139416
Radio Service CL - Cellular	
Market Numer CMA448	Channel Block A
Sub-Market Designator 0	

FCC Registration Number (FRN): 0003715919

Market Name Kentucky 6 - Madison				
Grant Date 09-01-2020	Effective Date 09-01-2020	Expiration Date 10-01-2030	Five Yr Build-Out Date	Print Date 09-01-2020

Site Information:

Location	Latitude	Longitude	Ground Elevation (meters)	Structure Hgt to Tip (meters)	Antenna Structure Registration No.
1	37-42-55.3 N	084-16-14.8 W			

Address: WEST OF US-25 1.2 MILES SOUTH OF INTERSECTION OF US-25 & SR-876

City: RICHMOND **County:** MADISON **State:** KY **Construction Deadline:**

Antenna: 1

Maximum Transmitting ERP in Watts: 115.000

Antenna Height AAT (meters)	0	45	90	135	180	225	270	315
Transmitting ERP (watts)	137.000	130.000	127.000	93.000	96.000	102.000	124.000	114.000
	74.000	74.000	74.000	74.000	74.000	74.000	74.000	74.000

Conditions:

Pursuant to §309(h) of the Communications Act of 1934, as amended, 47 U.S.C. §309(h), this license is subject to the following conditions: This license shall not vest in the licensee any right to operate the station nor any right in the use of the frequencies designated in the license beyond the term thereof nor in any other manner than authorized herein. Neither the license nor the right granted thereunder shall be assigned or otherwise transferred in violation of the Communications Act of 1934, as amended. See 47 U.S.C. § 310(d). This license is subject in terms to the right of use or control conferred by §706 of the Communications Act of 1934, as amended. See 47 U.S.C. §606.

Licensee Name: RURAL CELLULAR CORPORATION

Call Sign: KNKN940

File Number: 0009139416

Print Date: 09-01-2020

Location	Latitude	Longitude	Ground Elevation (meters)	Structure Hgt to Tip (meters)	Antenna Structure Registration No.
2	37-25-40.3 N	084-21-51.8 W			
Address: ON LEAR KNOB 3 MILES NW OF					
City: BRODHEAD	County: ROCKCASTLE	State: KY	Construction Deadline:		

Antenna: 1

Maximum Transmitting ERP in Watts:	175.000						
Azimuth(from true north)	0 45 90 135 180 225 270 315						
Antenna Height AAT (meters)	198.000						
Transmitting ERP (watts)	100.000						
100.000	100.000	100.000	100.000	100.000	100.000	100.000	100.000

Location	Latitude	Longitude	Ground Elevation (meters)	Structure Hgt to Tip (meters)	Antenna Structure Registration No.
3	37-17-21.3 N	084-15-51.8 W	430.0		
Address: ON SAND HILL 2.6 MILES SOUTHWEST OF					
City: LIVINGSTON	County: ROCKCASTLE	State: KY	Construction Deadline:		

Antenna: 1

Maximum Transmitting ERP in Watts:	172.000						
Azimuth(from true north)	0 45 90 135 180 225 270 315						
Antenna Height AAT (meters)	175.000						
Transmitting ERP (watts)	47.000						
47.000	22.000	19.000	41.000	90.000	114.000	120.000	102.000

Location	Latitude	Longitude	Ground Elevation (meters)	Structure Hgt to Tip (meters)	Antenna Structure Registration No.
4	37-08-57.3 N	084-05-58.8 W	408.0		
Address: 1 MILE NORTH OF					
City: LONDON	County: LAUREL	State: KY	Construction Deadline:		

Antenna: 1

Maximum Transmitting ERP in Watts:	138.000						
Azimuth(from true north)	0 45 90 135 180 225 270 315						
Antenna Height AAT (meters)	139.000						
Transmitting ERP (watts)	40.000						
40.000	34.000	54.000	128.000	146.000	137.000	146.000	95.000

Location	Latitude	Longitude	Ground Elevation (meters)	Structure Hgt to Tip (meters)	Antenna Structure Registration No.
5	37-36-05.3 N	084-39-36.8 W			
Address: 4 MILES SOUTHWEST OF					
City: LANCASTER	County: LINCOLN	State: KY	Construction Deadline:		

Antenna: 1

Maximum Transmitting ERP in Watts:	128.000						
Azimuth(from true north)	0 45 90 135 180 225 270 315						
Antenna Height AAT (meters)	139.000						
Transmitting ERP (watts)	100.000						
100.000	100.000	100.000	100.000	100.000	100.000	100.000	100.000

Licensee Name: RURAL CELLULAR CORPORATION

Call Sign: KNKN940

File Number: 0009139416

Print Date: 09-01-2020

Location	Latitude	Longitude	Ground Elevation (meters)	Structure Hgt to Tip (meters)	Antenna Structure Registration No.
7	37-01-05.3 N	084-34-53.8 W			
Address: Hilltop, 2.2 miles NNE of City: Burnside County: PULASKI State: KY Construction Deadline:					

Antenna: 1

Maximum Transmitting ERP in Watts:	196.000	Azimuth(from true north)	0	45	90	135	180	225	270	315
Antenna Height AAT (meters)	183.000		178.000	176.000	206.000	210.000	185.000	219.000	211.000	
Transmitting ERP (watts)	0.310		0.160	0.170	0.190	16.270	73.910	75.320	20.900	

Location	Latitude	Longitude	Ground Elevation (meters)	Structure Hgt to Tip (meters)	Antenna Structure Registration No.
8	37-38-52.6 N	084-47-12.9 W	297.5	91.4	1043353
Address: 211 FOREST AVENUE City: DANVILLE County: BOYLE State: KY Construction Deadline:					

Antenna: 1

Maximum Transmitting ERP in Watts:	140.820	Azimuth(from true north)	0	45	90	135	180	225	270	315
Antenna Height AAT (meters)	88.800		101.000	95.900	80.700	60.400	47.100	83.700	90.000	
Transmitting ERP (watts)	51.720		51.720	51.720	51.720	51.340	51.720	51.720	51.720	

Location	Latitude	Longitude	Ground Elevation (meters)	Structure Hgt to Tip (meters)	Antenna Structure Registration No.
9	37-52-45.3 N	084-19-32.8 W	277.0		
Address: 0.45 MILES NORTHEAST OF INTERSECTION OF I-75 & US-25/421 1 MILE ESE OF City: CLAYS FERRY County: CLARK State: KY Construction Deadline:					

Antenna: 1

Maximum Transmitting ERP in Watts:	109.000	Azimuth(from true north)	0	45	90	135	180	225	270	315
Antenna Height AAT (meters)	92.000		122.000	158.000	111.000	90.000	121.000	102.000	77.000	
Transmitting ERP (watts)	1.120		6.920	58.880	100.000	100.000	91.200	22.390	0.930	

Location	Latitude	Longitude	Ground Elevation (meters)	Structure Hgt to Tip (meters)	Antenna Structure Registration No.
12	37-21-22.3 N	084-55-12.8 W	336.0		
Address: On ridge 2 3/4 miles north-northeast of the town of liberty City: Liberty County: CASEY State: KY Construction Deadline:					

Antenna: 1

Maximum Transmitting ERP in Watts:	140.000	Azimuth(from true north)	0	45	90	135	180	225	270	315
Antenna Height AAT (meters)	117.000		132.000	144.000	114.000	152.000	158.000	146.000	159.000	
Transmitting ERP (watts)	75.000		75.000	75.000	75.000	75.000	75.000	75.000	75.000	

Licensee Name: RURAL CELLULAR CORPORATION

Call Sign: KNKN940

File Number: 0009139416

Print Date: 09-01-2020

Location	Latitude	Longitude	Ground Elevation (meters)	Structure Hgt to Tip (meters)	Antenna Structure Registration No.
13	36-59-59.6 N	084-06-05.0 W	366.6	91.1	1002550

Address: (South Laurel site) 1652 N Highway 1223
City: CORBIN County: LAUREL State: KY Construction Deadline:

Antenna: 1

Maximum Transmitting ERP in Watts: 140.820
Azimuth(from true north) **0** **45** **90** **135** **180** **225** **270** **315**
Antenna Height AAT (meters) 86.400 105.600 85.200 78.500 62.400 109.200 104.200 101.600
Transmitting ERP (watts) 60.890 180.300 71.530 58.190 0.640 0.640 0.640 4.200

Antenna: 2
Maximum Transmitting ERP in Watts: 140.820
Azimuth(from true north) **0** **45** **90** **135** **180** **225** **270** **315**
Antenna Height AAT (meters) 86.400 105.600 85.200 78.500 62.400 109.200 104.200 101.600
Transmitting ERP (watts) 0.580 0.580 0.720 3.690 4.920 4.620 2.530 0.580

Antenna: 3
Maximum Transmitting ERP in Watts: 140.820
Azimuth(from true north) **0** **45** **90** **135** **180** **225** **270** **315**
Antenna Height AAT (meters) 86.400 105.600 85.200 78.500 62.400 109.200 104.200 101.600
Transmitting ERP (watts) 46.980 2.590 0.640 0.640 0.640 8.220 89.280 172.970

Location	Latitude	Longitude	Ground Elevation (meters)	Structure Hgt to Tip (meters)	Antenna Structure Registration No.
14	37-46-29.3 N	084-19-15.8 W	287.4		

Address: MTSO CELL SITE: 124 S. KEENELAND DR
City: RICHMOND County: MADISON State: KY Construction Deadline:

Antenna: 1

Maximum Transmitting ERP in Watts: 186.000
Azimuth(from true north) **0** **45** **90** **135** **180** **225** **270** **315**
Antenna Height AAT (meters) 46.600 70.700 52.500 32.100 28.400 45.800 59.500 44.500
Transmitting ERP (watts) 88.000 181.800 171.600 177.600 162.000 53.600 17.200 19.000

Location	Latitude	Longitude	Ground Elevation (meters)	Structure Hgt to Tip (meters)	Antenna Structure Registration No.
16	37-32-51.3 N	084-19-58.8 W	378.0		

Address: BEREAL CELL SITE: 3.5 KILOMETERS SOUTHWEST OF
City: BEREAL County: MADISON State: KY Construction Deadline:

Antenna: 1

Maximum Transmitting ERP in Watts: 100.000
Azimuth(from true north) **0** **45** **90** **135** **180** **225** **270** **315**
Antenna Height AAT (meters) 173.900 164.000 127.800 71.600 126.700 133.400 156.000 194.700
Transmitting ERP (watts) 100.000 100.000 100.000 100.000 100.000 100.000 100.000 100.000

Licensee Name: RURAL CELLULAR CORPORATION

Call Sign: KNKN940

File Number: 0009139416

Print Date: 09-01-2020

Location	Latitude	Longitude	Ground Elevation (meters)	Structure Hgt to Tip (meters)	Antenna Structure Registration No.
17	37-04-42.3 N	084-48-36.8 W	366.3	91.1	1203424

Address: 3.4 miles East of Nancy, KY

City: Nancy County: PULASKI State: KY Construction Deadline:

Antenna: 1

Maximum Transmitting ERP in Watts: 140.820

Azimuth(from true north)	0	45	90	135	180	225	270	315
Antenna Height AAT (meters)	120.400	163.100	170.400	196.600	188.000	195.900	164.000	150.900
Transmitting ERP (watts)	29.000	29.000	29.000	29.000	29.000	29.000	29.000	29.000

Location	Latitude	Longitude	Ground Elevation (meters)	Structure Hgt to Tip (meters)	Antenna Structure Registration No.
18	37-38-56.9 N	084-57-46.2 W	289.0	48.2	

Address: Perryville Cell Site: 710 Cox Street

City: Perryville County: BOYLE State: KY Construction Deadline:

Antenna: 1

Maximum Transmitting ERP in Watts: 140.820

Azimuth(from true north)	0	45	90	135	180	225	270	315
Antenna Height AAT (meters)	90.100	62.100	41.400	-1.800	24.600	40.300	71.100	64.200
Transmitting ERP (watts)	99.100	143.700	70.200	6.300	0.400	0.400	0.500	14.200

Antenna: 2

Maximum Transmitting ERP in Watts: 140.820

Azimuth(from true north)	0	45	90	135	180	225	270	315
Antenna Height AAT (meters)	90.100	62.100	41.400	-1.800	24.600	40.300	71.100	64.200
Transmitting ERP (watts)	0.400	1.600	33.200	128.600	132.400	39.100	2.200	0.400

Antenna: 3

Maximum Transmitting ERP in Watts: 140.820

Azimuth(from true north)	0	45	90	135	180	225	270	315
Antenna Height AAT (meters)	90.100	62.100	41.400	-1.800	24.600	40.300	71.100	64.200
Transmitting ERP (watts)	9.000	0.400	0.400	0.400	10.400	87.000	143.500	82.100

Location	Latitude	Longitude	Ground Elevation (meters)	Structure Hgt to Tip (meters)	Antenna Structure Registration No.
19	37-06-10.0 N	084-35-45.0 W	388.0	91.4	1043625

Address: (Somerset site) 500 Rock Query Road

City: SOMERSET County: PULASKI State: KY Construction Deadline: 05-30-2014

Antenna: 1

Maximum Transmitting ERP in Watts: 140.820

Azimuth(from true north)	0	45	90	135	180	225	270	315
Antenna Height AAT (meters)	159.200	158.600	169.600	169.900	213.500	200.800	177.700	154.800
Transmitting ERP (watts)	110.230	148.690	21.490	0.730	0.400	0.330	0.450	7.630

Antenna: 3

Maximum Transmitting ERP in Watts: 140.820

Azimuth(from true north)	0	45	90	135	180	225	270	315
Antenna Height AAT (meters)	159.200	158.600	169.600	169.900	213.500	200.800	177.700	154.800
Transmitting ERP (watts)	0.330	0.620	0.330	0.330	2.050	69.550	163.040	61.990

Licensee Name: RURAL CELLULAR CORPORATION

Call Sign: KNKN940

File Number: 0009139416

Print Date: 09-01-2020

Location	Latitude	Longitude	Ground Elevation (meters)	Structure Hgt to Tip (meters)	Antenna Structure Registration No.
19	37-06-10.0 N	084-35-45.0 W	388.0	91.4	1043625

Address: (Somerset site) 500 Rock Query Road

City: SOMERSET **County:** PULASKI **State:** KY **Construction Deadline:** 05-30-2014

Antenna: 4

Maximum Transmitting ERP in Watts: 140.820

Azimuth(from true north)	0	45	90	135	180	225	270	315
Antenna Height AAT (meters)	159.200	158.600	169.600	169.900	213.500	200.800	177.700	154.800
Transmitting ERP (watts)	0.330	0.580	29.670	145.310	107.720	4.290	0.590	0.330

Control Points:

Control Pt. No. 2

Address: 500 W Dove Rd

City: Southlake **County:** TARRANT **State:** TX **Telephone Number:** (800)264-6620

Waivers/Conditions:

NONE

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**Federal Communications Commission
Wireless Telecommunications Bureau****RADIO STATION AUTHORIZATION**

LICENSEE: CELLCO PARTNERSHIP

ATTN: REGULATORY
CELLCO PARTNERSHIP
5055 NORTH POINT PKWY, NP2NE NETWORK ENGINEERING
ALPHARETTA, GA 30022

Call Sign	File Number
WQCS428	
Radio Service CW - PCS Broadband	

FCC Registration Number (FRN): 0003290673

Grant Date 04-23-2015	Effective Date 11-01-2016	Expiration Date 05-13-2025	Print Date
Market Number BTA252	Channel Block C		Sub-Market Designator 1
Market Name Lexington, KY			
1st Build-out Date 05-13-2010	2nd Build-out Date	3rd Build-out Date	4th Build-out Date

Waivers/Conditions:

NONE

Conditions:

Pursuant to §309(h) of the Communications Act of 1934, as amended, 47 U.S.C. §309(h), this license is subject to the following conditions: This license shall not vest in the licensee any right to operate the station nor any right in the use of the frequencies designated in the license beyond the term thereof nor in any other manner than authorized herein. Neither the license nor the right granted thereunder shall be assigned or otherwise transferred in violation of the Communications Act of 1934, as amended. See 47 U.S.C. § 310(d). This license is subject in terms to the right of use or control conferred by §706 of the Communications Act of 1934, as amended. See 47 U.S.C. §606.

This license may not authorize operation throughout the entire geographic area or spectrum identified on the hardcopy version. To view the specific geographic area and spectrum authorized by this license, refer to the Spectrum and Market Area information under the Market Tab of the license record in the Universal Licensing System (ULS). To view the license record, go to the ULS homepage at <http://wireless.fcc.gov/uls/index.htm?job=home> and select "License Search". Follow the instructions on how to search for license information.

Licensee Name: CELLCO PARTNERSHIP

Call Sign: WQCS428

File Number:

Print Date:

700 MHz Relicensed Area Information:

Market	Market Name	Buildout Deadline	Buildout Notification	Status
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FCC 601-MB
August 2021

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**Federal Communications Commission
Wireless Telecommunications Bureau****RADIO STATION AUTHORIZATION**

LICENSEE: CELLCO PARTNERSHIP

ATTN: REGULATORY
CELLCO PARTNERSHIP
5055 NORTH POINT PKWY, NP2NE NETWORK ENGINEERING
ALPHARETTA, GA 30022

Call Sign	File Number
WQDI527	
Radio Service CW - PCS Broadband	

FCC Registration Number (FRN): 0003290673

Grant Date 08-17-2015	Effective Date 11-01-2016	Expiration Date 09-06-2025	Print Date
Market Number BTA252	Channel Block C	Sub-Market Designator 7	
Market Name Lexington, KY			
1st Build-out Date 09-06-2010	2nd Build-out Date	3rd Build-out Date	4th Build-out Date

Waivers/Conditions:

NONE

Conditions:

Pursuant to §309(h) of the Communications Act of 1934, as amended, 47 U.S.C. §309(h), this license is subject to the following conditions: This license shall not vest in the licensee any right to operate the station nor any right in the use of the frequencies designated in the license beyond the term thereof nor in any other manner than authorized herein. Neither the license nor the right granted thereunder shall be assigned or otherwise transferred in violation of the Communications Act of 1934, as amended. See 47 U.S.C. § 310(d). This license is subject in terms to the right of use or control conferred by §706 of the Communications Act of 1934, as amended. See 47 U.S.C. §606.

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Licensee Name: CELLCO PARTNERSHIP

Call Sign: WQDI527

File Number:

Print Date:

700 MHz Relicensed Area Information:

Market	Market Name	Buildout Deadline	Buildout Notification	Status
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FCC 601-MB
August 2021

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**Federal Communications Commission
Wireless Telecommunications Bureau****RADIO STATION AUTHORIZATION**

LICENSEE: CELLCO PARTNERSHIP

CELLCO PARTNERSHIP
5055 NORTH POINT PKWY, NP2NE NETWORK ENGINEERING
ALPHARETTA, GA 30022

Call Sign WQGA940	File Number 0009774996
Radio Service AW - AWS (1710-1755 MHz and 2110-2155 MHz)	

FCC Registration Number (FRN): 0003290673

Grant Date 12-21-2021	Effective Date 12-21-2021	Expiration Date 11-29-2036	Print Date 12-21-2021
Market Number BEA047	Channel Block B		Sub-Market Designator 11
Market Name Lexington, KY-TN-VA-WV			
1st Build-out Date	2nd Build-out Date	3rd Build-out Date	4th Build-out Date

Waivers/Conditions:

This authorization is conditioned upon the licensee, prior to initiating operations from any base or fixed station, making reasonable efforts to coordinate frequency usage with known co-channel and adjacent channel incumbent federal users operating in the 1710-1755 MHz band whose facilities could be affected by the proposed operations. See, e.g., FCC and NTIA Coordination Procedures in the 1710-1755 MHz Band, Public Notice, FCC 06-50, WTB Docket No. 02-353, rel. April 20, 2006.

Conditions:

Pursuant to §309(h) of the Communications Act of 1934, as amended, 47 U.S.C. §309(h), this license is subject to the following conditions: This license shall not vest in the licensee any right to operate the station nor any right in the use of the frequencies designated in the license beyond the term thereof nor in any other manner than authorized herein. Neither the license nor the right granted thereunder shall be assigned or otherwise transferred in violation of the Communications Act of 1934, as amended. See 47 U.S.C. § 310(d). This license is subject in terms to the right of use or control conferred by §706 of the Communications Act of 1934, as amended. See 47 U.S.C. §606.

This license may not authorize operation throughout the entire geographic area or spectrum identified on the hardcopy version. To view the specific geographic area and spectrum authorized by this license, refer to the Spectrum and Market Area information under the Market Tab of the license record in the Universal Licensing System (ULS). To view the license record, go to the ULS homepage at <http://wireless.fcc.gov/uls/index.htm?job=home> and select "License Search". Follow the instructions on how to search for license information.

Licensee Name: CELLCO PARTNERSHIP

Call Sign: WQGA940

File Number: 0009774996

Print Date: 12-21-2021

700 MHz Relicensed Area Information:

Market	Market Name	Buildout Deadline	Buildout Notification	Status
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**Federal Communications Commission
Wireless Telecommunications Bureau****RADIO STATION AUTHORIZATION**

LICENSEE: CELLCO PARTNERSHIP

ATTN: REGULATORY
CELLCO PARTNERSHIP
5055 NORTH POINT PKWY, NP2NE NETWORK ENGINEERING
ALPHARETTA, GA 30022

Call Sign	File Number
WQJQ692	
Radio Service	
WU - 700 MHz Upper Band (Block C)	

FCC Registration Number (FRN): 0003290673

Grant Date 01-10-2020	Effective Date 02-11-2021	Expiration Date 06-13-2029	Print Date
Market Number REA004	Channel Block C	Sub-Market Designator 0	
Market Name Mississippi Valley			
1st Build-out Date 06-13-2013	2nd Build-out Date 06-13-2019	3rd Build-out Date	4th Build-out Date

Waivers/Conditions:

If the facilities authorized herein are used to provide broadcast operations, whether exclusively or in combination with other services, the licensee must seek renewal of the license either within eight years from the commencement of the broadcast service or within the term of the license had the broadcast service not been provided, whichever period is shorter in length. See 47 CFR §27.13(b).

This authorization is conditioned upon compliance with section 27.16 of the Commission's rules

Conditions:

Pursuant to §309(h) of the Communications Act of 1934, as amended, 47 U.S.C. §309(h), this license is subject to the following conditions: This license shall not vest in the licensee any right to operate the station nor any right in the use of the frequencies designated in the license beyond the term thereof nor in any other manner than authorized herein. Neither the license nor the right granted thereunder shall be assigned or otherwise transferred in violation of the Communications Act of 1934, as amended. See 47 U.S.C. § 310(d). This license is subject in terms to the right of use or control conferred by §706 of the Communications Act of 1934, as amended. See 47 U.S.C. §606.

This license may not authorize operation throughout the entire geographic area or spectrum identified on the hardcopy version. To view the specific geographic area and spectrum authorized by this license, refer to the Spectrum and Market Area information under the Market Tab of the license record in the Universal Licensing System (ULS). To view the license record, go to the ULS homepage at <http://wireless.fcc.gov/uls/index.htm?job=home> and select "License Search". Follow the instructions on how to search for license information.

Licensee Name: CELLCO PARTNERSHIP

Call Sign: WQJQ692

File Number:

Print Date:

700 MHz Relicensed Area Information:

Market	Market Name	Buildout Deadline	Buildout Notification	Status
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Reference Copy

FCC 601-MB
August 2021

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**Federal Communications Commission
Wireless Telecommunications Bureau****RADIO STATION AUTHORIZATION**

LICENSEE: RURAL CELLULAR CORPORATION

ATTN: REGULATORY
RURAL CELLULAR CORPORATION
5055 NORTH POINT PKWY, NP2NE NETWORK ENGINEERING
ALPHARETTA, GA 30022

Call Sign	File Number
WQUZ670	
Radio Service AW - AWS (1710-1755 MHz and 2110-2155 MHz)	

FCC Registration Number (FRN): 0003715919

Grant Date 11-16-2021	Effective Date 09-23-2022	Expiration Date 11-29-2036	Print Date 02-16-2023
Market Number REA004	Channel Block D	Sub-Market Designator 10	
Market Name Mississippi Valley			
1st Build-out Date	2nd Build-out Date	3rd Build-out Date	4th Build-out Date

Waivers/Conditions:

This authorization is conditioned upon the licensee, prior to initiating operations from any base or fixed station, making reasonable efforts to coordinate frequency usage with known co-channel and adjacent channel incumbent federal users operating in the 1710-1755 MHz band whose facilities could be affected by the proposed operations. See, e.g., FCC and NTIA Coordination Procedures in the 1710-1755 MHz Band, Public Notice, FCC 06-50, WTB Docket No. 02-353, rel. April 20, 2006.

Conditions:

Pursuant to §309(h) of the Communications Act of 1934, as amended, 47 U.S.C. §309(h), this license is subject to the following conditions: This license shall not vest in the licensee any right to operate the station nor any right in the use of the frequencies designated in the license beyond the term thereof nor in any other manner than authorized herein. Neither the license nor the right granted thereunder shall be assigned or otherwise transferred in violation of the Communications Act of 1934, as amended. See 47 U.S.C. § 310(d). This license is subject in terms to the right of use or control conferred by §706 of the Communications Act of 1934, as amended. See 47 U.S.C. §606.

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Licensee Name: RURAL CELLULAR CORPORATION

Call Sign: WQUZ670

File Number:

Print Date: 02-16-2023

The license is subject to compliance with the provisions of the January 12, 2001 Agreement between Deutsche Telekom AG, VoiceStream Wireless Corporation, VoiceStream Wireless Holding Corporation and the Department of Justice (DOJ) and the Federal Bureau of Investigation (FBI), which addresses national security, law enforcement, and public safety issues of the FBI and the DOJ regarding the authority granted by this license. Nothing in the Agreement is intended to limit any obligation imposed by Federal law or regulation including, but not limited to, 47 U.S.C. Section 222(a) and (c)(1) and the FCC's implementing regulations. The Agreement is published at VoiceStream-DT Order, IB Docket No. 00-187, FCC 01-142, 16 FCC Rcd 9779, 9853 (2001).

Licensee Name: RURAL CELLULAR CORPORATION

Call Sign: WQUZ670

File Number:

Print Date: 02-16-2023

700 MHz Relicensed Area Information:

Market	Market Name	Buildout Deadline	Buildout Notification	Status
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**Federal Communications Commission
Wireless Telecommunications Bureau****RADIO STATION AUTHORIZATION**

LICENSEE: CELLCO PARTNERSHIP

ATTN: REGULATORY
CELLCO PARTNERSHIP
5055 NORTH POINT PKWY, NP2NE ENGINEERING
ALPHARETTA, GA 30022

Call Sign WRAM732	File Number 0009262182
Radio Service WT - 600 MHz Band	

FCC Registration Number (FRN): 0003290673

Grant Date 01-09-2018	Effective Date 01-13-2021	Expiration Date 01-09-2030	Print Date 03-11-2021
Market Number PEA096	Channel Block A	Sub-Market Designator 1	
Market Name Richmond, KY			
1st Build-out Date 01-09-2024	2nd Build-out Date	3rd Build-out Date	4th Build-out Date

Waivers/Conditions:

NONE

Conditions:

Pursuant to §309(h) of the Communications Act of 1934, as amended, 47 U.S.C. §309(h), this license is subject to the following conditions: This license shall not vest in the licensee any right to operate the station nor any right in the use of the frequencies designated in the license beyond the term thereof nor in any other manner than authorized herein. Neither the license nor the right granted thereunder shall be assigned or otherwise transferred in violation of the Communications Act of 1934, as amended. See 47 U.S.C. § 310(d). This license is subject in terms to the right of use or control conferred by §706 of the Communications Act of 1934, as amended. See 47 U.S.C. §606.

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Licensee Name: CELLCO PARTNERSHIP

Call Sign: WRAM732

File Number: 0009262182

Print Date: 03-11-2021

700 MHz Relicensed Area Information:

Market	Market Name	Buildout Deadline	Buildout Notification	Status
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**Federal Communications Commission
Wireless Telecommunications Bureau****RADIO STATION AUTHORIZATION**

LICENSEE: CELLCO PARTNERSHIP

ATTN: REGULATORY
CELLCO PARTNERSHIP
5055 NORTH POINT PKWY, NP2NE ENGINEERING
ALPHARETTA, GA 30022

Call Sign	File Number
WRAY861	
Radio Service UU - Upper Microwave Flexible Use Service	

FCC Registration Number (FRN): 0003290673

Grant Date 07-25-2018	Effective Date 02-27-2019	Expiration Date 06-17-2028	Print Date
Market Number BTA252	Channel Block L1	Sub-Market Designator 0	
Market Name Lexington, KY			
1st Build-out Date 06-01-2024	2nd Build-out Date	3rd Build-out Date	4th Build-out Date

Waivers/Conditions:

Special Condition for AU/name change (6/4/2016): Grant of the request to update licensee name is conditioned on it not reflecting an assignment or transfer of control (see Rule 1.948); if an assignment or transfer occurred without proper notification or FCC approval, the grant is void and the station is licensed under the prior name.

Conditions:

Pursuant to §309(h) of the Communications Act of 1934, as amended, 47 U.S.C. §309(h), this license is subject to the following conditions: This license shall not vest in the licensee any right to operate the station nor any right in the use of the frequencies designated in the license beyond the term thereof nor in any other manner than authorized herein. Neither the license nor the right granted thereunder shall be assigned or otherwise transferred in violation of the Communications Act of 1934, as amended. See 47 U.S.C. § 310(d). This license is subject in terms to the right of use or control conferred by §706 of the Communications Act of 1934, as amended. See 47 U.S.C. §606.

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Licensee Name: CELLCO PARTNERSHIP

Call Sign: WRAY861

File Number:

Print Date:

700 MHz Relicensed Area Information:

Market	Market Name	Buildout Deadline	Buildout Notification	Status
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**Federal Communications Commission
Wireless Telecommunications Bureau****RADIO STATION AUTHORIZATION**

LICENSEE: CELLCO PARTNERSHIP

ATTN: REGULATORY
CELLCO PARTNERSHIP
5055 NORTH POINT PKWY, NP2NE ENGINEERING
ALPHARETTA, GA 30022

Call Sign WREV443	File Number 0009262182
Radio Service UU - Upper Microwave Flexible Use Service	

FCC Registration Number (FRN): 0003290673

Grant Date 12-11-2019	Effective Date 01-13-2021	Expiration Date 12-11-2029	Print Date 03-11-2021
Market Number PEA096	Channel Block A	Sub-Market Designator 3	
Market Name Richmond, KY			
1st Build-out Date	2nd Build-out Date	3rd Build-out Date	4th Build-out Date

Waivers/Conditions:

NONE

Conditions:

Pursuant to §309(h) of the Communications Act of 1934, as amended, 47 U.S.C. §309(h), this license is subject to the following conditions: This license shall not vest in the licensee any right to operate the station nor any right in the use of the frequencies designated in the license beyond the term thereof nor in any other manner than authorized herein. Neither the license nor the right granted thereunder shall be assigned or otherwise transferred in violation of the Communications Act of 1934, as amended. See 47 U.S.C. § 310(d). This license is subject in terms to the right of use or control conferred by §706 of the Communications Act of 1934, as amended. See 47 U.S.C. §606.

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Licensee Name: CELLCO PARTNERSHIP

Call Sign: WREV443

File Number: 0009262182

Print Date: 03-11-2021

700 MHz Relicensed Area Information:

Market	Market Name	Buildout Deadline	Buildout Notification	Status
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**Federal Communications Commission
Wireless Telecommunications Bureau****RADIO STATION AUTHORIZATION**

LICENSEE: CELLCO PARTNERSHIP

ATTN: REGULATORY
CELLCO PARTNERSHIP
5055 NORTH POINT PKWY, NP2NE ENGINEERING
ALPHARETTA, GA 30022

Call Sign WREV444	File Number 0009262182
Radio Service UU - Upper Microwave Flexible Use Service	

FCC Registration Number (FRN): 0003290673

Grant Date 12-11-2019	Effective Date 01-13-2021	Expiration Date 12-11-2029	Print Date 03-11-2021
Market Number PEA096	Channel Block B		Sub-Market Designator 1
Market Name Richmond, KY			
1st Build-out Date	2nd Build-out Date	3rd Build-out Date	4th Build-out Date

Waivers/Conditions:

NONE

Conditions:

Pursuant to §309(h) of the Communications Act of 1934, as amended, 47 U.S.C. §309(h), this license is subject to the following conditions: This license shall not vest in the licensee any right to operate the station nor any right in the use of the frequencies designated in the license beyond the term thereof nor in any other manner than authorized herein. Neither the license nor the right granted thereunder shall be assigned or otherwise transferred in violation of the Communications Act of 1934, as amended. See 47 U.S.C. § 310(d). This license is subject in terms to the right of use or control conferred by §706 of the Communications Act of 1934, as amended. See 47 U.S.C. §606.

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Licensee Name: CELLCO PARTNERSHIP

Call Sign: WREV444

File Number: 0009262182

Print Date: 03-11-2021

700 MHz Relicensed Area Information:

Market	Market Name	Buildout Deadline	Buildout Notification	Status
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**Federal Communications Commission
Wireless Telecommunications Bureau****RADIO STATION AUTHORIZATION**

LICENSEE: CELLCO PARTNERSHIP

ATTN: REGULATORY
CELLCO PARTNERSHIP
5055 NORTH POINT PKWY, NP2NE ENGINEERING
ALPHARETTA, GA 30022

Call Sign WRHE833	File Number 0010283156
Radio Service UU - Upper Microwave Flexible Use Service	

FCC Registration Number (FRN): 0003290673

Grant Date 06-04-2020	Effective Date 11-18-2022	Expiration Date 06-04-2030	Print Date 03-15-2023
Market Number PEA096	Channel Block M1	Sub-Market Designator 0	
Market Name Richmond, KY			
1st Build-out Date	2nd Build-out Date	3rd Build-out Date	4th Build-out Date

Waivers/Conditions:

NONE

Conditions:

Pursuant to §309(h) of the Communications Act of 1934, as amended, 47 U.S.C. §309(h), this license is subject to the following conditions: This license shall not vest in the licensee any right to operate the station nor any right in the use of the frequencies designated in the license beyond the term thereof nor in any other manner than authorized herein. Neither the license nor the right granted thereunder shall be assigned or otherwise transferred in violation of the Communications Act of 1934, as amended. See 47 U.S.C. § 310(d). This license is subject in terms to the right of use or control conferred by §706 of the Communications Act of 1934, as amended. See 47 U.S.C. §606.

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Licensee Name: CELLCO PARTNERSHIP

Call Sign: WRHE833

File Number: 0010283156

Print Date: 03-15-2023

700 MHz Relicensed Area Information:

Market	Market Name	Buildout Deadline	Buildout Notification	Status
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**Federal Communications Commission
Wireless Telecommunications Bureau****RADIO STATION AUTHORIZATION**

LICENSEE: RURAL CELLULAR CORPORATION

ATTN: REGULATORY
RURAL CELLULAR CORPORATION
5055 NORTH POINT PKWY, NP2NE NETWORK ENGINEERING
ALPHARETTA, GA 30022

Call Sign WRWF636	File Number 0010160917
Radio Service AW - AWS (1710-1755 MHz and 2110-2155 MHz)	

FCC Registration Number (FRN): 0003715919

Grant Date 09-23-2022	Effective Date 09-23-2022	Expiration Date 12-18-2036	Print Date 02-16-2023
Market Number BEA047	Channel Block C		Sub-Market Designator 14
Market Name Lexington, KY-TN-VA-WV			
1st Build-out Date	2nd Build-out Date	3rd Build-out Date	4th Build-out Date

Waivers/Conditions:

This authorization is conditioned upon the licensee, prior to initiating operations from any base or fixed station, making reasonable efforts to coordinate frequency usage with known co-channel and adjacent channel incumbent federal users operating in the 1710-1755 MHz band whose facilities could be affected by the proposed operations. See, e.g., FCC and NTIA Coordination Procedures in the 1710-1755 MHz Band, Public Notice, FCC 06-50, WTB Docket No. 02-353, rel. April 20, 2006.

Special Condition for AU/name change (6/4/2016): Grant of the request to update licensee name is conditioned on it not reflecting an assignment or transfer of control (see Rule 1.948); if an assignment or transfer occurred without proper notification or FCC approval, the grant is void and the station is licensed under the prior name.

Conditions:

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Licensee Name: RURAL CELLULAR CORPORATION


Call Sign: WRWF636

File Number: 0010160917

Print Date: 02-16-2023

700 MHz Relicensed Area Information:

Market	Market Name	Buildout Deadline	Buildout Notification	Status
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**TAG
TOWERS**
108 FORBES COURT, SUITE 1
RICHMOND, KY 40475
859.544.5000 (PH)

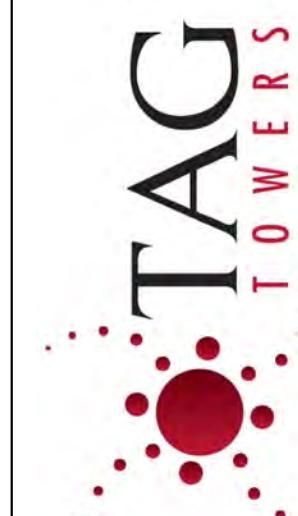**NEW 300' SELF SUPPORT TOWER
W/4' LIGHTNING ROD
TOTAL TOWER HEIGHT 304'**

PROJECT DESCRIPTION:

NOTE: ALL ITEMS WITHIN THESE CONSTRUCTION DOCUMENTS ARE BY OWNER'S GENERAL CONTRACTOR AND HIS SUB-CONTRACTORS UNLESS NOTED AS (VZW GC) WHICH SHALL INCLUDE VERIZON WIRELESS, GENERAL CONTRACTOR AND HIS SUB-CONTRACTORS, GENERALLY DESCRIBED BELOW:
 OWNER OWNER: SCOPES
 • INSTALL A NEW 300' SELF SUPPORT TOWER w/ 4' LIGHTNING ROD (TOTAL 304')
 • INSTALL A NEW TOWER FOUNDATION SYSTEM
 • INSTALL A NEW FENCED GRAVEL COMPOUND
 • INSTALL A NEW ELECTRICAL SERVICE RUN TO SITE UTILITY H-FRAME
 • INSTALL A NEW GRAVEL ACCESS DRIVE
 • NO WATER OR SEWAGE SERVICES TO SITE
 • INSTALL NEW TOWER & SITE GROUNDING SYSTEM
 • INSTALL NEW VZW SUBSURFACE GROUNDING SYSTEM
 • INSTALL NEW VZW CONCRETE EQUIPMENT FOUNDATIONS AND GENERATOR PADS
 • INSTALL VZW ICE BRIDGE AND FOUNDATIONS
 • INSTALL VZW EQUIPMENT H-FRAME AND FOUNDATIONS
 • INSTALL VZW ELECTRICAL SERVICE CONDUIT WITH PULL TAPES FROM ILC ENCLOSURE
 • SUB UP TO NEW VZW H-FRAME STUB-UP LOCATION TO THE GENERATOR SUB
 • INSULLATE CONDUITS WITH FULL TAPES FROM VZW ILC STUB-UP LOCATION TO THE GENERATOR SUB AT VZW GENERATOR PAD
 • INSTALL (1) NEW VZW FIBER OPTIC CONDUIT WITH INTEGRAL FIBER
 • INSTALL VZW EQUIPMENT PAD AND TRACER WIRE FROM VZW EQUIPMENT TO NEW VZW WIRELESS ONLY 24" X 36" HAND HOLE AT ROW.
 • PERMANENT ELECTRIC POWER MUST BE AVAILABLE FOR VZW WIRELESS AT THE METER BASE PRIOR TO THE SITE BEING RELEASED AS TENANT READY.

VERIZON WIRELESS, ONLY

GENERAL INFORMATION:
 LATITUDE - 37° 19' 32.58" N
 LONGITUDE - 84° 15' 28.77" W
 ELEVATION - 1201.4" AMSL
 1988 (NAVD88)

TOWER OWNER:

TAG TOWERS, LLC
108 FORBES COURT, SUITE 1
RICHMOND, KY 40475
PHONE: (859) 544-5000

PROPERTY OWNER:

CLYDE & MARGALINE COLLINS
321 FROSTY HOLLOW ROAD
MT. VERNON, KY 40456

PROJECT TOTAL DISTURBED AREA:

COMPOUND: (2750 SF) = (0.086088 ACRE)
 ACCESS DRIVE: (40510.8 SF) = (0.93 ACRE)
 GROSS AREA: (44260.8 SF) = (1.016088 ACRE)

PROJECT SUMMARY:

ALL CONSTRUCTION ITEMS ARE TO BE COMPLETED BY THE OWNER GENERAL CONTRACTOR UNLESS NOTED AS (VZW GC) WHICH SHALL BE COMPLETED BY THE VERIZON WIRELESS GENERAL CONTRACTOR

PROJECT DESCRIPTION:

ELECTRICAL
 12'-0" x 30'-0"
 (360 SF)

PROJECT TOTAL DISTURBED AREA:

COMPOUND: (2750 SF) = (0.086088 ACRE)
 ACCESS DRIVE: (40510.8 SF) = (0.93 ACRE)
 GROSS AREA: (44260.8 SF) = (1.016088 ACRE)

PROJECT SUMMARY:

ALL CONSTRUCTION ITEMS ARE TO BE COMPLETED BY THE OWNER GENERAL CONTRACTOR UNLESS NOTED AS (VZW GC) WHICH SHALL BE COMPLETED BY THE VERIZON WIRELESS GENERAL CONTRACTOR

PROJECT DESCRIPTION:

ELECTRICAL
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PROJECT SUMMARY:

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ALL CONSTRUCTION ITEMS ARE TO BE COMPLETED BY THE OWNER GENERAL CONTRACTOR UNLESS NOTED AS (VZW GC) WHICH SHALL BE COMPLETED BY THE VERIZON WIRELESS GENERAL CONTRACTOR

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 ACCESS DRIVE: (40510.8 SF) = (0.93 ACRE)
 GROSS AREA: (44260.8 SF) = (1.016088 ACRE)

PROJECT SUMMARY:

ALL CONSTRUCTION ITEMS ARE TO BE COMPLETED BY THE OWNER GENERAL CONTRACTOR UNLESS NOTED AS (VZW GC) WHICH SHALL BE COMPLETED BY THE VERIZON WIRELESS GENERAL CONTRACTOR

PROJECT DESCRIPTION:

ELECTRICAL
 12'-0" x 30'-0"
 (360 SF)

PROJECT TOTAL DISTURBED AREA:

COMPOUND: (2750 SF) = (0.086088 ACRE)
 ACCESS DRIVE: (40510.8 SF) = (0.93 ACRE)
 GROSS AREA: (44260.8 SF) = (1.016088 ACRE)

PROJECT SUMMARY:

ALL CONSTRUCTION ITEMS ARE TO BE COMPLETED BY THE OWNER GENERAL CONTRACTOR UNLESS NOTED AS (VZW GC) WHICH SHALL BE COMPLETED BY THE VERIZON WIRELESS GENERAL CONTRACTOR

PROJECT DESCRIPTION:

ELECTRICAL
 12'-0" x 30'-0"
 (360 SF)

PROJECT TOTAL DISTURBED AREA:

COMPOUND: (2750 SF) = (0.086088 ACRE)
 ACCESS DRIVE: (40510.8 SF) = (0.93 ACRE)
 GROSS AREA: (44260.8 SF) = (1.016088 ACRE)

PROJECT SUMMARY:

ALL CONSTRUCTION ITEMS ARE TO BE COMPLETED BY THE OWNER GENERAL CONTRACTOR UNLESS NOTED AS (VZW GC) WHICH SHALL BE COMPLETED BY THE VERIZON WIRELESS GENERAL CONTRACTOR

PROJECT DESCRIPTION:

ELECTRICAL
 12'-0" x 30'-0"
 (360 SF)

PROJECT TOTAL DISTURBED AREA:

COMPOUND: (2750 SF) = (0.086088 ACRE)
 ACCESS DRIVE: (40510.8 SF) = (0.93 ACRE)
 GROSS AREA: (44260.8 SF) = (1.016088 ACRE)

PROJECT SUMMARY:

ALL CONSTRUCTION ITEMS ARE TO BE COMPLETED BY THE OWNER GENERAL CONTRACTOR UNLESS NOTED AS (VZW GC) WHICH SHALL BE COMPLETED BY THE VERIZON WIRELESS GENERAL CONTRACTOR

PROJECT DESCRIPTION:

ELECTRICAL
 12'-0" x 30'-0"
 (360 SF)

PROJECT TOTAL DISTURBED AREA:

COMPOUND: (2750 SF) = (0.086088 ACRE)
 ACCESS DRIVE: (40510.8 SF) = (0.93 ACRE)
 GROSS AREA: (44260.8 SF) = (1.016088 ACRE)

PROJECT SUMMARY:

ALL CONSTRUCTION ITEMS ARE TO BE COMPLETED BY THE OWNER GENERAL CONTRACTOR UNLESS NOTED AS (VZW GC) WHICH SHALL BE COMPLETED BY THE VERIZON WIRELESS GENERAL CONTRACTOR

PROJECT DESCRIPTION:

ELECTRICAL
 12'-0" x 30'-0"
 (360 SF)

PROJECT TOTAL DISTURBED AREA:

COMPOUND: (2750 SF) = (0.086088 ACRE)
 ACCESS DRIVE: (40510.8 SF) = (0.93 ACRE)
 GROSS AREA: (44260.8 SF) = (1.016088 ACRE)

PROJECT SUMMARY:

ALL CONSTRUCTION ITEMS ARE TO BE COMPLETED BY THE OWNER GENERAL CONTRACTOR UNLESS NOTED AS (VZW GC) WHICH SHALL BE COMPLETED BY THE VERIZON WIRELESS GENERAL CONTRACTOR

PROJECT DESCRIPTION:

ELECTRICAL
 12'-0" x 30'-0"
 (360 SF)

PROJECT TOTAL DISTURBED AREA:

COMPOUND: (2750 SF) = (0.086088 ACRE)
 ACCESS DRIVE: (40510.8 SF) = (0.93 ACRE)
 GROSS AREA: (44260.8 SF) = (1.016088 ACRE)

PROJECT SUMMARY:

ALL CONSTRUCTION ITEMS ARE TO BE COMPLETED BY THE OWNER GENERAL CONTRACTOR UNLESS NOTED AS (VZW GC) WHICH SHALL BE COMPLETED BY THE VERIZON WIRELESS GENERAL CONTRACTOR

PROJECT DESCRIPTION:

ELECTRICAL
 12'-0" x 30'-0"
 (360 SF)

PROJECT TOTAL DISTURBED AREA:

COMPOUND: (2750 SF) = (0.086088 ACRE)
 ACCESS DRIVE: (40510.8 SF) = (0.93 ACRE)
 GROSS AREA: (44260.8 SF) = (1.016088 ACRE)

PROJECT SUMMARY:

ALL CONSTRUCTION ITEMS ARE TO BE COMPLETED BY THE OWNER GENERAL CONTRACTOR UNLESS NOTED AS (VZW GC) WHICH SHALL BE COMPLETED BY THE VERIZON WIRELESS GENERAL CONTRACTOR

PROJECT DESCRIPTION:

ELECTRICAL
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 (360 SF)

PROJECT TOTAL DISTURBED AREA:

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PROJECT DESCRIPTION:

	- LEGAL DESCRIPTIONS (PARENT TRACT)
	- MILE NOTES

PARENT TRACT DESCRIPTION PROVIDED BY FIDELITY NATIONAL TITLE INSURANCE COMPANY

Property located in Rockcastle County, Kentucky

PARCEL 1:
Beginning at a utility pole on East side of Jack Hurd Road; thence southwesterly along the road to a white oak tree and iron stake, the center of E.B. Allen, Minnie Kirby, and Kelly Coffey; thence westerly approximately 40 feet to an iron stake at the fork of the two principal branches, which is a corner boundary line of E.B. Allen, Maybelle Moore, and Hayes Allen; thence with Hayes Allen boundary line 210 feet to big white oak; thence Southwesterly .88 feet to a pine tree above dwelling; thence Southwest 1.53 feet to iron stake in line of Donald Collins; thence around Donald Collins line to his Northeast corner and line of Hayes Allen; thence to center of branch and along line of Maybelle Moore other west corner; thence with Maybelle Moore's line South 30 degrees East to corner stone and pine tree; thence with Maybelle Moore's line easterly to iron stake and pine tree, the corner of E.B. Allen and Maybelle Moore; thence easterly in a direct line with Ebb B. Allen to property line of James Goforth to a twin hickory tree in fence line .56 feet south of the branch; thence southerly with James Goforth to a hickory at top of ridge, G. D. Mink comes thence northwesterly with Mink down a hill to a corner in the branch with fence; thence westerly continuing with Mink and the fence to a corner on top of Pipe Hill, fence corner; thence northerly with W.T. Payne, J. B. Fain and Tom Reiner lands with a fence to an iron stake in boundary line at a fence corner; thence easterly with a fence, a new line to an iron stake; thence northeasterly a new line to the utility pole, the point of beginning, and containing seven acres more or less.

LESS AND EXCEPT that portion of property conveyed to Michael Collins from Clyde Raymond Collins and Magdalene Collins by Deed of Conveyance dated July 12, 2006 and recorded August 8, 2006 in Deed Book 211, Page 654. (DOES NOT AFFECT THE LEASE AREA, THE ACCESS & UTILITY ESMI, OR THE UTILITY ESMI. SHOWN PER THIS SURVEY)

AND BEING a portion of the same property conveyed to Clyde Raymond Collins and Magdalene Collins from Ebb Ben Allen and Willis Robinson Allen by Deed of Conveyance dated June 17, 1994 and recorded June 22, 1994 in Deed Book 154, Page 282.

Tax Parcel No. 074-00-002

PARCEL 2:
The following described real property located in Rockcastle County, Kentucky, and more particularly bounded and described as follows:

On the waters of Roundstone Creek;

Beginning at a stone in the side of the county road, Albert Griffin's (now John Griffin's) corner; thence south with county road 716 feet to a stone in the edge of county road; thence east a straight line to the top of the ridge to Albert Griffin's line; thence north with Griffin's line to a pine corner in said line; thence west a straight line to the beginning corner and containing ten (.10) acres the same more or less.

LESS AND EXCEPT that portion conveyed to Darrell Collins and Chia G. Collins from Clyde Raymond Collins and Magdalene Collins by Deed of Conveyance dated March 23, 1999 and recorded March 26, 1999 in Deed Book 173, Page 667. (DOES NOT AFFECT THE LEASE AREA, THE ACCESS & UTILITY ESMI, OR THE UTILITY ESMI. SHOWN PER THIS SURVEY)

AND BEING a portion of the same property conveyed to C. Raymond Collins and Magdalene W. Collins from William Cash, Jr., and Doris P. Cash by Deed of Conveyance dated April 20, 1972 and recorded April 25, 1972 in Deed Book 92, Page 320.

Tax Parcel No. 073SW-00-016

PARCEL 3:
The following described real property located in Rockcastle County, Kentucky, and more particularly bounded and described as follows:

Beginning on a pine on the west side of a dirt road and being a corner to Clyde Collins and Benton Miller; thence with line of Miller N13° 42' 25" E, 104.52 feet to a white oak; N 12° 10' 00" E, 314.77 feet to a post; thence N 00° 34' 30" W, 76.40 feet to a post in line of Miller and corner to Clifford Collins; thence with line of Collins S 77° 01' 13" E, 102.04 feet to a post; S 20° 20' 20" E, 221.74 feet to a post; N 22° 41' 55" E, 50.71 feet to a post in line of Clifford Collins and corner to George Collins; thence with line of some S 56° 58' 22" E, 132.79 feet to a post corner of George Collins and Ronnie Worf; thence with line of Ward S 03° 23' 15" W, 118.32 feet; S 60° 48' 04" E, 262.61 feet to an iron post in line of Worf and corner to James Jones; thence S 23° 44' 26" W, 457.49 feet to an iron post corner to Jones and in line of Ben Allen; thence with line of Allen N 55° 00' 00" W, 135.48 feet to a post; N 60° 00' 00" W, 145.93 feet to a black oak; N 80° 23' 35" W, 149.90 feet to a black oak; N 74° 48' 13" W, 97.45 feet to a black oak corner to Allen and in line of Clyde Collins; thence with some N 13° 07' 16" W, 64.57 feet to point of beginning. Containing 7.972 acres by survey of Charles Mullins Registered Land Surveyor NC. 778.

LESS AND EXCEPT that portion conveyed to Rhonda Collins and Magdalene Collins by Deed of Conveyance dated August 4, 2000 and recorded September 8, 2000 in Deed Book 181, Page 168. (SAME AS RFS. #073SW-00-016.02. DOES NOT AFFECT THE LEASE AREA, THE ACCESS & UTILITY ESMI, OR THE UTILITY ESMI. SHOWN PER THIS SURVEY)

AND BEING a portion of the same property conveyed to Clyde Raymond Collins and Magdalene Collins from George Collins and Irene Collins by Deed of Conveyance dated March 29, 1988 and recorded April 4, 1988 in Deed Book 153, Page 483.

Tax Parcel No. 073SW-00-032.04



STATE OF KENTUCKY	
FRANK L. SELLINGER	3282
LICENSED PROFESSIONAL LAND SURVEYOR	

Frank L. Sellinger, Ky. Reg. No. 3282

REVISIONS:	
ACCESS ESMI - 01.09.23	ADD TITLE - 02.21.23
FINAL(SAS) - 02.27.23	SHIFT COORD. PNT.-04.24.23/231173/23

SHEET 4 OF 4

TYPE "A" SURVEY: UNADJUSTED TRAVERSE CLOSURE BETTER THAN 1 IN 10,000.
TO ALL PARTIES INTERESTED IN TITLE TO PREMISES SURVEYED
I HEREBY CERTIFY that this plan and survey were made under my
supervision, and that the angular and linear measurements,
as witnessed by monuments shown herein, are true and correct
to the best of my knowledge and belief.
This survey and plan meets or exceeds the minimum standards
of the governing authorities.
This property is subject to any recorded easements or right
of ways not shown herein.

Frank L. Sellinger **F-2913**

LAND SURVEYOR'S CERTIFICATE
SHEET 4 OF 4

SURVEYOR'S REVIEW OF "SPECIAL EXCEPTIONS"

NOTES CORRESPONDING TO THE FIDELITY NATIONAL TITLE INSURANCE COMPANY, "REPORT OF TITLE", ORDER NUMBER: 37985209 AND REFERENCE NUMBER: VERIZON WIRELESS - LV MT. VERNON EAST, EFFECTIVE DATE: 10/13/2022.

4. *Easement in favor of Kentucky Utilities Company set forth in instrument recorded on April 9, 1984 in Deed Book 122, Page 152. (DOES NOT AFFECT THE LEASE AREA, THE ACCESS & UTILITY ESMI, OR THE UTILITY ESMI. SHOWN PER THIS SURVEY)*5. *Certificate of Title (Mobile Home) recorded on July 19, 2010 in Miscellaneous Book 46, Page 93. (NOT A SURVEY ISSUE)*1012 S 4th Street, Suite 101
Louisville, Ky 40203
Phone: (502) 636-5111
Fax: (502) 636-5263SITE NUMBER:
721772SITE NAME:
MT VERNON EASTSITE ADDRESS:
FROSTY HOLLOW RD
MT VERNON, KY 40456LEASE AREA:
10,000.00 SQ.FT.PROPERTY OWNER:
CLYDE R & MAGDALENE COLLINS
3117 FROSTY HOLLOW RD
MT VERNON, KY 40456PARCEL NUMBER:
074-00-002,
073SW-00-032.04,
& 073SW-00-016SOURCE OF TITLE:
D.B. 154 PG. 282,
D.B. 133 PG. 483,
& D.B. 92 PG. 320DING BY: SNS FIELD DATE: DRAFT DATE:
OKRD BY: FLS 11/15/22 12/09/22
ESTAN PROJECT NO.:
22-1168

STATE OF KENTUCKY	
FRANK L. SELLINGER	3282
LICENSED PROFESSIONAL LAND SURVEYOR	

SHEET 4 OF 4

TYPE "A" SURVEY: UNADJUSTED TRAVERSE CLOSURE BETTER THAN 1 IN 10,000.
TO ALL PARTIES INTERESTED IN TITLE TO PREMISES SURVEYED
I HEREBY CERTIFY that this plan and survey were made under my
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as witnessed by monuments shown herein, are true and correct
to the best of my knowledge and belief.
This survey and plan meets or exceeds the minimum standards
of the governing authorities.
This property is subject to any recorded easements or right
of ways not shown herein.

Frank L. Sellinger **F-2913**

REVISIONS:

ACCESS ESMI - 01.09.23

ADD TITLE - 02.21.23

FINAL(SAS) - 02.27.23

SHIFT COORD. PNT.-04.24.23/231173/23

RAWLAND

Ky. Reg. No. 3282



TAG TOWERS, LLC
08 FORBES COURT, SUITE 1
RICHMOND, KY 40475
859.544.5000 (PH)

49030 Pontiac Trail, Suite 100
Wixom, Michigan 48393
PHONE: (248) 705-9212

49030 Pontiac Trail, Suite 100
Wixom, Michigan 48393
PHONE: (248) 705-9212




SITE INFORMATION:
LVMT VERNON EAST
321 FROSTY HOLLOW ROAD
MT VERNON, KY 40456
ROCK CASTLE COUNTY

SITE NAME:	LV MT VERNON EAST		
ID NUMBER:	16913443		
DRAWN BY:	RC	PL	10.25.23
CHECKED BY:			
DATE:			

OVERALL SITE PLAN

SHEET NUMBER:
C — C
WIK PAD & CANOPY REV 3 FINAL 10/16/23

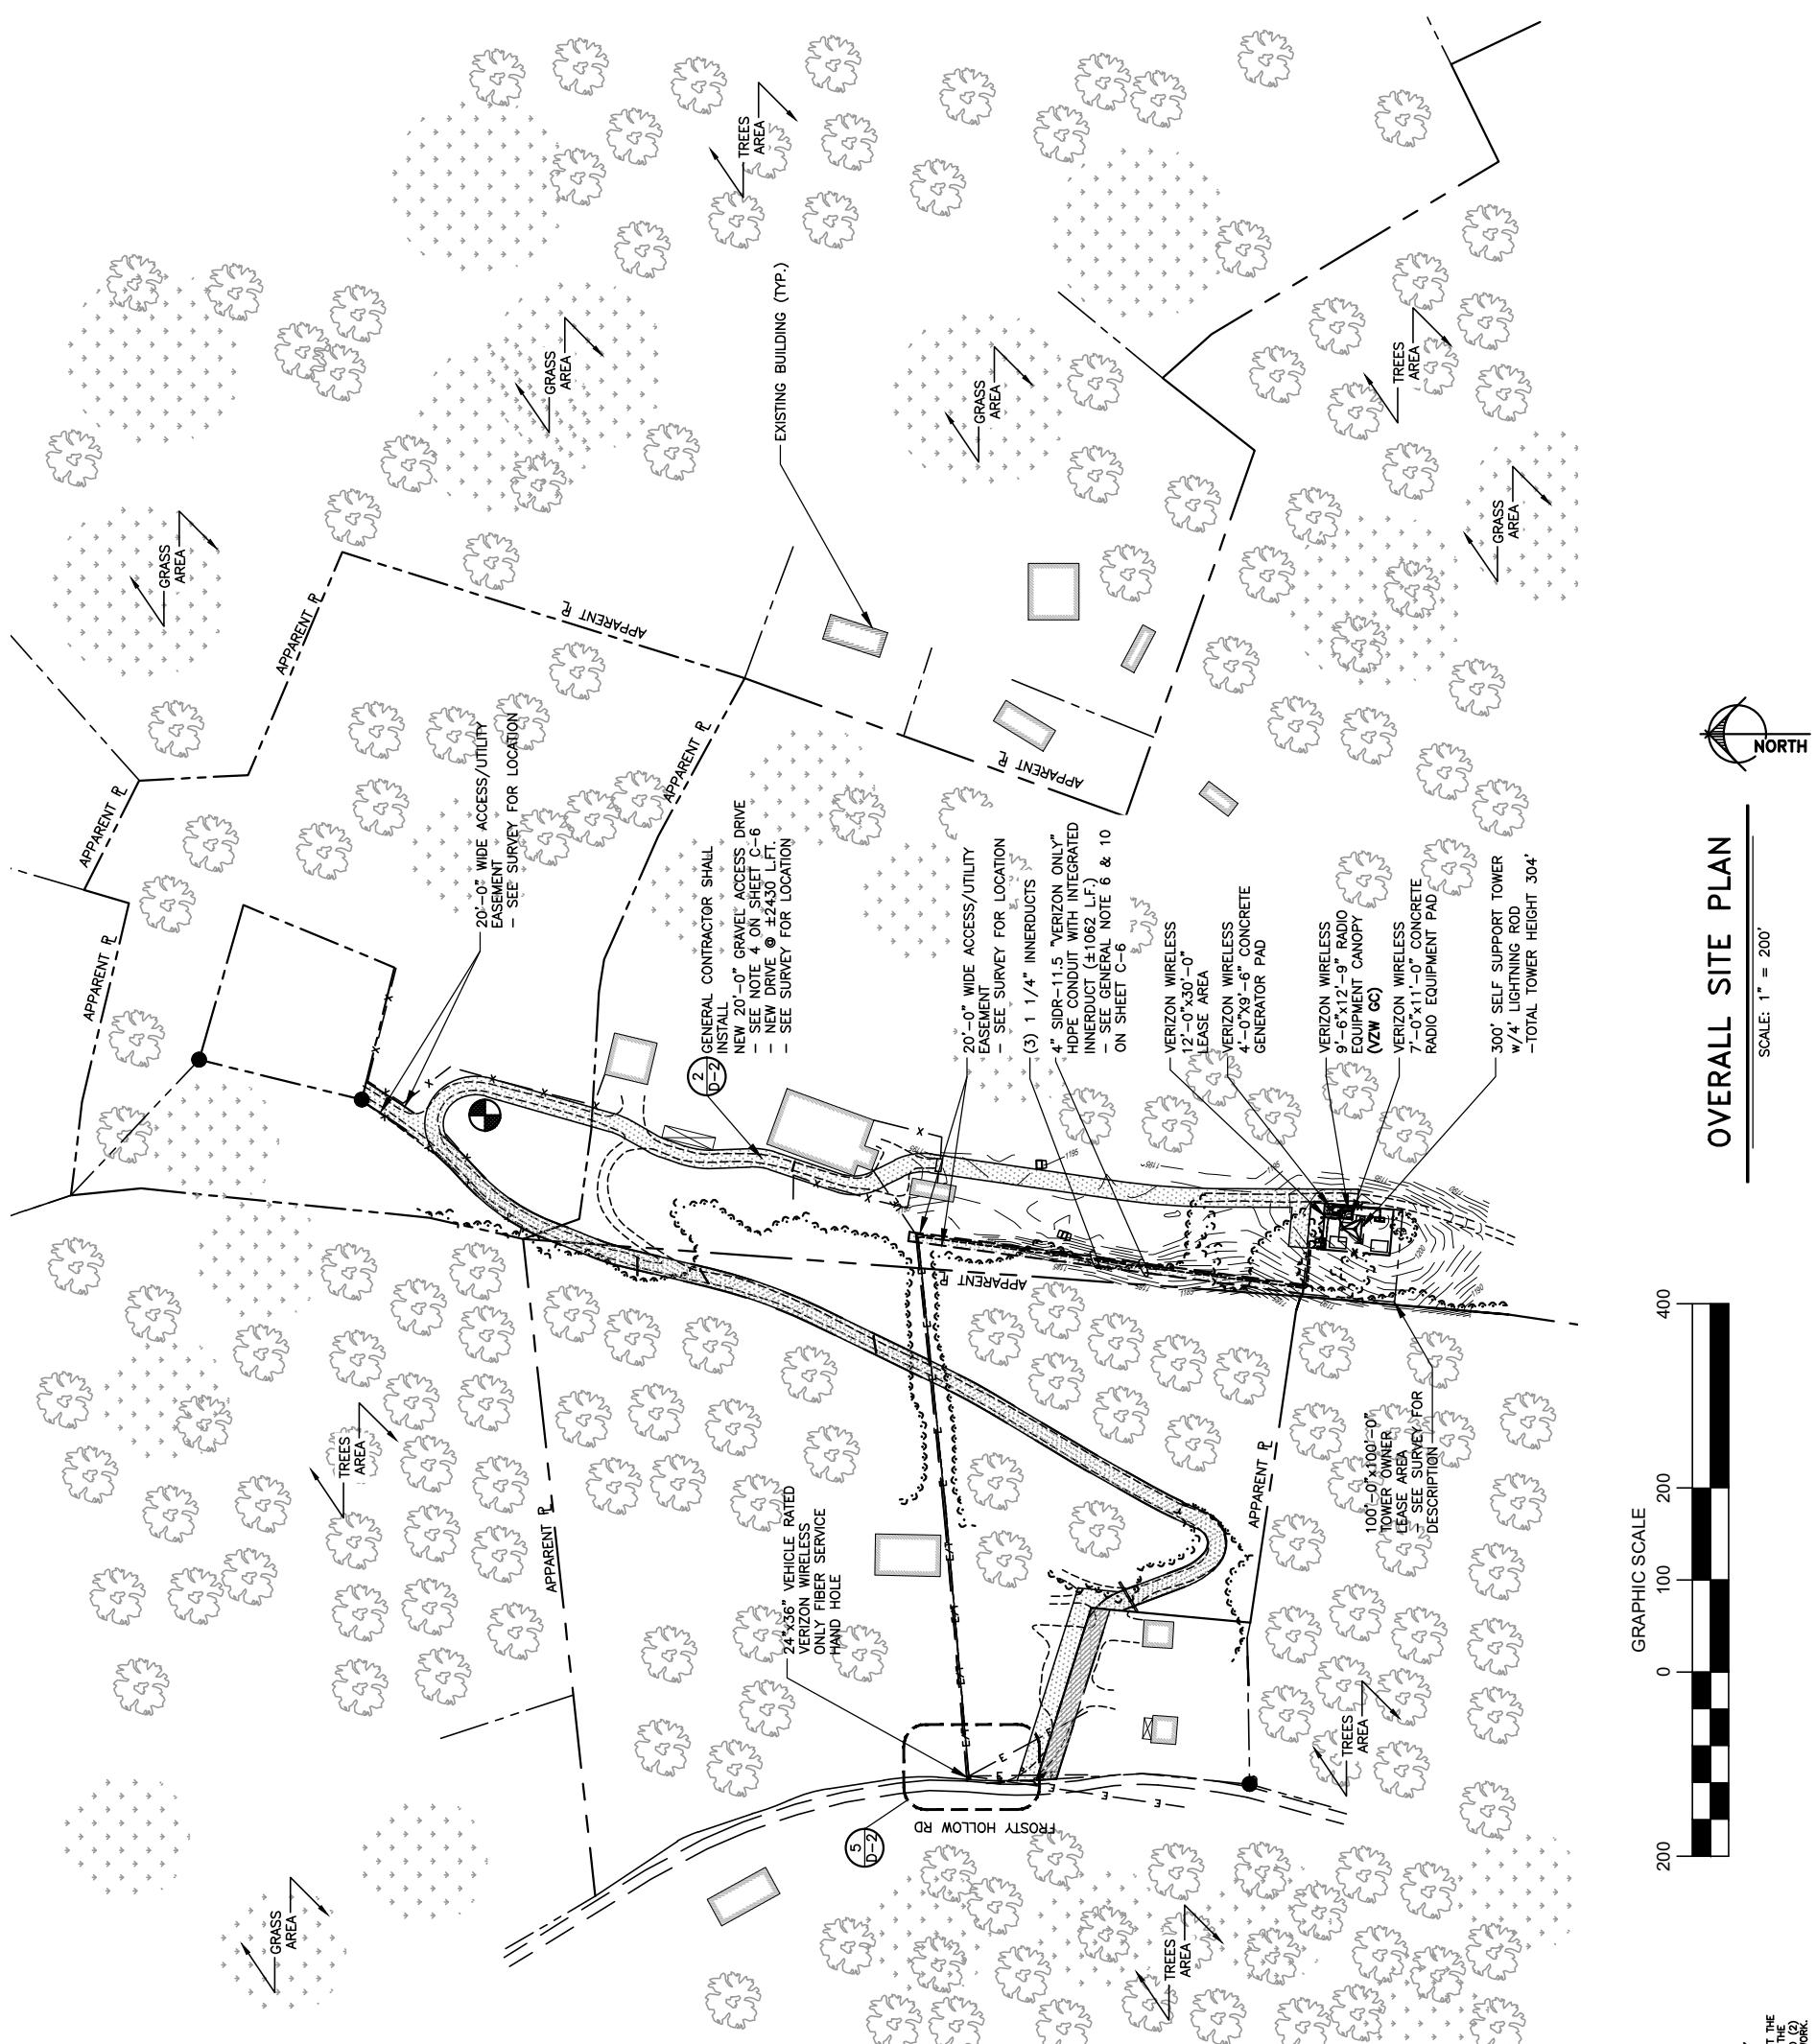

A hand holding a telephone receiver, with a speech bubble containing the text "Know what's below." Below the hand, the text "Call before you dig." is written vertically.



TAG
TOWERS
108 FOREST COURT, SUITE 1
RICHMOND, KY 40475
859-544-5000 (PH)



49030 Portia Trail, Suite 100
Wixom, Michigan 48393
PHONE: (248) 705-9212

REV.	DATE	DESCRIPTION
-	12/27/23	REVISED FOR CONSTRUCTION
0	11/16/23	ISSUED FOR REVIEW
B	08/04/23	ISSUED FOR REVIEW
A	08/04/23	ISSUED FOR REVIEW



SITE INFORMATION:
LV MT VERNON EAST
321 FROSTY HOLLOW ROAD
MT VERNON, KY 40456
ROCK CASTLE COUNTY

SITE NAME:
LV MT VERNON EAST
SITE NUMBER:
721772
SHEET TITLE:

OVERALL SITE PLAN
W/AERIAL OVERLAY
SHEET NUMBER:
C — 1

WK PAD & CANOPY REV 3 FINAL 10/16/23



Know before you dig.
Call before you dig.
Call Monday thru Friday 7 am to 6 pm.
1-800-752-6007
PER KENTUCKY STATE LAW, IT IS AGAINST THE
LAW TO EXCAVATE WITHOUT NOTIFYING THE
UNDERGROUND LOCATING SERVICE TWO (2)
WORKING DAYS BEFORE COMMENCING WORK.



SCALE: 1" = 50'



OVERALL SITE PLAN W/AERIAL OVERLAY



TAG TOWERS LLC
108 FORGE COURT, SUITE 1
RICHMOND, KY 40475
859-544-5000 (PH)

LAB

49030 Portiac Trail, Suite 100
Wixom, Michigan 48393
PHONE: (248) 705-9212

REV.	DATE	DESCRIPTION
1	12/27/23	REVISED FOR CONSTRUCTION
0	11/16/23	ISSUED FOR REVIEW
B	08/04/23	ISSUED FOR REVIEW
A	08/04/23	ISSUED FOR REVIEW



SITE INFORMATION:
LV MT VERNON EAST
321 FROSTY HOLLOW ROAD
MT VERNON, KY 40456
ROCK CASTLE COUNTY

SITE NUMBER:
721772
SITE NAME:
LV MT VERNON EAST
PID NUMBER: 16913443
DRAWN BY: RC
CHECKED BY: PL
DATE: 10/25/23

SHEET TITLE:
**OVERALL SITE PLAN
W/TOWER LEG
DISTANCE TO
PROPERTY LINES**
SHEET NUMBER:
C — 1 A

PER KENTUCKY STATE LAW, IT IS AGAINST THE
LAW TO LOCATE TWO (2)
UNPERMITTED COMMERCIAL SERVICE WORKING
DAYS BEFORE COMMENCING WORK.
1-800-752-6007
Call Monday thru Friday - 7 am. to 6 pm.
Know where below.
Call before you dig.




**OVERALL SITE PLAN w/TOWER LEG DISTANCE
TO PROPERTY LINES**

SCALE: 1" = 60'



Call before you dig.
1-800-752-6007
PER KENTUCKY STATE LAW, IT IS AGAINST THE
LAW TO LOCATE TWO (2)
UNPERMITTED COMMERCIAL SERVICE WORKING
DAYS BEFORE COMMENCING WORK.

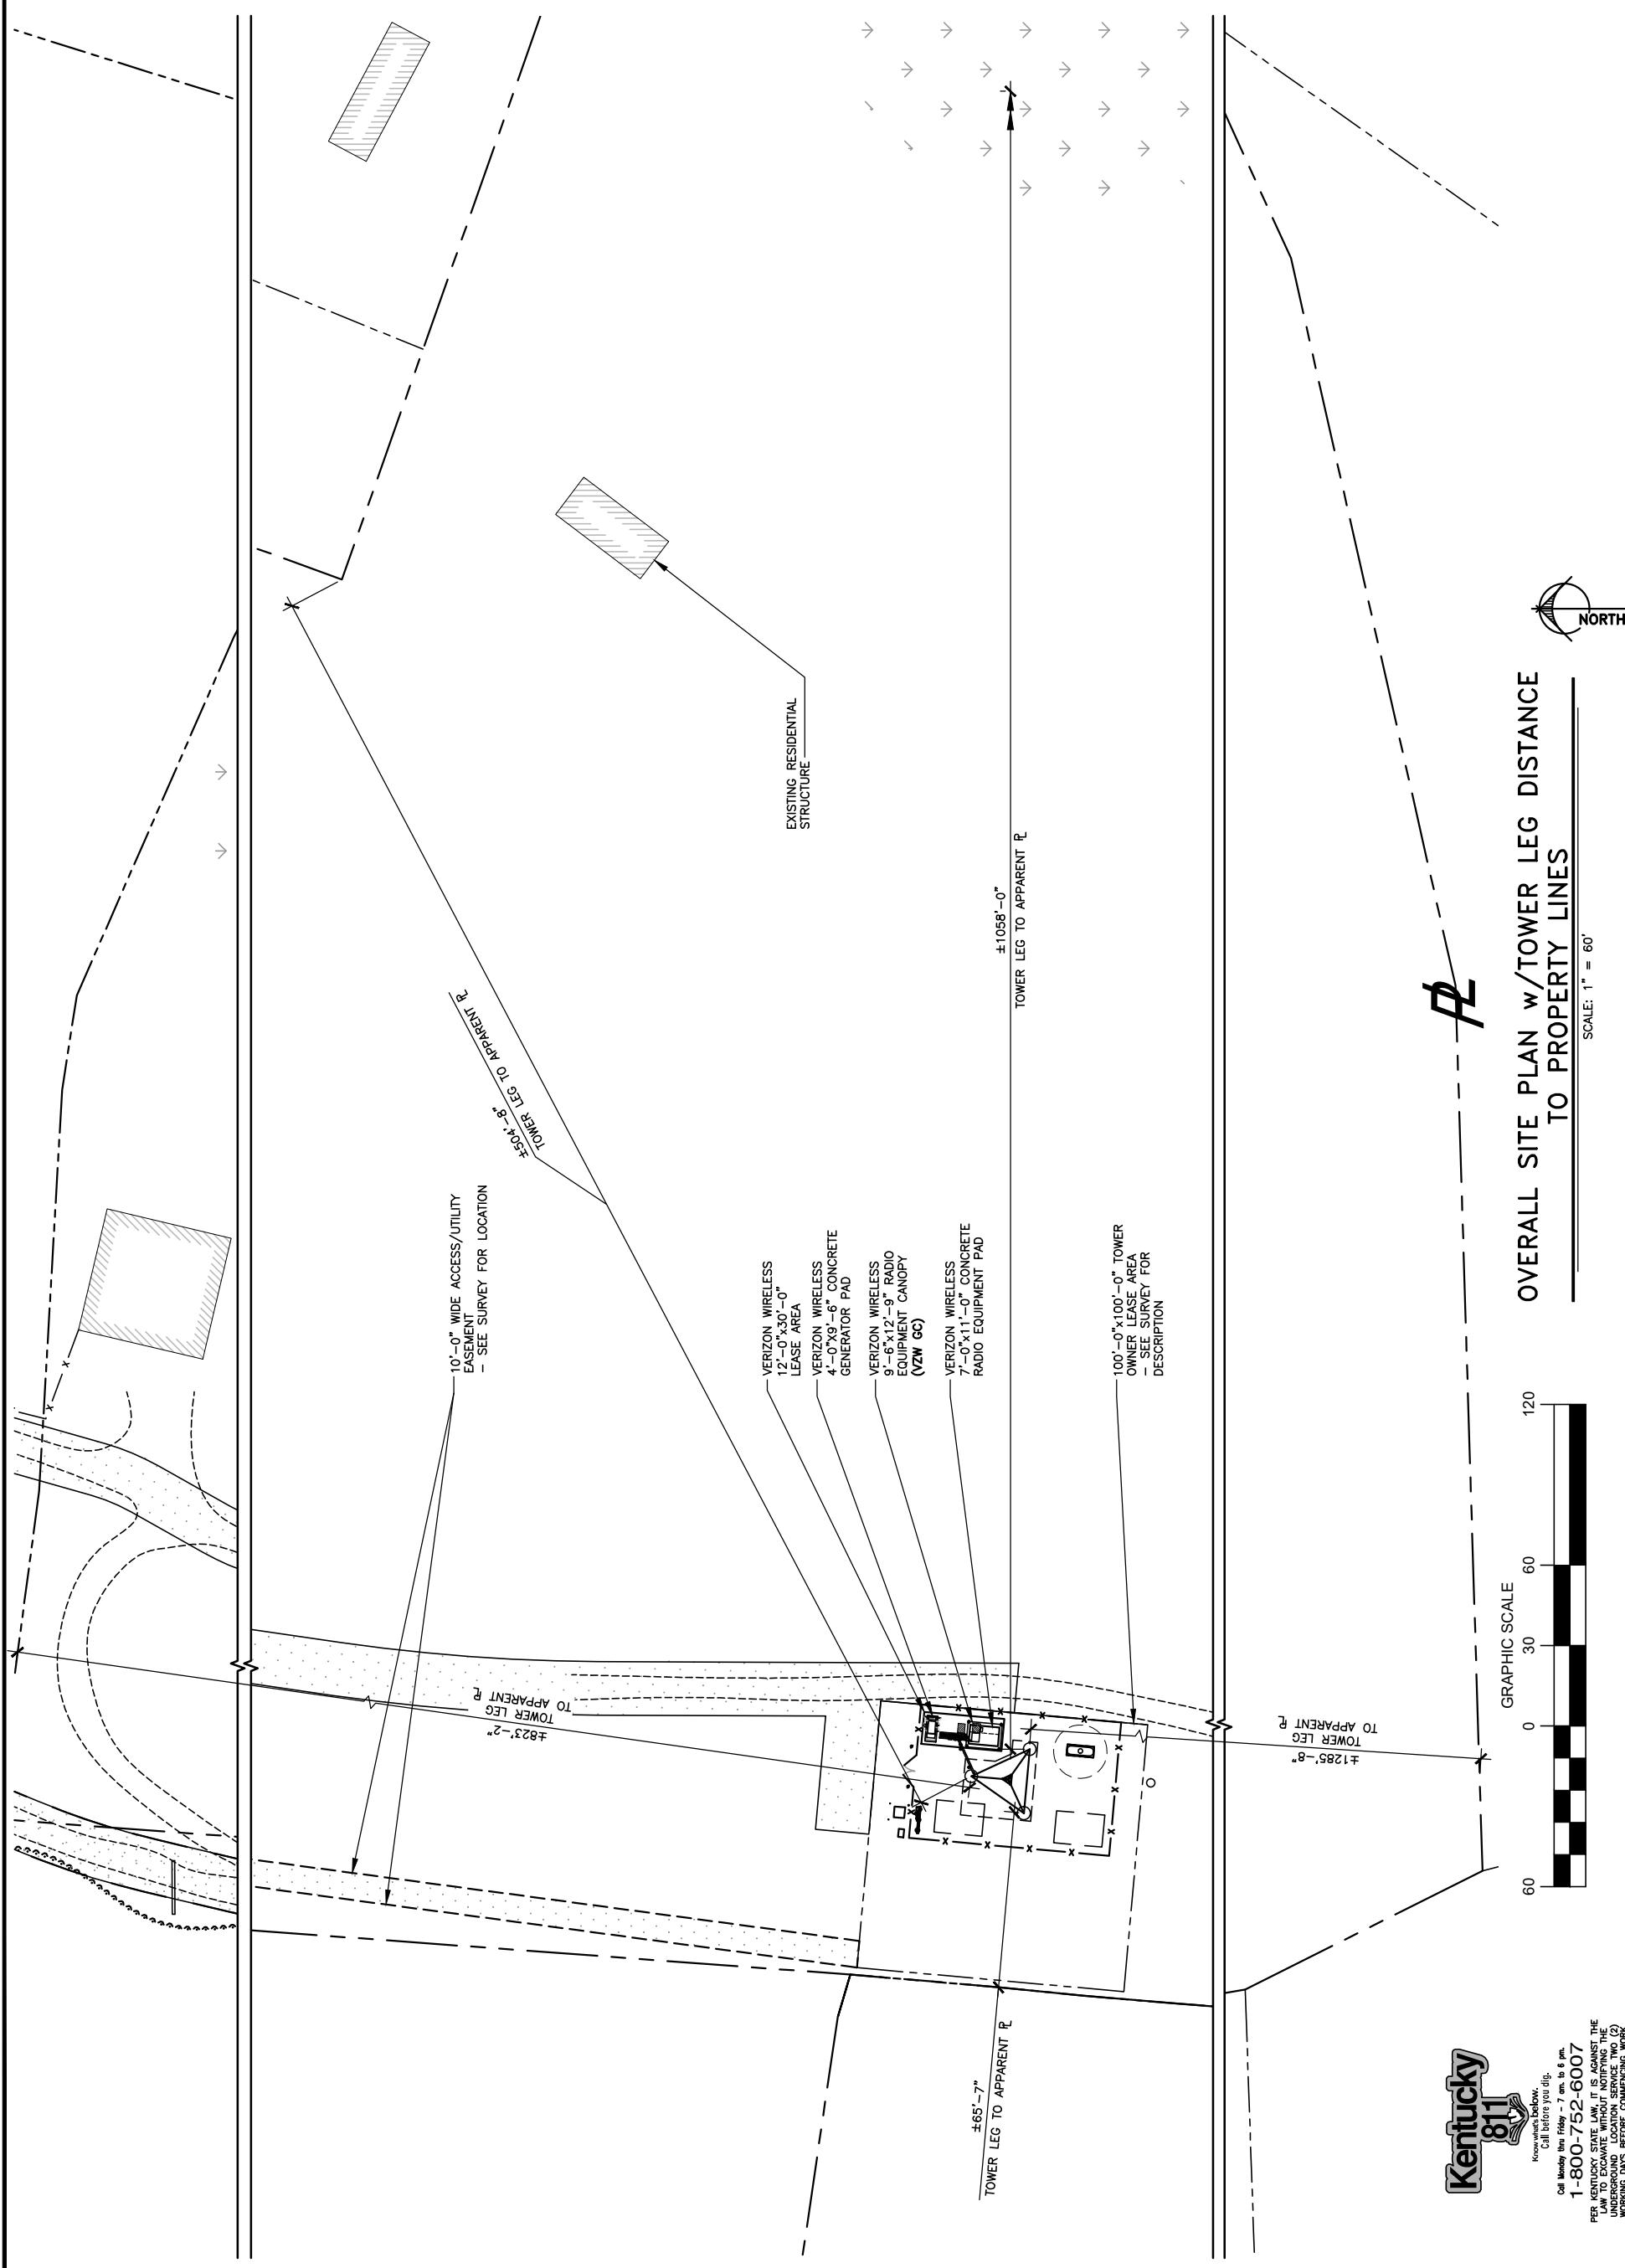



TAG TOWERS LLC
108 FOREST COURT, SUITE 1
RICHMOND, KY 40475
859-544-5000 (PH)

LAB

49030 Portiac Trail, Suite 100
Wixom, Michigan 48393
PHONE: (248) 705-9212

REV.	DATE	DESCRIPTION
1	12/27/23	REVISED FOR CONSTRUCTION
0	11/16/23	ISSUED FOR REVIEW
B	08/04/23	ISSUED FOR REVIEW
A	08/04/23	ISSUED FOR REVIEW




SITE INFORMATION:
LV MT VERNON EAST
321 FROSTY HOLLOW ROAD
MT VERNON, KY 40456
ROCK CASTLE COUNTY


SITE NAME:
721772

PID NUMBER: 16913443
DRAWN BY: RC
CHECKED BY: PL
DATE: 10-25-23

OVERALL SITE PLAN
w/TOWER LEG DISTANCE
TO RESIDENTIAL STRUCTURES

SHEET NUMBER: C-1 B
PER. KENTUCKY REV. 3 FINAL 10/16/23

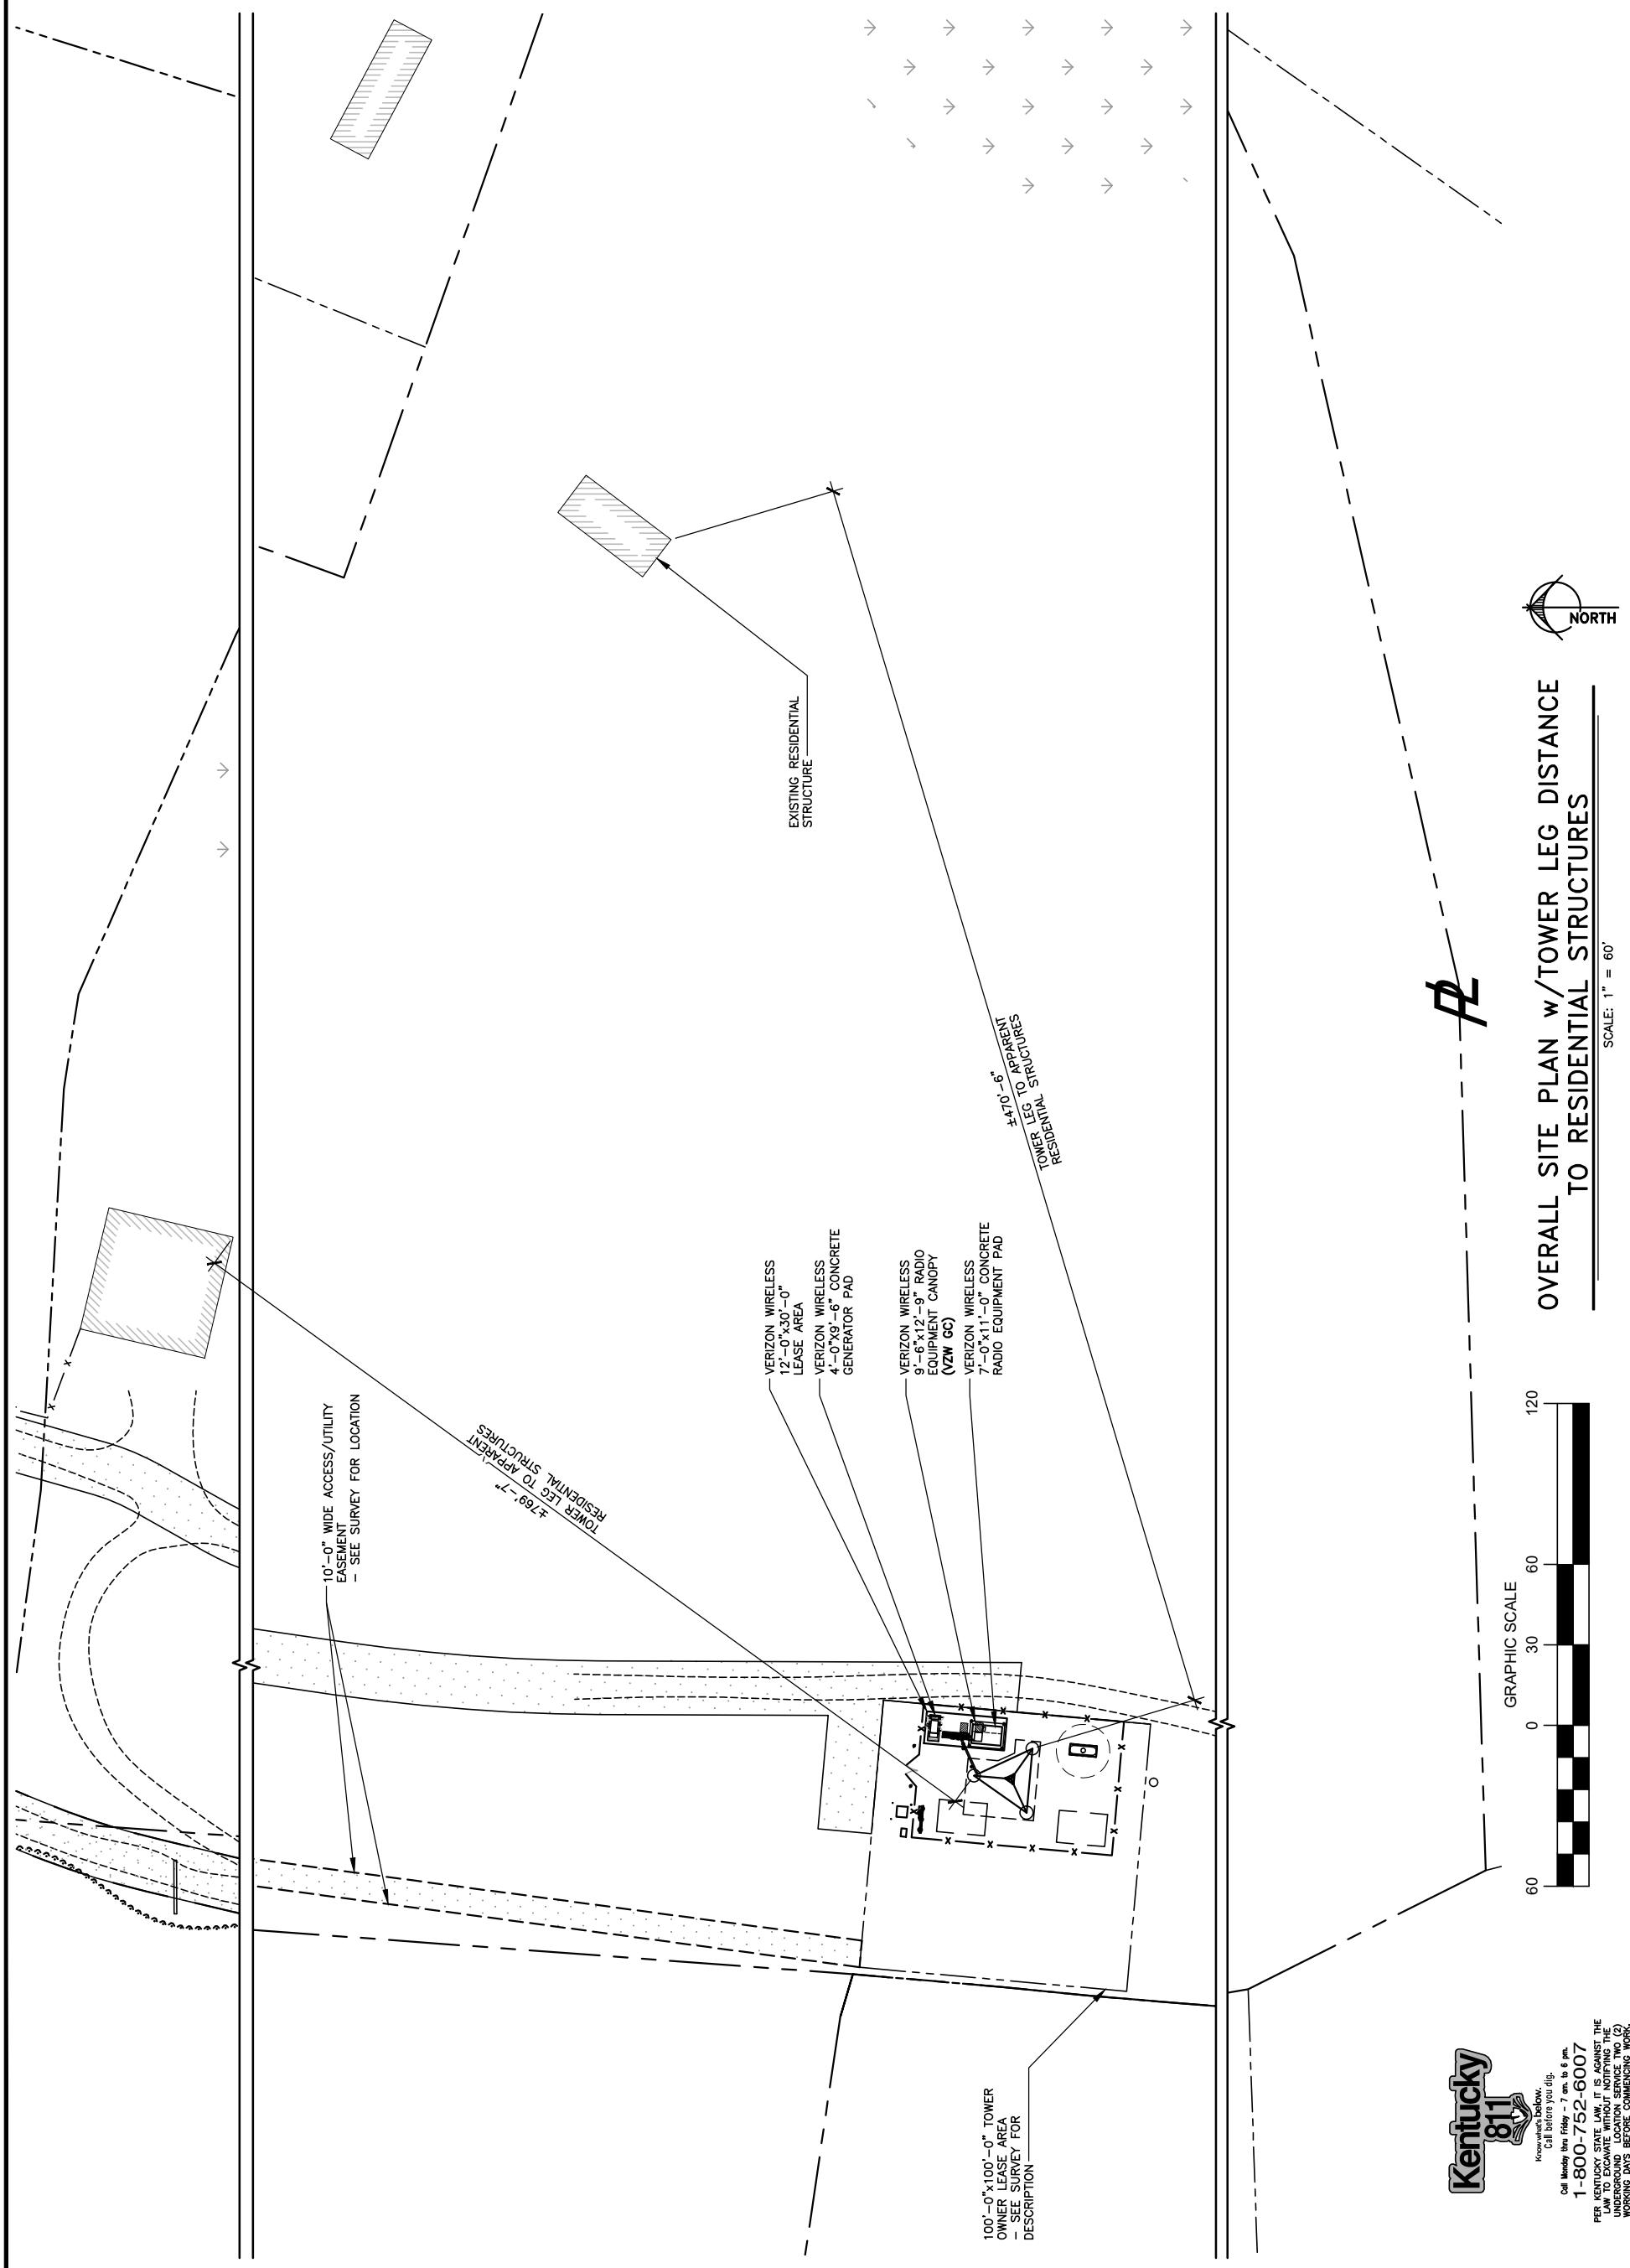

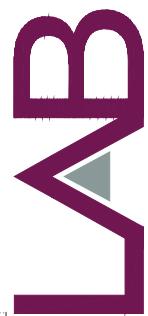verizon250E 96TH ST, STE 175
INDIANAPOLIS, IN 46240-375349030 PONTIAC TRAIL, SUITE 400
WIXOM, MICHIGAN 48393
PHONE: (248) 705-9212
ALBUL
ENGINEERING
3840 E. ROBINSON ROAD
AMHERST, NY 14228
WWW.ALBULENG.COM

KY LICENSE NO. 25093

DMITRY ALBUL

12-15-2023

SHEET INFORMATION:

LV MT VERNON EAST
721772321 FROSTY HOLLOW ROAD
MT VERNON, KY 40456
ROCK CASTLE COUNTY

33746.LAB.GDP.C47049.2

GRADING & EROSION
CONTROL OVERALL PLAN

C-2 AS SHOWN

SCALE 1"=100' FOR 11' X 17'
1"=100' FOR 22' X 34"


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CARRIER:

CLIENT:

CONTRACTOR:

REV. DATE DESCRIPTION DRAWN BY CHECKED BY

**GRADING & EROSION CONTROL OVERALL PLAN**

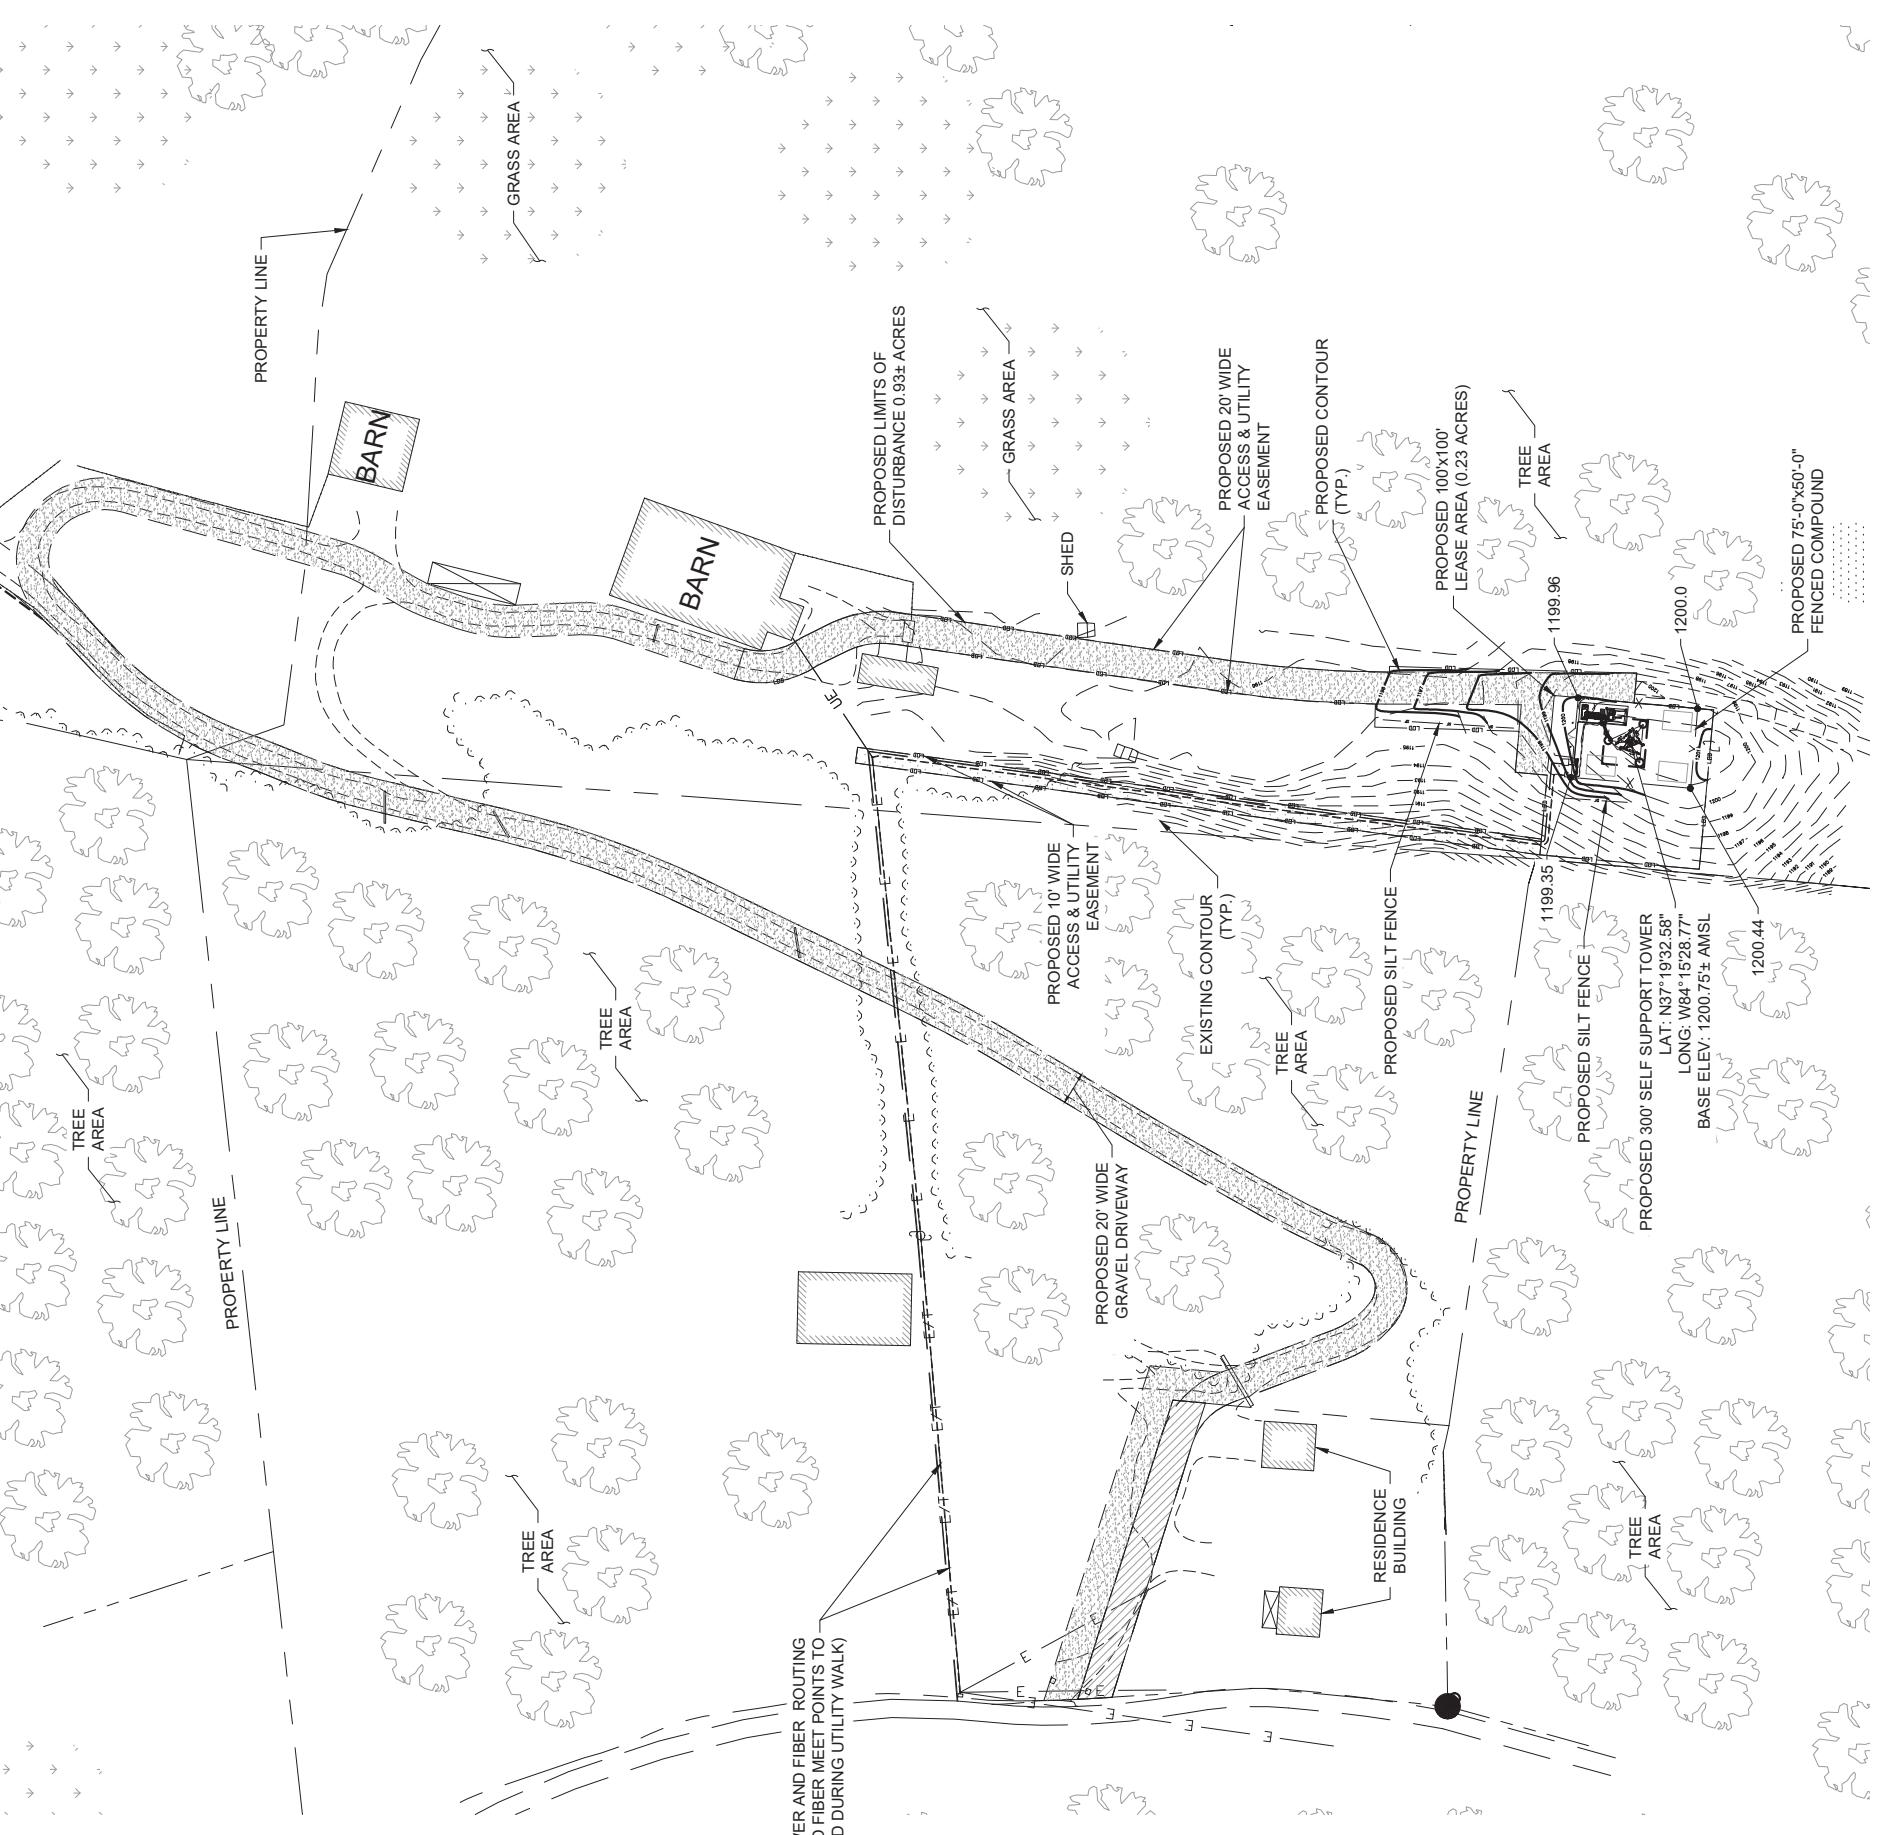1

SCALE 1"=100' FOR 11' X 17'
1"=100' FOR 22' X 34"

EROSION AND SEDIMENT CONTROL LEGEND

SF — PROPOSED SILT FENCE
— LOO — LIMITS OF DISTURBANCE

PROPOSED FENCE
EXISTING EDGE OF PAVEMENT
UNDERGROUND FIBER CONDUIT
UNDERGROUND ELECTRICAL CONDUIT
PROPOSED DITCH
PROPOSED SPOT ELEV

EXISTING CONTOUR
PROPOSED CONTOUR
EXISTING EASEMENT
PROPOSED EASEMENT
PROPOSED LEASE AREA
PROPOSED FENCE
EXISTING CONTOUR
EXISTING EASEMENT
PROPOSED EASEMENT
PROPOSED LEASE AREA


REPEATED SECTION

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SHEET SIZE - 22' X 34"



250E 96TH ST, STE 175
INDIANAPOLIS, IN 46240-3753

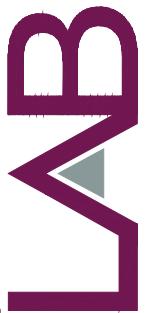

49030 PONTIAC TRAIL, SUITE 400
WIXOM, MICHIGAN 48393
PHONE: (248) 705-9212



840 E. ROBINSON ROAD
AMHERST, NY 14228
WWW.ALBULENG.COM



4	12/15/23	REVISED PER SITE CONDITIONS	YAY	AAN
3	10/27/23	REVISED PER SITE CONDITIONS	YAY	AAN
2	08/16/23	REVISED PER SITE CONDITIONS	YAY	AAN
1	07/31/23	ISSUED FOR CONSTRUCTION	YAY	AAN
0	03/17/23	PRELIMINARY	YAY	AAN
ADDITIONAL INFORMATION				

LV MT VERNON EAST



321 FROSTY HOLLOW

MT VERNON, KY 40456
ROCK CASTLE COUNTY

333746.LAB.GDP.C47049.2
CT NUMBER:

GRADING & EROSION CONTROL OVERALL PLAN

AS SHOWN
SCALE:
C-2.1

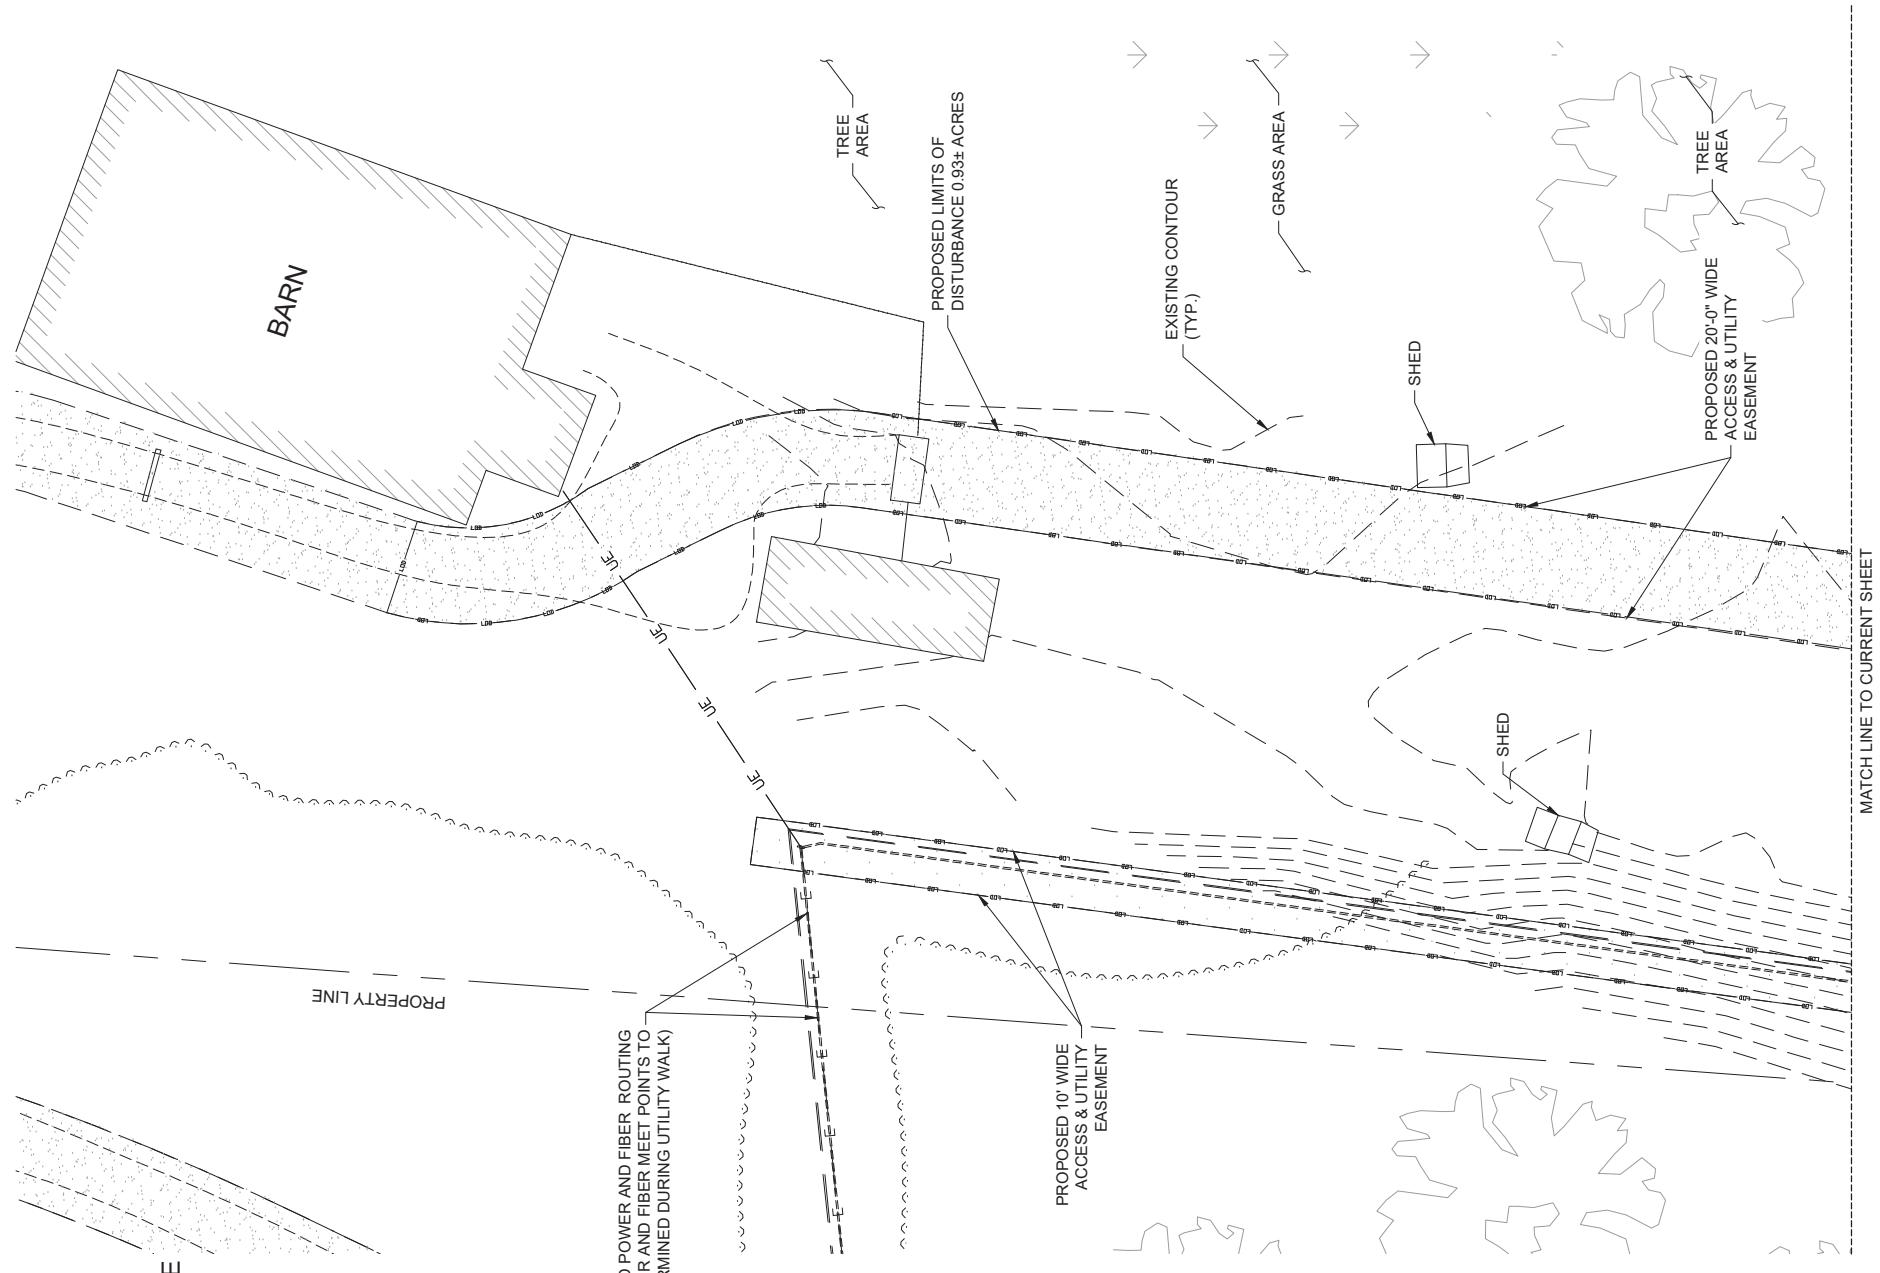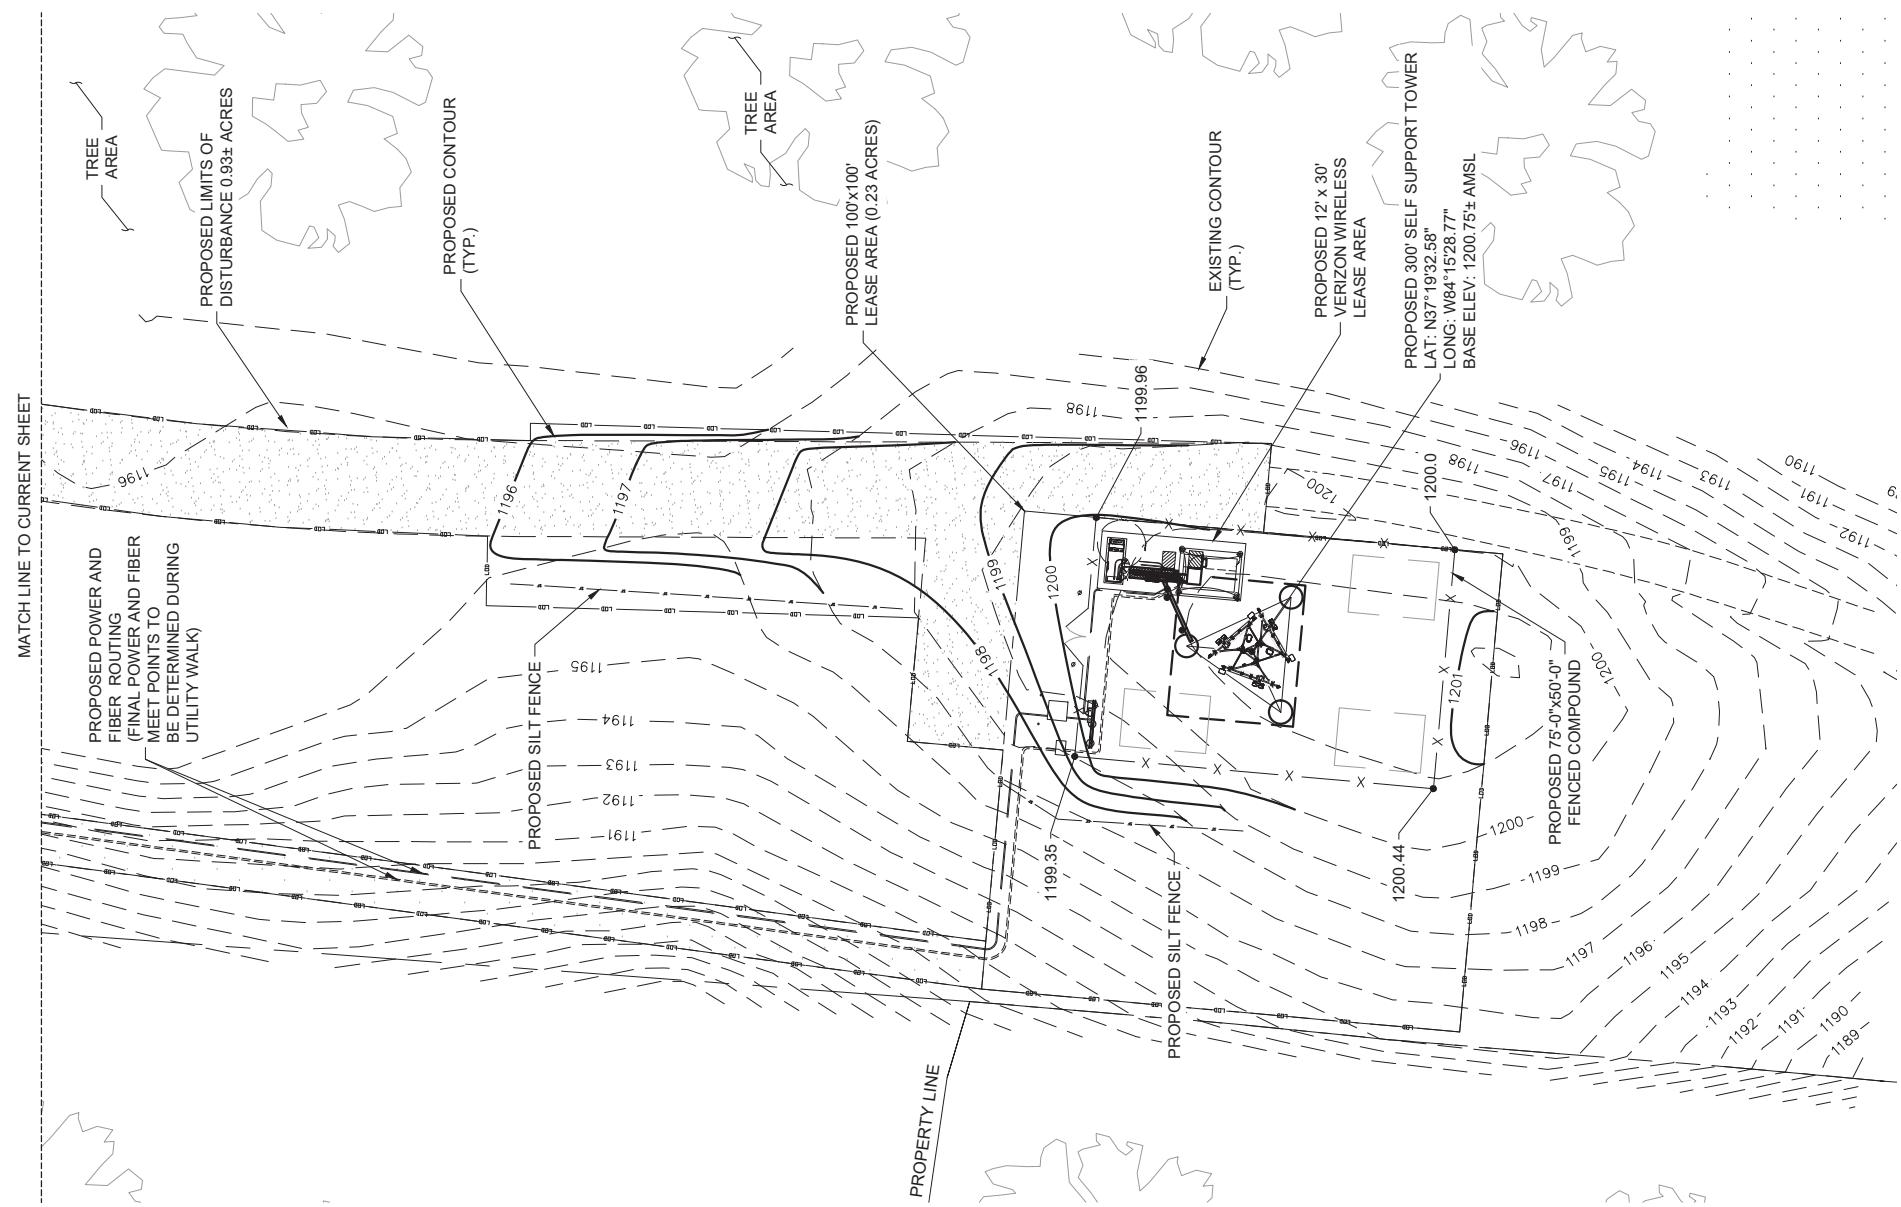

GRADING & EROSION CONTROL PLAN

GRADING & EROSION CONTROL PLAN

卷之三



TAG
TOWERS
108 PORTIAC TRAIL, SUITE 1
RICHMOND, KY 40475
859-544-5000 (PH)

LAB

49030 Portiac Trail, Suite 100
Wixom, Michigan 48393
PHONE: (248) 705-9212

REV.	DATE	DESCRIPTION
A	08/04/23	ISSUED FOR REVIEW
B	08/16/23	ISSUED FOR REVIEW
C	11/16/23	REVISED FOR CONSTRUCTION
D	12/27/23	ISSUED FOR REVIEW




SITE INFORMATION:
LV MT VERNON EAST
321 FROSTY HOLLOW ROAD
MT VERNON, KY 40456
ROCK CASTLE COUNTY

SITE NUMBER:
721772
SITE NAME:
LV MT VERNON EAST
PID NUMBER: 16913443
DRAWN BY: RC
CHECKED BY: PL
DATE: 10/25/23
SHEET TITLE:

DETAILED SITE PLAN
C — 3

SHEET NUMBER:
C — 3
WK PAD & CANOPY REV 3 FINAL 10/16/23

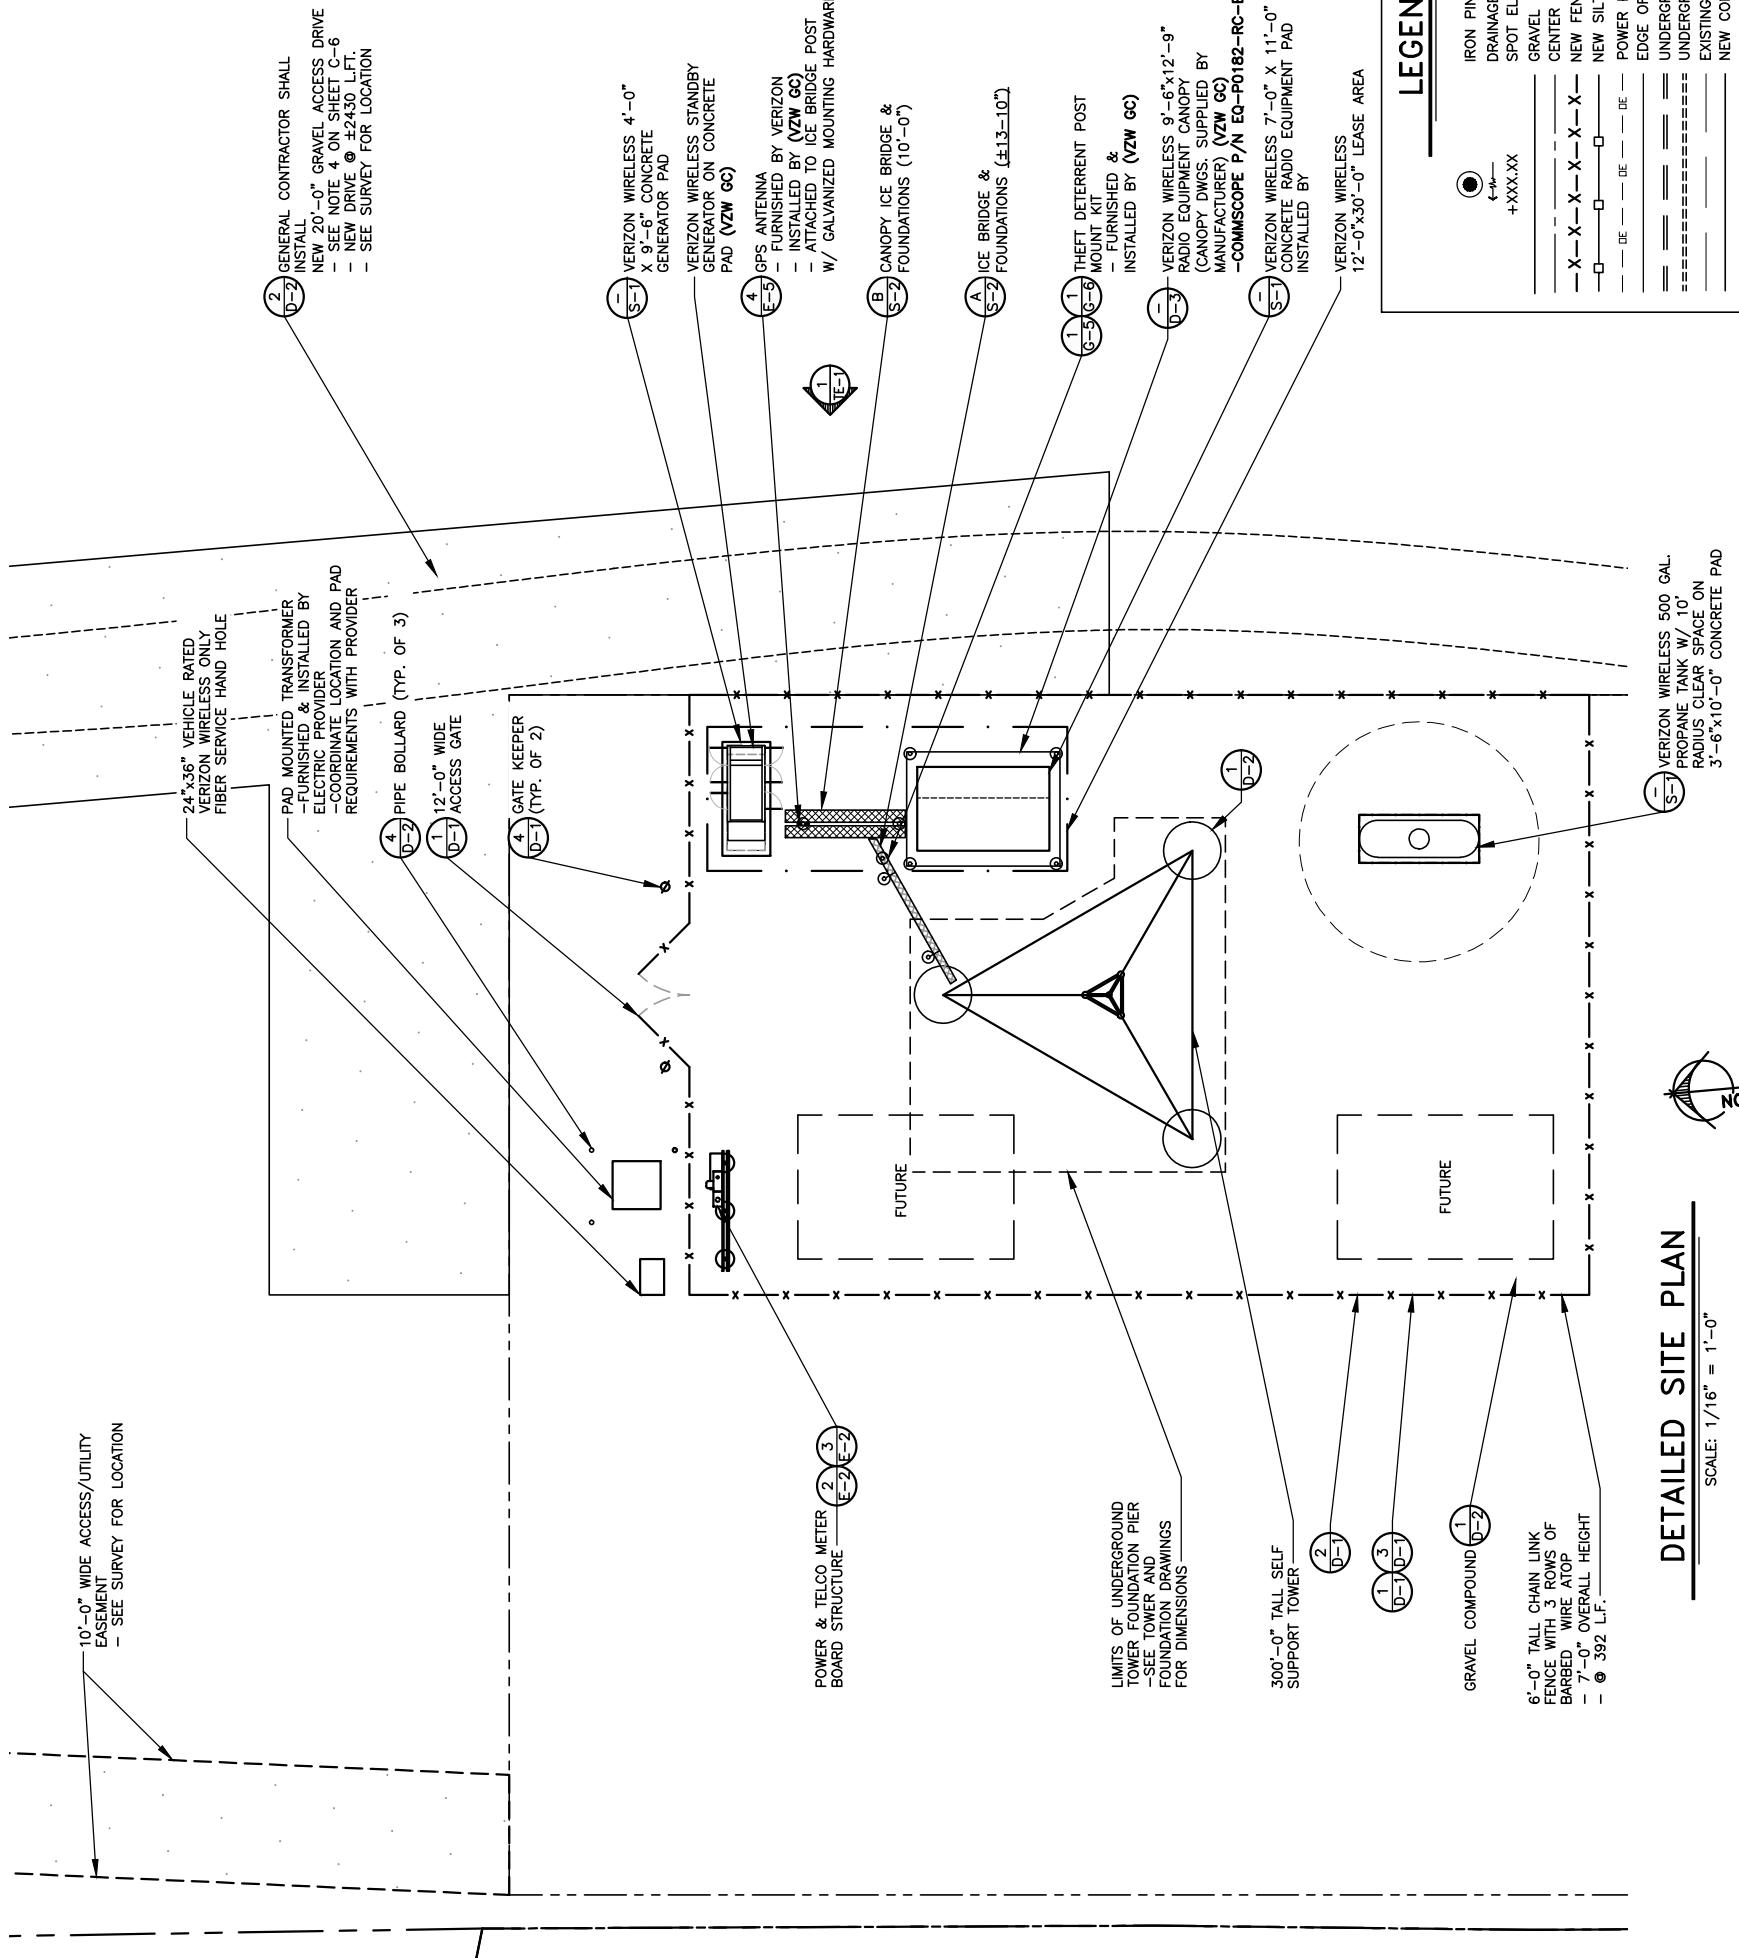

DETAILED SITE PLAN

SCALE: 1/16" = 1'-0"

*NOTE:
GENERAL CONTRACTOR IS TO ENSURE
THERE IS NO DISTURBANCE OF
PROPERTY, SOIL, ETC., OUTSIDE OF
THE STAKED LEASE AREA WITHOUT
APPROVAL FROM VERIZON WIRELESS
CONSTRUCTION MANAGER



Kentucky 811
Call before you dig.
Call Monday thru Friday - 7 am to 6 pm.
1-800-752-6007
PER KENTUCKY STATE LAW, IT IS AGAINST THE
LAW TO EXCAVATE WITHOUT NOTIFYING THE
UNDERGROUND LOCATION SERVICE TWO (2)
WORKING DAYS BEFORE COMMENCING WORK.



TAG
TOWERS
108 FOREST COURT, SUITE 1
RICHMOND, KY 40475
859-544-5500 (PH)

LAB

49030 Portiac Trail, Suite 100
Wixom, Michigan 48393
PHONE: (248) 705-9212



REV.	DATE	DESCRIPTION
1	12/27/23	REVISED FOR CONSTRUCTION
0	11/16/23	ISSUED FOR REVIEW
B	08/04/23	ISSUED FOR REVIEW
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SITE INFORMATION:
LV MT VERNON EAST
321 FROSTY HOLLOW ROAD
MT VERNON, KY 40456
ROCK CASTLE COUNTY

SITE NUMBER:
721772
SITE NAME:
LV MT VERNON EAST
DRAWN BY: RC
CHECKED BY: PL
DATE: 10/25/23
SHEET TITLE:

DIMENSIONED
SITE PLAN
SHEET NUMBER:
C — 4
WK PAD & CANOPY REV 3 FINAL 10/16/23



DIMENSIONED SITE PLAN

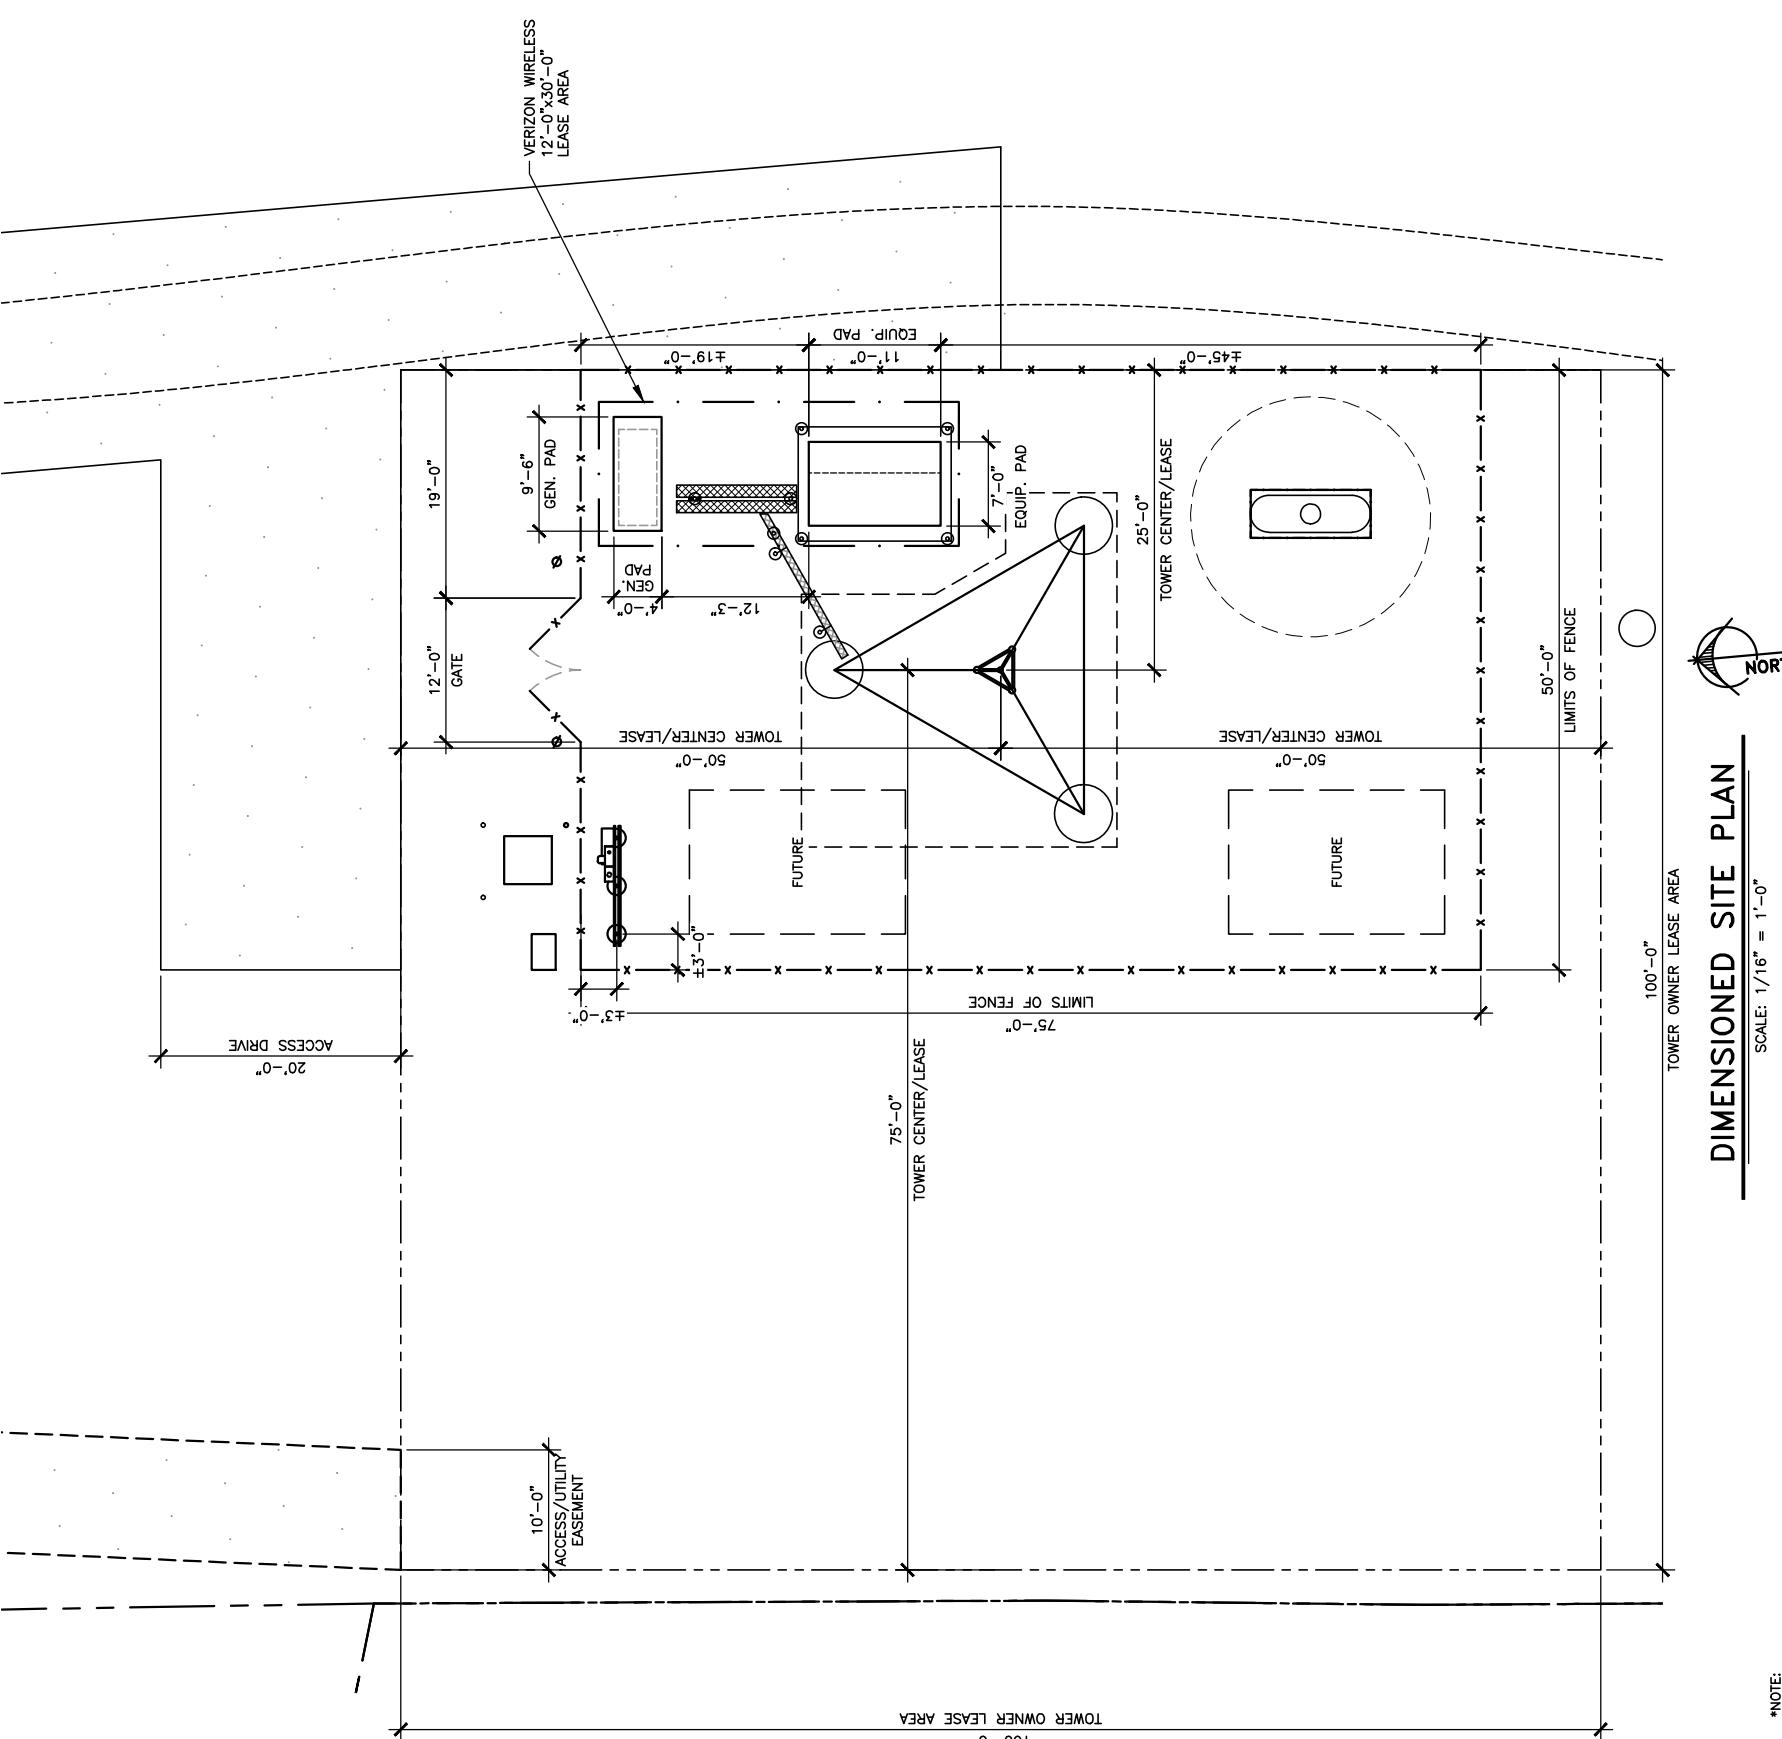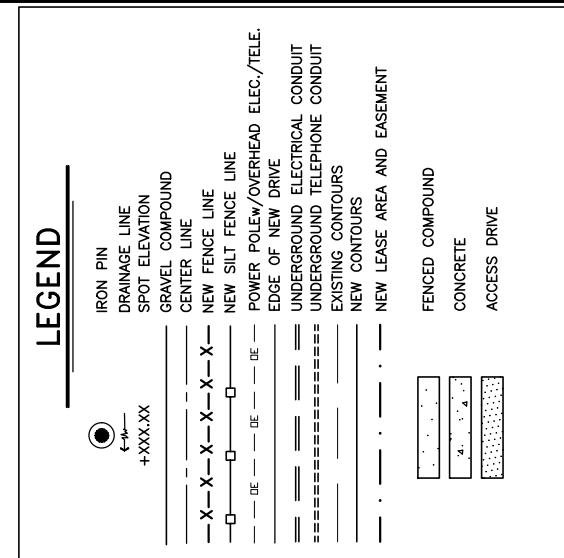SCALE: 1/16" = 1'-0"

*NOTE:
GENERAL CONTRACTOR IS TO ENSURE
THERE IS NO DISTURBANCE OF
PROPERTY, SOIL, ETC., OUTSIDE OF
THE STAKED LEASE AREA WITHOUT
APPROVAL FROM WIRELESS
CONSTRUCTION MANAGER



Know where below.
Call before you dig.
Monday thru Friday - 7 a.m. to 6 p.m.
1-800-752-6007
PER KENTUCKY STATE LAW, IT IS AGAINST THE
LAW TO DAMAGE OR DESTROY UNDERGROUND
UNIVERSITY, TELECOM, GAS, WATER, SEWER, AND
SEWER LINES AND/OR CONDUITS TWO (2)
WORKING DAYS BEFORE COMMENCING WORK.



TAG TOWERS, LLC
3 FORBES COURT, SUITE 1
RICHMOND, KY 40475
859.544.5000 (PH)

B2

19030 Pontiac Trail, Suite 100
Wixom, Michigan 48393
PHONE: (248) 705-9212




SITE INFORMATION:
MT VERNON EAST
321 FROSTY HOLLOW ROAD
MT VERNON, KY 40456
ROCK CASTLE COUNTY

SITE NAME:
EV MT VERNON EAST

RAWN BY: RC
HECKED BY: PL
DATE: 10.25.23

DETAILED VZW EQUIPMENT PLAN

SHEET NUMBER:
C-5
MIK PAD & CANOPY REV 3 FINAL 10/16/23

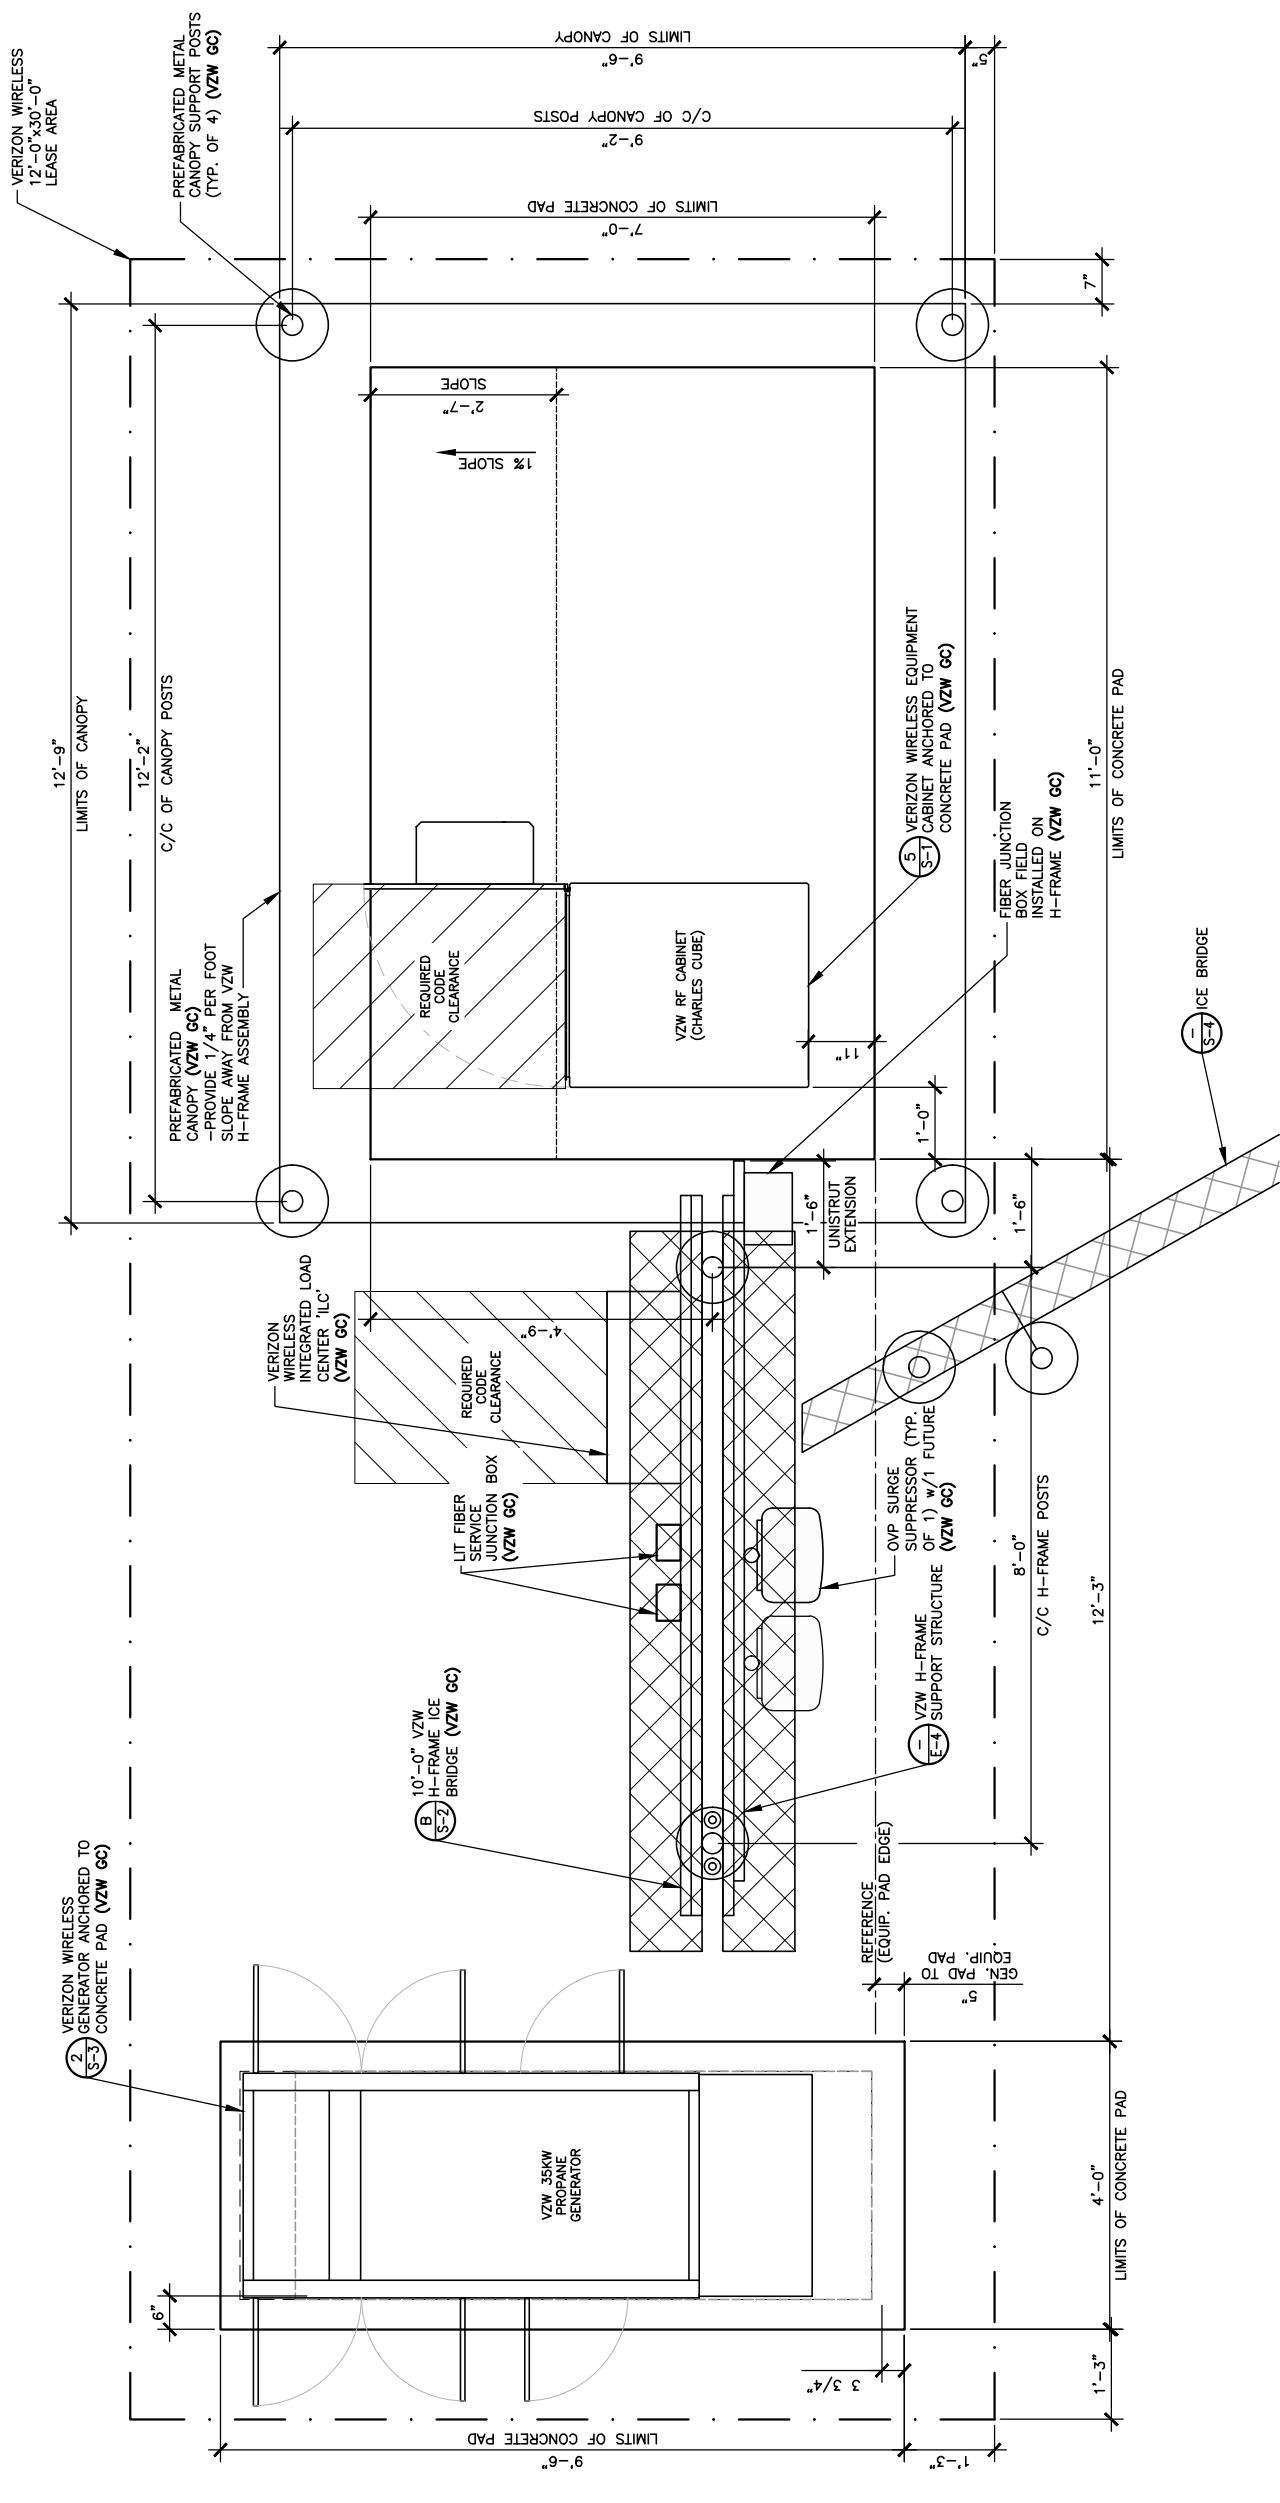

DETAILED VZW EQUIPMENT PLAN

SCALE: $3/8'' = 1'-0''$

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***NOTE:** GENERAL CONTRACTOR IS TO ENSURE THERE IS NO DISTURBANCE OF PROPERTY, SOIL, ETC. OUTSIDE OF THE STAKED LEASE AREA WITHOUT APPROVAL FROM VERIZON WIRELESS CONSTRUCTION MANAGER

Knows before you dig.
Call before you dig.
Call Monday thru Friday - 7 am. to 6 pm.
1-800-752-6007
KENTUCKY STATE LAW, IT IS AGAINST
LAW TO EXCAVATE WITHOUT NOTIFYING THE
UNDERGROUND LOCATION SERVICE TWO
WORKING DAYS BEFORE COMMENCING WORK.

GENERAL SITE CONSTRUCTION NOTES

1. SCHEDULE:

THE CONSTRUCTION OF THE SITE REQUIRES A CERTAIN SEQUENCE OF EVENTS TO MINIMIZE CONSTRUCTION TIME REQUIRED UNTIL AVAILABILITY OF CELLULAR TELEPHONE SERVICE. VERIFY SCHEDULE DURING BID WALK.

2. TOWER OWNER REPRESENTATIVE:

TAG TOWERS, LLC
108 FORBES COURT, SUITE 1
RICHMOND, KY 40475
PHONE: (859) 544-5000

3. ANTENNA INSTALLATION:

THE VERIZON WIRELESS CONTRACTOR (VZW GC) INSTALLING THE FRAME/PLATFORM SHALL ENSURE THAT THE PLATFORM IS ALIGNED BASED ON THE VERIZON WIRELESS RF PLAN. DURING THIS WORK, THE GENERAL CONTRACTOR SHALL BE LIMITED TO THE WORK WHICH CAN BE PERFORMED OUTSIDE THE TOWER.

4. ACCESS DRIVENAY:

THE GENERAL CONTRACTOR SHALL CONSTRUCT THE ACCESS DRIVE PER THE ALIGNMENT SHOWN ON THESE DRAWINGS. IF ANY AREA OF CONSTRUCTION REQUIRES ADDITIONAL FILL OF AGGREGATE, STONE, THAN SHOWN ON THE DRAWINGS, THE GENERAL CONTRACTOR SHALL NOTIFY THE ENGINEER FOR APPROVAL OF THE SIZE, TYPE AND QUANTITY OF STONE/FILL NECESSARY AND SHALL NOT BE USED UNTIL APPROVAL BY THE ENGINEER. THE GENERAL CONTRACTOR SHALL ALSO OBTAIN DRIVE PERMIT FOR NEW ACCESS DRIVE.

5. PREFABRICATED EQUIPMENT CABINETS, CANOPY, AND GENERATOR:

THIS VERIZON WIRELESS CONTRACTOR (VZW GC) SHALL PROVIDE ALL LABOR, EQUIPMENT AND MATERIALS FOR THE PROPER LIFTING, TRANSPORTING AND ASSEMBLY OF THE PREFABRICATED EQUIPMENT CANOPY FROM THE TRANSPORT TRUCK BED TO THE FINAL POSITION. THE EQUIPMENT CABINETS SHALL BE LIFTED INTO PLACE ON THE CONCRETE EQUIPMENT PAD. THE GENERATOR SHALL BE LIFTED INTO PLACE BY USING TWO SPREADER BAR ASSEMBLIES. EACH SPREADER BAR SHALL BE A MINIMUM 3' WIDE (RADAR TO CARRY 3 TONS). THE GENERATOR WEIGHT IS 1,425# WITH TANK PEDESTAL. VERIZON WIRELESS CONTRACTOR (VZW GC) SHALL ANCHOR THE EQUIPMENT CABINETS AND GENERATOR BASE TO THE CONCRETE SLAB USING ANCHOR BOLTS. EXTREME CAUTION SHALL BE TAKEN IN THE INSTALLATION OF ALL EQUIPMENT TO AVOID CONTACT WITH EXISTING OVERHEAD UTILITY LINES.

THE VERIZON WIRELESS CONTRACTOR (VZW GC) IS RESPONSIBLE FOR ATTACHING, SECURING OR ASSEMBLING ANY ACCESSORY OR LOOSE ITEMS THAT ARE SHIPPED WITH THE PREFABRICATED EQUIPMENT CABINETS, CANOPY AND GENERATOR AND SHALL INCLUDE THIS WORK IN THE VZW EQUIPMENT INSTALLATION PORTION OF THE BID.

6. UTILITIES:

THE CONTRACTOR SHALL BE RESPONSIBLE FOR THE EXCAVATION AND PROPER BACKFILLING OF TRENCHES AND SUPPLY CONDUIT REQUIRED FOR UNDERGROUND TELEPHONE & ELECTRICAL UTILITIES. ALL TRENCHING SHALL BE COMPACTED TO 95% MAXIMUM DRY DENSITY IN ACCORDANCE W/ASTM D-1557.

THE CONTRACTOR SHALL RUN AN ELECTRICAL TRENCH WITH 2 1/2" CONDUIT AND DETECTABLE FULL TAPE FROM THE NEW RADIO EQUIPMENT PAD AND END AT THE NEW METER BOARD STRUCTURE. THE CONTRACTOR SHALL THEN RUN (2) TWO 4" CONDUIT WITH PULL TAPE FROM THE METER BOARD TO THE NEW PAD MOUNTED TRANSFORMER LOCATION AND STUB UP 6" ABOVE GRADE. THE ELECTRICAL PROVIDER WILL THEN RUN UNDERGROUND CONDUIT FROM THE NEW TRANSFORMER TO THE NEW UTILITY POLE, CONTACT ---@###-####-####, WITH 22222222 BEFORE BEGINNING CONSTRUCTION TO VERIFY LOCATION, CONDUIT AND CONDUIT, CONTRACTOR CONDUITS MUST HAVE A MINIMUM DEPTH OF 36". CONTRACTOR SHALL CONTACT ELECTRIC PROVIDER TO HAVE TRENCH AND CONDUIT INSPECTED BEFORE THE TRENCH IS COVERED. THE ELECTRIC PROVIDER SHALL SUPPLY SERVICE TO THE NEW METER BOARD STRUCTURE. THE CONTRACTOR SHALL CONTACT ---@###-####-#### ENERGY TO SETUP AN INSPECTION OF THE TRENCHES BEFORE THEY ARE BACKFILLED. THE CONTRACTOR SHALL PROPER BACKFILL THE TRENCHES AFTER INSPECTION AND SETTLEMENT. CONTACT ELECTRIC PROVIDER THREE TO FOUR WEEKS PRIOR TO CONSTRUCTION FOR NEW SERVICE AND COORDINATION OF ACCESS TO SITE. THE CONTRACTOR SHALL CONTACT ----- FOR A COPY OF THEIR SPECIFICATIONS BEFORE CONSTRUCTION.

THE TOWER OWNER SHALL ENSURE PERMANENT ELECTRIC POWER IS AVAILABLE FOR VERIZON WIRELESS AT THE METER BASE PRIOR TO THE SITE BEING RELEASED TO VERIZON WIRELESS AS TENANT READY.

THE VERIZON WIRELESS GENERAL CONTRACTOR (VZW GC) SHALL RUN ELECTRICAL CONDUCTORS FROM NEW METER CENTER TO NEW VZW INTEGRATED LOAD CENTER WITHIN METER INSTALLED.

THE VERIZON WIRELESS GENERAL CONTRACTOR (VZW GC) SHALL BE RESPONSIBLE FOR THE ORDERING AND COORDINATING THE DELIVERY OF A FIBER OPTIC SERVICE LINE TO THE RADIO EQUIPMENT ENCLOSURE. COORDINATE WITH THE FIBER PROVIDER AND THE VERIZON WIRELESS FACILITY ENGINEER.

1. ONE 4" SIDR-11.5 HDPE FIBER CONDUITS w/INTEGRATED INNERDUCTS SHALL BE INSTALLED FROM HANDHOLE OUTSIDE COMPOUND MEET POINT AT THE PUBLIC MODEL RIGHT-OF-WAY WITHIN UTILITY EASEMENT WITH PULL TAPE THE HANDHOLE MODEL AS FOLLOWS:

- THE VERIZON FIBER CONDUIT HANDHOLES SHALL BE OLDCASTLE INFRASTRUCTURE SYSTEMS MODEL PC2436-30-T22, VERIZON LOGO OR QUATIHEMBURG POWER APPROVED EQUALS. ALTERNATIVE CONDUITS MAY BE USED IF MEETING THE DESIGNATED LOADING AND HAVING DIMENSIONS OF AT LEAST 2x3x2.5'. ALL VERIZON HANDHOLES TO HAVE "VERIZON" LOGO ON COVER.
- THE GENERAL USE FIBER CONDUIT HANDHOLE SHALL BE A MODEL AS APPROVED BY THE CONSTRUCTION MANAGER.
- 2. BY THE CONSTRUCTION MANAGER.
- 3. SO THAT SPACING BETWEEN HANDHOLES IS NO GREATER THAN 50 FEET.
- 3. CONTRACTOR SHALL PLACE (1) COPPERHEAD INDUSTRIES ORANGE TRACER WIRE CONDUIT(S).
- 4. ONE 4" SIDR-11.5 HDPE FIBER CONDUIT w/INTEGRATED INNERDUCTS SHALL BE INSTALLED FROM VERIZON WIRELESS EQUIPMENT PAD LOCATION (PER PLANS)

ELECTRIC SERVICE PROVIDED BY: ??????? POWER ADDRESS: STREET ADDRESS CITY, ST ZIP CODE CONTACT: TBD PHONE: TBD EMAIL: TBD

FIBER OPTIC SERVICE PROVIDED BY: FIBER PROVIDER TO BE DETERMINED BY VERIZON WIRELESS

10. EXCAVATION OF UTILITIES:

A. FIELD VERIFY THE LOCATION OF ANY EXISTING UNDERGROUND UTILITIES PRIOR TO EXCAVATING IN THE VICINITY OF THE SITE. ALL EXCAVATIONS SHALL BE MADE BY HAND OVER OR UNDER OR IMMEDIATELY ADJACENT TO ANY EXISTING UTILITIES & GROUNDING.

B. ALL UTILITY COMPANIES SHALL BE NOTIFIED AT LEAST 48 HOURS PRIOR TO ANY CONSTRUCTION ON THIS PROJECT. CONTACT UNDERGROUND UTILITY PROTECTION SERVICE BEFORE YOU DIG AT 1-800-382-5544 OR 811.

C. EXISTING UTILITIES ARE SHOWN FROM THE SURVEY AND ARE NOT NECESSARILY COMPLETE AND ACCURATE. THE CONTRACTOR SHALL BE RESPONSIBLE TO LOCATE, EXPLODE AND DETERMINE IF CONFLICTS EXIST WITH THE NEW IMPROVEMENTS. THE CONTRACTOR SHALL NOTIFY THE ENGINEER (A&E FIRM) IN ORDER TO RESOLVE ANY CONFLICTS.

11. CONTRACTOR'S LICENSE:

THE GENERAL CONTRACTOR, VERIZON WIRELESS GENERAL CONTRACTOR (VZW GC) AND ALL OF THEIR SUBCONTRACTORS THAT DO ANY WORK ON THIS PROJECT SHALL BE CURRENTLY LICENSED TO PERFORM WORK IN THE LOCATION OF THIS SITE. PROOF OF LICENSES SHALL BE SUPPLIED TO VERIZON WIRELESS PRIOR TO THE COMMENCEMENT OF ANY WORK.

12. SEEDING:

ALL DISTURBED AREAS SHALL BE REPAVED AND SEEDED BY THE GENERAL CONTRACTOR, UNLESS OTHERWISE AGREED. SEED DISTURBED AREAS W/4 POUNDS/1000 SQ. FT. - 60% KENTUCKY BLUEGRASS, 18% CREEPING RED FESCUE, 22% ANNUAL RYEGRASS.

13. TRAFFIC CONTROL:

THE CONTRACTOR SHALL FURNISH, INSTALL AND MAINTAIN ALL REQUIRED TRAFFIC CONTROL DEVICES IN ACCORDANCE WITH THE MANUAL OF UNIFORM TRAFFIC CONTROL DEVICES OR GOVERNING LOCAL AGENCIES.

14. CONSTRUCTION STAKING:

THE CONTRACTOR SHALL BE RESPONSIBLE FOR ALL CONSTRUCTION STAKING NEEDED TO COMPLETE ALL THE CONSTRUCTION SHOWN HEREON. CONTACT DESIGN ENGINEER TO SCHEDULE CONSTRUCTION STAKING.

15. THE CONTRACTOR SHALL BE RESPONSIBLE FOR ANY DAMAGE TO EXISTING PROPERTY RESULTING FROM THE CONSTRUCTION ACTIVITIES, INCLUDING, BUT NOT LIMITED TO PAVEMENT, FINISHED GRADES, LANDSCAPING, BUILDINGS, SURVEY MARKERS, FIELD TILES, CULVERTS, ETC.

16. IN THE EVENT ANY DISCREPANCIES OR ERRORS ARE FOUND ON THESE PLANS OR ANY CONFICTS OR PROBLEMS ARE ENCOUNTERED DURING CONSTRUCTION, THE GENERAL CONTRACTOR OR VERIZON WIRELESS GENERAL CONTRACTOR (VZW GC) SHALL NOTIFY THE ENGINEER BEFORE PROCEEDING WITH THE WORK. NO ADDITIONAL COMPENSATION WILL BE PAID TO THE GENERAL CONTRACTOR OR VERIZON WIRELESS GENERAL CONTRACTOR (VZW GC) FOR WORK HAVING TO BE REDONE FOR GRADE OR GEOMETRIC DISCREPANCIES IF NOTICE TO THE ENGINEER HAS NOT BEEN PROVIDED. THE ENGINEER RESERVES THE RIGHT TO MAKE MINOR ADJUSTMENTS AS NECESSARY TO ACCOMPLISH THE INTENT OF THESE PLANS.

17. ALL SITE WORK AND CONSTRUCTION SHALL CONFORM TO ANY AND ALL APPLICABLE CODES AND VERIZON WIRELESS STANDARDS AND SPECIFICATIONS.

18. ALL ELEVATIONS AND TOPOGRAPHIC INFORMATION WAS TAKEN FROM A SURVEY SHIPPED TO A&E FIRM BY SURVEYING FIRM. A&E FIRM HAS NOT VERIFIED THIS INFORMATION AND DOES NOT WARRANT ANY INFORMATION SUPPLIED BY OTHERS.

19. THE GENERAL CONTRACTOR SHALL MAINTAIN A COMPLETE AS-BUILT SET OF PLANS AND CONDITIONS, AND SUBMIT SAME TO THE ENGINEER WITHIN 7 DAYS OF COMPLETION OF CONSTRUCTION, AS-BUILT PLANS SUBMITTED TO THE ENGINEER UNDERGROUND UTILITIES, GROUNDING GRID, EQUIPMENT PAD, TOWER FOUNDATION, TOWER PLATEFORM ORIENTATION, AND FENCE WITHIN THE LEASE AREA OR PROPERTY AND BE CERTIFIED BY A LICENSED PROFESSIONAL SURVEYOR.

20. THE GENERAL CONTRACTOR AND VERIZON WIRELESS GENERAL CONTRACTOR (VZW GC) SHALL BE RESPONSIBLE FOR NOTIFICATION OF ALL GOVERNING AGENCIES THAT REQUIRE SITE INSPECTION OF THE WORK AND/OR SIMPLY NOTIFICATION.

21. THE GENERAL CONTRACTOR AND VERIZON WIRELESS GENERAL CONTRACTOR (VZW GC) THAT REQUIRE SITE INSPECTION OR TESTING OF THE WORK AS DIRECTED IN THESE PLANS, GOVERNING AGENCIES AND ALL APPLICABLE CODES.

22. PRIOR TO THE SUBMISSION OF BIDS, THE GENERAL CONTRACTOR AND HIS SUBCONTRACTORS SHALL VERIFY THE DRAWINGS AND SCHEDULES ON THE DRAWINGS AND SPECIFICATIONS PROVIDED BY THE OWNER, FOR MEANING OF ABBREVIATIONS AND ADDITIONAL REQUIREMENTS AND INFORMATION, CHECK ALL CONSTRUCTION DOCUMENTS TO INCLUDE, BUT NOT LIMITED TO, GEOTECHNICAL REPORT, STRUCTURAL ANALYSIS, TOWER, MECHANICAL AND ELECTRICAL DRAWINGS, FOR SCALE, SPACE LIMITATIONS, DOOR SWINGS, ADJACENT EQUIPMENT COORDINATION AND ADDITIONAL INFORMATION, ETC. REPORT ANY DISCREPANCIES, CONFLICTS, ETC. TO THE OWNER BEFORE SUBMITTING BIDS.

24. WORK SITE SAFETY:

A. CONTRACTOR AND VERIZON WIRELESS CONTRACTOR (VZW GC) ARE RESPONSIBLE TO EDUCATE THEIR WORK FORCE OF THE DANGERS AND LIMIT THEIR EXPOSURE TO HAZARDS. THIS EDUCATION SHALL INCLUDE BUT NOT BE LIMITED TO APPROPRIATE TRAINING COURSES AND CERTIFICATIONS, PROPER PERSONAL PROTECTIVE EQUIPMENT USAGE, DAILY TAILGATE MEETINGS AND ANY OTHER PROTECTIVE MEASURES WHICH MAY BE REASONABLY EXPECTED.

B. CONTRACTOR (VZW GC) AND ALL SUB-CONTRACTORS SHALL BE RESPONSIBLE FOR THE SAFETY OF THE WORK AREA, ADJACENT AREAS AND ANY PROPERTY OCCUPANTS WHO MAY BE AFFECTED BY THE WORK UNDER CONTRACT. ALL CONTRACTORS SHALL REVIEW ALL LANDOWNER, PRIME CONTRACTOR, CARRIER, OSHA AND LOCAL SAFETY GUIDELINES AND AT ALL TIMES SHALL CONFORM TO THE MOST RESTRICTIVE OF THESE STANDARDS TO ENSURE A SAFE WORKPLACE.

C. TOWER WORK PRESENTS UNIQUE THREATS TO HEALTH AND SAFETY. ALL TOWER WORKERS WORKING ON A TOWER MUST BE ADEQUATELY TRAINED AND MONITORED TO ENSURE THAT SAFE WORK PRACTICES ARE LEARNED AND FOLLOWED. EMPLOYEES MUST BE PROVIDED WITH APPROPRIATE FALL PROTECTION, TRAINED TO USE THIS FALL PROTECTION PROPERTY, AND THE USE OF FALL PROTECTION MUST BE CONSISTENTLY SUPERVISED AND ENFORCED BY THE CONTRACTOR.

C. ALL SAFETY EQUIPMENT SHALL BE INSPECTED ACCORDING TO ALL OSHA AND INDUSTRY SCHEDULED INTERVALS AND ALL INSPECTIONS SHALL BE DOCUMENTED PER APPLICABLE CODES AND STANDARDS.

SITE INFORMATION:

LV M/T VERNON EAST

321 FROSTY HOLLOW ROAD
MT VERNON, KY 40456
ROCK CASTLE COUNTY

SITE NUMBER:

721772

SITE NAME:

LV M/T VERNON EAST

SHEET NUMBER:

16913443

SHEET TITLE:

RC
PL
10.25.23

GENERAL SITE CONSTRUCTION NOTES

SHEET NUMBER:

C — 6

SHEET NUMBER:

WK PAD & CANTOPY REV 3 FINAL 10/16/23



LAB

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EROSION & SEDIMENT CONTROL NOTES

- ALL WORK SPECIFIED AS A/AN DOT ITEM SHALL BE GOVERNED BY THE STATE OF INDIANA DEPARTMENT OF TRANSPORTATION CONSTRUCTION AND MATERIAL SPECIFICATION HANDBOOK. IT IS CONTRACTORS RESPONSIBILITY TO POSSESS AND BE FAMILIAR WITH APPLICABLE SECTIONS.
- THIS CONTRACT DRAWING SHALL BE MADE AVAILABLE ON SITE AT ALL TIMES AND PRESENTED UPON REQUEST. IF UNFORESEEN STORM WATER POLLUTION PREVENTION IS ENCOUNTERED, ADDITIONAL STORM WATER POLLUTION PREVENTION (SWPP) MEASURES MAY BE REQUESTED BY THE OWNER, COUNTY ENGINEER, PROJECT ENGINEER OR SOIL CONSERVATION REPRESENTATIVE AT ANYTIME. SUCH REQUESTS SHALL BE IMPLEMENTED IMMEDIATELY AT CONTRACTOR'S EXPENSE.
- ALL STORM WATER POLLUTION PREVENTION ITEMS SHALL BE INSTALLED AS SHOWN OR NOTED ON THIS SHEET.
- PLANT TEMPORARY SEEDING AND MULCHING IN ALL AREAS THAT SHALL BE INACTIVE FOR 7 DAYS OR MORE. ALL DISTURBED OR ERODED EARTH SHALL BE REGRADED AND SEEDED WITHIN 14 DAYS WITH SEEDING AS DEFINED ABOVE AND AS SHOWN ON THE TABLE BELOW. TO ESTABLISH STABILITY AND PROVIDE SEDIMENT CONTROL WHERE POSSIBLE, TEMPORARY SEEDING GROWTH SHALL NOT BE MOVED UNTIL IT HAS GONE TO SEED FOR 1 YEAR.

LAB

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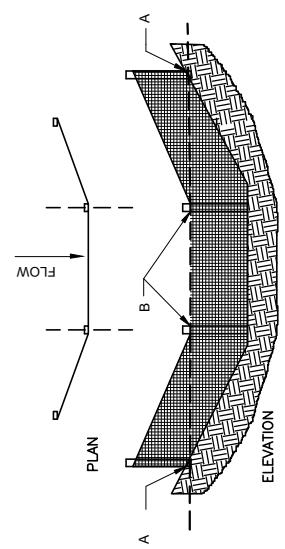
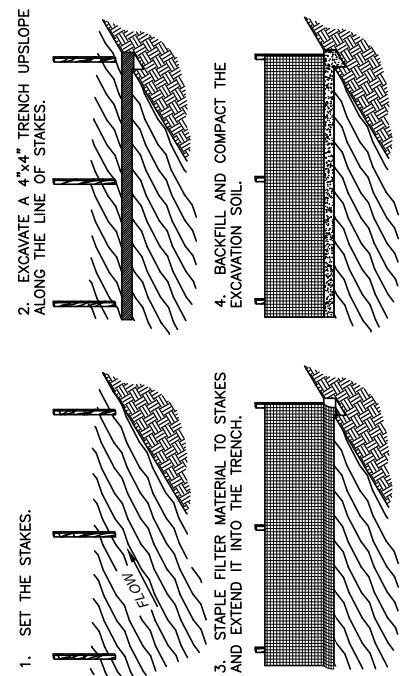
REV.	DATE	DESCRIPTION	JAN. FEB. MAR. APR. MAY JUN. JUL. AUG. SEP. OCT. NOV. DEC.
A	08/04/23	ISSUED FOR REVIEW	
B	08/16/23	ISSUED FOR REVIEW	
C	11/16/23	REVISED FOR CONSTRUCTION	
D	12/27/23	ISSUED FOR REVIEW	
E			*
F			**



SITE INFORMATION:
LV MT VERNON EAST
321 FROSTY HOLLOW ROAD
MT VERNON, KY 40456
ROCK CASTLE COUNTY

SITE NAME:
LV MT VERNON EAST
PID NUMBER: 16913443
DRAWN BY: RC
CHECKED BY: PL
DATE: 10/25/23
SHEET TITLE: **BEST MANAGEMENT PRACTICES & EROSION CONTROL DETAILS AND NOTES**
SHEET NUMBER: C-7


WK PAD & CANOPY REV 3 FINAL 10/16/23



POINTS A SHOULD BE HIGHER THAN POINT B


SILT FENCE DETAIL C-7

SCALE: N.T.S.

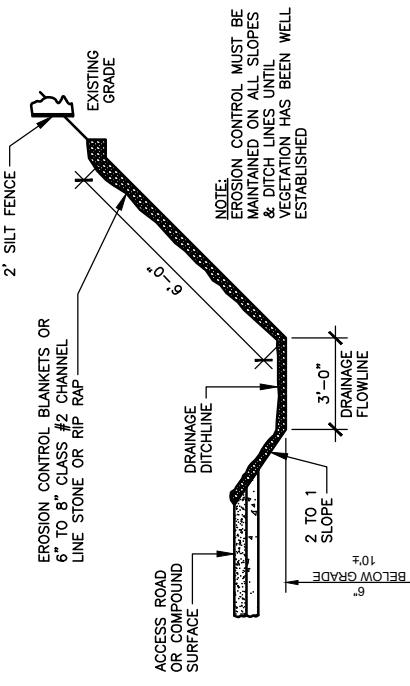

TEMPORARY STABILIZED CONSTRUCTION ENTRANCE 1 C-7

SCALE: N.T.S.

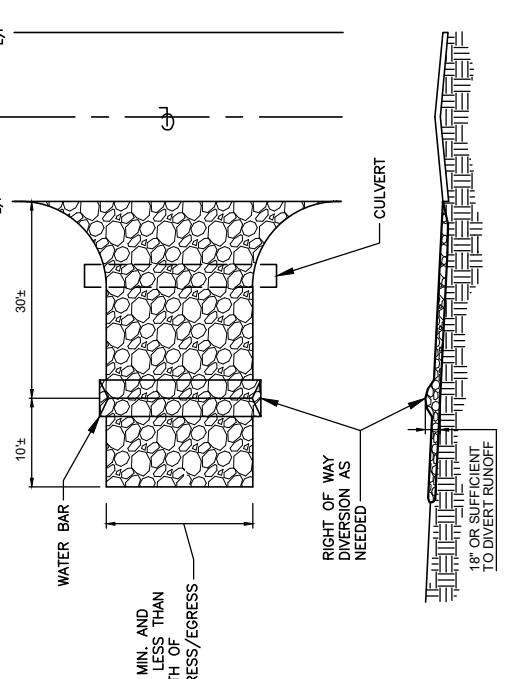

NOTES:

- STONE SIZE - TWO INCH STONE SHALL BE USED, OR RECYCLED CONCRETE EQUIVALENT.
- THE CONSTRUCTION ENTRANCE SHALL CONCIDE WITH THE PROPOSED DRIVE AS SHOWN ON THE PLAN.
- PAVEMENT THICKNESS - STONE LAYER SHALL BE AT LEAST 6" THICK.
- DRIVEWAY WIDTH - THE ENTRANCE SHALL BE AT LEAST 10' WIDE, BUT NOT LESS THAN FULL WIDTH AT POINTS WHERE INGRESS/EGRESS OCCURS.
- BEDDING - A GEOTEXTILE SHALL BE PLACED OVER THE ENTIRE AREA PRIOR TO PLACING STONE. IT SHALL HAVE A GRAB TENSILE STRENGTH OF AT LEAST 200 LBS. AND A MULLEN BURST STRENGTH OF AT LEAST 190 LBS.
- CULVERT - A PIPE OR CULVERT SHALL BE CONSTRUCTED UNDER THE ENTRANCE IF NEEDED TO PREVENT SURFACE WATER FLOWING ACROSS THE ENTRANCE FROM BEING DIRECTED OUT ONTO PAVED SURFACES.
- WATER BAR - A WATER BAR SHALL BE CONSTRUCTED AS PART OF THE CONSTRUCTION ENTRANCE IF NEEDED TO PREVENT SURFACE RUNOFF FROM FLOWING THE LENGTH OF THE CONSTRUCTION ENTRANCE AND OUT ONTO PAVED SURFACES.
- Maintenance - Top dressing of additional stone shall be applied as conditions demand. Mud spilled, dropped, washed or tracked onto public roads, or any surface where runoff is not checked by sediment controls, shall be removed immediately. Removal shall be accomplished by scraping or sweeping.
- Constructions entrances shall not be relied upon to remove mud from vehicles and prevent off site tracking vehicles that enter and leave the construction site. Construction entrance shall be restricted from muddy areas.
- Under the entrance if needed to prevent surface water flowing across the entrance from being directed out onto paved surfaces.
- Water bar - a water bar shall be constructed as part of the construction entrance if needed to prevent surface runoff from flowing the length of the construction entrance and out onto paved surfaces.
- Maintenance - top dressing of additional stone shall be applied as conditions demand. Mud spilled, dropped, washed or tracked onto public roads, or any surface where runoff is not checked by sediment controls, shall be removed immediately. Removal shall be accomplished by scraping or sweeping.
- Constructions entrances shall not be relied upon to remove mud from vehicles and prevent off site tracking vehicles that enter and leave the construction site. Construction entrance shall be restricted from muddy areas.

CONSTRUCTION SEQUENCE

- STAKE AND/OR FLAG LIMITS OF CLEARING
- DURING PRECONSTRUCTION MEETING ALL EROSION & SEDIMENT CONTROL FACILITIES & PROCEDURES SHALL BE DISCUSSED.
- CLEARING & GRUBBING AS NECESSARY, FOR INSTALLATION OF PERIMETER CONTROLS.
- INSTALL SILT FENCE PERIMETER CONTROLS AS SHOWN ON PLANS.
- COLLECTION ON VEHICLE TIRES, THE TIRES MUST BE CLEANED BEFORE THE VEHICLES ENTER THE PUBLIC ROADWAY. THE SITE ENTRANCE SHALL BE MAINTAINED IN A CONDITION THAT WILL PREVENT THE TRACKING OR FLOW OF MUD INTO THE PUBLIC RIGHT-OF-WAY. ALL MATERIALS SPILLED, DROPPED, WASHED OR TRACED FROM VEHICLES ONTO THE ROADWAY MUST BE REMOVED FROM PROMPTLY.
- CLEARING & GRUBBING AS REQUIRED TO REACH SUBGRADE.
- BEGIN FILLING & GRAVING DURING FILLING AND GRADING ACTIVITIES.
- CONSTRUCT AND MAINTAIN TEMPORARY DRAINAGE SWALES DURING FILLING AND GRADING ACTIVITIES.
- CONSTRUCT SITE WORK INCLUDING STORM DRAINAGE FACILITIES.
- MANTAIN EROSION & SEDIMENTATION CONTROL MEASURES UNTIL THE SITE HAS BEEN COMPLETELY STABILIZED.
- REMOVE SEDIMENT CONTROLS.

DRAINAGE DITCHLINE DETAIL (SWALE) 3 C-7

SCALE: N.T.S.

- NOTES:**
- WHEN FACED WITH SLOPES LESS THAN 2 TO 1 SLOPES, ALL SLOPES SHOULD BE DOZER TRACKED PRIOR TO SEDDING OR RIP RAP EMBEDDED ON SLOPES SURFACES TO REDUCE EROSION.
 - ALL FLOWLINES MUST BE INSTALLED BELOW SUB-GRADE OF COMPOUND. (AT MINIMUM OF 6" BELOW)

WK PAD & CANOPY REV 3 FINAL 10/16/23

C-7



TAG
TOWERS
5


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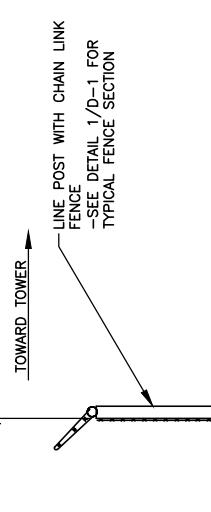
CHAIN LINK FENCING NOTES

1. ALL FENCE AND FABRIC SHALL BE HOT DIPPED GALVANIZED WITH A MINIMUM OF 2 OZ. PER SQUARE FOOT, 9 GAUGE WIRE (MIN. BREAKING STRENGTH OF 1,290 LBS) WITH 2" MESH. ALL BARBED WIRE SHALL BE ALUMINUM OR COATED PER NOTE #4.
2. BOTTOM EDGE OF FENCE FABRIC SHALL EXTEND TO FINISHED GRADE.
3. SITE FENCE SHALL BE 6'-0" FABRIC W/ 3 STRAND BARBED WIRE FOR TOTAL HEIGHT OF 7'-0".
4. BARBED WIRE SHALL MEET ASTM A 121, CLASS 3 GALV. OR ASTM A 585, TYPE I, CLASS 2 COATING (NOT LESS THAN 0.8 OZ. PER SQ. FT.) AND SHALL BE THREE STRAND 12.5 GAGE w/4 POINT BARBS AT 5° O/C.
5. BOTTOM OF CONCRETE BASE SHALL BE SET BELOW FROSTLINE (SEE LOCAL CODE), WHERE SOIL BEARING CAPACITY IS LESS THAN 2000 PSF, INCREASE CONCRETE SURROUNDING FENCE POST FOUNDATION DIAMETERS BY 8", PROVIDE CONCRETE WITH A 28 DAY STRENGTH OF 3000 PSI (MIN.).
6. PROVIDE A DIAGONAL BRACE ROD ON BOTH GATE LEAFS.
7. ALL RAILS AND BRACES SHALL BE SCHEDULE 40 STEEL PIPE, AND BE 2 OZ.. GALVANIZED COATED.
8. CONTRACTOR SHALL ENSURE ALL POSTS ARE PLUMB.
9. ALL FENCE SHALL BE FABRICATED AND INSTALLED PER ASTM F2611-15, ASTM F567-14o AND CHAIN LINK FENCE MANUFACTURES INSTITUTE CLMI-PM 245.
10. CONTRACTOR SHALL FURNISH AND INSTALL ONE (1) MASTER LOCK LONG SHANK #475UH COMBINATION PADLOCK. COMBINATION TO BE SET AT 7011.




CHAIN LINK FENCE & POST DETAIL 1

SCALE: N.T.S.

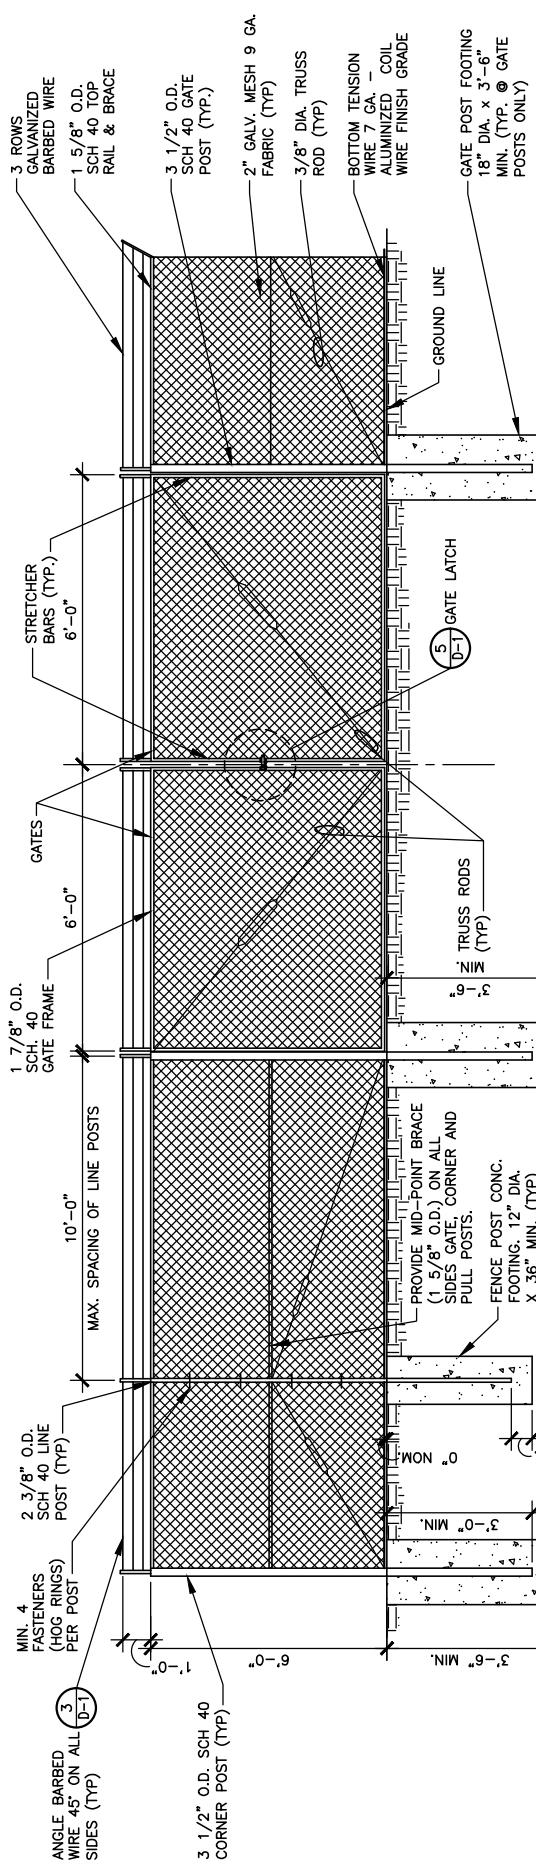


TYPICAL BARBED WIRE DETAIL 3

SCALE: N.T.S.

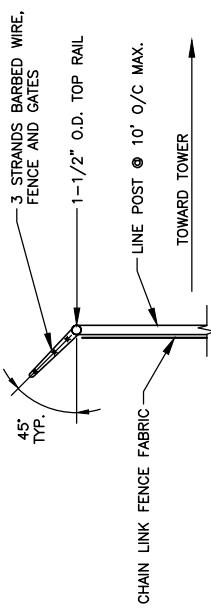


SITE AREA SURFACING 2

SCALE: N.T.S.

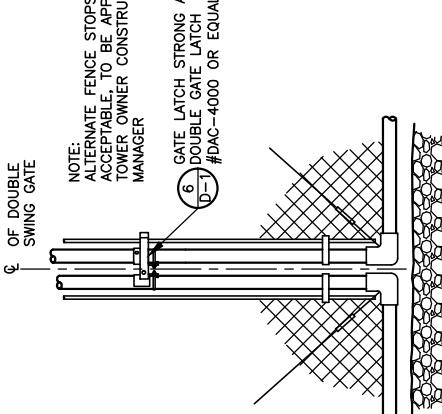

GATE LATCH DETAIL 5

SCALE: N.T.S.

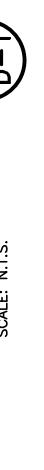

SITE INFORMATION:
LV MT VERNON EAST
DMITRIY V. ALBUL
LICENSED PROFESSIONAL
25093
Signature

321 FROSTY HOLLOW ROAD
MT VERNON, KY 40456
ROCK CASTLE COUNTY

SITE NUMBER:
721772
SITE NAME:

LV MT VERNON EAST
PID NUMBER: 16913443
DRAWN BY: RC
CHECKED BY: PL
DATE: 10/25/23
SHEET TITLE:

FENCE DETAILS AND NOTES


SHEET NUMBER:
D — 1
WIK PAD & CANOPY REV 3 FINAL 10/16/23



TAG
TOWERS
108 FOREST COURT, SUITE 1
RICHMOND, KY 40475
859-544-5000 (PH)

LAB

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Wixom, Michigan 48393
PHONE: (248) 705-9212

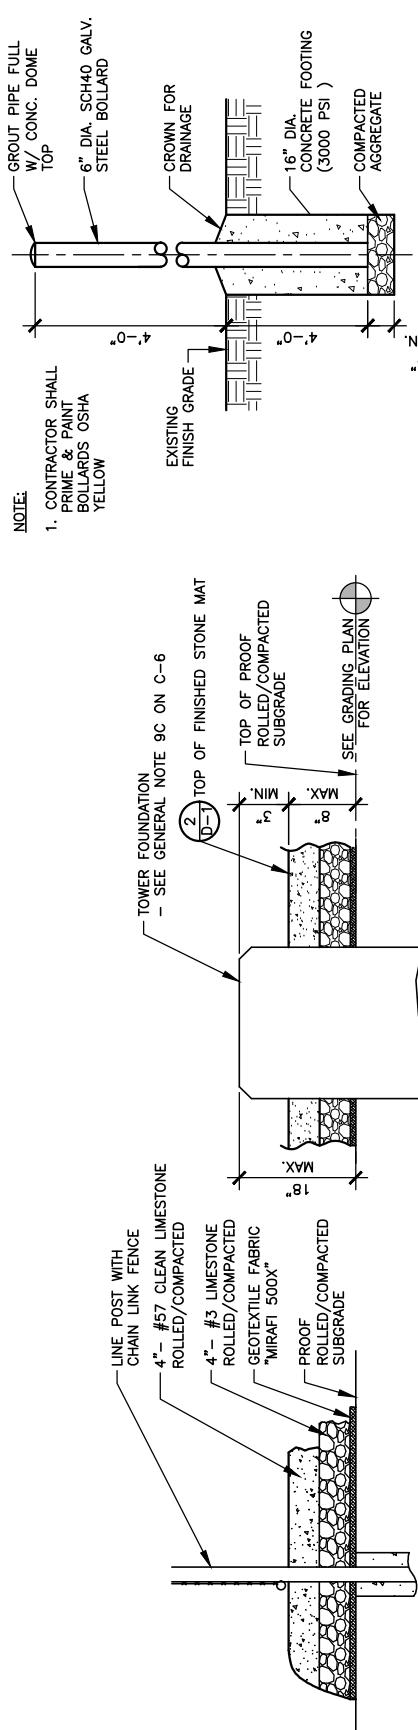

ACCESS DRIVE TYPICAL SECTION **2** **D-2**

SCALE: N.T.S.

REGRADE DRIVE AND COMPACT 6" OF CRUSHER RUN (#57) AGGREGATE LIMESTONE (AFTER INSTALLATION OF TOWER AND BUILDING)

6" #3 LIMESTONE 4 POUNDS/1000 SQ. FT. 60% KENTUCKY BLUEGRASS 18% CREEPING RED FESCUE 22% ANNUAL RYEGRASS

6" #3 LIMESTONE W/DGA SPREAD AND COMPACT
REMOVE TOPSOIL 1'-0" DEEP MINIMUM FROM SITE & COMPACT SUBGRADE TO DOT STANDARDS

SLOPE TO MEET EXISTING GRADE (TYP.)
1/4"/FT. (MAX.)
1/4"/FT. (MAX.)


INSTALL MIRAFI 500X ENGINEERING FABRIC ACCORDING TO MANUFACTURERS RECOMMENDATIONS

CULVERT DETAIL **3** **D-2**

SCALE: N.T.S.

6" MINIMUM AGGREGATE BASE PER DESIGN
EX. DITCH
COMPACTED PFA GRAVEL BACKFILL AND BEDDING
C/L EXISTING DITCH PROPOSED CULVERT
TRANSITION DITCH BACK TO EXISTING IN 15 LF. AT EACH END OF CULVERT
6" BEVEL DITCH PROPOSED IN. EXISTING DITCH
MIN. 1'-0" MIN. 6"

MIN. 6' TEMPORARY DURING FINAL CONFIGURATION LENGTH OF 15" ALUMINIZED STEEL PIPE TYPE 2, 3" x 1" CORR.
- SEE PLAN ON C-2 FOR LOCATIONS
- VERIFY FINAL CULVERT DIAMETER WITH COUNTY HIGHWAY DEPARTMENT

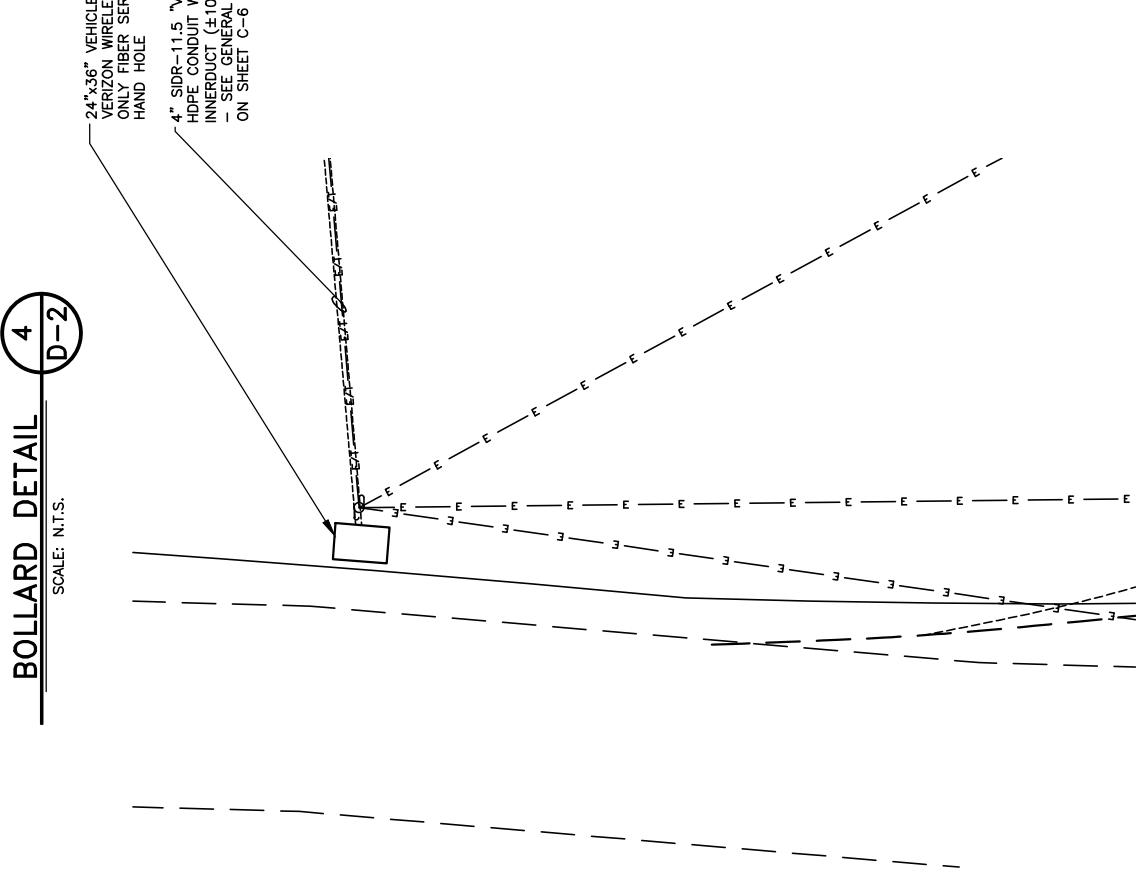

ENLARGED FIBER HAND HOLE PLAN AT R.O.W. **5** **D-2**

SCALE: 3'/32" = 1'-0"



SITE DETAILS

SHEET NUMBER:
D-2

CULVERT DETAIL **3** **D-2**

SCALE: N.T.S.

SHEET NUMBER:
D-2

Wk Pad & Canopy Rev 3 Final 10/16/23

SITE INFORMATION:
LV MT VERNON EAST
321 FROSTY HOLLOW ROAD
MT VERNON, KY 40456
ROCK CASTLE COUNTY

SITE NAME:
LV MT VERNON EAST
PID NUMBER: 16913443
DRAWN BY: RC
CHECKED BY: PL
DATE: 10/25/23
SHEET TITLE:

SITE DETAILS

SHEET NUMBER:
D-2



DMITRIY V. ALBUL
25093
LICENSED PROFESSIONAL ENGINEER
Signature



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RICHMOND, KY 40475
859-544-5000 (PH)

LAB

49030 Portiac Trail, Suite 100
Wixom, Michigan 48393
PHONE: (248) 705-9212



SITE INFORMATION:
LV MT VERNON
EAST
321 FROSTY HOLLOW ROAD
MT VERNON, KY 40456
ROCK CASTLE COUNTY


SITE NUMBER:
721772
SITE NAME:
LV MT VERNON EAST

EQUIPMENT PAD &
CANOPY ELEVATIONS

SHEET NUMBER:
D — 3


WK PAD & CANOPY REV 3 FINAL 10/16/23

NOTE:
CANOPY ROOF PANELS PROFILE R/PBR.
PROVIDE 1.7lb DENSITY POLYETHYLENE
FOAM PANEL CLOSURE STRIPS TO MATCH
PROFILE AS MANUFACTURED BY: SATELLITE
BUILDING FASTENERS 'ST CLOSURE'
STRIPS OR EQUAL (VERIFY PROFILE WITH
ROOF PANELS SUPPLIED WITH CANOPY)

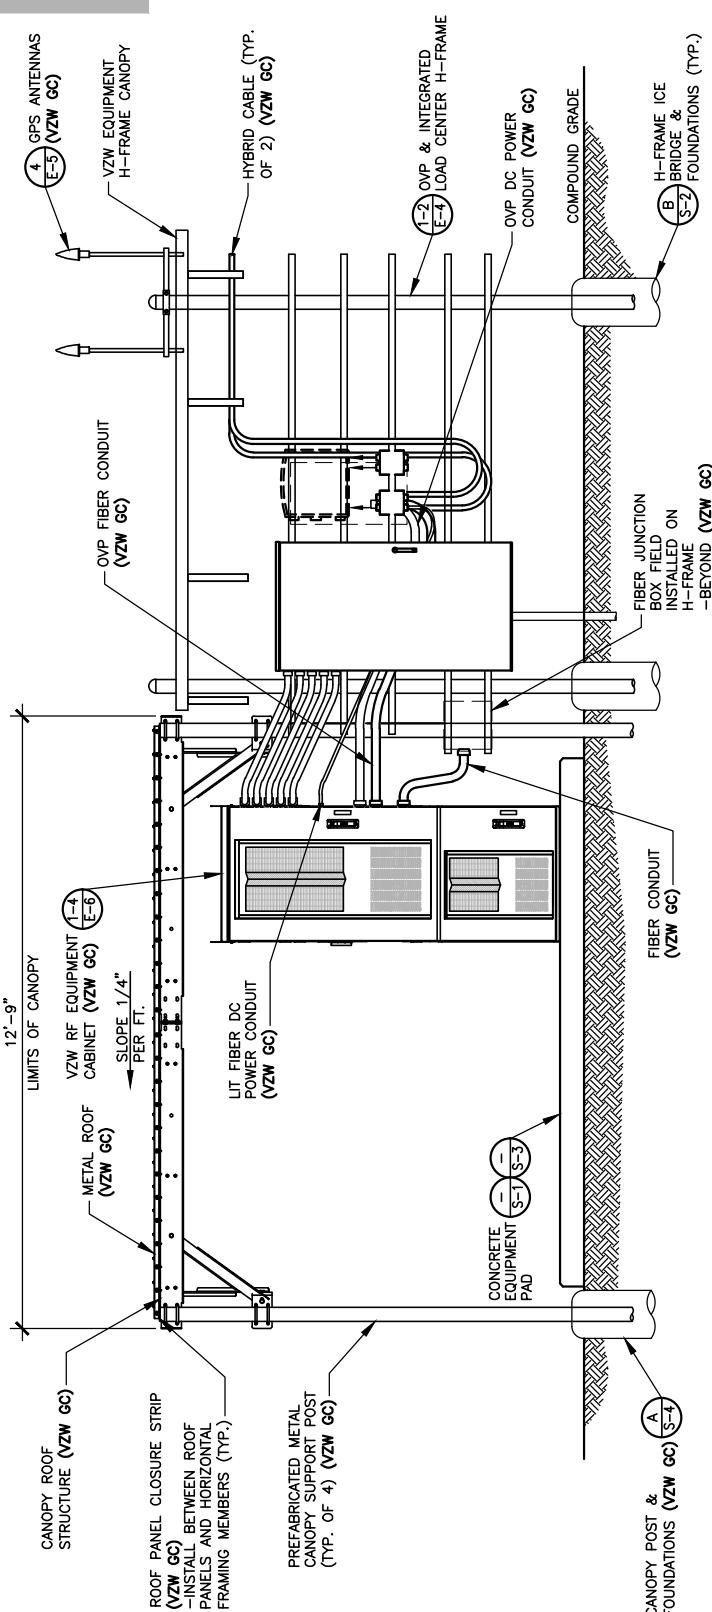


FRONT ELEVATION
SCALE: 1/4" = 1'-0"


NOTE:
VERIZON WIRELESS 9'-6" x 12'-9"
RADIO EQUIPMENT CANOPY
(CANOPY DINGS, SUPPLIED BY
MANUFACTURER) (VZW GC)
-COMMSCOPE P/N EQ-#0162-RC-B

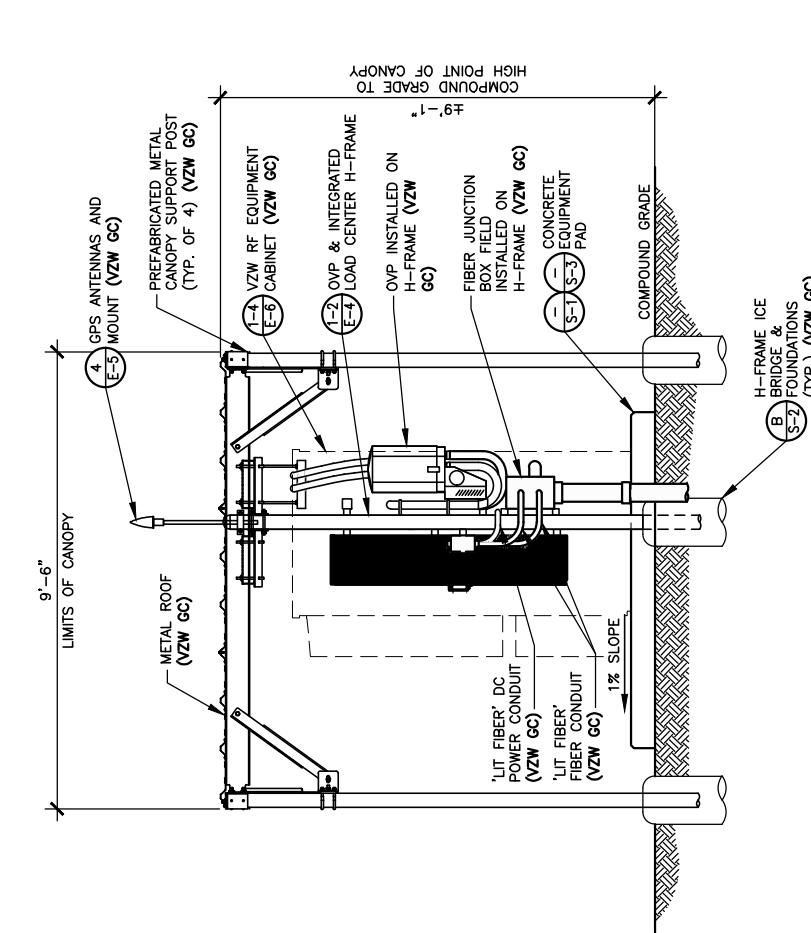

GENERATOR ELEVATION
SCALE: 1/4" = 1'-0"

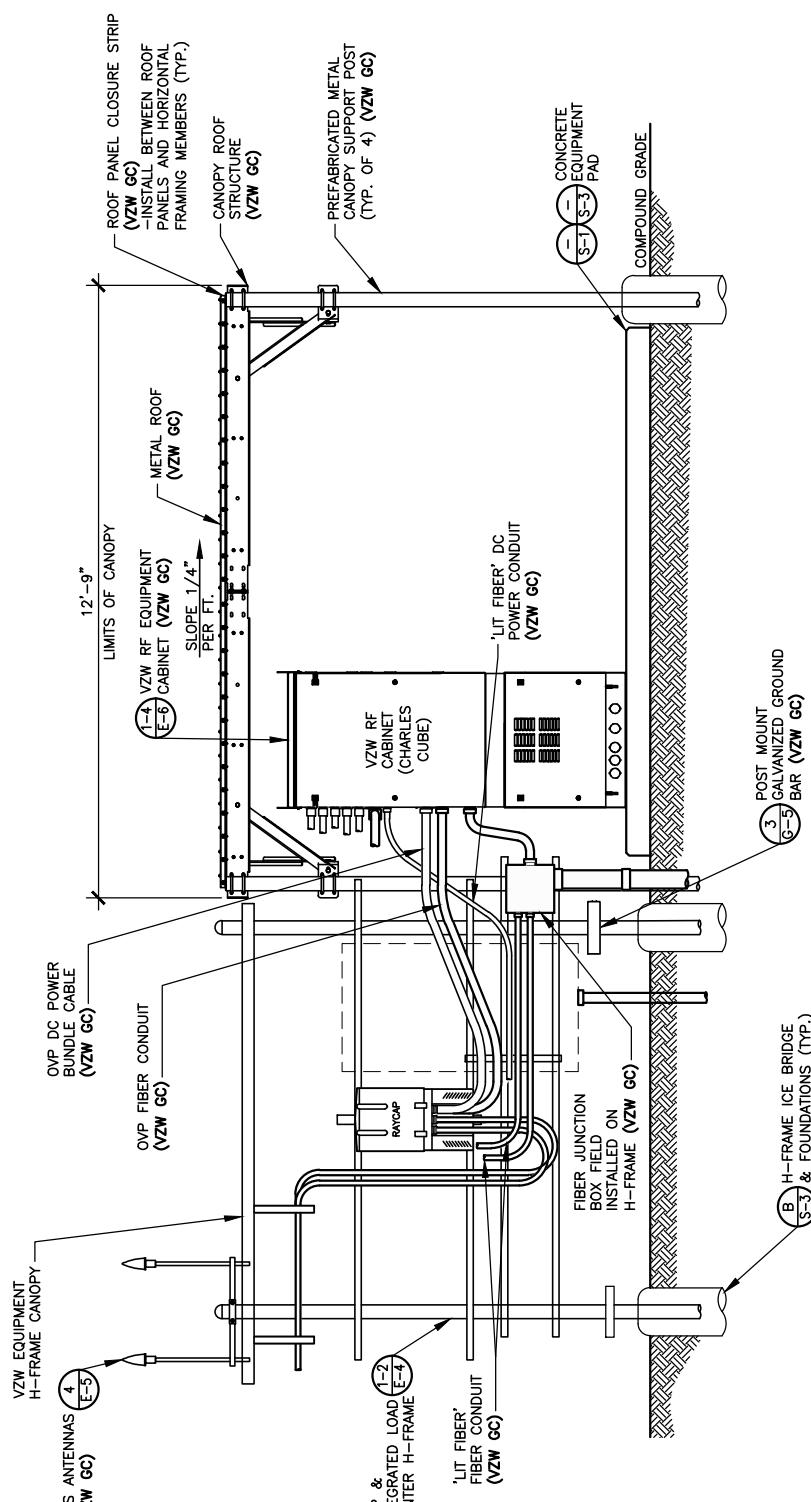

RIGHT ELEVATION
SCALE: 1/4" = 1'-0"

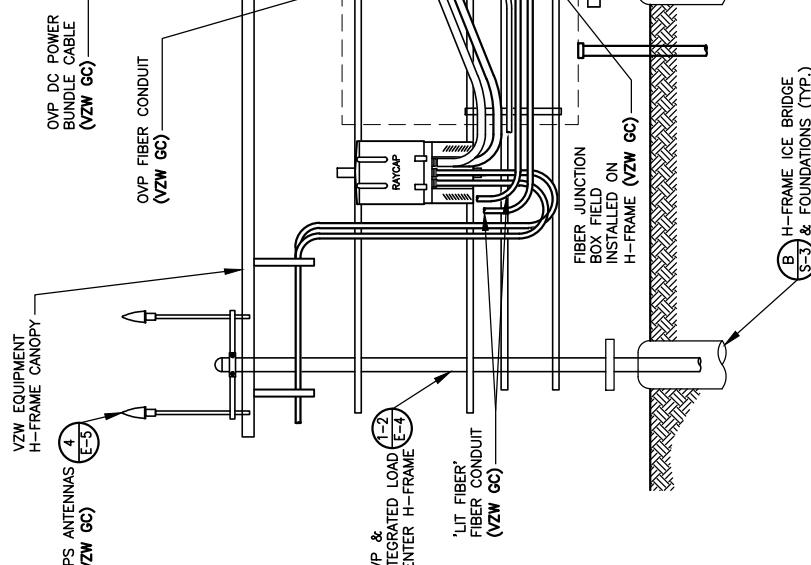

REAR ELEVATION
SCALE: 1/4" = 1'-0"



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859-544-5000 (PH)



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Wixom, Michigan 48393
PHONE: (248) 705-9212

STANDARD SITE SIGNAGE:

REQUIRED SIGNS:	LOCATIONS:
(C1) • N.O.C. "IN CASE OF EMERGENCY"	FRONT ACCESS DOOR OF CABINET (SEE FIGURE 1)
(C2) • NOTICE (CONTACT INFO)	
(C3) • COMBINATION WARNING (SEE NOTE 2)	FRONT ACCESS DOOR OF EACH CABINET WITH BATTERIES (SEE FIGURE 1)
(C4) • COMBINATION WARNING (SEE NOTE 2)	INSIDE FRONT ACCESS DOOR OF EACH CABINET WITH BATTERIES
(C5) • S.D.S.	-N.O.C. STANDS FOR "NETWORK OPERATIONS CENTER" -S.D.S. STANDS FOR "SAFETY DATA SHEET"

NOTES:

- CONTRACTOR SHALL INSTALL ALL SIGNS ON THE FRONT OF EACH CABINET. ALL SIGNS CAN BE PLACED ON ONLY THE UPPER DOOR, IF SPACE IS AVAILABLE.
- CONTRACTOR SHALL INSTALL SIGN C3 OR C4 BASED ON THE TYPE OF BATTERY THAT IS BEING INSTALLED.

(C1)



(C2)



(C3)



(C4)

(C4)



(C5)



-N.O.C. STANDS FOR "NETWORK OPERATIONS CENTER"

-S.D.S. STANDS FOR "SAFETY DATA SHEET"

NOTES:

- CONTRACTOR SHALL INSTALL ALL SIGNS ON THE FRONT OF EACH CABINET. ALL SIGNS CAN BE PLACED ON ONLY THE UPPER DOOR, IF SPACE IS AVAILABLE.
- CONTRACTOR SHALL INSTALL SIGN C3 OR C4 BASED ON THE TYPE OF BATTERY THAT IS BEING INSTALLED.

(C1)



(C2)



(C3)



(C4)

(C4)



(C5)



-N.O.C. STANDS FOR "NETWORK OPERATIONS CENTER"

-S.D.S. STANDS FOR "SAFETY DATA SHEET"

NOTES:

- CONTRACTOR SHALL INSTALL ALL SIGNS ON THE FRONT OF EACH CABINET. ALL SIGNS CAN BE PLACED ON ONLY THE UPPER DOOR, IF SPACE IS AVAILABLE.
- CONTRACTOR SHALL INSTALL SIGN C3 OR C4 BASED ON THE TYPE OF BATTERY THAT IS BEING INSTALLED.

(C1)



(C2)



(C3)



(C4)

(C4)



(C5)



-N.O.C. STANDS FOR "NETWORK OPERATIONS CENTER"

-S.D.S. STANDS FOR "SAFETY DATA SHEET"

NOTES:

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- CONTRACTOR SHALL INSTALL SIGN C3 OR C4 BASED ON THE TYPE OF BATTERY THAT IS BEING INSTALLED.

(C1)



(C2)



(C3)



(C4)

(C4)



(C5)



-N.O.C. STANDS FOR "NETWORK OPERATIONS CENTER"

-S.D.S. STANDS FOR "SAFETY DATA SHEET"

NOTES:

- CONTRACTOR SHALL INSTALL ALL SIGNS ON THE FRONT OF EACH CABINET. ALL SIGNS CAN BE PLACED ON ONLY THE UPPER DOOR, IF SPACE IS AVAILABLE.
- CONTRACTOR SHALL INSTALL SIGN C3 OR C4 BASED ON THE TYPE OF BATTERY THAT IS BEING INSTALLED.

(C1)



(C2)




(C3)



(C4)

(C4)

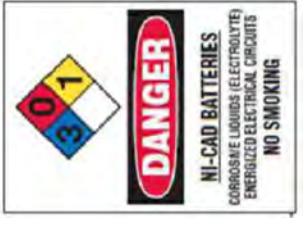

(C5)



-N.O.C. STANDS FOR "NETWORK OPERATIONS CENTER"

-S.D.S. STANDS FOR "SAFETY DATA SHEET"

NOTES:

- CONTRACTOR SHALL INSTALL ALL SIGNS ON THE FRONT OF EACH CABINET. ALL SIGNS CAN BE PLACED ON ONLY THE UPPER DOOR, IF SPACE IS AVAILABLE.
- CONTRACTOR SHALL INSTALL SIGN C3 OR C4 BASED ON THE TYPE OF BATTERY THAT IS BEING INSTALLED.

(C1)



(C2)



(C3)



(C4)

(C4)



(C5)



-N.O.C. STANDS FOR "NETWORK OPERATIONS CENTER"

-S.D.S. STANDS FOR "SAFETY DATA SHEET"

NOTES:

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- CONTRACTOR SHALL INSTALL SIGN C3 OR C4 BASED ON THE TYPE OF BATTERY THAT IS BEING INSTALLED.

(C1)



(C2)



(C3)



(C4)

(C4)



(C5)



-N.O.C. STANDS FOR "NETWORK OPERATIONS CENTER"

-S.D.S. STANDS FOR "SAFETY DATA SHEET"

NOTES:

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- CONTRACTOR SHALL INSTALL SIGN C3 OR C4 BASED ON THE TYPE OF BATTERY THAT IS BEING INSTALLED.

(C1)



(C2)



(C3)



(C4)

(C4)



(C5)



-N.O.C. STANDS FOR "NETWORK OPERATIONS CENTER"

-S.D.S. STANDS FOR "SAFETY DATA SHEET"

NOTES:

- CONTRACTOR SHALL INSTALL ALL SIGNS ON THE FRONT OF EACH CABINET. ALL SIGNS CAN BE PLACED ON ONLY THE UPPER DOOR, IF SPACE IS AVAILABLE.
- CONTRACTOR SHALL INSTALL SIGN C3 OR C4 BASED ON THE TYPE OF BATTERY THAT IS BEING INSTALLED.

(C1)



(C2)



(C3)



(C4)

(C4)



(C5)



-N.O.C. STANDS FOR "NETWORK OPERATIONS CENTER"

-S.D.S. STANDS FOR "SAFETY DATA SHEET"

NOTES:

- CONTRACTOR SHALL INSTALL ALL SIGNS ON THE FRONT OF EACH CABINET. ALL SIGNS CAN BE PLACED ON ONLY THE UPPER DOOR, IF SPACE IS AVAILABLE.
- CONTRACTOR SHALL INSTALL SIGN C3 OR C4 BASED ON THE TYPE OF BATTERY THAT IS BEING INSTALLED.

(C1)



(C2)



(C3)



(C4)

(C4)



(C5)



-N.O.C. STANDS FOR "NETWORK OPERATIONS CENTER"

-S.D.S. STANDS FOR "SAFETY DATA SHEET"

NOTES:


- CONTRACT




TAG TOWERS LLC
108 FOREST COURT, SUITE 1
RICHMOND, KY 40475
859-544-5000 (PH)

LAB


49030 Portia Trail, Suite 100
Wixom, Michigan 48393
PHONE: (248) 705-9212

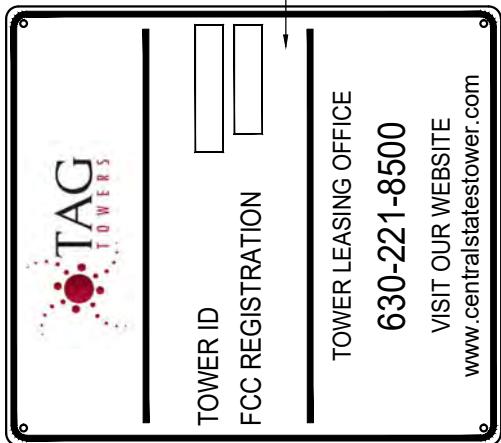WHITE BACKGROUND
w/BLACK LETTERINGMARKETING/ID SIGN 1

24" WIDE x 24" HIGH

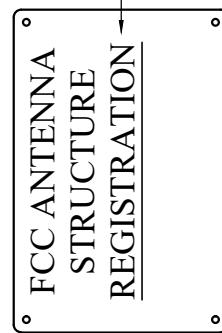WHITE BACKGROUND
w/BLACK LETTERINGFCC REGISTRATION SIGN 2

24" WIDE x 18" HIGH

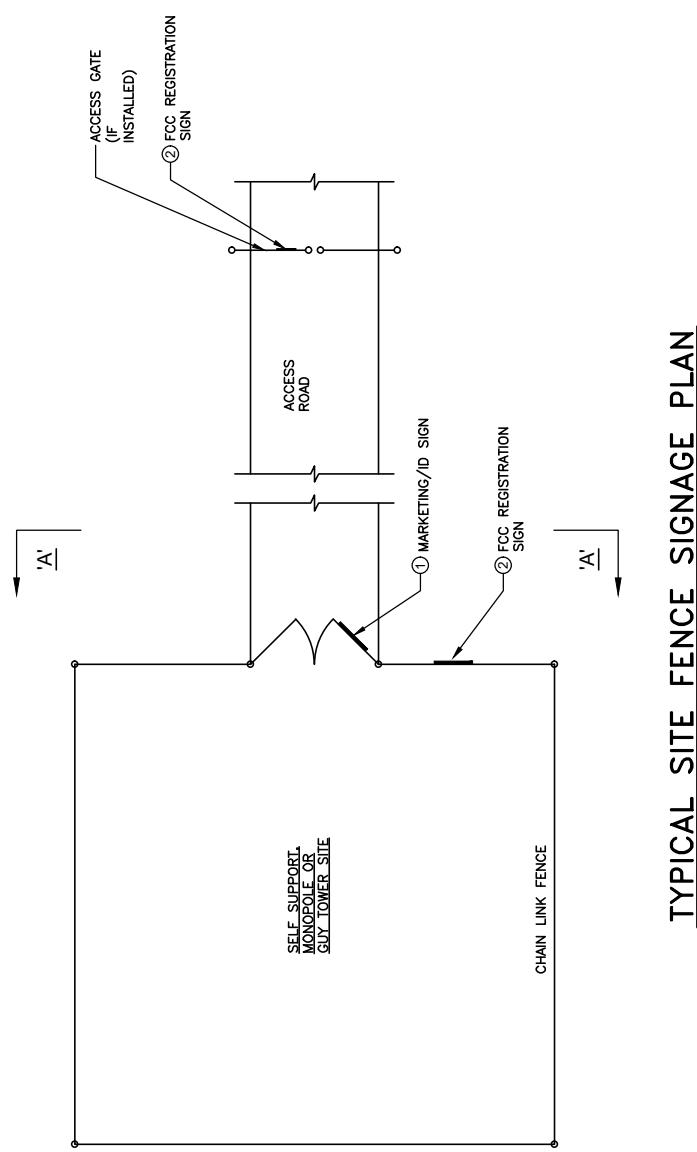
TYPICAL SITE FENCE SIGNAGE PLAN
SCALE: N. T. S.

SITE INFORMATION:
LV MT VERNON EAST
321 FROSTY HOLLOW ROAD
MT VERNON, KY 40456
ROCK CASTLE COUNTY

SITE NUMBER:
721772SITE NAME:
LV MT VERNON EAST

PID NUMBER: 16913443
DRAWN BY: RC
CHECKED BY: PL
DATE: 10/25/23

SHEET TITLE:
TOWER OWNER SITE FENCE SIGNAGE (REFERENCE ONLY)

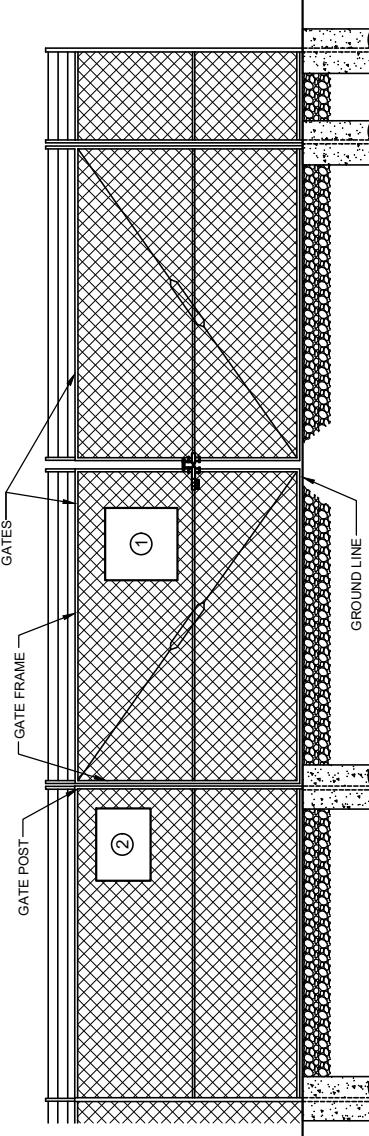SHEET NUMBER:
D — 5ELEVATION "A-A"
SCALE: N. T. S.



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859-544-5000 (PH)

STRUCTURAL NOTES

1. CANOPY SYSTEM DESIGN LOADINGS:

ROOF SNOW LOAD 70 PSF
DEAD LOADS ACTUAL MATERIAL WEIGHTS
BASIC WIND SPEED 120 MPH



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Wixom, Michigan 48393
PHONE: (248) 705-9212

DESIGN CODES	INTERNATIONAL BUILDING CODE (IBC) 2015
	MINIMUM DESIGN LOADS FOR BUILDINGS AND OTHER STRUCTURES ASCE7-10
	OSHA REGULATIONS
REV.	DATE
A	08/04/23
B	08/04/23
C	08/04/23
D	11/16/23
E	12/27/23
F	REvised FOR CONSTRUCTION
G	ISSUED FOR REVIEW
H	DESCRIPTION





SITE INFORMATION:
LV MT VERNON EAST
321 FROSTY HOLLOW ROAD
MT VERNON, KY 40456
ROCK CASTLE COUNTY

SITE NUMBER: 16913443
SITE NAME: 721772
DRAWN BY: RC
CHECKED BY: PL
DATE: 10/25/23

SHEET TITLE: EQUIPMENT PAD FOUNDATION PLAN, DETAILS AND STRUCTURAL NOTES
SHEET NUMBER: S-1

WK PAD & CANOPY REV 3 FINAL 10/16/23
Call before you dig.
1-800-752-6007
For Kentucky State Law, it is against the law to move or damage utility lines without first calling the Kentucky Utility Locating Service at least two working days before commencing work.

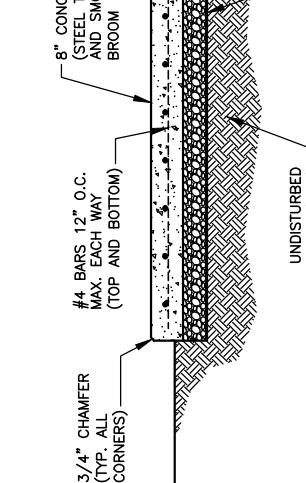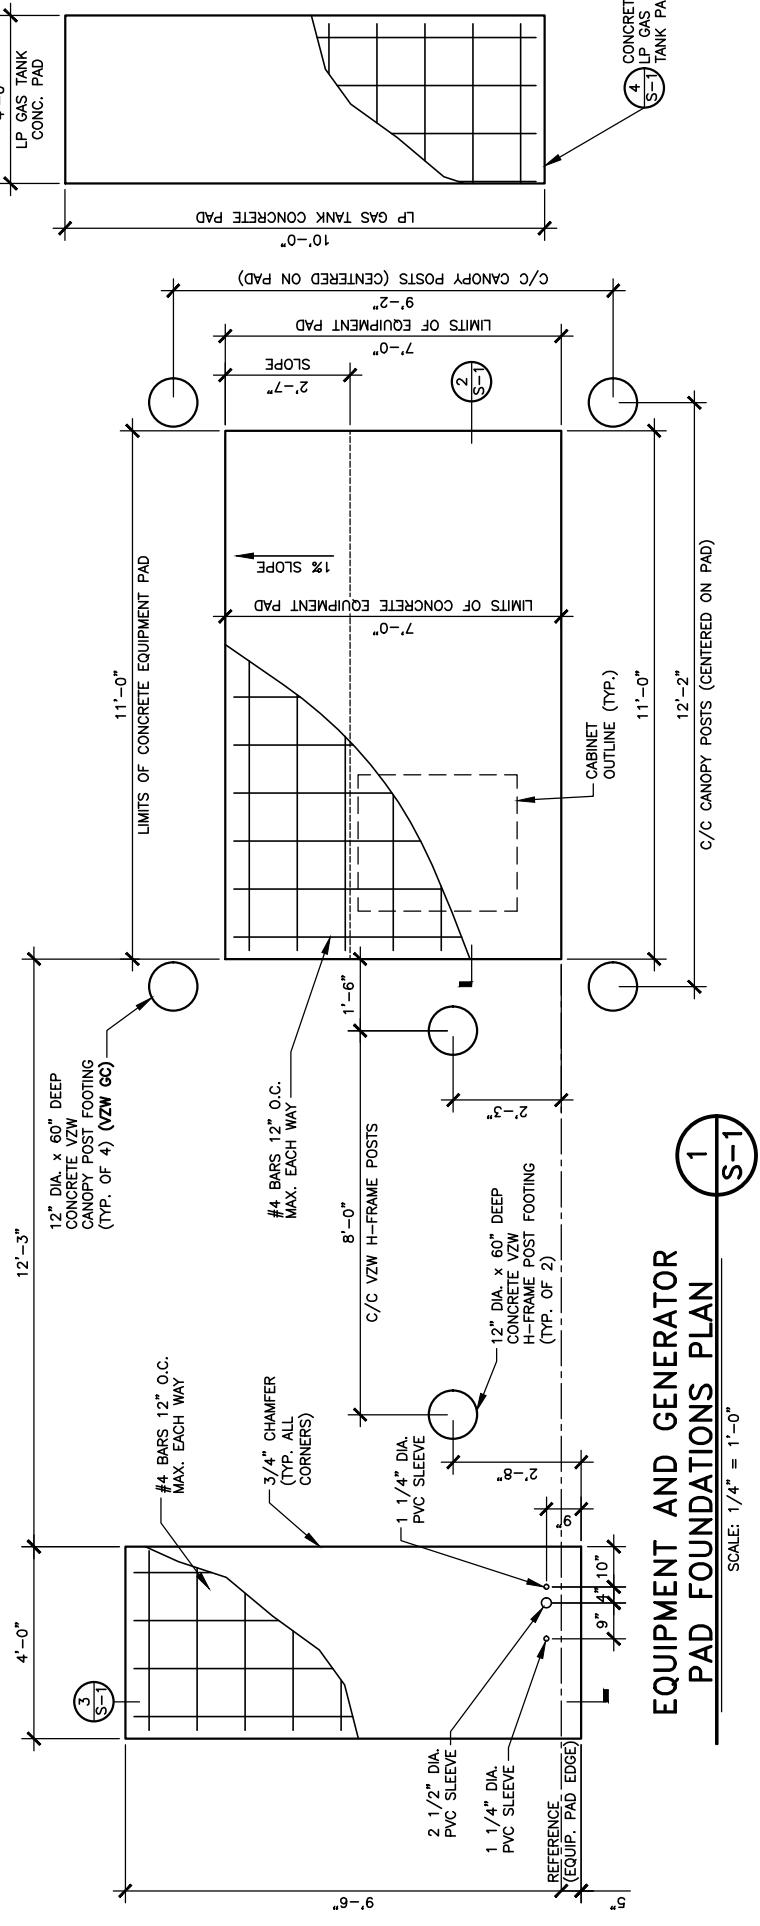


GENERATOR PAD FOUNDATION SECTION **S-1**

SCALE: 1/4" = 1'-0"

Dimensions and details shown in the diagram include:

- Foundation: 6" min. compacted granular base, 6 mil polyethylene vapor barrier, and 8" concrete slab (steel trowel, true, and smooth, light broom finish).
- Reinforcement: #4 bars 12" O.C. max. each way (top and bottom).
- Chamfer: 3/4" chamfer (typ. all corners).
- Earth: Undisturbed earth (typ.) and compound grade.

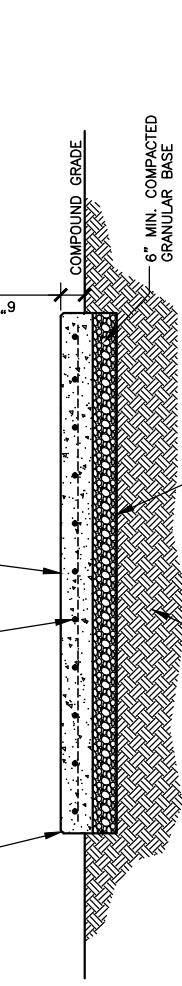


EQUIPMENT PAD FOUNDATION SECTION **S-1**

SCALE: 1/4" = 1'-0"

Dimensions and details shown in the diagram include:

- Foundation: 6" min. compacted granular base, 6 mil polyethylene vapor barrier, and 8" concrete slab (steel trowel, true, and smooth, light broom finish).
- Reinforcement: #4 bars 12" O.C. max. each way (top and bottom).
- Chamfer: 3/8" dia. Hilti-Z-R stainless steel anchor (N.Z.W. GC) (min. 3" embedment) - min. of 4 (verify with tank).
- Earth: Undisturbed earth (typ.) and compound grade.

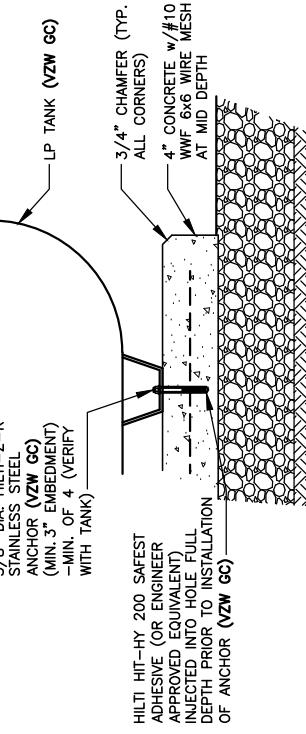

LP TANK PAD DETAIL **S-1**

SCALE: N.T.S.

Dimensions and details shown in the diagram include:

- Foundation: 3/8" dia. Hilti-HY 200 safest adhesive (or engineer approved equivalent) injected into hole full depth prior to installation of anchor (N.Z.W. GC).
- Anchor: 4" concrete w/ #10 WWF 6x6 wire mesh at mid depth.
- Chamfer: 3/4" chamfer (typ. all corners).


4
S-1



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Wixom, Michigan 48393
PHONE: (248) 705-9212



ICE BRIDGE SECTION **A** **S-2**
SCALE: 1/4" = 1'-0"

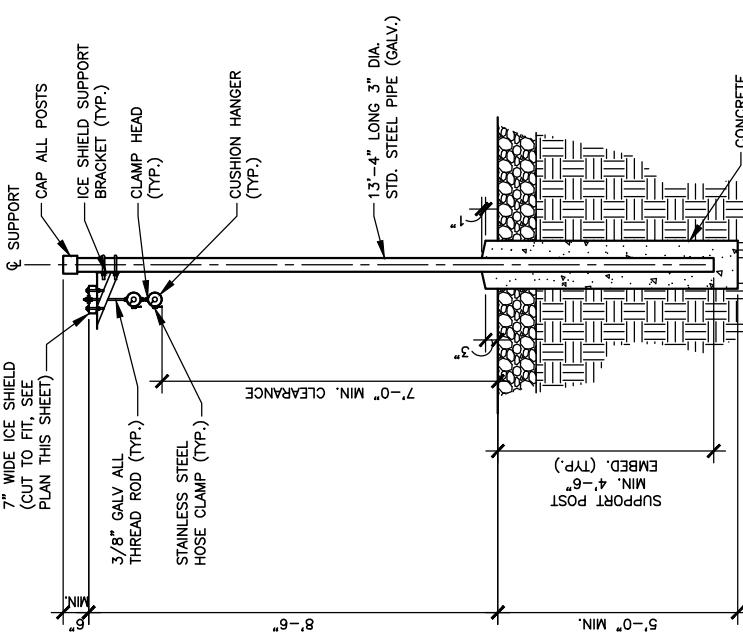


SITE INFORMATION:
LV MT VERNON EAST
321 FROSTY HOLLOW ROAD
MT VERNON, KY 40456
ROCK CASTLE COUNTY


SITE NUMBER:
721772
SITE NAME:
LV MT VERNON EAST
PID NUMBER: 16913443
DRAWN BY: RC
CHECKED BY: PL
DATE: 10/25/23
SHEET TITLE:

ICE BRIDGE PLAN AND DETAILS

SHEET NUMBER:
S - 2
Wk Pad & Canopy Rev 3 Final 10/16/23

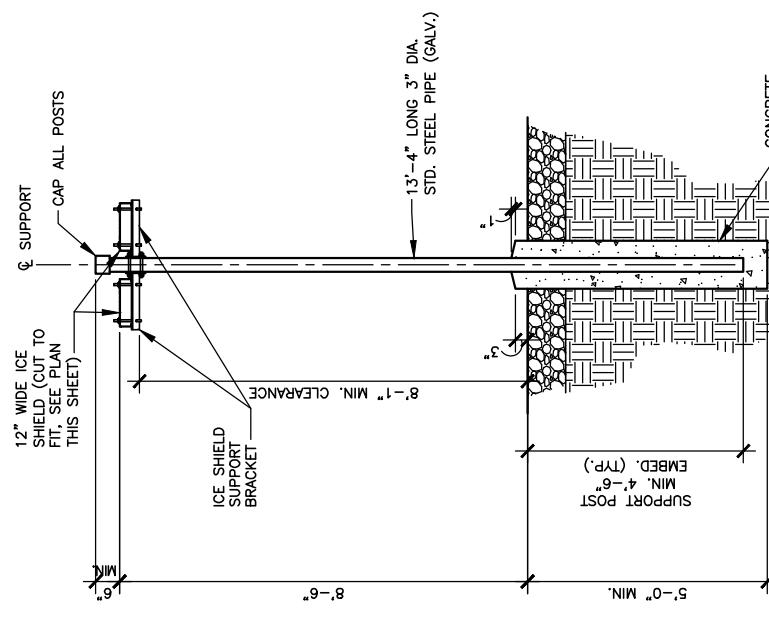

VZW H-FRAME CANOPY SECTION **B** **S-2**
SCALE: 1/4" = 1'-0"

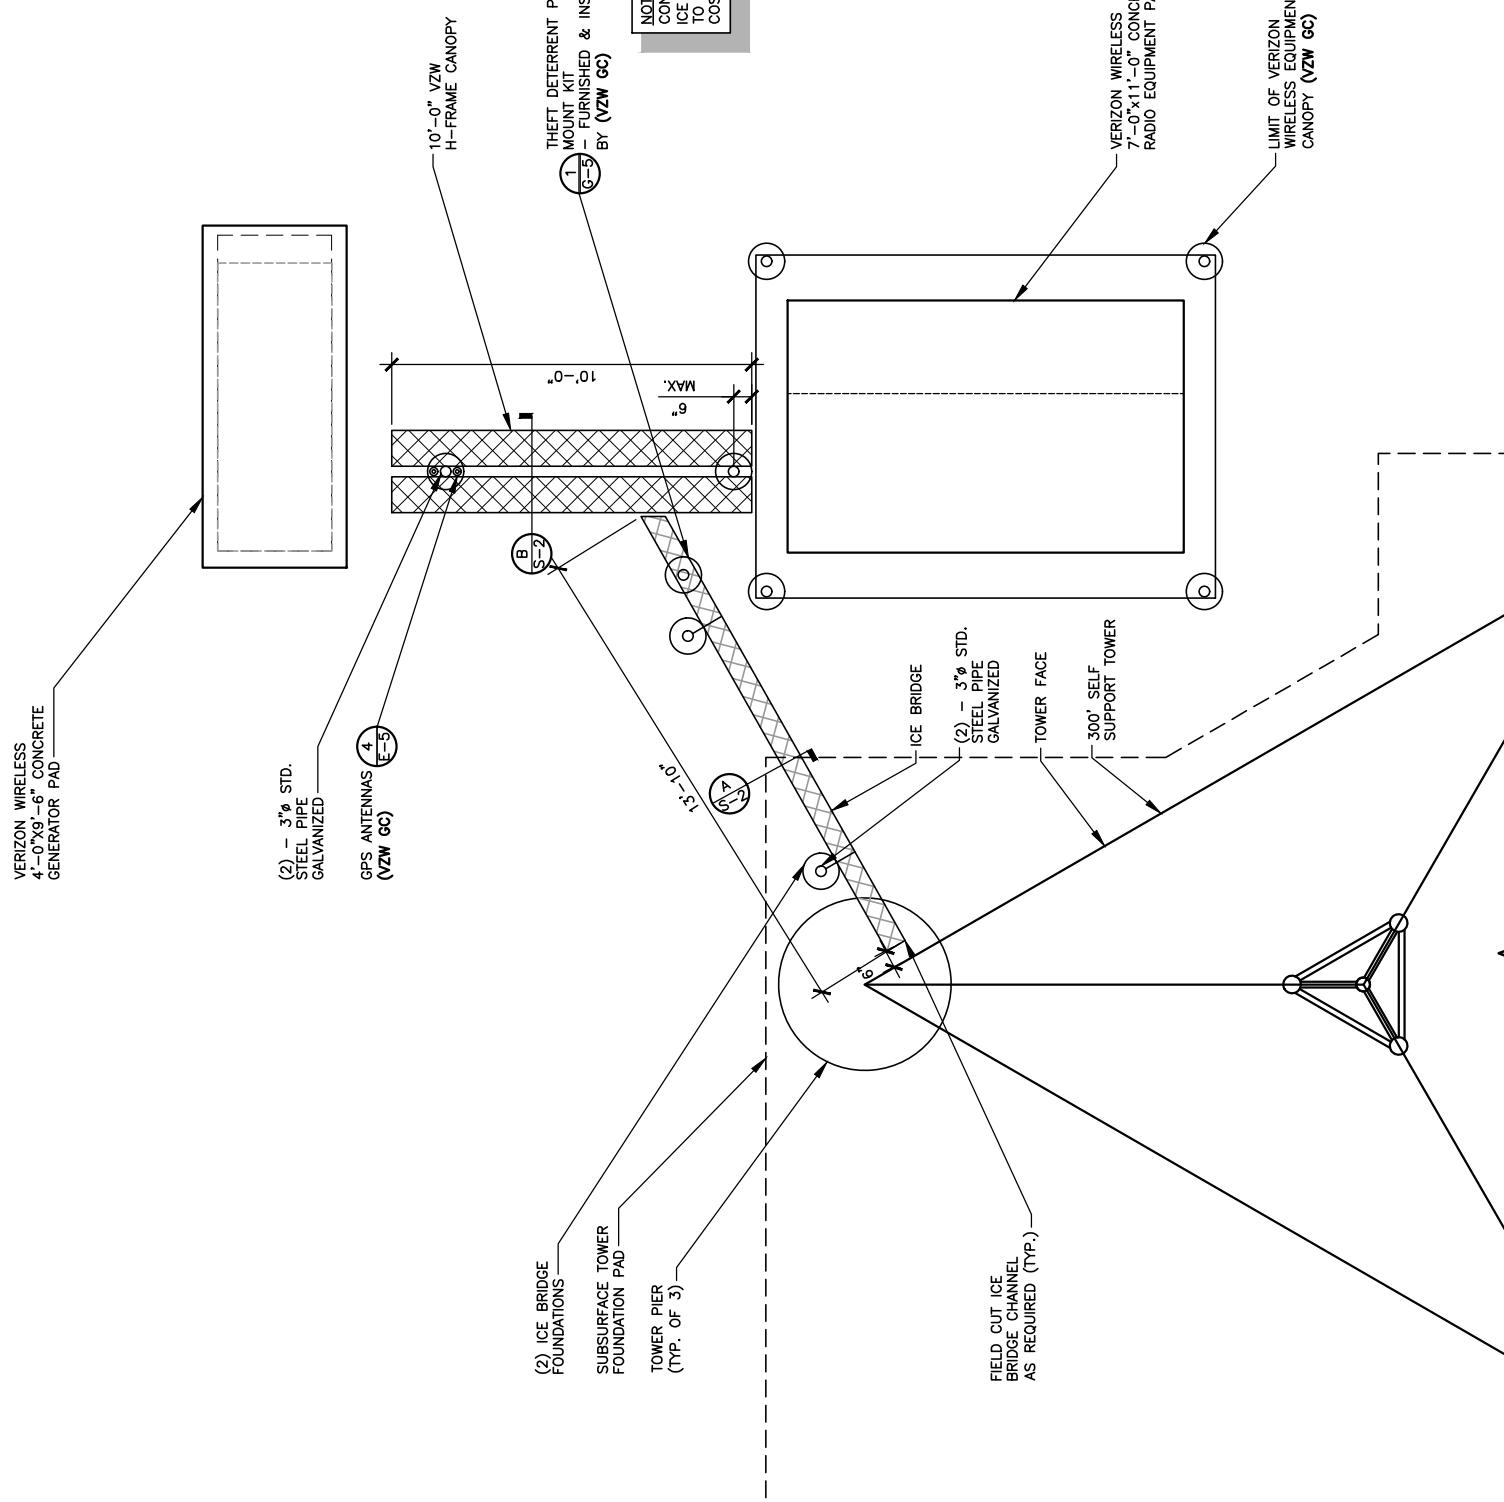

ICE BRIDGE PLAN
SCALE: 3/16" = 1'-0"



Know before you dig.
Call 800-752-6007
PER KENTUCKY STATE LAW IT IS AGAINST THE
LAW TO DIG ON PUBLIC PROPERTY WITHOUT THE
UNDERGROUND CONSTRUCTION SERVICE TWO (2)
WORKING DAYS BEFORE COMMENCING WORK.



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859-544-5000 (PH)

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Wixom, Michigan 48393
PHONE: (248) 705-9212




SITE INFORMATION:
LV MT VERNON EAST
321 FROSTY HOLLOW ROAD
MT VERNON, KY 40456
ROCK CASTLE COUNTY


SITE NUMBER:
721772
SITE NAME:
LV MT VERNON EAST
PID NUMBER: 16913443
DRAWN BY: RC
CHECKED BY: PL
DATE: 10/25/23
SHEET TITLE:

FOUNDATION PLAN
AND DETAILS
SHEET NUMBER:
S - 3


SHEET NUMBER:
S - 3
WIK PAD & CANOPY REV 3 FINAL 10/16/23

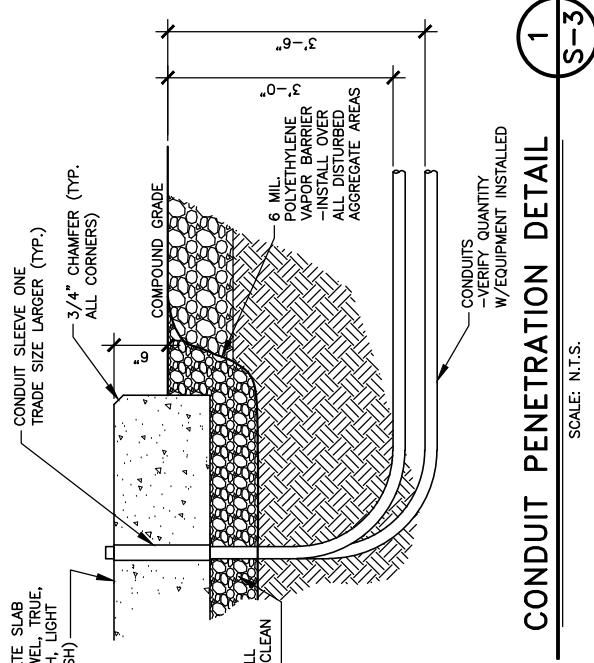


CONDUIT PENETRATION DETAIL
SCALE: N.T.S.
S-3

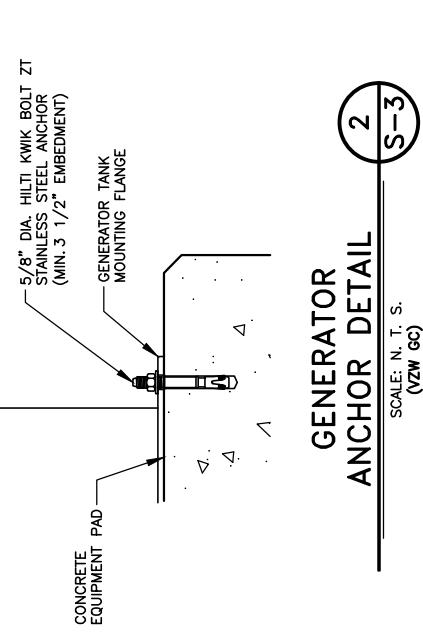

GENERATOR ANCHOR DETAIL
SCALE: N. T. S.
S-3

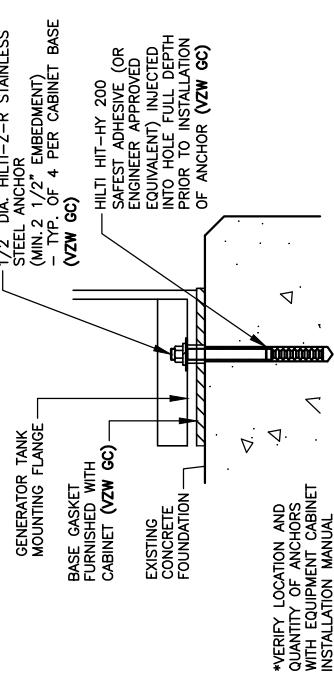

EQUIPMENT CABINET MOUNTING DETAIL
SCALE: N. T. S.
S-3

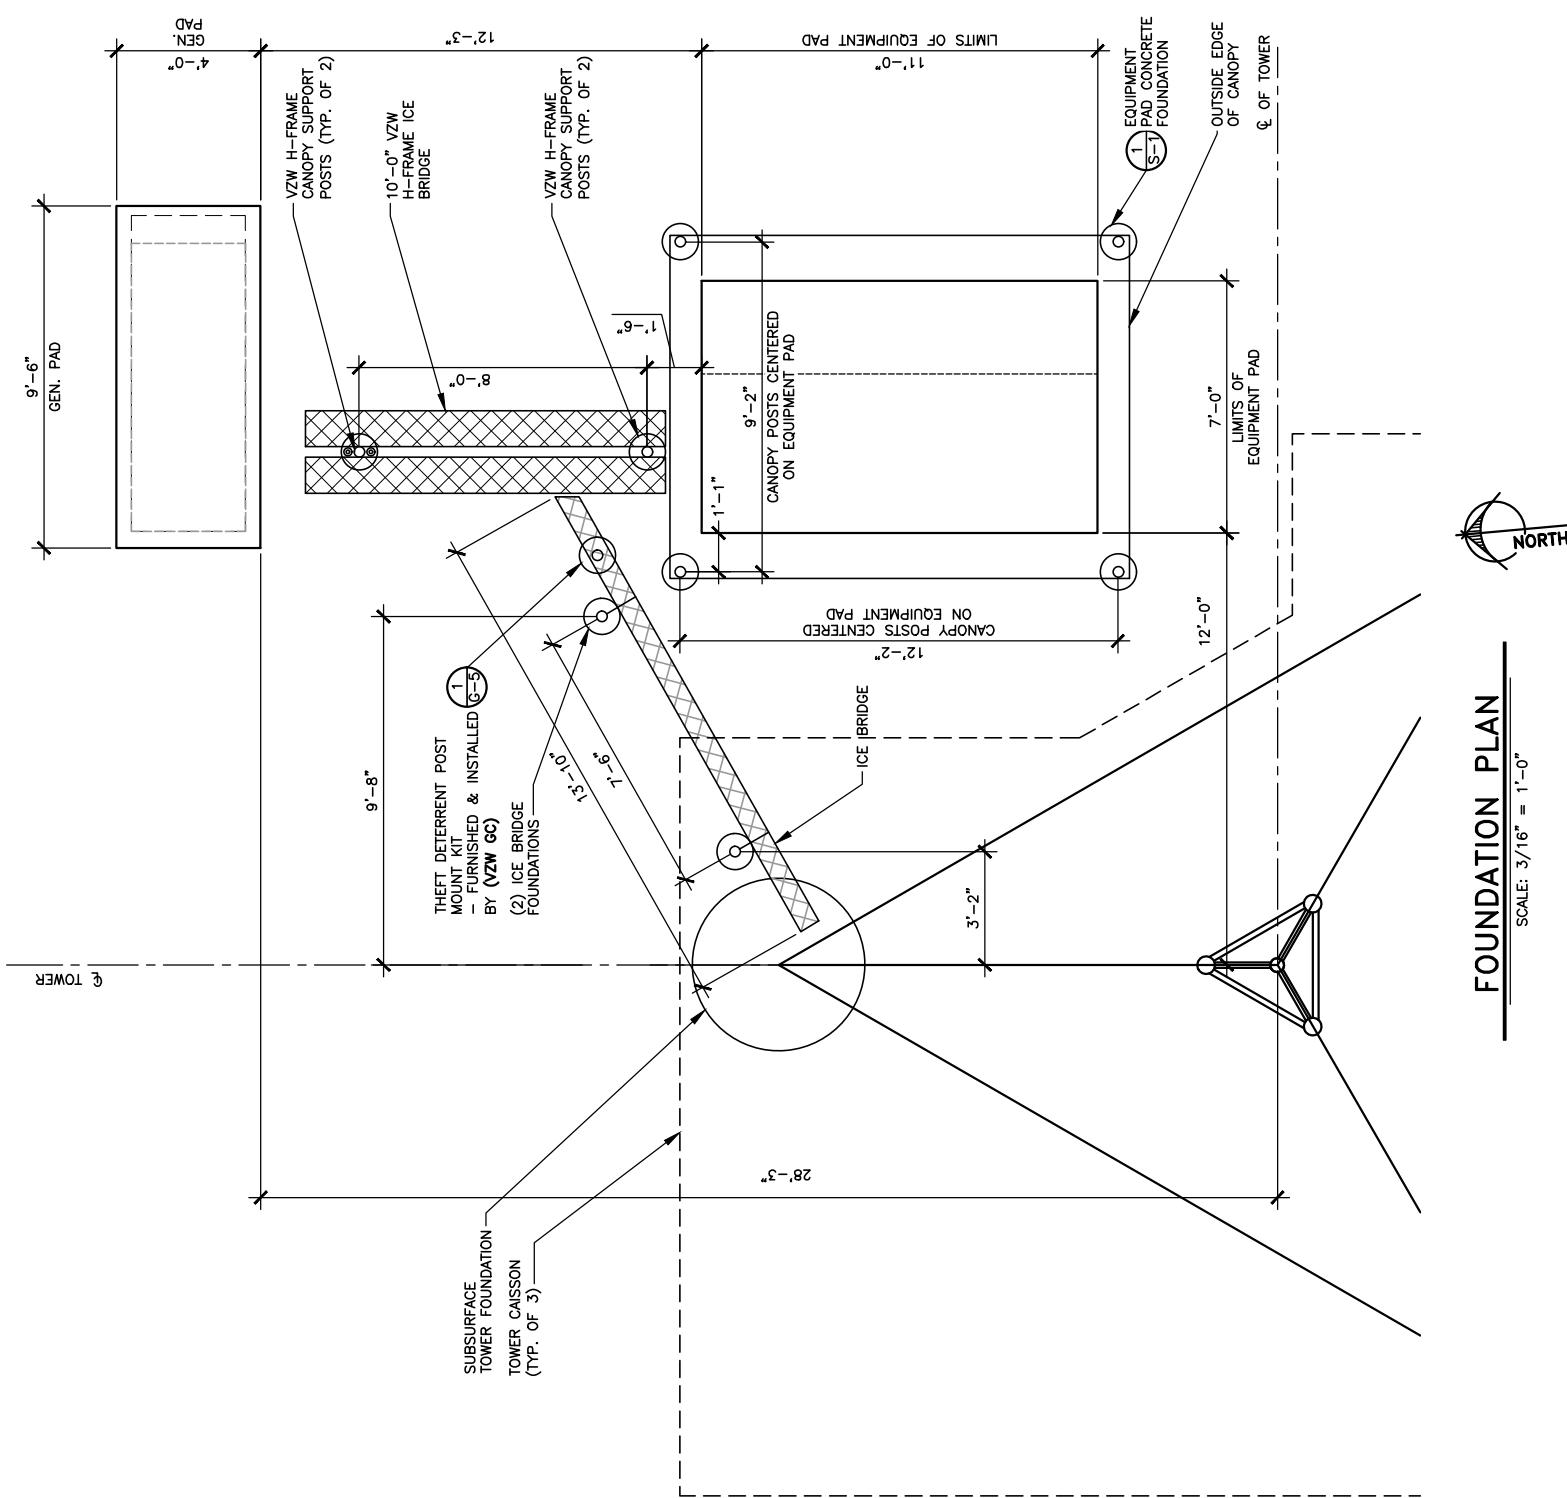

FOUNDATION PLAN
SCALE: 3/16" = 1'-0"



Know Before You Dig
Call before you dig - 7 am. to 6 pm.
1-800-752-6007
PER KENTUCKY STATE LAW, IT IS AGAINST THE
LAW TO DIG ON PUBLIC PROPERTY WITHOUT
UNDERGROUND LOCATION SERVICE TWO (2)
WORKING DAYS BEFORE COMMENCING WORK.



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LAB

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Wixom, Michigan 48393
PHONE: (248) 705-9212

- NOTE:**
1. IT IS THE INSTALLING CONTRACTOR'S RESPONSIBILITY TO VERIFY ALL ANTENNA INFORMATION AGAINST FINAL RADIO ENGINEERING PLAN PROVIDED BY RURAL CELLULAR CORP d/b/a VERIZON WIRELESS (VZW GC)
 2. ALL TOWER LIGHTING SHALL BE INSTALLED AS REQUIRED BY THE FEDERAL AVIATION ADMINISTRATION AND RECOMMENDED BY THE USFWS INTERIM GUIDELINES (2000) FOR LIGHTING OF TOWERS OVER 200' IN HEIGHT.

REPORT OF SOIL RESISTIVITY TESTING
PREPARED BY CIL ENGINEERING OF
OHIO, INC. ON 09/12/2023

REV.	DATE	DESCRIPTION
1	12/27/23	REVISED FOR CONSTRUCTION
0	11/16/23	ISSUED FOR REVIEW
B	08/04/23	ISSUED FOR REVIEW
A	08/04/23	ISSUED FOR REVIEW





SITE INFORMATION:
LV MT VERNON EAST
321 FROSTY HOLLOW ROAD
MT VERNON, KY 40456
ROCK CASTLE COUNTY


SITE NAME:
LV MT VERNON EAST
PID NUMBER: 16913443
DRAWN BY: RC
CHECKED BY: PL
DATE: 10/25/23
SHEET TITLE:

TOWER ELEVATION
SHEET NUMBER: **TE-1**
SCALE: N.T.S.
NORTH

VERIZON REV 3 FINAL 10/16/23

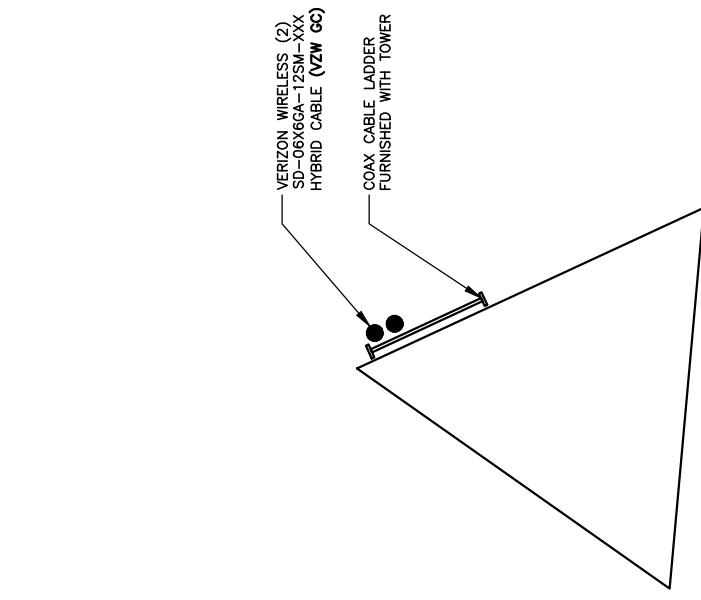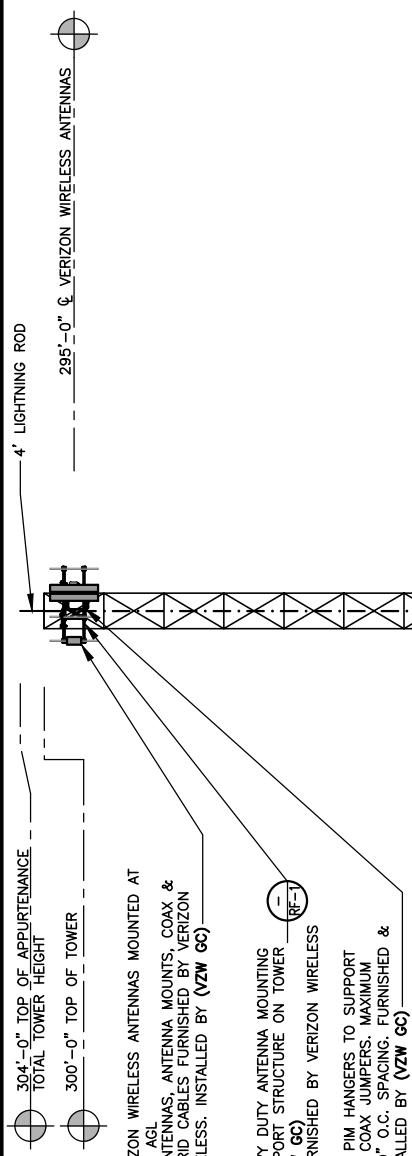

COAX PLAN
SCALE: N.T.S.

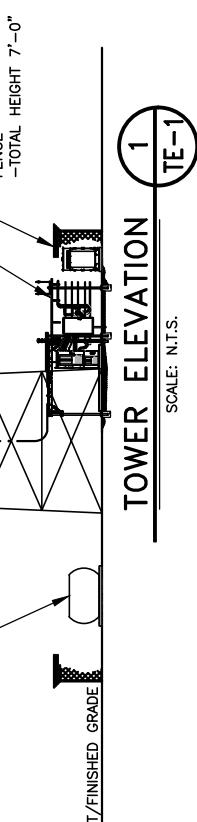

GENERAL ELECTRICAL NOTES




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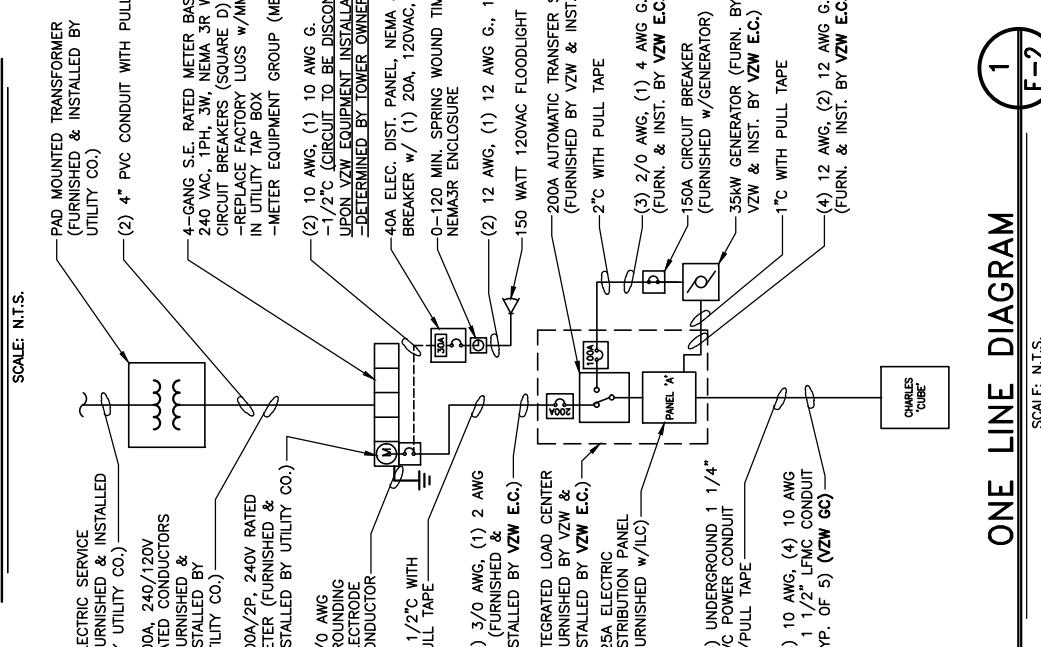
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Wixom, Michigan 48393
PHONE: (248) 705-9212

1. UNLESS NOTED AS VERIZON WIRELESS GENERAL CONTRACTOR OR VZW GC, ALL WORK ITEMS ON ELECTRICAL "E" & GROUNDING "G" SHEETS SHALL BE PERFORMED BY THE GENERAL CONTRACTOR'S ELECTRICAL CONTRACTOR. ALL WORK SHOWN AS NEW UNLESS NOTED EXISTING.
2. THE GENERAL CONTRACTOR AND VERIZON WIRELESS ELECTRICAL CONTRACTORS SHALL BE RESPONSIBLE FOR OBTAINING AN ELECTRICAL PERMIT FROM THE COUNTY.
3. UNDERGROUND CONDUIT SHALL BE SCH. 40 (SCH. 80 UNDER ROADWAY) PVC PLASTIC DUCT WITH ALL BENDS MINIMUM 24" RADIUS 90° SWEEP SCH. 80 U-BOLT OR UNISTRUT PIPE CLAMP (TYP) DRILL HOLES AS REQ'D
4. ABOVE GRADE RISER CONDUIT SHALL BE RIGID SCH. 80 PVC WITH MATCHING FITTINGS UNLESS NOTED OTHERWISE.
5. ALL CONDUITS SHALL BE PLACED WITH 200 LB POLYETHYLENE PULL TAPES. PULL TAPES SHALL BE SECURELY FASTENED AT EACH END OF CONDUIT. (THIS SHALL ALSO APPLY FOR ALL FIBER CONDUITS).
6. PRIOR TO TRENCHING AND FOR COORDINATING OF THE FIBER AND ELECTRICAL SERVICES, SEE SHEET C-6 GENERAL NOTE #6 FOR UTILITY CONTACT NAMES & PHONE NUMBERS TO ALSO INCLUDE VERIZON WIRELESS CONSTRUCTION MANAGER. STANDARDS AND ALL LOCAL CODES.
7. ALL WORK SHALL BE IN ACCORDANCE WITH N.F.P.A. AND N.E.C. CODES, NEMA STANDARDS.
8. ALL WIRE SHALL BE COPPER, 600V THHN-2/THHN-2 OR XHHW-2/90°C UNLESS NOTED OTHERWISE.
9. ALL ELECTRICAL CONTRACTORS SHALL ABIDE BY ALL GUIDELINES REQUIRED BY TOWER OWNER AND VERIZON WIRELESS, INCLUDING BUT NOT LIMITED TO, a) STAGE CONSTRUCTION AND REPORT WHEN ON AND OFF THE SITE, b) PROVIDE LOG BOOK RECORDS OF PERSONNEL ON TOWER, c) PROVIDE R.F. MONITORING DEVICES TO TOWER PERSONNEL, d) VERIZON WIRELESS TO INSPECT ALL TRENCHING BEFORE BACKFILLING.
10. THE ELECTRICAL CONTRACTOR SHALL INSTALL ALL UNDERGROUND CONDUITS SHOWN ON PLANS UNLESS NOTED OTHERWISE. ALL UNDERGROUND CONDUIT SHALL BE STUBBED-UP AND CAPPED AT THE LOCATION INDICATED ON PLANS. VZW CONTRACTOR SHALL COMPLETE ALL CONDUIT TERMINATIONS TO VZW ENCLOSURES SHOWN ON PLANS AND ELECTRICAL PROVIDER DESIGN.
11. THE VZW ELECTRICAL CONTRACTOR SHALL VERIFY ELECTRICAL SERVICE REQUIRED - 120/240V, SINGLE PHASE, 200 AMP BEFORE ROUGH IN.
12. GENERAL CONTRACTOR AND VZW ELECTRICAL CONTRACTORS SHALL PROVIDE FIRE WATCH DURING ALL WELDING OPERATIONS. TWO (2) HAND HELD 30 LB. FIRE EXTINGUISHERS & ADEQUATE WATER SUPPLY SHALL BE APPROVED BY THE CLIENT AND THE TOWNSHIP WATER AUTHORITY.
13. SEAL ALL PENETRATIONS WITH SILICONE SEALANT.
14. ELECTRICAL WORK PRESENTS SPECIFIC THREATS TO THE HEALTH AND SAFETY OF WORKERS IN SITE. SPECIFICALLY ELECTROSHOCK ARE THE FOUR LEADING CAUSES OF DEATH ON CONSTRUCTION SITES. ALL ELECTRICAL WORKERS SHALL HAVE CURRENT CERTIFICATIONS WHICH SATISFY ALL TRAINING REQUIREMENTS FOR THE ELECTRICAL WORK THEY ARE PERFORMING PER OSHA STANDARDS. ALL ELECTRICAL WORKERS SHALL ADHERE TO ALL SAFETY RULES AND REGULATIONS FOR WORKER AND PUBLIC SAFETY. ALL WORK SHALL BE PERFORMED BY QUALIFIED ELECTRICIANS TRAINED FOR THE TYPE OF WORK AND THE VoltAGES PRESENT FOR EACH TASK. THE CONTRACTOR SHALL REVIEW ALL LANDOWNER, PRIME CONTRACTOR, CARRIER, OSHA, NFPA 70E, AND LOCAL SAFETY GUIDELINES AND AT ALL TIMES SHALL CONFORM TO THE MOST RESTRICTIVE OF THESE STANDARDS TO ENSURE A SAFE WORKPLACE.
15. CONNECT NEUTRAL TERMINAL IN SERVICE DISCONNECTING DEVICE TO GROUNDING ELECTRODE (2/0 AWG TINNED STRANDED COPPER GROUNDING ELECTRODE CONDUCTOR IN 1" PVC CONDUIT). CONNECT FIRST GROUNDING ELECTRODE TO SECOND GROUNDING ELECTRODE WITH 2/0 AWG TINNED STRANDED COPPER CONDUCTOR EXOTHERMICALLY WELDED TO ELECTRODES.
16. VZW E.C. SHALL VERIFY SUFFICIENT CAPACITY EXISTS AT EXISTING METER CENTER. NOTIFY ENGINEER IMMEDIATELY IF SERVICE IS NOT ADEQUATE.
17. REFER TO ELECTRICAL SITE PLAN FOR CONDUIT AND WIRE REQUIREMENTS.
18. ALL ELECTRICAL EQUIPMENT PLACARDS MUST BE ENGRAVED PLASTIC LABELS ONLY. NO P-TOUCH LABELS ARE TO BE USED. PLACARDS SHALL BE 1 1/2" x 5" IN SIZE AND PERMANENTLY AFFIXED TO THE ENCLOSURES EASILY VISIBLE LOCATIONS.
19. VZW WIRELESS ELECTRICAL PLACARD REQUIREMENTS:
 - a) AVAILABLE FAULT CURRENT RATING FROM UTILITY PROVIDER WITH DATE.
 - b) VZW WIRELESS SERVICE DISCONNECT AT METER BASE.
 - c) VZW MAIN BREAKER AT INTEGRATED LOAD CENTER ILC.
 - d) GENERATOR NEUTRAL CONDUCTOR BONDED TO SERVICE GROUNDING ELECTRODE IN THIS ENCLOSURE AT METER CENTER AND AUTOMATIC TRANSFER SWITCH "ATS" NEUTRAL BAR.
 - e) VZW WIRELESS GENERATOR ACCESS PROPERTY OF VERIZON WIRELESS' AT ALL VZEW WIRELESS FIBER OPTIC SITES.
20. ALL EQUIPMENT SHALL BE GROUNDED PER LATEST EDITION OF NEC AND AS INDICATED ON GROUNDING PLAN.
21. ELECTRICAL EQUIPMENT SHALL BE MIN. 3'-0" FROM ANY STRUCTURE AND AS REQUIRED BY LOCAL UTILITY COMPANIES.
22. 2 AWG BARE SOLID TINNED COPPER WIRE LEADS FROM NEW H-FRAME STRUCTURE TO BE BONDED TO EXISTING GROUNDING SYSTEM (TYP) 2 AWG TO HAND HOLES FASTENED TO INSIDE WALL OF HAND HOLE.
23. ALL METALLIC CABINETS & ENCLOSURES MUST BE GROUNDED WITH 2 AWG TO GROUND RING.
24. ALL ABOVE GRADE GROUND VZW CONNECTIONS SHALL BE IN 1/2" FLEXIBLE PVC CONDUIT w/ANTI-THEFT COMPOUND. ALL OTHER LEADS SHALL BE IN 1/2" PVC CONDUIT.
25. ALL HARDWARE USED MUST BE GALVANIZED OR STAINLESS STEEL, NO ZINC OR OTHER MATERIAL IS TO BE USED.
26. VZW WIRELESS FURNISH & INSTALL ALL INNER CONNECTING CONDUITS BETWEEN CABINETS AND LAND ALL AC POWER TO VZW EQUIPMENT.
27. ALL CONDUIT RUNS SHALL HAVE A CONTINUOUS SLOPE DOWNWARD AND AWAY FROM THE METERBOARD SO THAT WATER WILL NOT FLOW FROM THE EQUIPMENT. TRENCHES SHALL BE EXCAVATED ALONG STRAIGHT LINES BEFORE CONDUIT ARE INSTALLED SO THE ELEVATION CAN BE ADJUSTED, IF NECESSARY, TO AVOID UNSEEN OBSTACLES.
28. PRIOR TO THE SUBMISSION OF BIDS, THE GENERAL CONTRACTOR AND HIS SUBCONTRACTORS SHALL VERIFY ALL DETAILS AND SCHEDULES ON THE DRAWINGS AND SPECIFICATIONS PROVIDED BY THE OWNER, FOR MEANING OF ABBREVIATIONS AND ADDITIONAL REQUIREMENTS AND INFORMATION, CHECK STRUCTURAL AND OTHER MECHANICAL AND ELECTRICAL DRAWINGS FOR SCALE, SPACE LIMITATIONS, DOOR SWINGS, ADJACENT CARRIER EQUIPMENT COORDINATION AND ADDITIONAL INFORMATION, ETC. REPORT ANY DISCREPANCIES, CONFLICTS, ETC. TO THE OWNER BEFORE SUBMITTING BIDS.







SURFACE MOUNTED NEMA 3R w/DOOR
22K AIC BREAKERS
(E.C. SHALL VERIFY AIC RATINGS w/LOCAL POWER CO.)

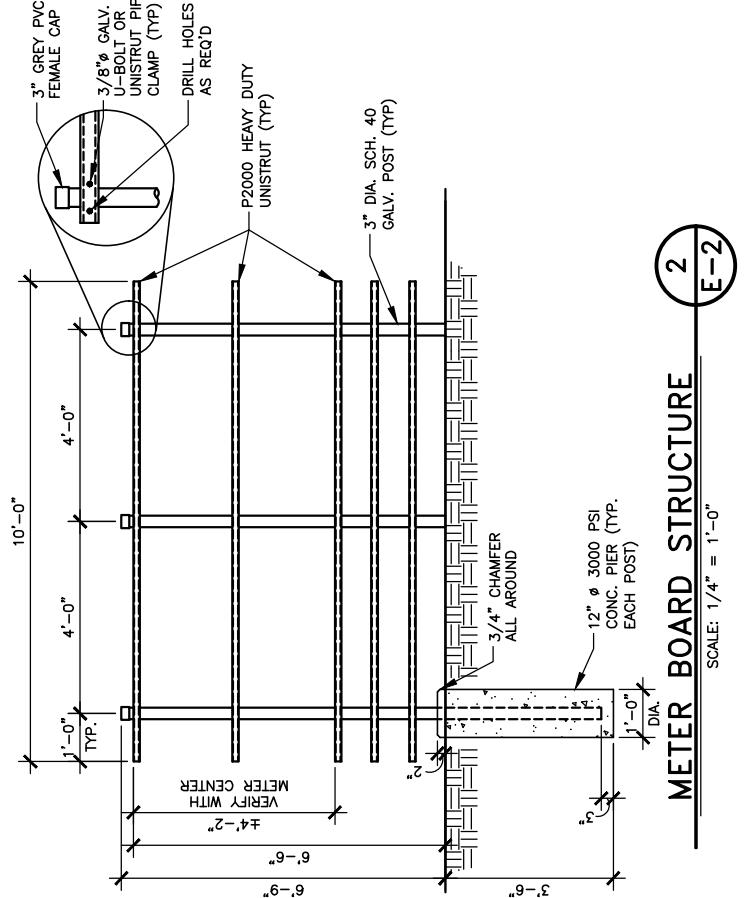PANEL SCHEDULE "A"



NON-CONTINUOUS LOAD = 0.00 KW, 00.00 AMPS
CONTINUOUS LOAD = 31.04 KW x 1.25 = 38.80 KW, 161.67 AMPS
TOTAL CONNECTED LOAD = 38.80 KW, 161.67 AMPS
(SEE NOTE 1)

PANEL SCHEDULE "A"

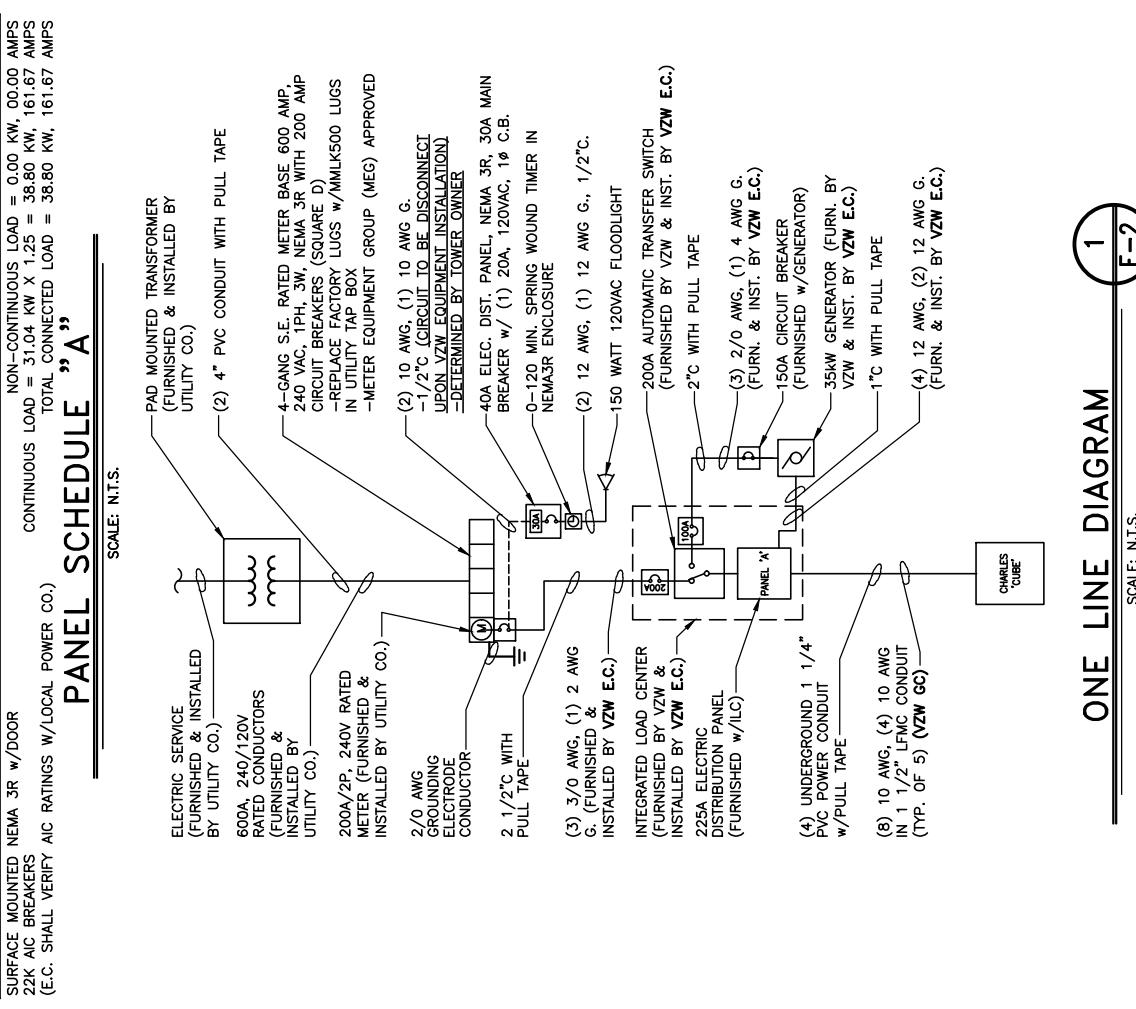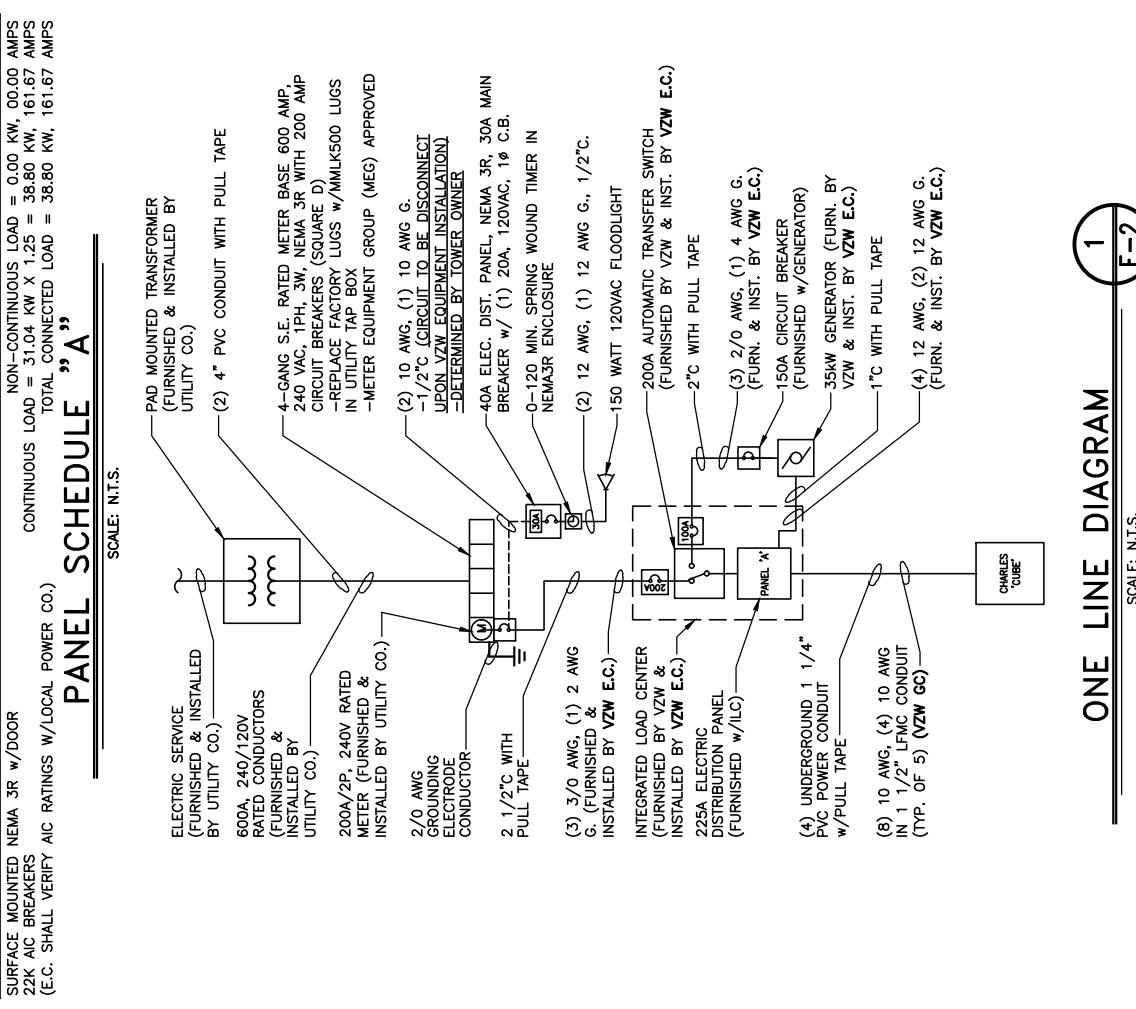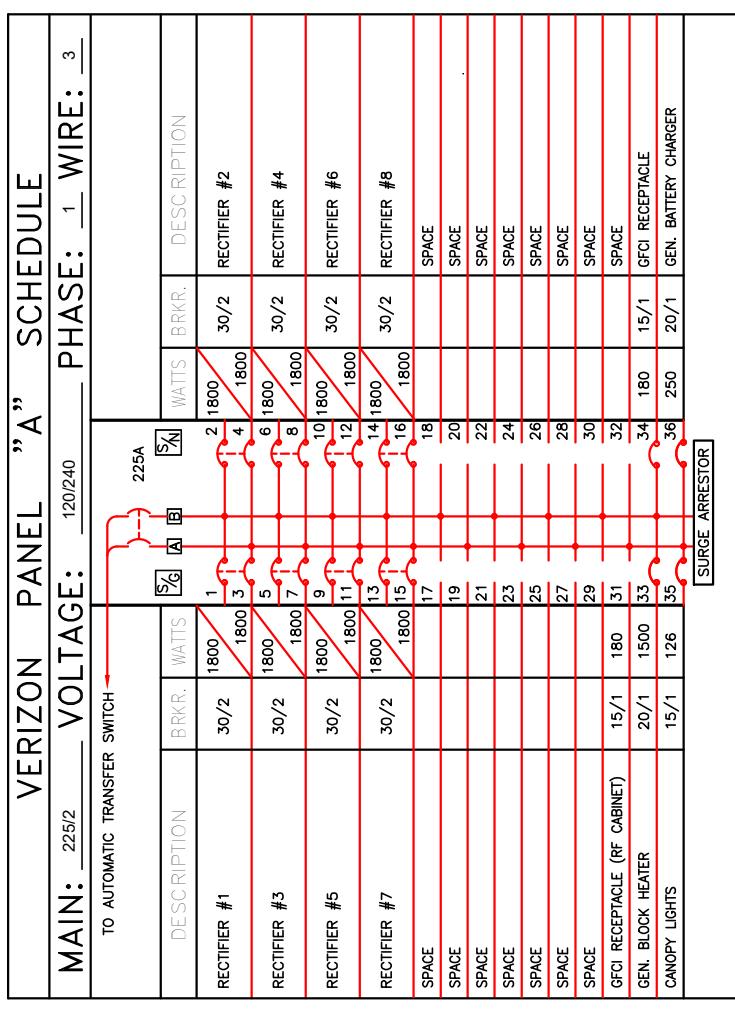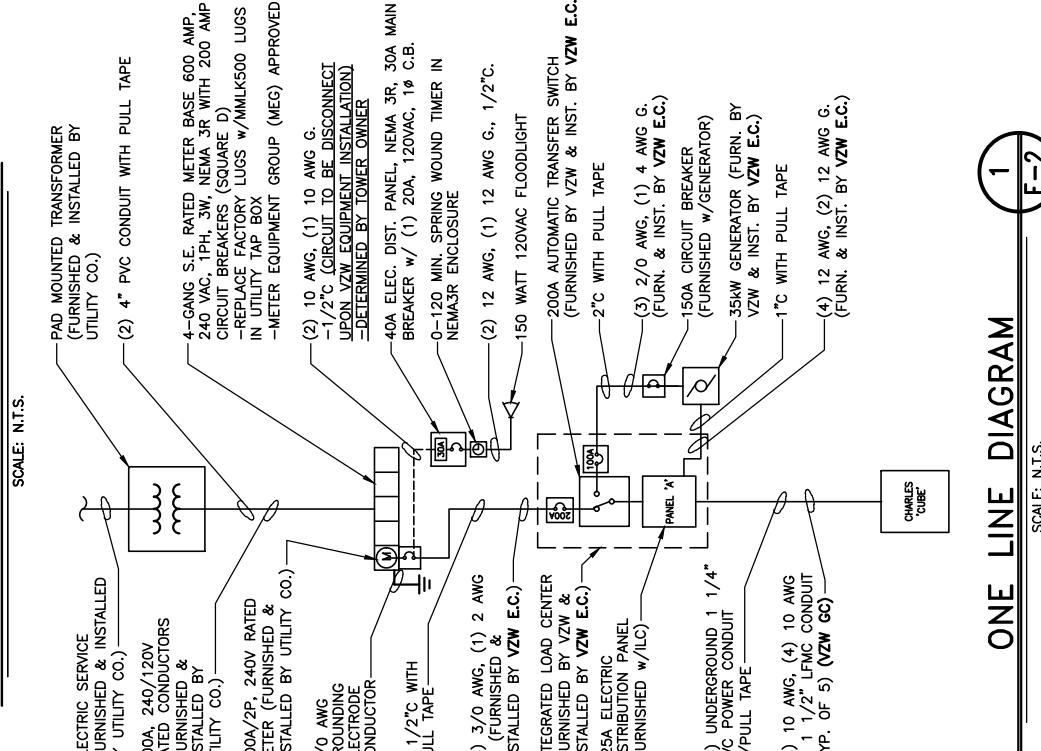



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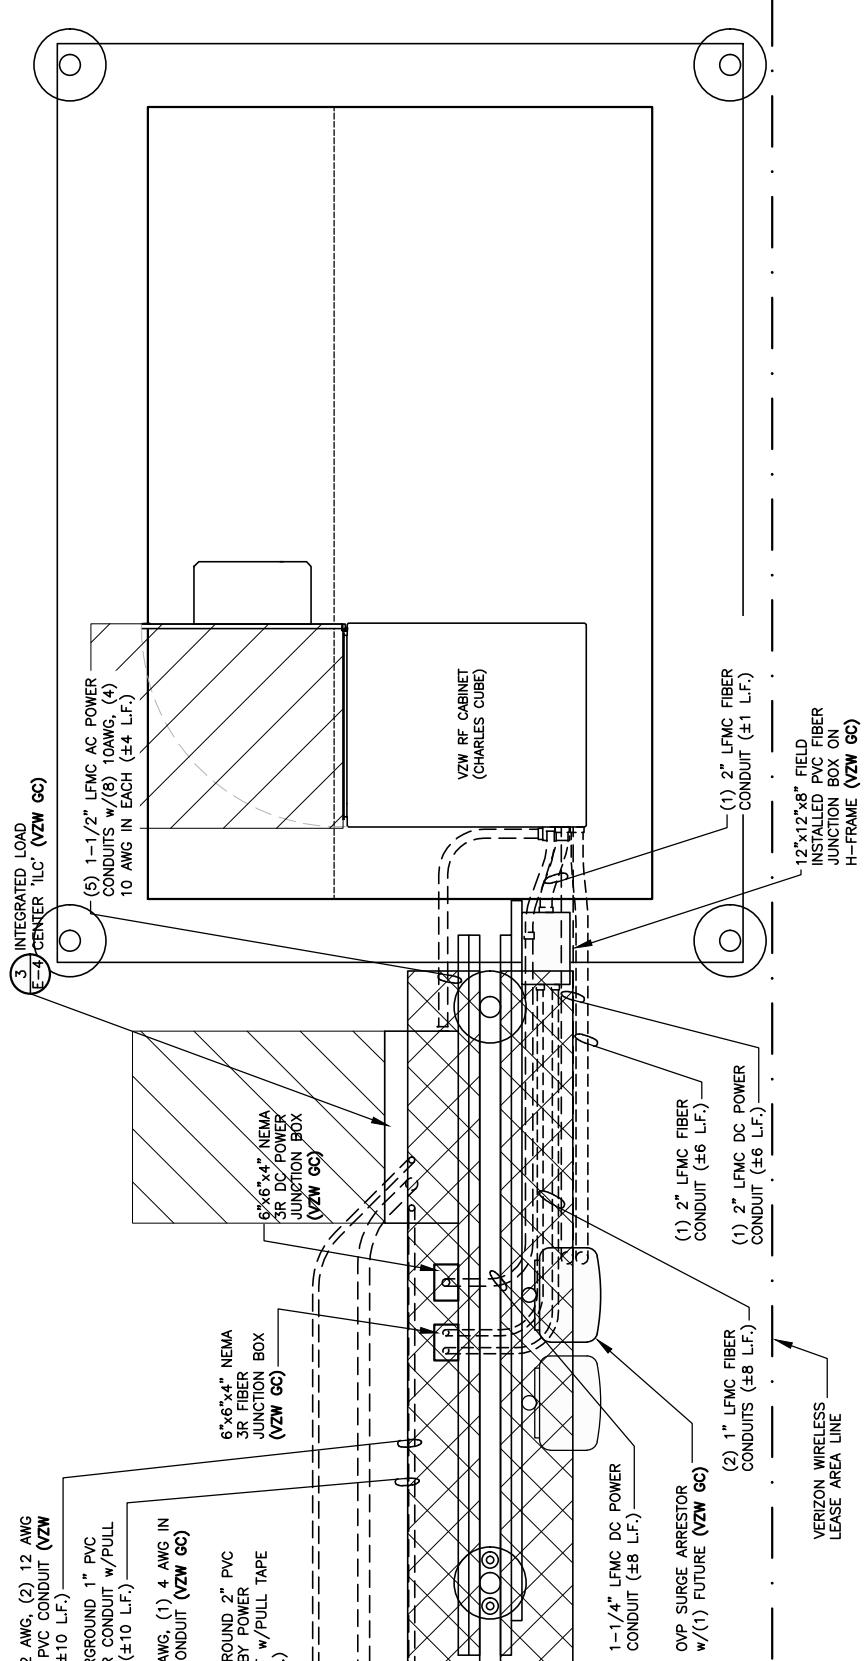
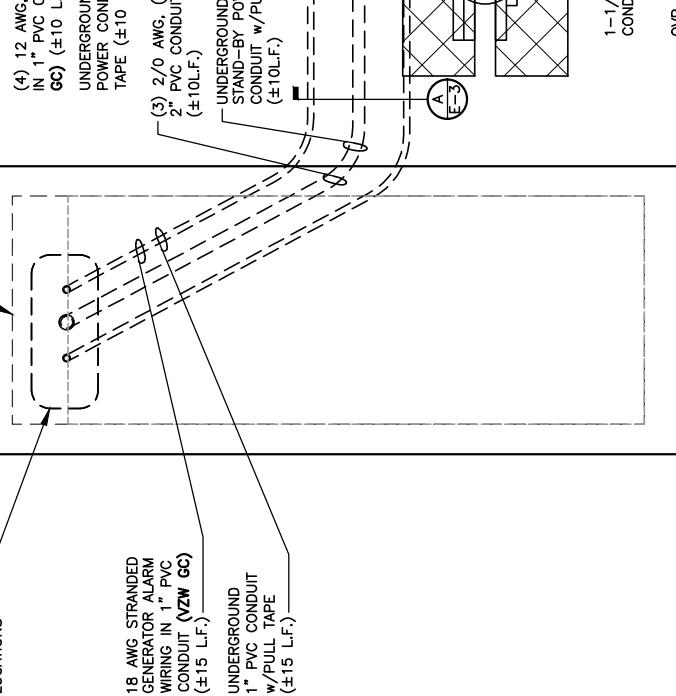
LAB

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PHONE: (248) 705-9212

NOTE:
ALL GENERATOR CONDUITS SHALL BE
INSTALLED AND CAPPED WEATHERTIGHT
FOR FUTURE GENERATOR INSTALLATION
IF REQUIRED

YZW 35kW PROPANE
GENERATOR OUTLINE


SEE SHEET S-1
FOR CONDUIT
LOCATIONS



SITE INFORMATION:
LV MT VERNON EAST
321 FROSTY HOLLOW ROAD
MT VERNON, KY 40456
ROCK CASTLE COUNTY

SITE NUMBER: 721772
SITE NAME: LV MT VERNON EAST
PID NUMBER: 16913443
DRAWN BY: RC
CHECKED BY: PL
DATE: 10/25/23

**RF CABINET FEEDER
TRENCH SECTION DETAIL**
A
E-3
SCALE: N.T.S.

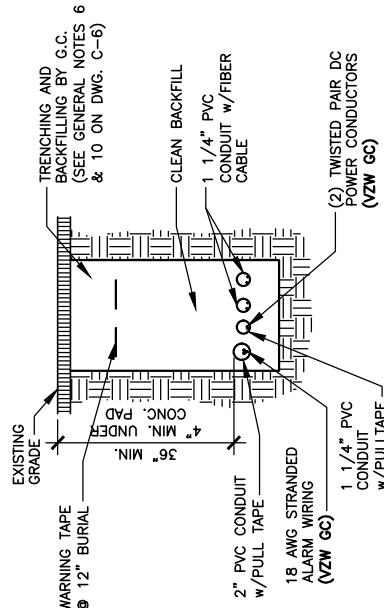

EQUIPMENT PAD UTILITY PLAN
SCALE: 3/8" = 1'-0"

- ELECTRICAL NOTES:**
1. PROVIDE 6' 0" MAX. LIQUIDTIGHT FLEXIBLE METAL CONDUIT AT ALL EQUIPMENT CONNECTIONS.
 2. ALL CONDUIT SHALL BE ROUTED WITHIN 2'-0" OF PERIMETER COMPOUND FENCE WHERE APPROPRIATE.
 3. CONDUIT TRENCH WIDTH SHALL NOT EXCEED 18" AT ALL ACCESS DRIVE LOCATIONS AND WHEN CROSSING THE COMPOUND GATE OPENING.
 4. ALL CONDUIT RACEWAYS BETWEEN CABINETS ABOVE CONCRETE PAD SHALL BE 2" DIAMETER SCH40 PVC WITH WEATHERPROOF FITTINGS.
 5. ALL GENERATOR CONDUITS SHALL BE INSTALLED REGARDLESS OF INITIAL GENERATOR INSTALLATION.


SHEET TITLE:
**EQUIPMENT PAD
UTILITY PLAN &
EQUIPMENT PAD
TRENCH SECTIONS**
SHEET NUMBER:
E — 3
WIK PAD & CANOPY REV 3 FINAL 10/16/23



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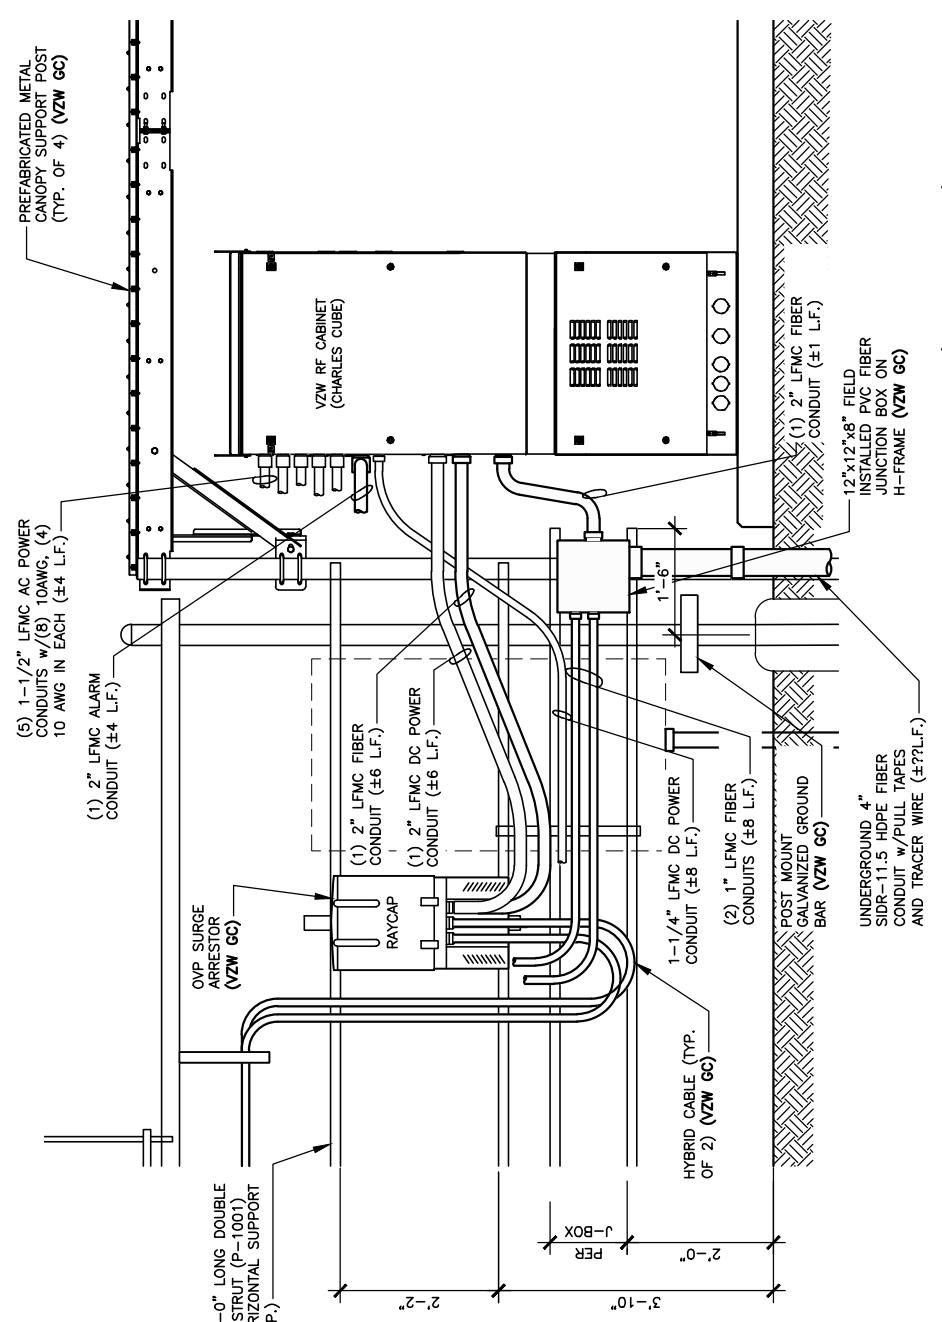
ENLARGED OVP H-FRAME ELEVATION (LIT FIBER DEMARC)




SITE INFORMATION:
LV MT VERNON EAST
321 FROSTY HOLLOW ROAD
MT VERNON, KY 40456
ROCK CASTLE COUNTY

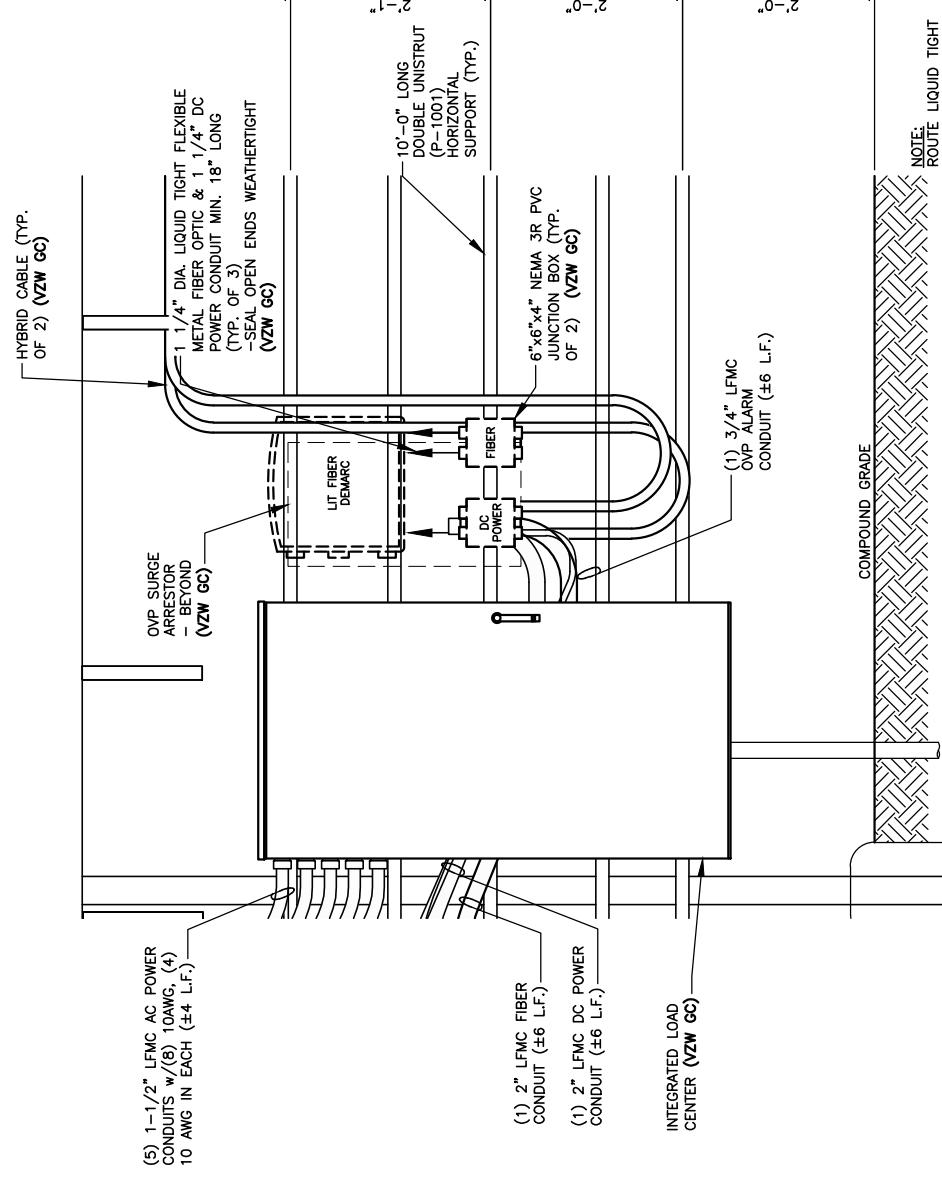SITE NUMBER: 721772
SITE NAME: LV MT VERNON EAST
PID NUMBER: 16913443
DRAWN BY: RC
CHECKED BY: PL
DATE: 10/25/23

SHEET TITLE: OVP & INTEGRATED LOAD CENTER H-FRAME ELEVATIONS AND DETAILS
SHEET NUMBER: E-4



OUTDOOR OVP EQUIPMENT ELEVATION (OVP SIDE) — REAR

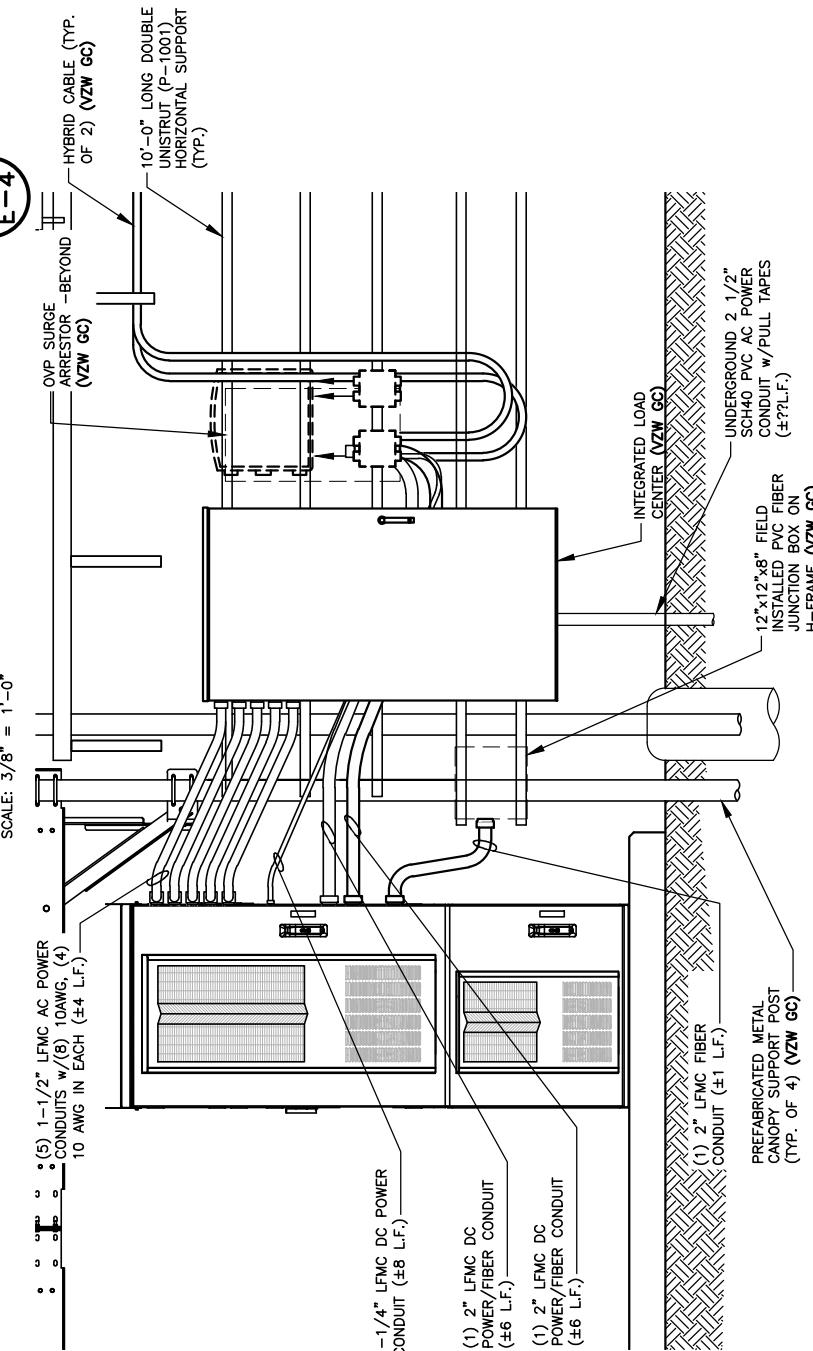



OUTDOOR OVP EQUIPMENT ELEVATION (ILC SIDE) — FRONT



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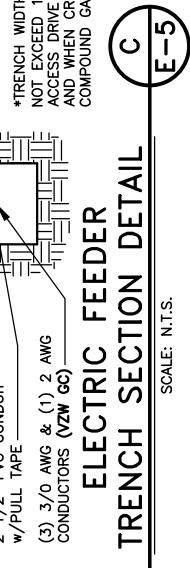
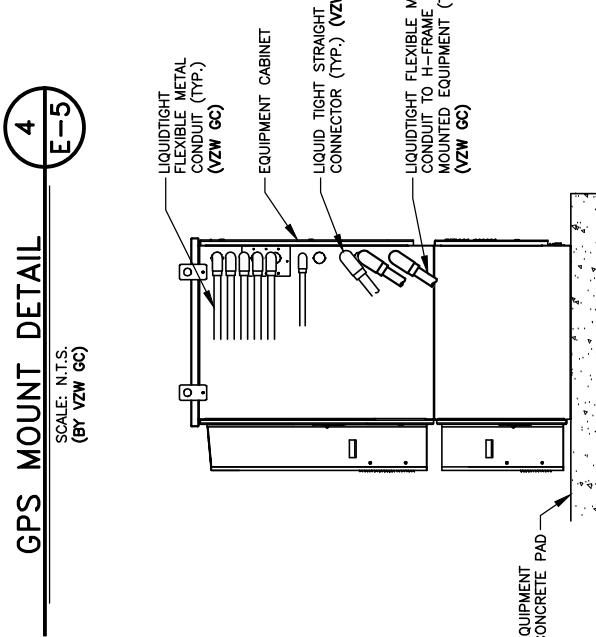
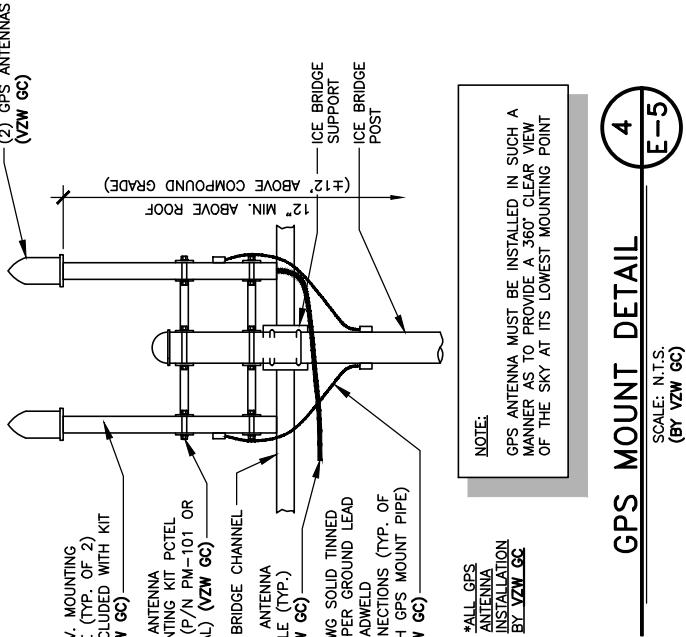


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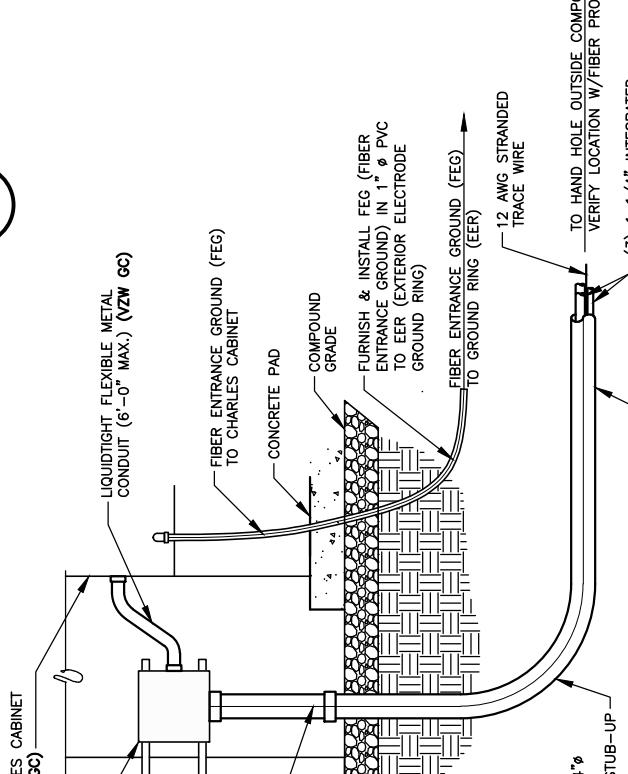
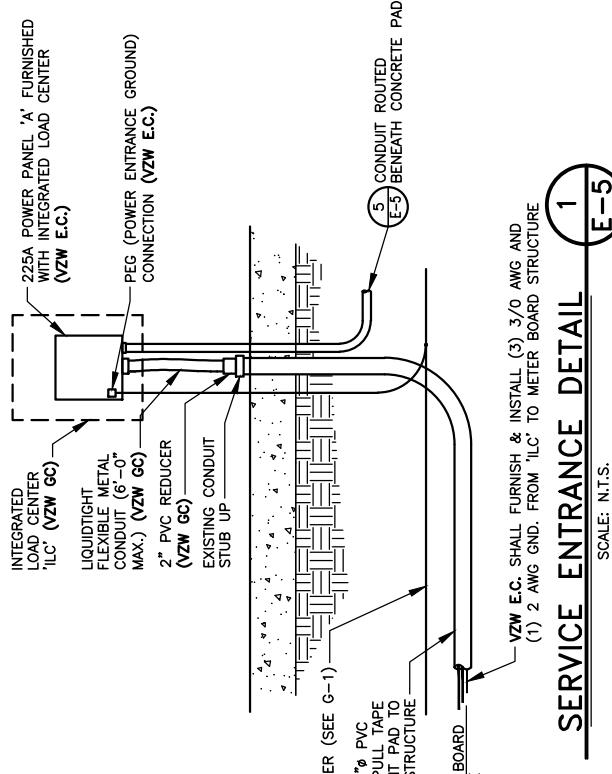
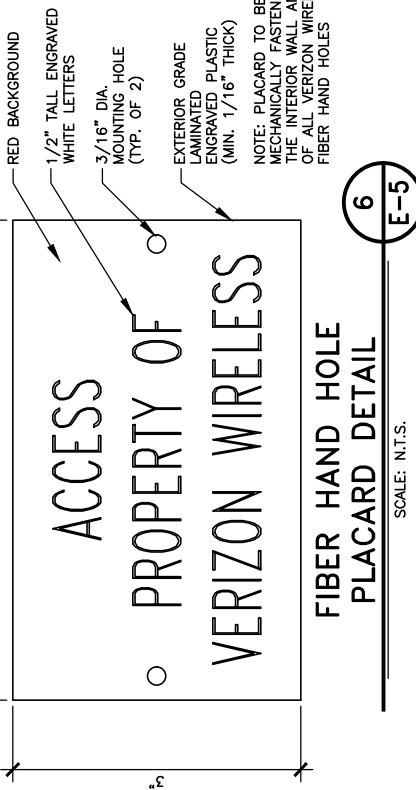
SERVICE LATERAL TRENCH SECTION DETAIL A-E-5

SCALE: N.T.S.

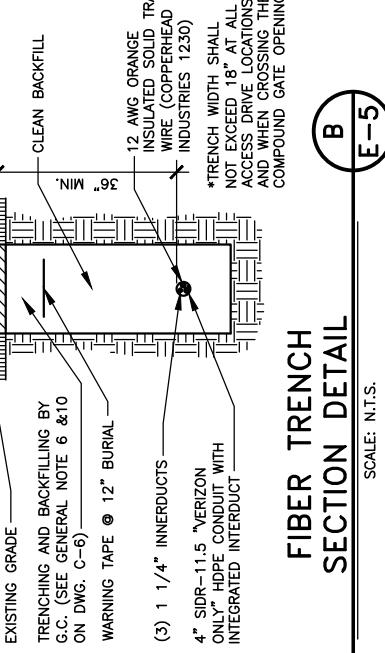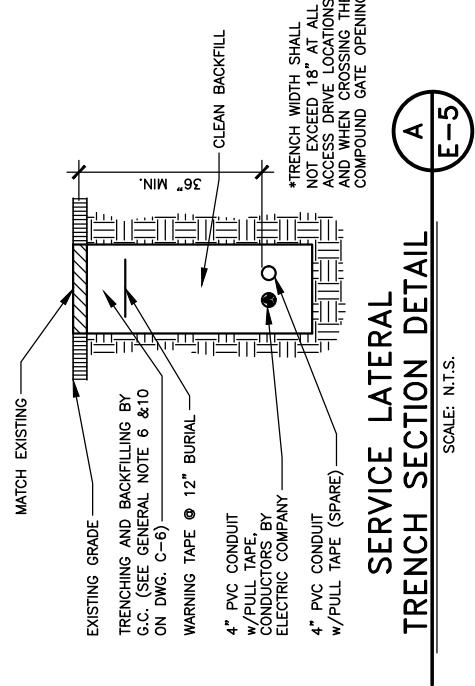


ELECTRIC FEEDER TRENCH SECTION DETAIL C-E-5

SCALE: N.T.S.



FIBER CONDUIT ENTRANCE DETAIL 2-E-5

SCALE: N.T.S.

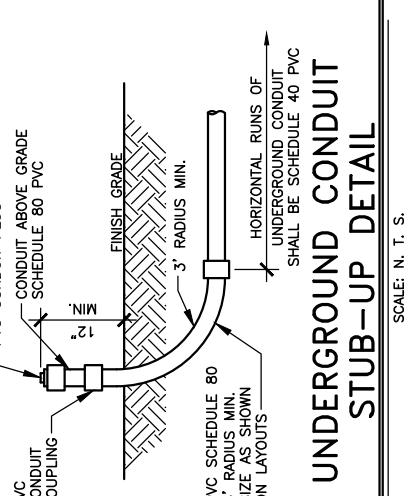

ELECTRICAL DETAILS

SHEET NUMBER: E-5

WK PAD & CANOPY REV 3 FINAL 10/16/23

LV MT VERNON EAST

SITE NUMBER: 721772

SITE NAME:

PID NUMBER: 16913443

DRAWN BY: RC

CHECKED BY: PL

DATE: 10/25/23

SHEET TITLE:




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859-544-5000 (PH)

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Wixom, Michigan 48393
PHONE: (248) 705-9212

NOTE:
VERIFY INTERIOR EQUIPMENT LOCATION, PRIOR TO
JUNCTION BOX FASTENER INSTALLATION. NO SHARP
FASTENER EDGES PERMITTED WITHIN CABINET

NOTE:
FIBER OPTIC INNERDUCTS SHALL
TERMINATE INSIDE CHARLES CABINET
ONLY

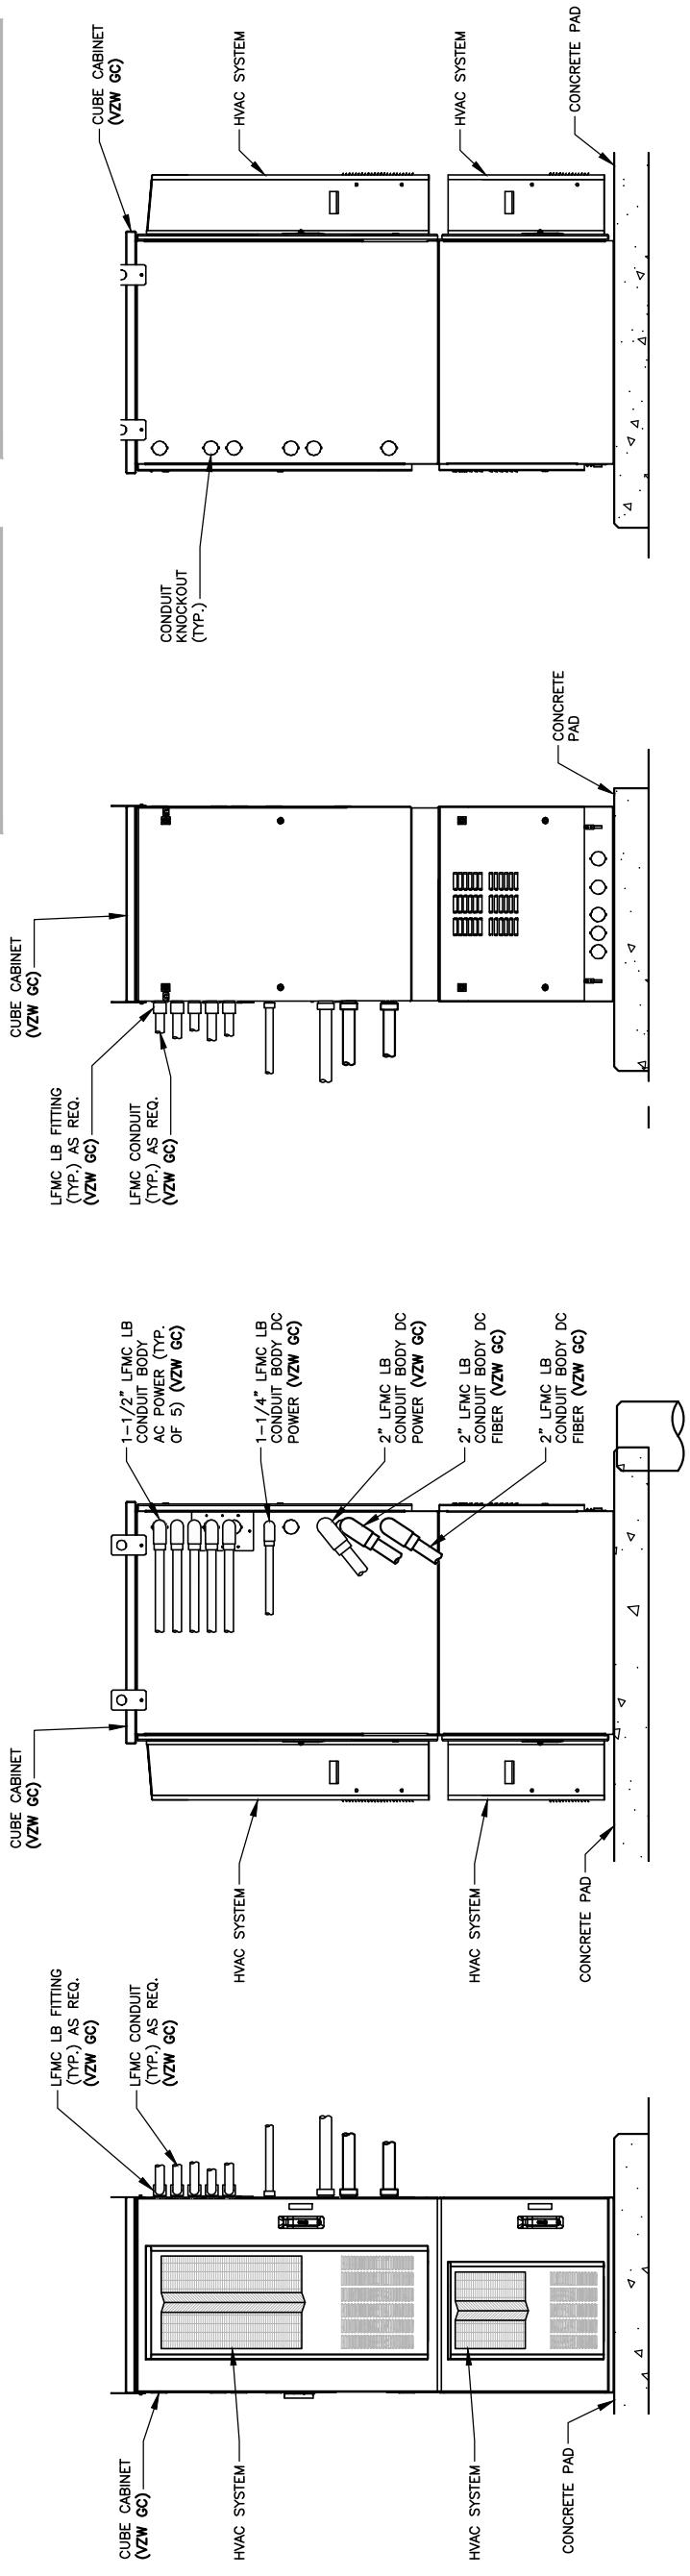

SITE INFORMATION:
LV MT VERNON EAST
DMITRIY V. ALBUL
LICENSED PROFESSIONAL ENGINEER
25093
Signature

SITE NUMBER:
721772
SITE NAME:
LV MT VERNON EAST
PID NUMBER: 16913443
DRAWN BY: RC
CHECKED BY: PL
DATE: 10/25/23
SHEET TITLE:

EQUIPMENT CABINET ELEVATIONS
SHEET NUMBER:


F — 6
WIK PAD & CANOPY REV 3 FINAL 10/16/23

RF CABINET LEFT ELEVATION **4** **E-6**
SCALE: N.T.S.

RF CABINET REAR ELEVATION **3** **E-6**
SCALE: N.T.S.

RF CABINET RIGHT ELEVATION **2** **E-6**
SCALE: N.T.S.

RF CABINET FRONT ELEVATION **1** **E-6**
SCALE: N.T.S.

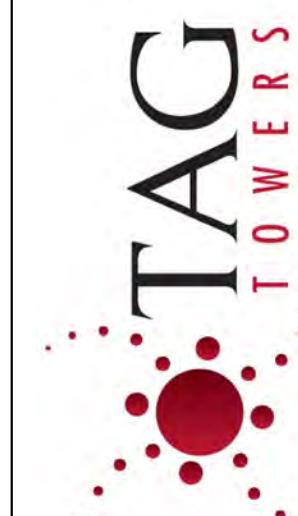

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859.544.5000 (PH)

**NEW 300' SELF SUPPORT TOWER
W/4' LIGHTNING ROD
TOTAL TOWER HEIGHT 304'**

PROJECT DESCRIPTION:

NOTE: ALL ITEMS WITHIN THESE CONSTRUCTION DOCUMENTS ARE BY OWNER'S GENERAL CONTRACTOR AND HIS SUB-CONTRACTORS UNLESS NOTED AS (VZW GC) WHICH SHALL INCLUDE VERIZON WIRELESS, GENERAL CONTRACTOR AND HIS SUB-CONTRACTORS, GENERALLY DESCRIBED BELOW:
 OWNER OWNER: SCOPES
 • INSTALL A NEW 300' SELF SUPPORT TOWER w/ 4' LIGHTNING ROD (TOTAL 304')
 • INSTALL A NEW TOWER FOUNDATION SYSTEM
 • INSTALL A NEW FENCED GRAVEL COMPOUND
 • INSTALL A NEW ELECTRICAL SERVICE RUN TO SITE UTILITY H-FRAME
 • INSTALL A NEW GRAVEL ACCESS DRIVE
 • NO WATER OR SEWAGE SERVICES TO SITE
 • INSTALL NEW TOWER & SITE GROUNDING SYSTEM
 • INSTALL NEW VZW SUBSURFACE GROUNDING SYSTEM
 • INSTALL NEW VZW CONCRETE EQUIPMENT FOUNDATIONS AND GENERATOR PADS
 • INSTALL VZW ICE BRIDGE AND FOUNDATIONS
 • INSTALL VZW EQUIPMENT H-FRAME AND FOUNDATIONS
 • INSTALL VZW ELECTRICAL SERVICE CONDUIT WITH PULL TAPES FROM ILC ENCLOSURE
 • SUB UP TO NEW VZW H-FRAME STUB-UP LOCATION TO THE GENERATOR SUB
 • INSULLATE CONDUITS WITH FULL TAPES FROM VZW ILC STUB-UP LOCATION TO THE GENERATOR SUB AT VZW GENERATOR PAD
 • INSTALL (1) NEW VZW FIBER OPTIC CONDUIT WITH INTEGRAL FIBER
 • INSTALL VZW EQUIPMENT PAD AND TRACER WIRE FROM VZW EQUIPMENT TO NEW VZW WIRELESS ONLY 24" X 36" HAND HOLE AT ROW.
 • PERMANENT ELECTRIC POWER MUST BE AVAILABLE FOR VZW WIRELESS AT THE METER BASE PRIOR TO THE SITE BEING RELEASED AS TENANT READY.

VERIZON WIRELESS, ONLY

• INSTALL VZW PRE-ROUTED CABLE, SUPPORT STRUCTURE, ON TOWER ANTISSA, GPS ANTENNA, LINES, COAX, CABLES, GROUND LEADS TO VZW EQUIPMENT & FACILITIES

• INSTALL EXISTING SUB-SURFACE GROUND LEADS TO VZW EQUIPMENT & FACILITIES

• INSTALL VZW ELECTRIC SERVICE CONDUCTORS FROM UTILITY H-FRAME TO VZW ILC

• INSTALL NEW CONDUITS WITH PULL TAPES FROM RF CABINET TO OVP H-FRAME LIT FIBER LOCATION

• INSTALL NEW CONDUITS AND CIRCUITS FROM VZW ILC ENCLOSURE TO EQUIPMENT ENCLOSURES AT VZW EQUIPMENT PAD

• INSTALL VZW GENERATOR CIRCUITS FROM VZW ILC & EQUIPMENT ENCLOSURES TO VZW NEW OUTDOOR OVERS AND CABLING ON VZW EQUIPMENT H-FRAME

• ALL CONSTRUCTION ITEMS ARE TO BE COMPLETED BY THE OWNER GENERAL CONTRACTOR UNLESS NOTED AS (VZW GC) WHICH SHALL BE COMPLETED BY THE VERIZON WIRELESS GENERAL CONTRACTOR

PROJECT DESCRIPTION



PROJECT SUMMARY



LV MT VERNON EAST

721772

**321 FROSTY HOLLOW ROAD
MT VERNON, KY 40456
ROCK CASTLE COUNTY**

**TENANT: RURAL CELLULAR CORP d/b/a VERIZON WIRELESS
BUILDING #: "LV MT VERNON EAST"**

FROM: 205 E. MAIN ST, MOUNT VERNON, KY 40456; HEAD EAST ON KY-1326 / E. MAIN ST TOWARD SPRING ST, 0.3 MI, KEEP STRAIGHT TO GET ONTO US-150 E / US-25 S / S ARRIVE AT 321 FROSTY HOLLOW ROAD, MT VERNON, KY 40456

**NEW 300' SELF SUPPORT TOWER
W/4' LIGHTNING ROD
TOTAL TOWER HEIGHT 304'**

PROJECT DESCRIPTION:

NOTE: ALL ITEMS WITHIN THESE CONSTRUCTION DOCUMENTS ARE BY OWNER'S GENERAL CONTRACTOR AND HIS SUB-CONTRACTORS UNLESS NOTED AS (VZW GC) WHICH SHALL INCLUDE VERIZON WIRELESS, GENERAL CONTRACTOR AND HIS SUB-CONTRACTORS, GENERALLY DESCRIBED BELOW:
 OWNER OWNER: SCOPES
 • INSTALL A NEW 300' SELF SUPPORT TOWER w/ 4' LIGHTNING ROD (TOTAL 304')

VERIZON WIRELESS, ONLY

• INSTALL VZW PRE-ROUTED CABLE, SUPPORT STRUCTURE, ON TOWER ANTISSA, GPS ANTENNA, LINES, COAX, CABLES, GROUND LEADS TO VZW EQUIPMENT & FACILITIES

• INSTALL EXISTING SUB-SURFACE GROUND LEADS TO VZW EQUIPMENT & FACILITIES

• INSTALL VZW ELECTRIC SERVICE CONDUCTORS FROM UTILITY H-FRAME TO VZW ILC

• INSTALL NEW CONDUITS WITH PULL TAPES FROM RF CABINET TO OVP H-FRAME LIT FIBER LOCATION

• INSTALL NEW CONDUITS AND CIRCUITS FROM VZW ILC ENCLOSURE TO EQUIPMENT ENCLOSURES AT VZW EQUIPMENT PAD

• INSTALL VZW GENERATOR CIRCUITS FROM VZW ILC & EQUIPMENT ENCLOSURES TO VZW NEW OUTDOOR OVERS AND CABLING ON VZW EQUIPMENT H-FRAME

• ALL CONSTRUCTION ITEMS ARE TO BE COMPLETED BY THE OWNER GENERAL CONTRACTOR UNLESS NOTED AS (VZW GC) WHICH SHALL BE COMPLETED BY THE VERIZON WIRELESS GENERAL CONTRACTOR

PROJECT DESCRIPTION

PROJECT TOTAL DISTURBED AREA:

COMPOUND: (2750 SF) = (0.086088 ACRE)



ACCESS DRIVE: (40510.8 SF) = (0.93 ACRE)

GROSS AREA: (44260.8 SF) = (1.016088 ACRE)

ALL CONSTRUCTION ITEMS ARE TO BE COMPLETED BY THE OWNER GENERAL CONTRACTOR UNLESS NOTED AS (VZW GC) WHICH SHALL BE COMPLETED BY THE VERIZON WIRELESS GENERAL CONTRACTOR

PROJECT SUMMARY

LOCATION MAP

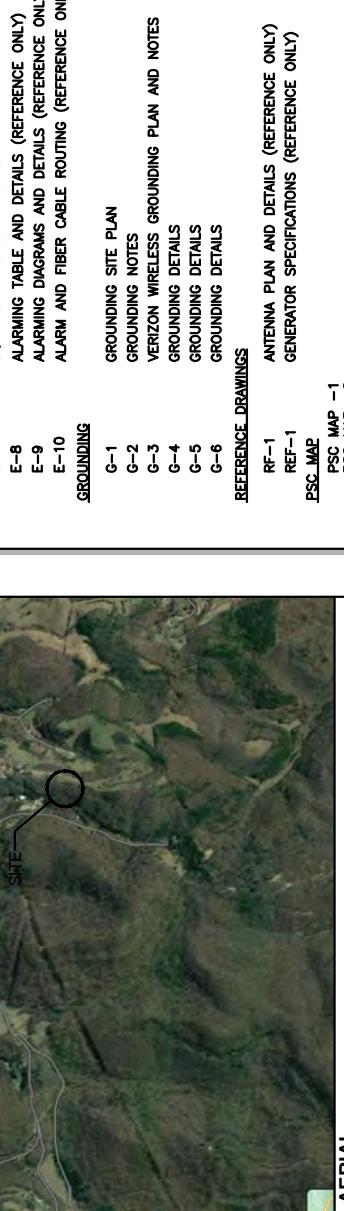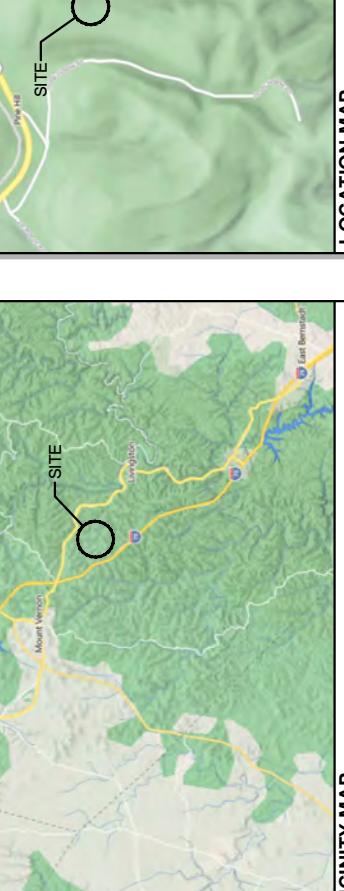

SHEET NUMBER	DESCRIPTION
T-1	PROJECT INFORMATION, SITE MAPS, SHEET INDEX
LS-1 TO LS-4	SURVEY PLAN
C-0	OVERALL SITE PLAN
C-1	OVERALL SITE PLAN W/AERIAL OVERLAY
C-1A	OVERALL SITE PLAN W/TOWER LEG DISTANCE TO PROPERTY LINES
C-1B	OVERALL SITE PLAN W/TOWER LEG DISTANCE TO PROPERTY LINES
C-2	GRADING AND EROSION CONTROL, OVERALL PLAN
C-2.1	GRADING AND EROSION CONTROL, OVERALL PLAN
C-3	DETAILED SITE PLAN
C-4	DIMENSIONED SITE PLAN
C-5	DETAILED YZW EQUIPMENT PLAN
C-6	GENERAL SITE CONSTRUCTION NOTES
C-7	BEST MANAGEMENT PRACTICES & EROSION CONTROL DETAILS AND NOTES
D-1	FENCE DETAILS AND NOTES
D-2	SITE DETAILS
D-3	EQUIPMENT PAD & CANOPY ELEVATIONS
D-4	VERIZON WIRELESS SIGNAGE (REFERENCE ONLY)
D-5	TOWER OWNER SITE FENCE SIGNAGE (REFERENCE ONLY)
S-1	EQUIPMENT PAD FOUNDATION PLAN, DETAILS AND STRUCTURAL NOTES
S-2	ICE BRIDGE PLAN AND DETAILS
S-3	FOUNDATION PLAN AND DETAILS
TE-1	TOWER ELEVATION
E-1	SITE UTILITY PLAN
E-2	PANEL SCHEDULE, ONE LINE DIAGRAM, ELECTRICAL NOTES AND DETAILS
E-3	EQUIPMENT PAD UTILITY PLAN & EQUIPMENT PAD TRENCH SECTIONS
E-4	OVP & INTEGRATED LOAD CENTER H-FRAME ELEVATIONS AND DETAILS
E-5	ELECTRICAL DETAILS
E-6	EQUIPMENT CABINET ELEVATIONS
E-7	EQUIPMENT PAD LIGHTING PLAN
E-8	ALARMING TABLE AND DETAILS (REFERENCE ONLY)
E-9	VERIZON WIRELESS GROUNDING PLAN AND NOTES
E-10	GROUNDED DETAILS
G-1	GROUNDING SITE PLAN
G-2	GROUNDING NOTES
G-3	ALARMING DETAILS
G-4	GROUNDED DETAILS
G-5	GROUNDING DETAILS
G-6	GROUNDING DETAILS
REF. DRAWINGS	REFERENCE DRAWINGS
RF-1	ANTENNA PLAN AND DETAILS (REFERENCE ONLY)
REF-1	GENERATOR SPECIFICATIONS (REFERENCE ONLY)
PSC MAP	PSC MAP
PSC MAP - 1	PSC MAP - 1

WK PAD & CANDY REV 3 FINAL 10/16/23

SHEET NUMBER	DESCRIPTION
RC PL	PROJECT INFORMATION, SITE MAPS, SHEET INDEX
10/25/23	SHEET NUMBER:
16913443	PID NUMBER:
RC PL	DRAWN BY:
10/25/23	CHECKED BY:
16913443	SHEET TITLE:
RC PL	PROJEC
10/25/23	INFORMATION, SITE MAPS, SHEET INDEX
1	SHEET NUMBER:

T — 1



PREPARED FOR:
verizon
Verizon W

SMJ INSTITUTIONAL

FSTAN

CURVE	RADIUS	CHORD BEARING	CHORD LENGTH
C1	50.00'	S 84° 38' 21" E	79.14'
C2	60.00'	S 05° 12' 50" E	49.04'
C3	50.00'	S 24° 27' 52" W	72.07'
C4	70.00'	S 24° 27' 52" W	12.07'
C5	62.00'	S 05° 14' 23" W	25.60'

C3	90.00'	S 0715 19° W	27.47'
C7	42.29'	S 1029 48° E	36.68'
C8	70.00'	S 0901 57° E	41.51'
C9	690.00'	S 04° 13' 18" W	96.08'
C10	710.00'	N 04° 13' 18" E	96.08'
C11	50.00'	N 0807 57° W	29.65'
C12	62.29'	N 0920 08° W	52.88'
C13	70.00'	N 0708 35° E	20.85'
C14	113.20'	N 1006 18° E	32.17'
C15	90.00'	N 24° 24' 26" E	15.52'
C16	70.00'	N 2237 52° E	16.39'
C17	40.00'	N 0612 50° W	32.69'
C18	30.00'	N 64° 39' 21" W	47.49'
C19	410.00'	S 45° 38' 38" W	37.48'
C20	215.34'	S 3344 58° W	107.94'
C21	410.00'	S 2052 43° W	21.52'
C22	290.00'	S 1753 10° W	46.88'
C23	610.00'	S 1934 04° W	1.34 25'
C24	610.00'	S 2827 25° W	54.74'
C25	590.00'	S 3008 55° W	18.13'
C26	590.00'	S 2603 52° W	65.95'
C27	35.89'	S 7526 50° W	57.62'
C28	71.87'	N 3522 40° W	38.63'
C29	51.87'	S 3522 40° E	27.66'

C30	15.89°	N	75°26'50"E	25.24'
C31	610.00°	N	20°03'52"E	68.18'
C32	610.00°	N	30°08'55"E	18.74'
C33	590.00°	N	28°27'55"E	52.94'
C34	590.00°	N	19°34'04"E	129.85'
C35	310.00°	N	17°53'10"E	50.11'
C36	310.00°	N	20°52'43"E	22.37'
C37	325.74°	N	33°44'58"E	11.96'
C38	390.00°	N	45°18'38"E	35.65'

YOURS NOTES

**BEARING AND ELEVATION IS A G.P.S. OBSERVATION ON NOVEMBER
15, 2010 FROM A GPS CONTINUOUSLY OPERATING REFERENCE STATION
N - X Y DIST & CORS APP. DOTS ID - MTHA. PD - DRK35.
W - X Y SUBJECT TO SHIFT OF WAVS AND ELEMENTS SHOWN HEREIN**

OF PUBLIC RECORDS HAS BEEN ACHIEVED BY THIS SURVEY.
ANY DEFECTS AND/OR AMBIGUITIES IN THE TITLE OF THE PARENT
PROPERTY DO NOT REPRESENT A BOUNDARY SURVEY.
CONTURS ARE AT ONE FOOT INTERVALS.

SURVEYOR'S CERTIFICATE

SURVEYOR UNQUOTE TRAVESE CLOSURE BETTER THAN 1 IN 10,000.
SUBSCRIBERS INTERESTED IN TITLE TO PREMISES SURVEYED
certify that this plat and survey were made under my
own, and that the angular and linear measurements,
and all of the monuments shown thereon, are true and correct
to the best of my knowledge and belief.
I further certify that no part thereof exceeds the minimum standards
of the surveying authorities.

 <u>Sellinger, Inc.</u> <small>not shown person.</small>	4-25-23 <hr/> RT. Reg. No. 3822 <hr/> COMMUNICATION SITE SURVEY"	<small>DATE:</small> _____
---	---	-------------------------------

DATE: _____
LOAD INSURANCE RATE MAPS (FIRMS)
DATED 08-03-2009 AND THE LEASE
TO BE IN A FL0000 PROFILE
IS LOCATED IN ZONE X.



	- LEGAL DESCRIPTIONS (PARENT TRACT)
	- MILE NOTES

PARENT TRACT DESCRIPTION PROVIDED BY FIDELITY NATIONAL TITLE INSURANCE COMPANY

Property located in Rockcastle County, Kentucky

PARCEL 1:
Beginning at a utility pole on East side of Jack Hurd Road; thence southwesterly along the road to a white oak tree and iron stake, the center of E.B. Allen, Minnie Kirby, and Kelly Coffey; thence westerly approximately 40 feet to an iron stake at the fork of the two principal branches, which is a corner boundary line of E.B. Allen, Maybelle Moore, and Hayes Allen; thence with Hayes Allen boundary line 210 feet to big white oak; thence Southwesterly .88 feet to a pine tree above dwelling; thence Southwest 1.53 feet to iron stake in line of Donald Collins; thence around Donald Collins line to his Northeast corner and line of Hayes Allen; thence to center of branch and along line of Maybelle Moore other west corner; thence with Maybelle Moore's line South 30 degrees East to corner stone and pine tree; thence with Maybelle Moore's line easterly to iron stake and pine tree, the corner of E.B. Allen and Maybelle Moore; thence easterly in a direct line with Ebb B. Allen to property line of James Goforth to a twin hickory tree in fence line .56 feet south of the branch; thence southerly with James Goforth to a hickory at top of ridge, G. D. Mink comes thence northwesterly with Mink down a hill to a corner in the branch with fence; thence westerly continuing with Mink and the fence to a corner on top of Pipe Hill, fence corner; thence northerly with W.T. Payne, J. B. Fain and Tom Reiner lands with a fence in boundary line at a fence corner; thence easterly with a fence, a new line to an iron stake; thence northeasterly a new line to the utility pole, the point of beginning, and containing seven acres more or less.

LESS AND EXCEPT that portion of property conveyed to Michael Collins from Clyde Raymond Collins and Magdalene Collins by Deed of Conveyance dated July 12, 2006 and recorded August 8, 2006 in Deed Book 211, Page 654. (DOES NOT AFFECT THE LEASE AREA, THE ACCESS & UTILITY ESMI, OR THE UTILITY ESMI. SHOWN PER THIS SURVEY)

AND BEING a portion of the same property conveyed to Clyde Raymond Collins and Magdalene Collins from Ebb Ben Allen and Willis Robinson Allen by Deed of Conveyance dated June 17, 1994 and recorded June 22, 1994 in Deed Book 154, Page 282.

Tax Parcel No. 074-00-002

PARCEL 2:
The following described real property located in Rockcastle County, Kentucky, and more particularly bounded and described as follows:

On the waters of Roundstone Creek;

Beginning at a stone in the side of the county road, Albert Griffin's (now John Griffin's) corner; thence south with county road 716 feet to a stone in the edge of county road; thence east a straight line to the top of the ridge to Albert Griffin's line; thence north with Griffin's line to a pine corner in said line; thence west a straight line to the beginning corner and containing ten (.10) acres the same more or less.

LESS AND EXCEPT that portion conveyed to Darrell Collins and Chia G. Collins from Clyde Raymond Collins and Magdalene Collins by Deed of Conveyance dated March 23, 1999 and recorded March 26, 1999 in Deed Book 173, Page 667. (DOES NOT AFFECT THE LEASE AREA, THE ACCESS & UTILITY ESMI, OR THE UTILITY ESMI. SHOWN PER THIS SURVEY)

AND BEING a portion of the same property conveyed to C. Raymond Collins and Magdalene W. Collins from William Cash, Jr., and Doris P. Cash by Deed of Conveyance dated April 20, 1972 and recorded April 25, 1972 in Deed Book 92, Page 320.

Tax Parcel No. 073SW-00-016

PARCEL 3:
The following described real property located in Rockcastle County, Kentucky, and more particularly bounded and described as follows:

Beginning on a pine on the west side of a dirt road and being a corner to Clyde Collins and Benton Miller; thence with line of Miller N13° 42' 25" E, 104.52 feet to a white oak; N 12° 10' 00" E, 314.77 feet to a post; thence N 00° 34' 30" W, 76.40 feet to a post in line of Miller and corner to Clifford Collins; thence with line of Collins S 77° 01' 13" E, 102.04 feet to a post; S 70° 20' 20" E, 221.74 feet to a post; N 22° 41' 55" E, 50.71 feet to a post in line of Clifford Collins and corner to George Collins; thence with line of some S 56° 58' 22" E, 132.79 feet to a post corner of George Collins and Ronnie Worf; thence with line of Ward S 03° 23' 15" W, 118.32 feet; S 60° 48' 04" E, 262.61 feet to an iron post in line of Worf and corner to James Jones; thence S 23° 44' 26" W, 457.49 feet to an iron post corner to Jones and in line of Ben Allen; thence with line of Allen N 55° 00' 00" W, 135.48 feet to a post; N 60° 00' 00" W, 145.93 feet to a post; N 74° 48' 13" W, 35.91 feet to a white oak; N 80° 23' 35" W, 149.90 feet to a black oak; N 76° 04' 38" W, 97.45 feet to a black oak corner to Allen and in line of Clyde Collins; thence with some N 13° 07' 16" W, 64.57 feet to point of beginning. Containing 7.972 acres by survey of Charles Mullins Registered Land Surveyor NC. 778.

LESS AND EXCEPT that portion conveyed to Rhonda Collins and Magdalene Collins by Deed of Conveyance dated August 4, 2000 and recorded September 8, 2000 in Deed Book 181, Page 168. (SAME AS PAR. #073SW-00-016.02. DOES NOT AFFECT THE LEASE AREA, THE ACCESS & UTILITY ESMI, OR THE UTILITY ESMI. SHOWN PER THIS SURVEY)

AND BEING a portion of the same property conveyed to Clyde Raymond Collins and Magdalene Collins from George Collins and Irene Collins by Deed of Conveyance dated March 29, 1988 and recorded April 4, 1988 in Deed Book 153, Page 483.

Tax Parcel No. 073SW-00-032.04

SURVEYOR'S REVIEW OF "SPECIAL EXCEPTIONS"

NOTES CORRESPONDING TO THE FIDELITY NATIONAL TITLE INSURANCE COMPANY, "REPORT OF TITLE", ORDER NUMBER: 37985209 AND REFERENCE NUMBER: VERIZON WIRELESS - LV MT. VERNON EAST, EFFECTIVE DATE: 10/13/2022.

4. Easement in favor of Kentucky Utilities Company set forth in instrument recorded on April 9, 1984 in Deed Book 122, Page 152. (DOES NOT AFFECT THE LEASE AREA, THE ACCESS & UTILITY ESMI, OR THE UTILITY ESMI. SHOWN PER THIS SURVEY)

5. Certificate of Title (Mobile Home) recorded on July 19, 2010 in Miscellaneous Book 46, Page 93. (NOT A SURVEY ISSUE)

FSTAN
1012 S 4th Street, Suite 101
Louisville, Ky 40203
Phone: (502) 636-5111
Fax: (502) 636-5263

SITE NUMBER: 721772

SITE NAME:

MT VERNON EAST

SITE ADDRESS:

FROSTY HOLLOW RD
MT VERNON, KY 40456
LEASE AREA: 10,000.00 SQ.FT.
PROPERTY OWNER: CLYDE R & MAGDALENE COLLINS
3117 FROSTY HOLLOW RD
MT VERNON, KY 40456

PARCEL NUMBER:

074-00-002,
073SW-00-032.04,
& 073SW-00-016SOURCE OF TITLE:
D.B. 154 PG. 282,
D.B. 133 PG. 483
& D.B. 92 PG. 320DING BY: SMS FIELD DATE: DRAFT DATE:
OKRD BY: FLS 11/15/22 12/09/22
ESTAN PROJECT NO.: 22-11688

LAND SURVEYOR'S CERTIFICATE

TYPE "A" SURVEY: UNADJUSTED TRAPEZOIDAL CLOSURE BETTER THAN 1 IN 10,000.
TO ALL PARTIES INTERESTED IN TITLE TO PREMISES SURVEYED
I hereby certify that this plan and survey were made under my
supervision, and that the angular and linear measurements,
as witnessed by monuments shown herein, are true and correct
to the best of my knowledge and belief.
This survey and plan meets or exceeds the minimum standards
of the governing authorities.
This property is subject to any recorded easements or right
of ways not shown herein.

REVISIONS:
ACCESS ESMI - 01/09/23
ADD TITLE - 02/21/23
FINAL(SAS) - 02/27/23
SHIFT COORD. PNT.-04/24/23(231173)

FRANK L. SELLINGER
Frank L. Sellinger
KY Reg. No. 3282

LICENSED PROFESSIONAL LAND SURVEYOR

RAWLAND
Rawland
KY Reg. No. 3282



TAG TOWERS, LLC
08 FORBES COURT, SUITE 1
RICHMOND, KY 40475
859.544.5000 (PH)

49030 Pontiac Trail, Suite 100
Wixom, Michigan 48393
PHONE: (248) 705-9212

49030 Pontiac Trail, Suite 100
Wixom, Michigan 48393
PHONE: (248) 705-9212




SITE INFORMATION:
LVMT VERNON EAST
321 FROSTY HOLLOW ROAD
MT VERNON, KY 40456
ROCK CASTLE COUNTY

SITE NAME:	ELV MT VERNON EAST
PID NUMBER:	16913443
DRAWN BY:	RC
CHECKED BY:	PL
DATE:	10.25.23

OVERALL SITE PLAN

SHEET NUMBER:
C — 0
MIK PAD & CANOPY REV 3 FINAL 10/16/23

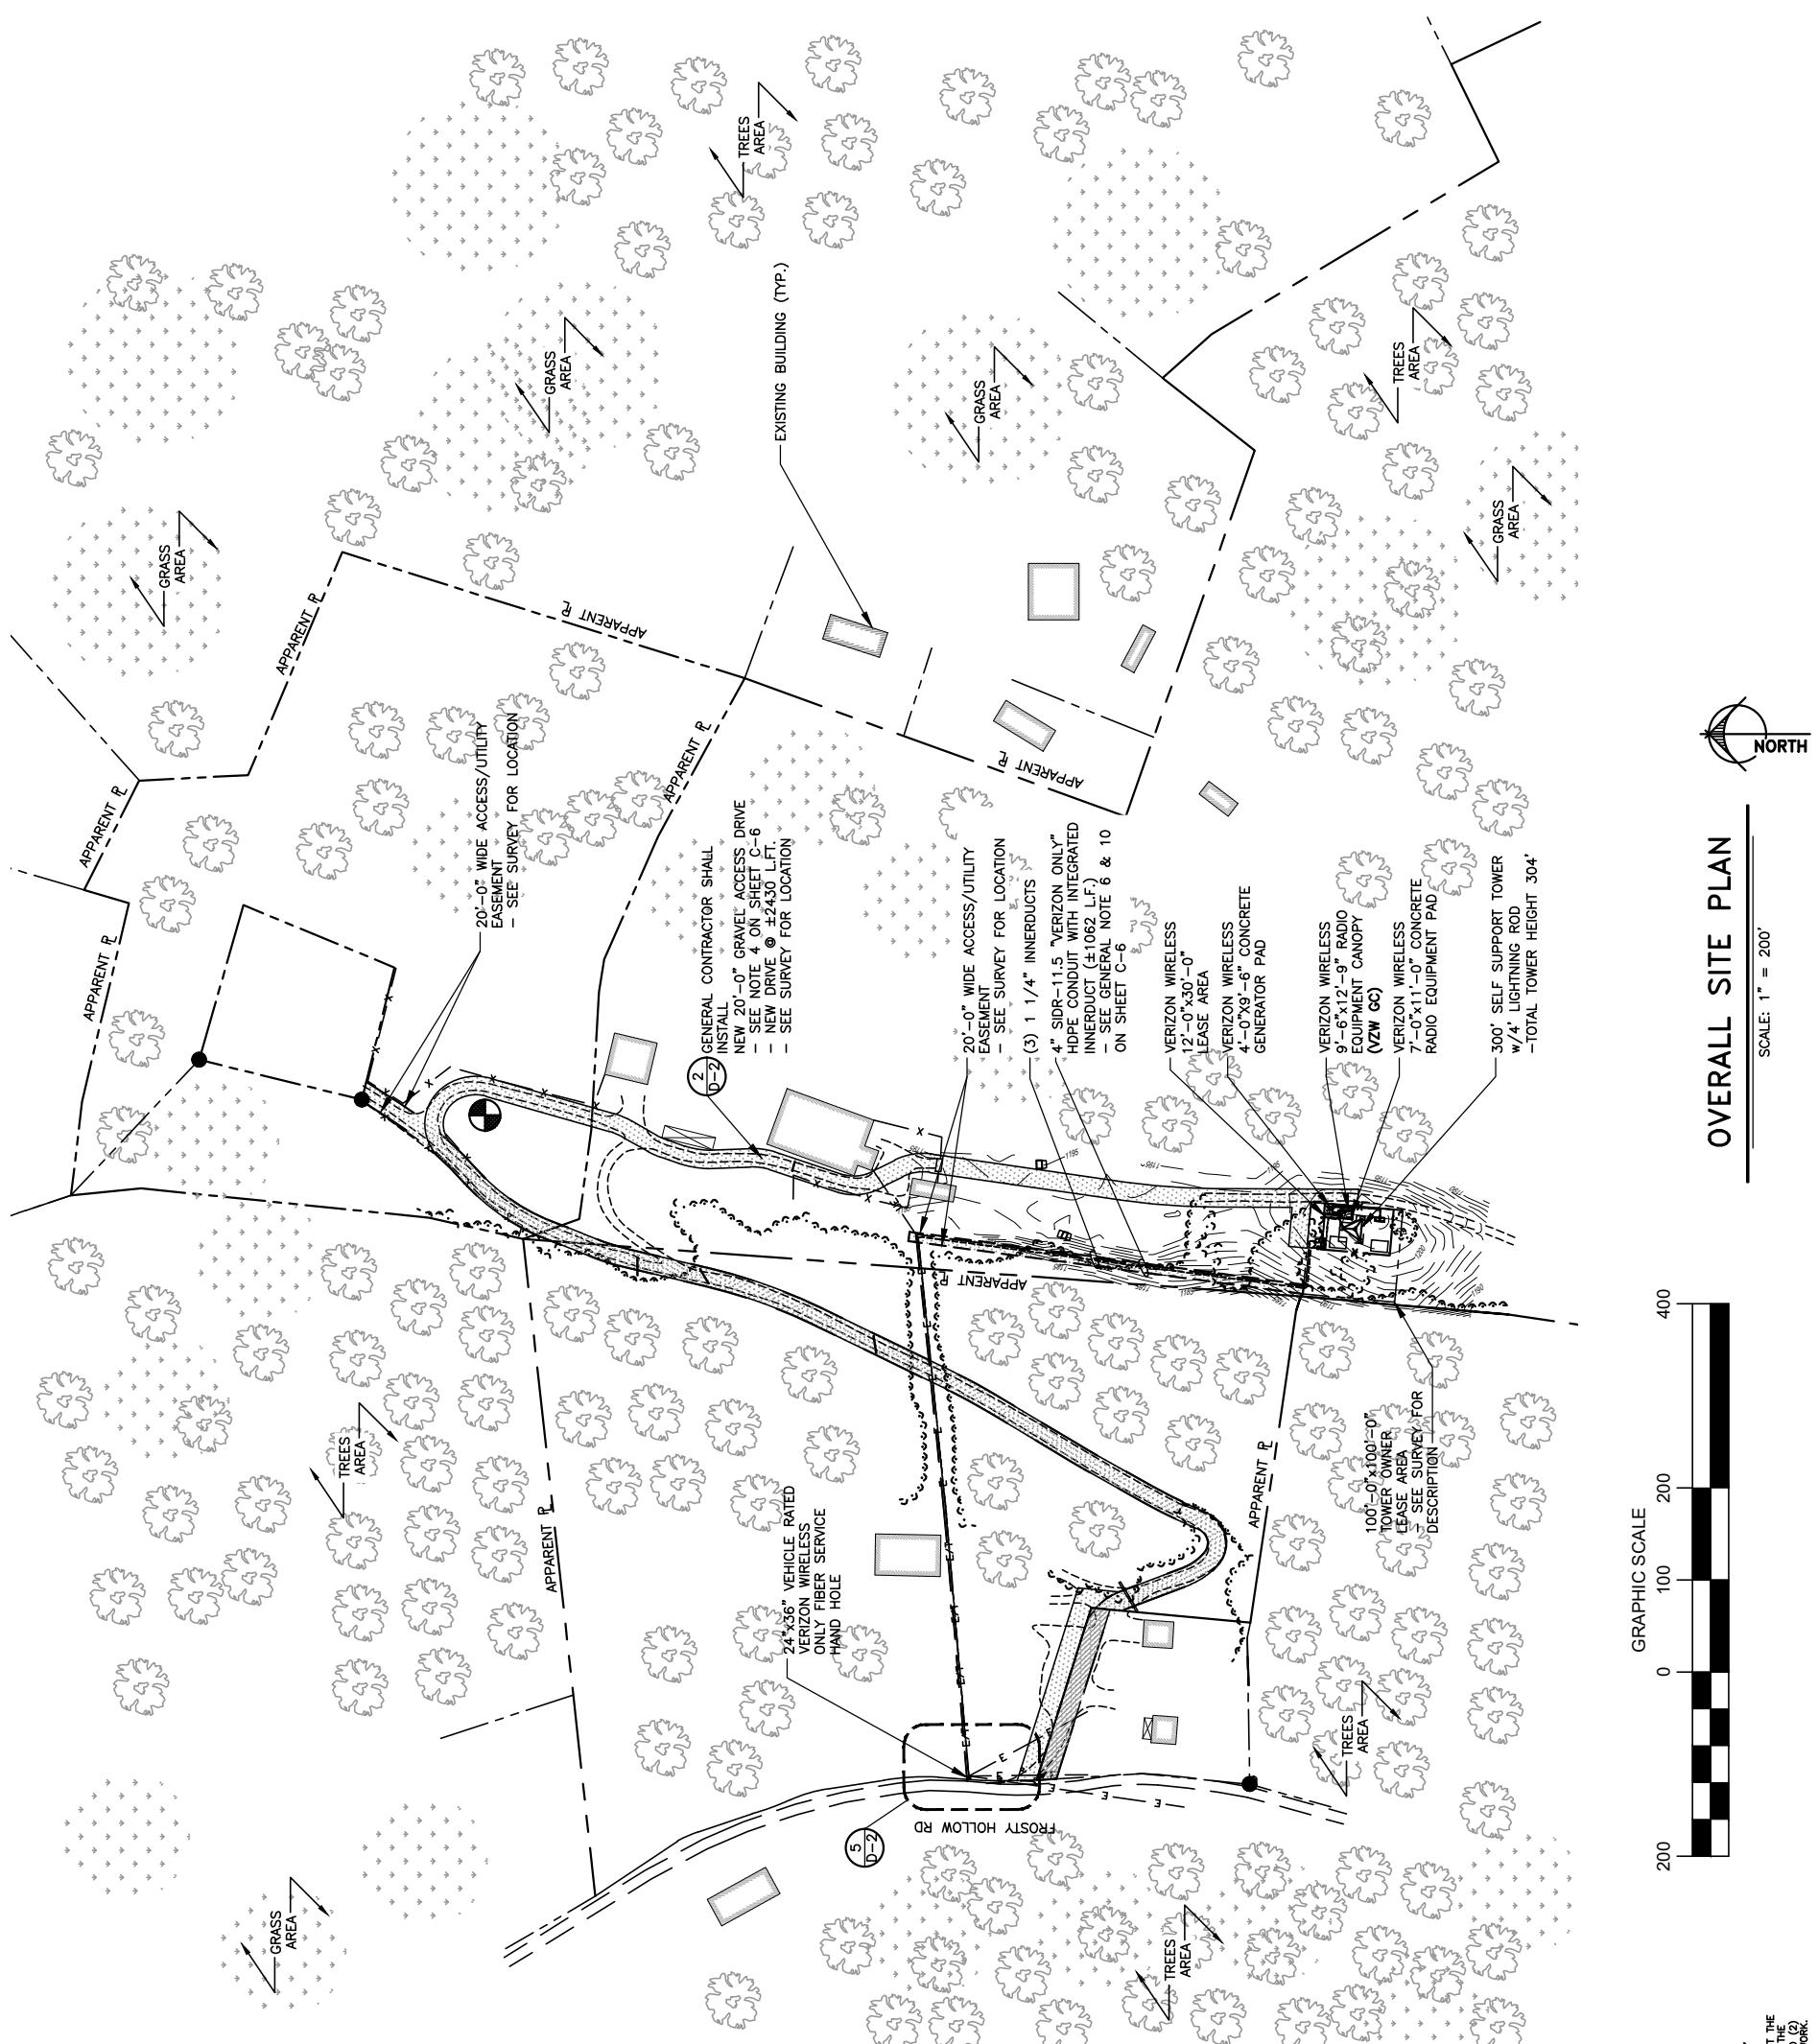

Know where to dig.
Call before you dig.
Call Monday thru Friday - 7 am. to 6 pm.
1-800-752-6007



TAG
TOWERS
108 FOREST COURT, SUITE 1
RICHMOND, KY 40475
859-544-5000 (PH)



49030 Portia Trail, Suite 100
Wixom, Michigan 48393
PHONE: (248) 705-9212

REV.	DATE	DESCRIPTION
-	12/27/23	REVISED FOR CONSTRUCTION
0	11/16/23	ISSUED FOR REVIEW
B	08/04/23	ISSUED FOR REVIEW
A	08/04/23	ISSUED FOR REVIEW



SITE INFORMATION:
LV MT VERNON EAST
321 FROSTY HOLLOW ROAD
MT VERNON, KY 40456
ROCK CASTLE COUNTY

SITE NAME:
LV MT VERNON EAST
SITE NUMBER:
721772
SHEET TITLE:

OVERALL SITE PLAN
W/AERIAL OVERLAY
SHEET NUMBER:
C — 1

WK PAD & CANOPY REV 3 FINAL 10/16/23



Know before you dig.
Call before you dig.
Call Monday thru Friday 7 am to 6 pm.
1-800-752-6007
PER KENTUCKY STATE LAW, IT IS AGAINST THE
LAW TO EXCAVATE WITHOUT NOTIFYING THE
UNDERGROUND LOCATING SERVICE TWO (2)
WORKING DAYS BEFORE COMMENCING WORK.



SCALE: 1" = 50'



OVERALL SITE PLAN W/AERIAL OVERLAY



TAG TOWERS LLC
108 FORGE COURT, SUITE 1
RICHMOND, KY 40475
859-544-5000 (PH)

LAB

49030 Portiac Trail, Suite 100
Wixom, Michigan 48393
PHONE: (248) 705-9212

REV.	DATE	DESCRIPTION
1	12/27/23	REVISED FOR CONSTRUCTION
0	11/16/23	ISSUED FOR REVIEW
B	08/04/23	ISSUED FOR REVIEW
A	08/04/23	ISSUED FOR REVIEW



SITE INFORMATION:
LV MT VERNON EAST
321 FROSTY HOLLOW ROAD
MT VERNON, KY 40456
ROCK CASTLE COUNTY

SITE NUMBER:
721772
SITE NAME:
LV MT VERNON EAST
PID NUMBER: 16913443
DRAWN BY: RC
CHECKED BY: PL
DATE: 10/25/23

SHEET TITLE:
**OVERALL SITE PLAN
W/TOWER LEG
DISTANCE TO
PROPERTY LINES**
SHEET NUMBER:
C — 1 A

PER KENTUCKY STATE LAW, IT IS AGAINST THE
LAW TO LOCATE TWO (2)
UNPERMITTED COMMERCIAL SERVICE WORKING
DAYS BEFORE COMMENCING WORK.
CALL MONDAY THRU FRIDAY - 7 AM. TO 6 PM.
1-800-752-6007




**OVERALL SITE PLAN w/TOWER LEG DISTANCE
TO PROPERTY LINES**

SCALE: 1" = 60'



Know where below.
Call before you dig.
1-800-752-6007

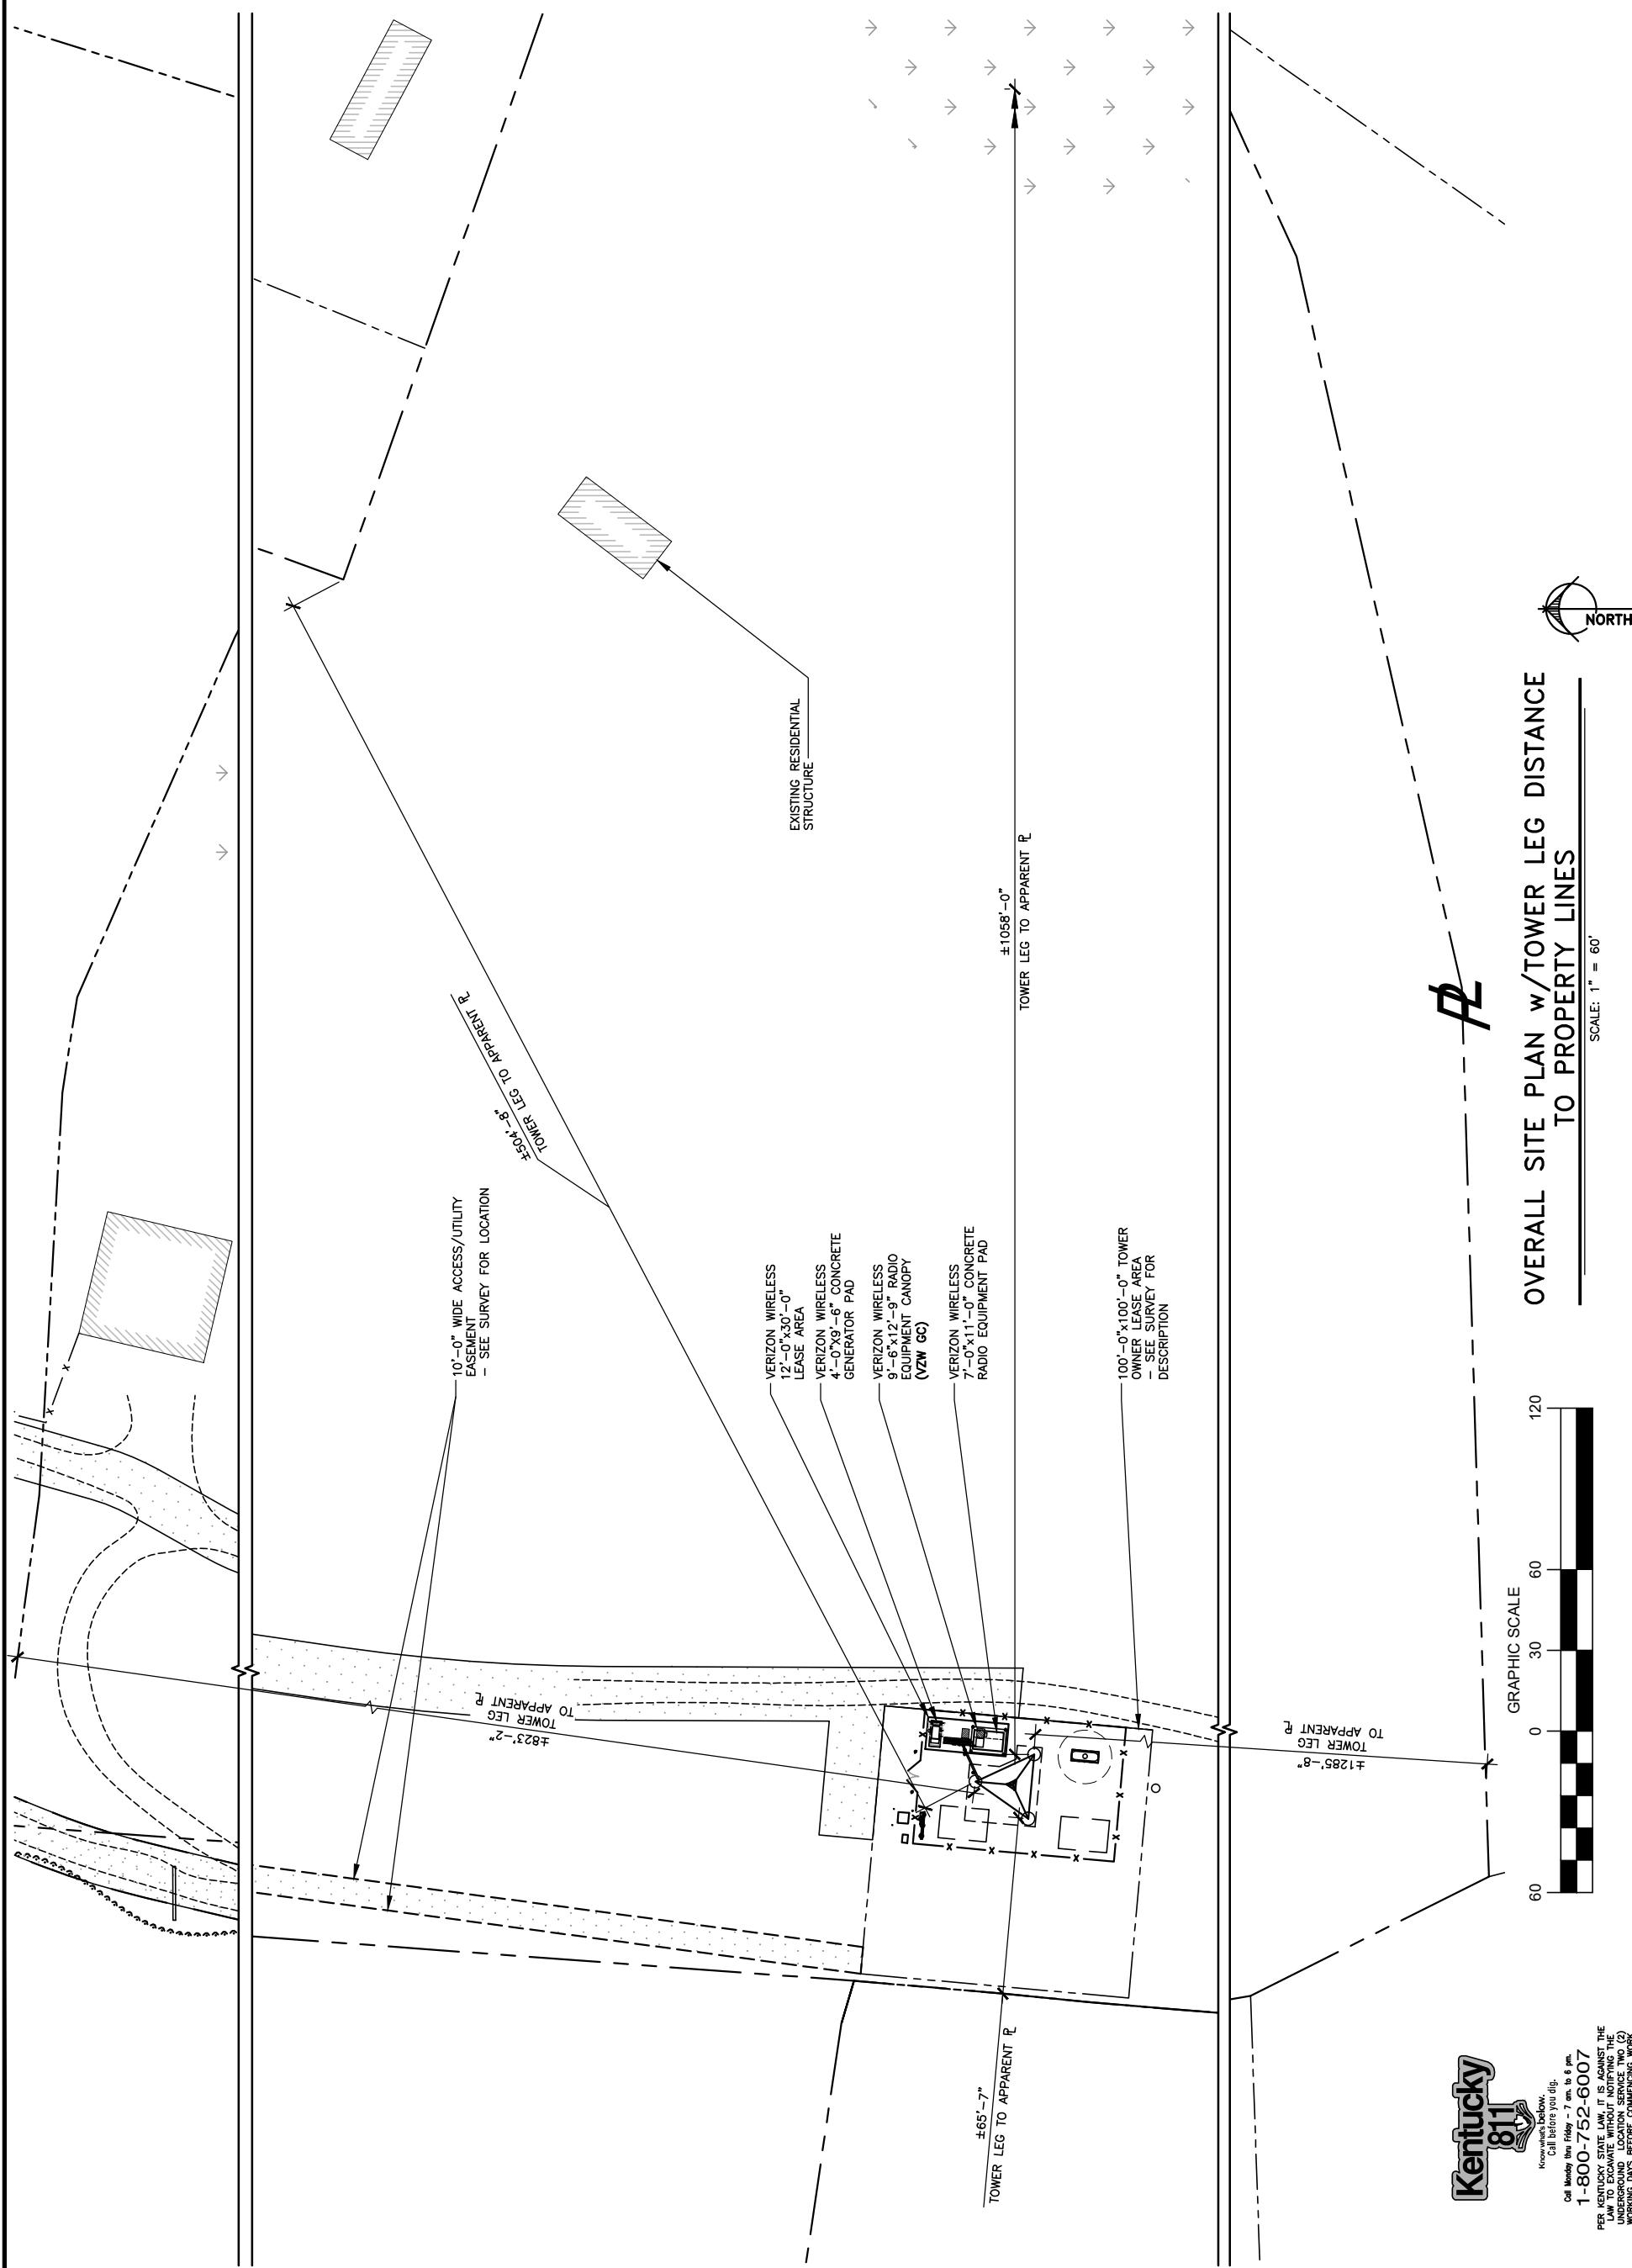



TAG TOWERS LLC
108 FOREST COURT, SUITE 1
RICHMOND, KY 40475
859-544-5000 (PH)

LAB

49030 Portiac Trail, Suite 100
Wixom, Michigan 48393
PHONE: (248) 705-9212

REV.	DATE	DESCRIPTION
1	12/27/23	REVISED FOR CONSTRUCTION
0	11/16/23	ISSUED FOR REVIEW
B	08/04/23	ISSUED FOR REVIEW
A	08/04/23	ISSUED FOR REVIEW



SITE INFORMATION:
LV MT VERNON EAST
321 FROSTY HOLLOW ROAD
MT VERNON, KY 40456
ROCK CASTLE COUNTY

SITE NAME:
721772

PID NUMBER: 16913443
DRAWN BY: RC
CHECKED BY: PL
DATE: 10-25-23

OVERALL SITE PLAN
w/TOWER LEG DISTANCE
TO RESIDENTIAL STRUCTURES

SHEET NUMBER:
C — 1 B
PER. KENTUCKY REV. 3 FINAL 10/16/23




**OVERALL SITE PLAN w/TOWER LEG DISTANCE
TO RESIDENTIAL STRUCTURES**

SCALE: 1" = 60'




Know before you dig.
Call **Kentucky 811** this Friday - 7 am. to 6 pm.
1-800-752-6007
PER. KENTUCKY STATE LAW, IT IS AGAINST THE
LAW TO DIG ON PUBLIC PROPERTY WITHOUT
FIRST CALLING 811. TWO (2) WORKING DAYS
BEFORE COMMENCING WORK.

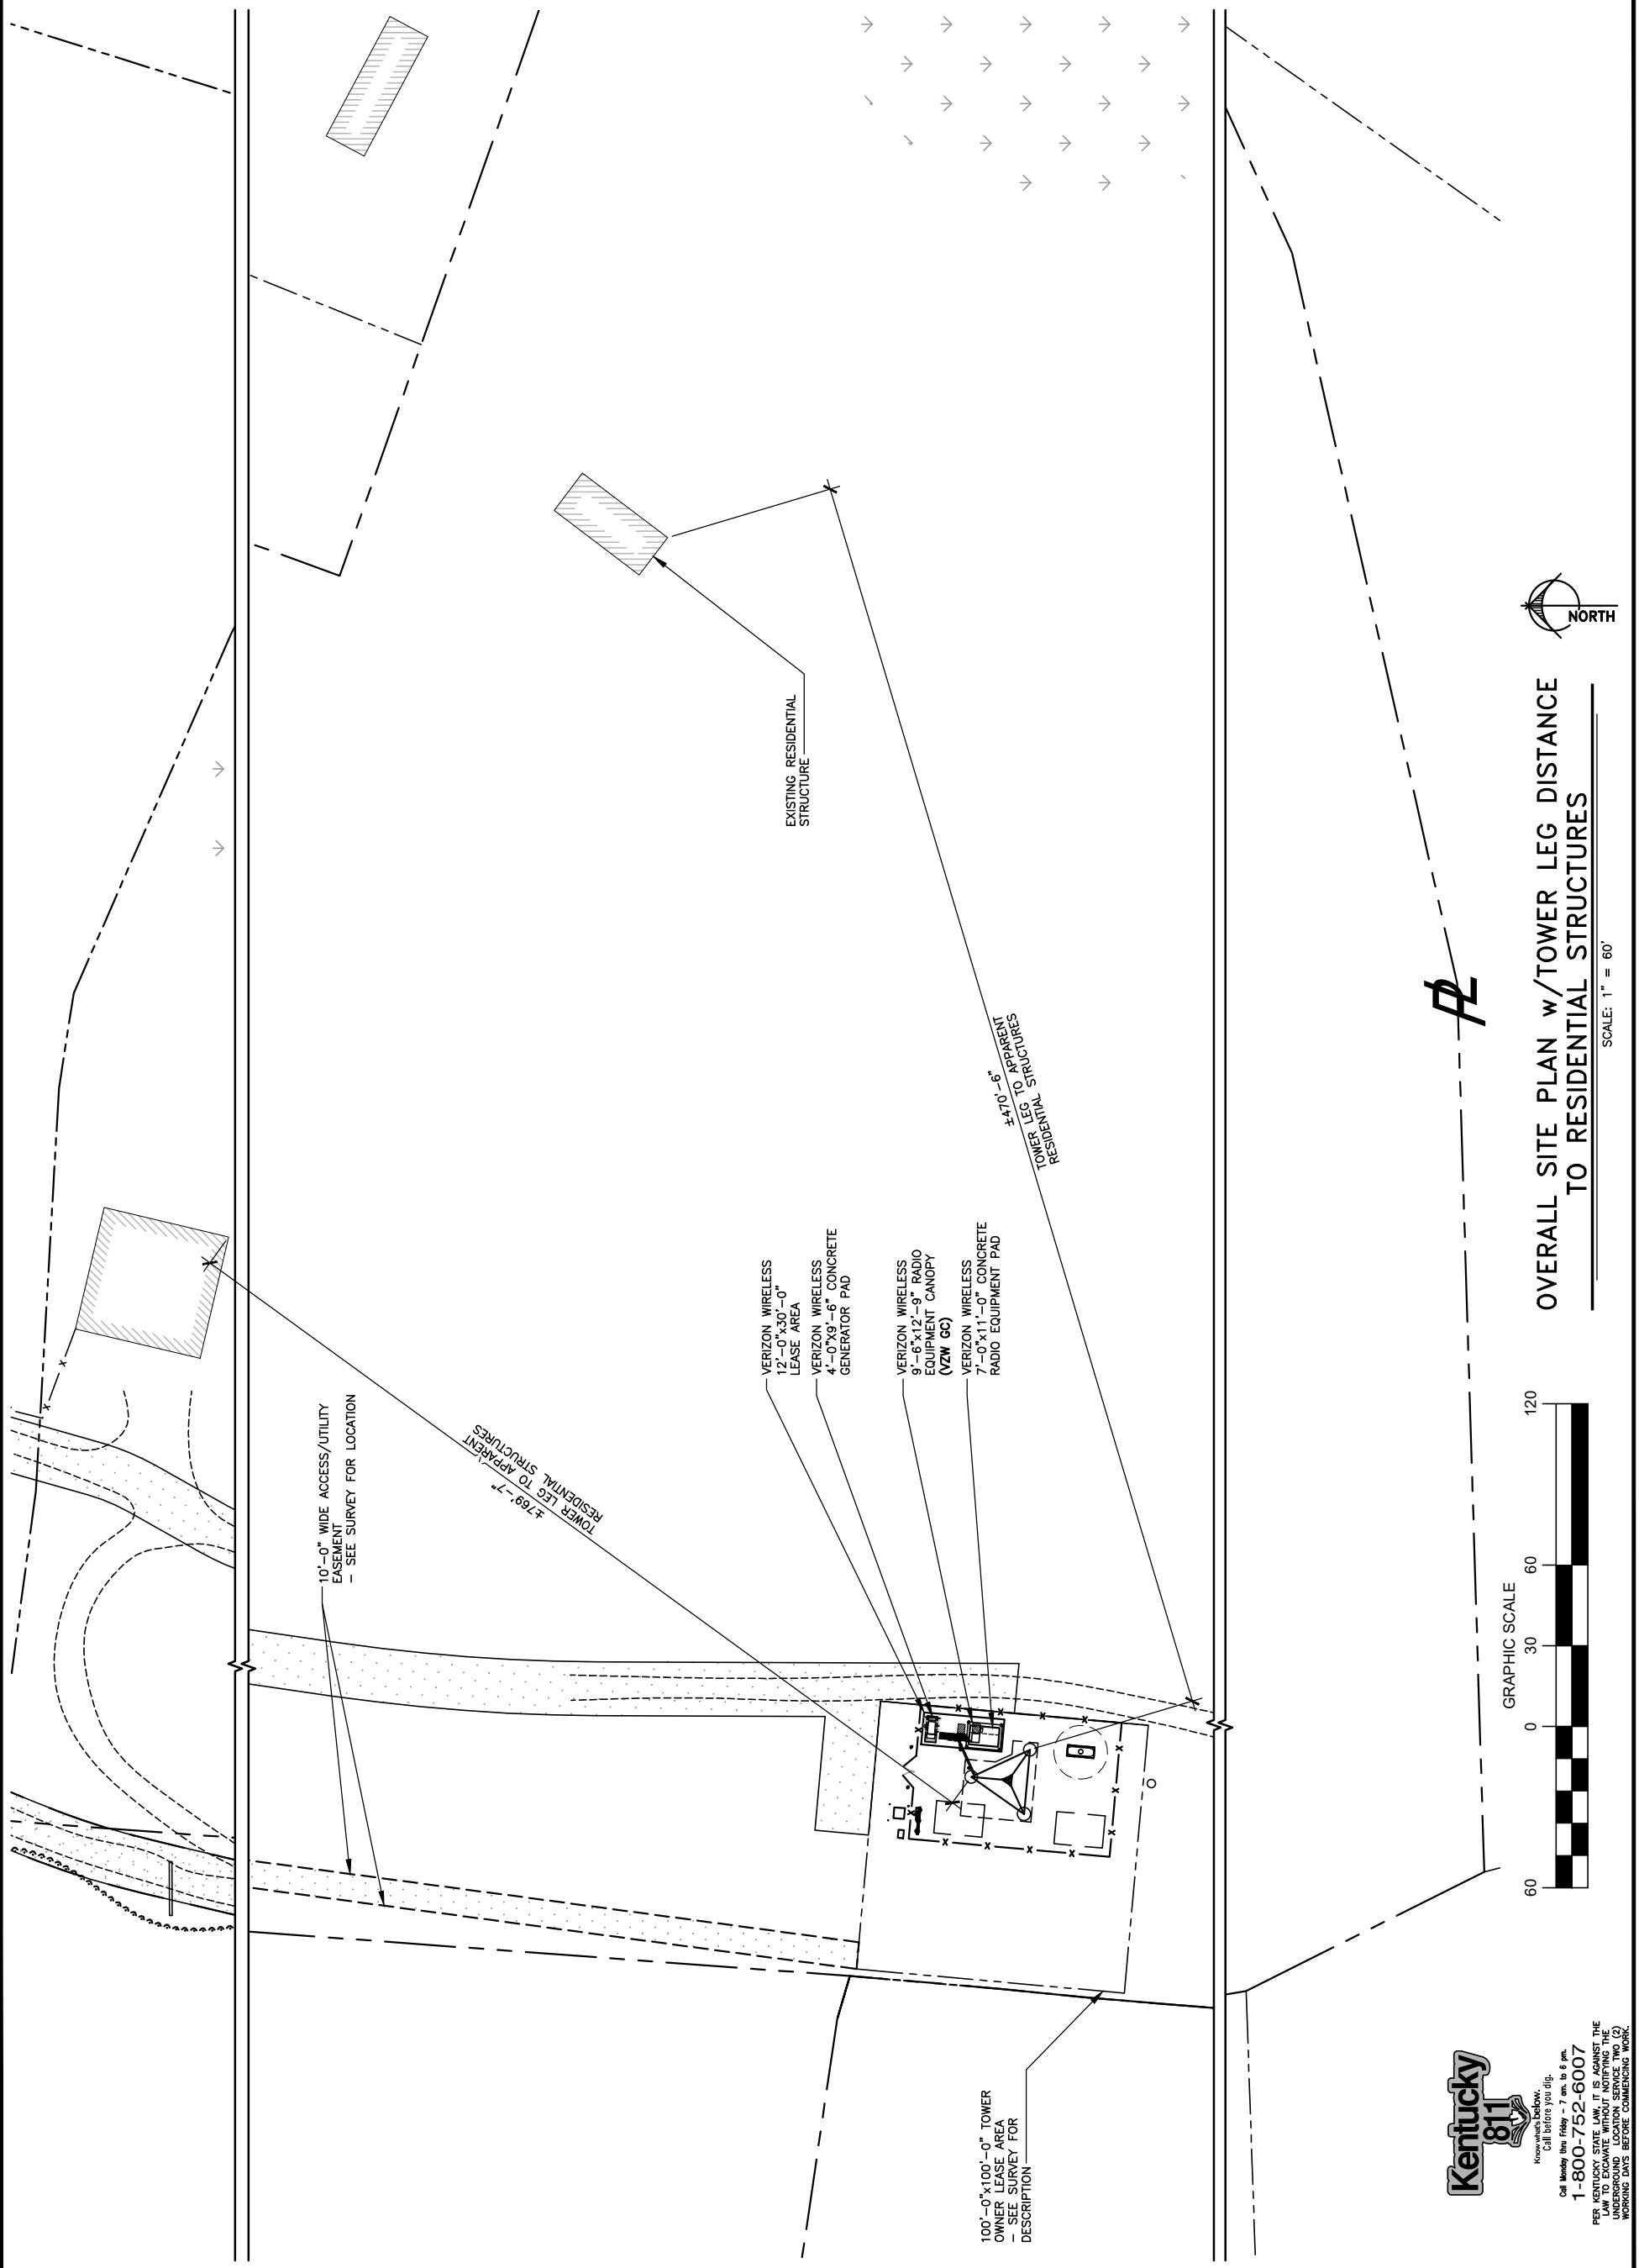



250E 96TH ST, STE 175
INDIANAPOLIS, IN 46240-3753

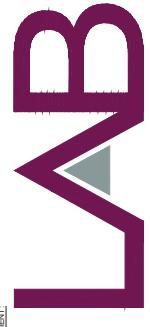

49030 PONTIAC TRAIL, SUITE 400
WIXOM, MICHIGAN 48393
PHONE: (248) 705-9212



3840 E. ROBINSON ROAD
AMHERST, NY 14228
WWW.ALBULENG.COM



BWHTN REBOL
RY LICENSE NO. 25093

REF#	DATE	DESCRIPTION	DRAWN BY	CHECKED BY
4	12/16/23	REVISED PER SITE CONDITIONS	YAY	AAN
3	10/27/23	REVISED PER SITE CONDITIONS	YAY	AAN
2	08/06/23	REVISED PER SITE CONDITIONS	YAY	AAN
1	07/31/23	ISSUED FOR CONSTRUCTION	YAY	AAN
0	03/17/23	PRELIMINARY	YAY	AAN

IV MONTVERNON EAST

721772

321 FROSTY HOLLOW ROAD
MT VERNON, KY 40456
ROCK CASTLE COUNTY

33746 | AB GDP C47049 2
OBJECT NUMBER:

GRADING & EROSION
CONTROL OVERALL PLAN


UNDERGROUND ELECTRICAL CONDUIT
PROPOSED DITCH
PROPOSED SPOT ELEV

EROSION AND SEDIMENT CONTROL LEGEND

SF ————— SF —————	(SF)	PROPOSED SILT FENCE
LOD ————— LOD —————		LIMITS OF DISTURBANCE


GRADING & EROSION CONTROL OVERALL PLAN

1

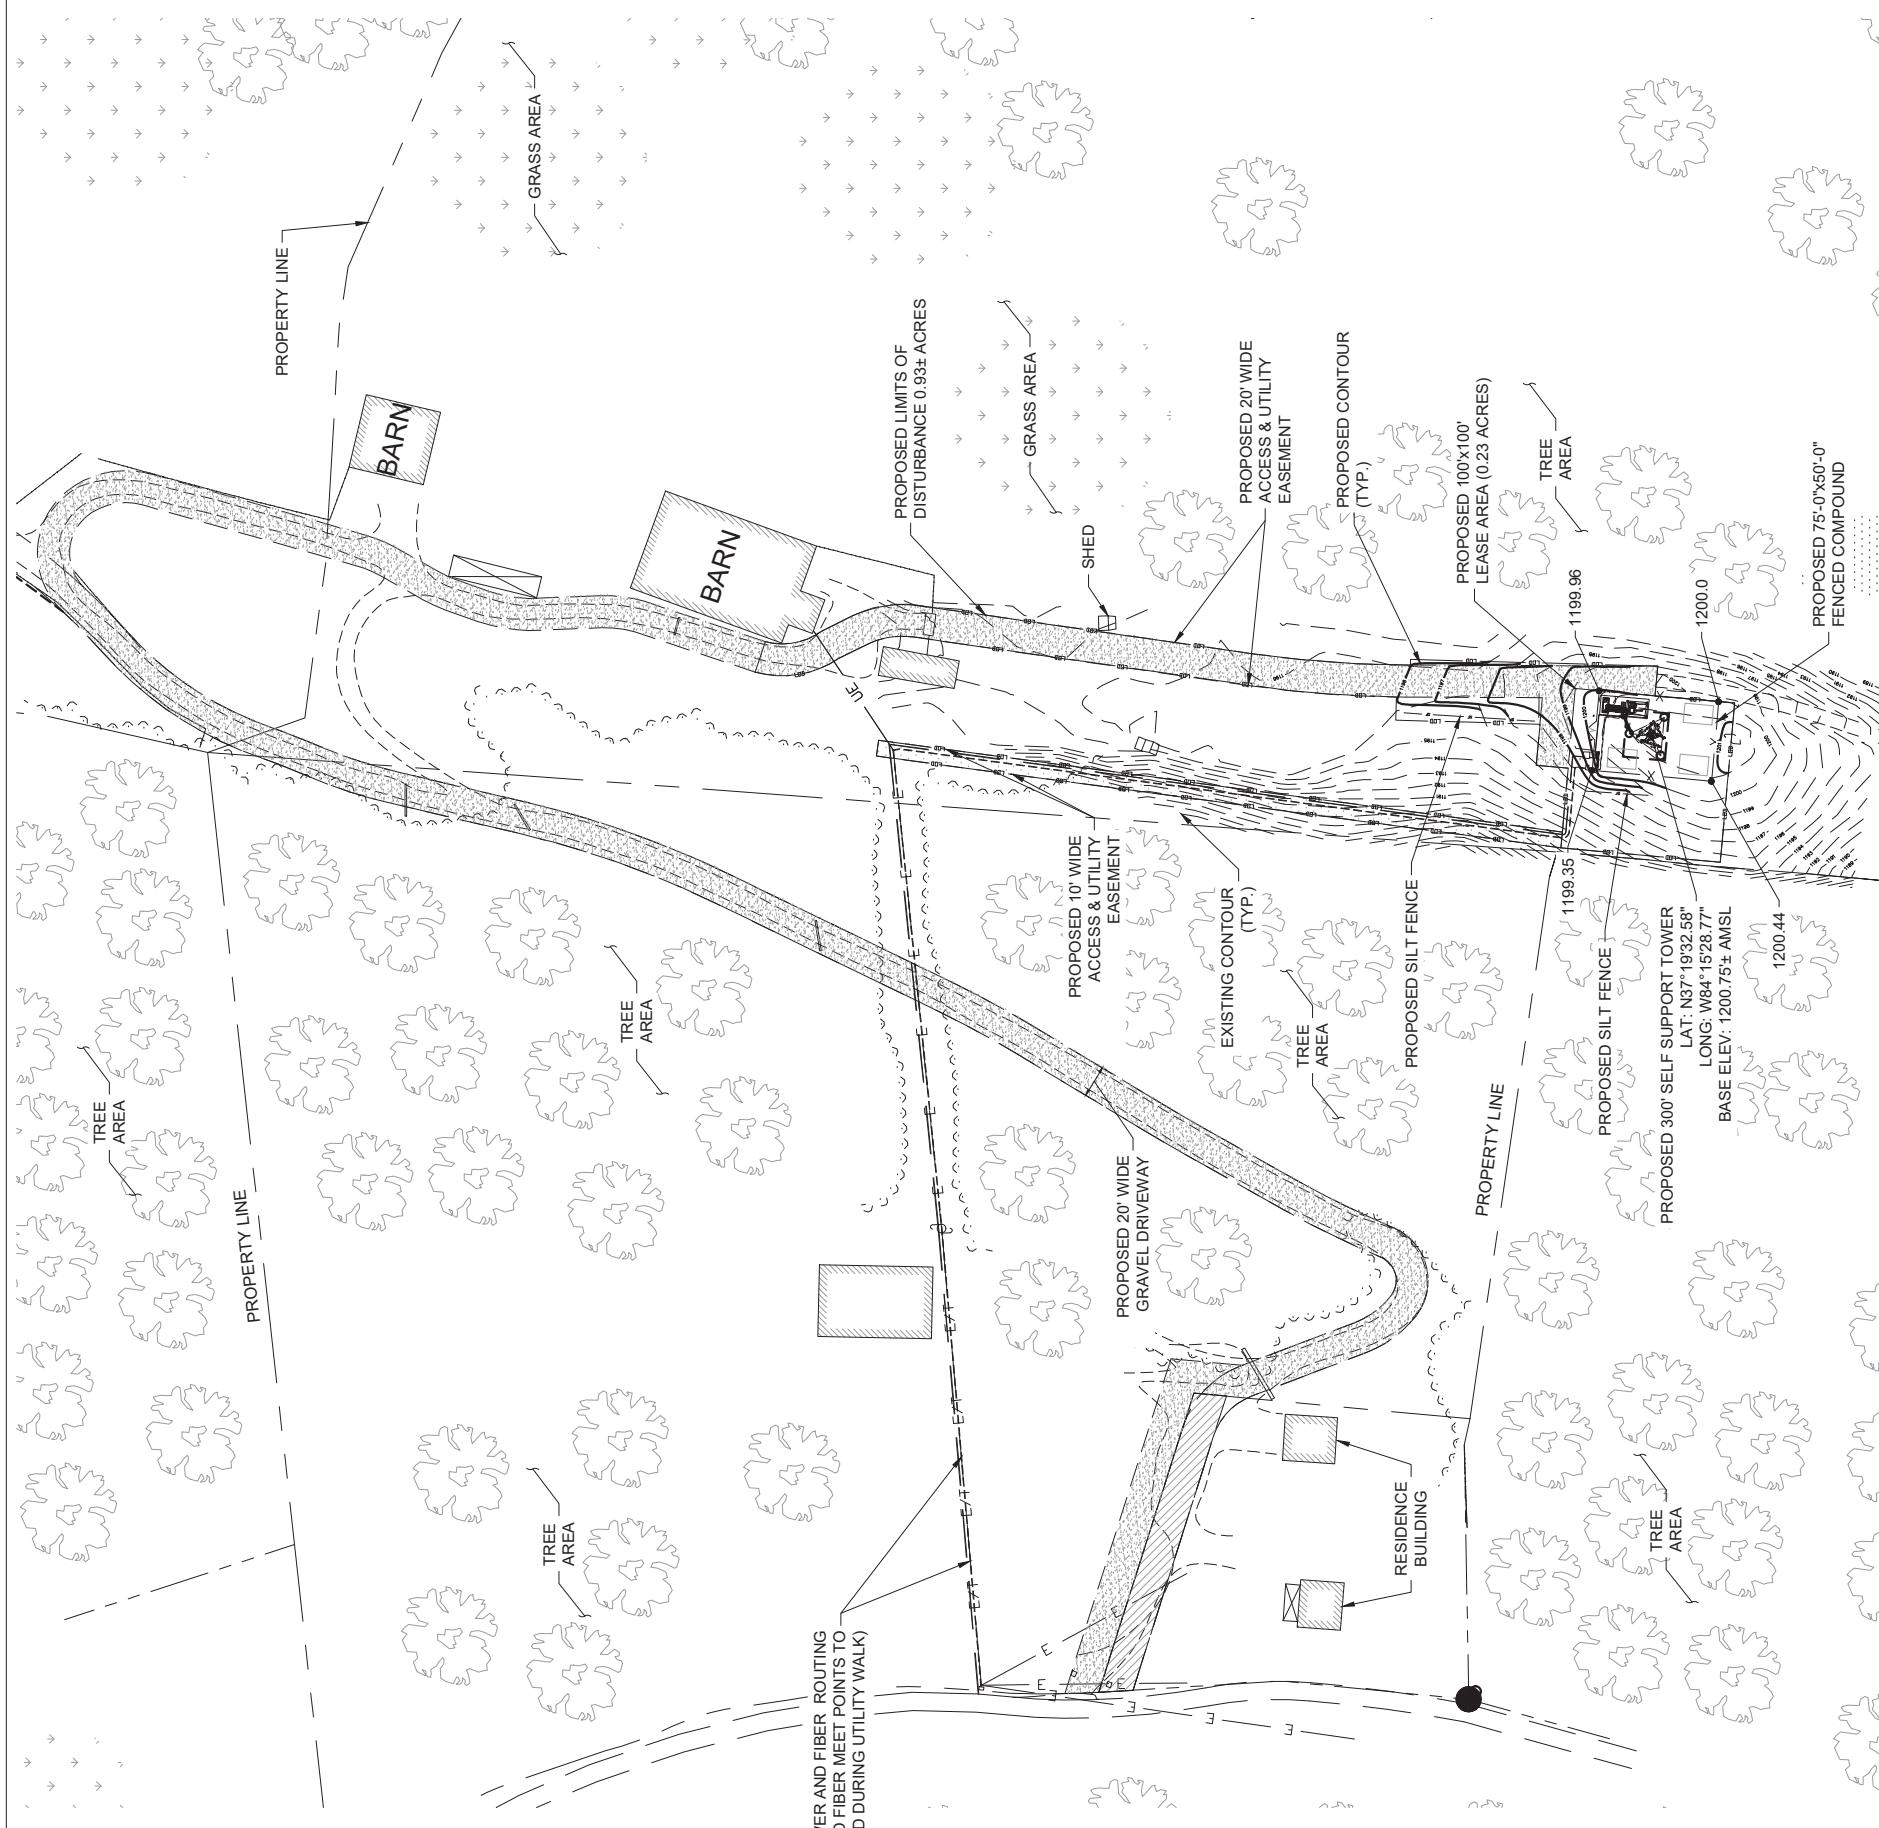

verizon

250E 96TH ST, STE 175
INDIANAPOLIS, IN 46240-3753

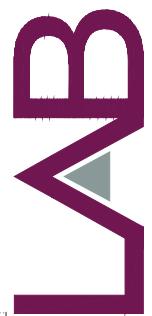

49030 PONTIAC TRAIL, SUITE 400
WIXOM, MICHIGAN 48393
PHONE: (248) 705-9212

ALBUL ENGINEERING

3840 E. ROBINSON ROAD
AMHERST, NY 14228
WWW.ALBULENG.COM



KY LICENSE NO. 25093

12-15-2023

DMITRY ALBUL

PROFESSIONAL ENGINEER

LICENSEE NO. 25093

STATE OF KENTUCKY

DMITRY V.

ALBUL

25093

PROFESSIONAL


ENGINEER

LICENSEE NO. 25093

DMITRY ALBUL

PROFESSIONAL

ENGINEER

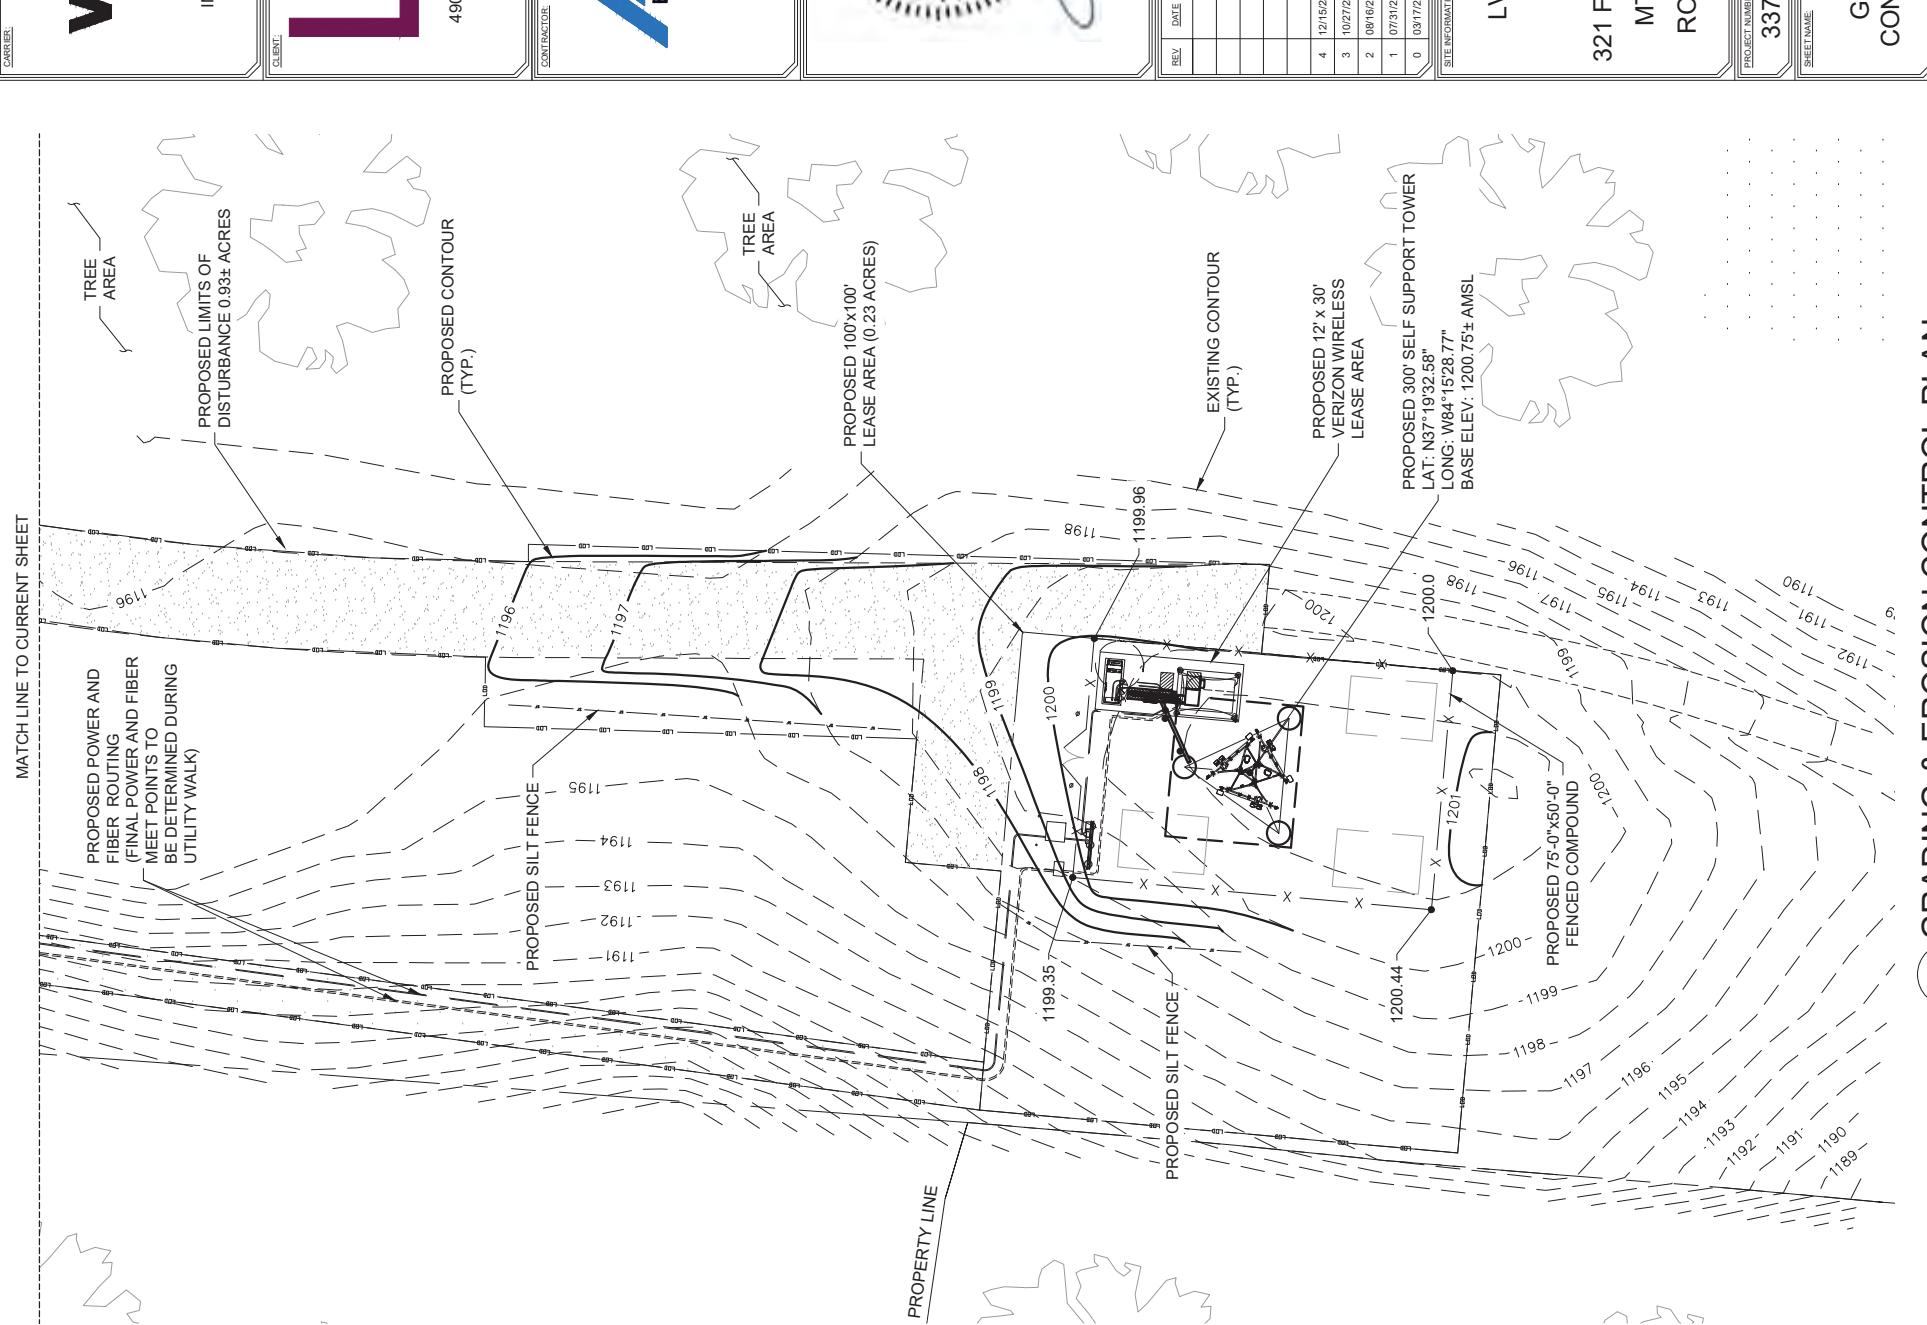

3 GRADING & EROSION CONTROL PLAN

2 GRADING & EROSION CONTROL PLAN

MATCH LINE TO CURRENT SHEET

MATCH LINE TO CURRENT SHEET

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TAG
TOWERS
108 PORTIAC TRAIL, SUITE 1
RICHMOND, KY 40475
859-544-5000 (PH)

LAB

49030 Portiac Trail, Suite 100
Wixom, Michigan 48393
PHONE: (248) 705-9212


REV.	DATE	DESCRIPTION
A	08/04/23	ISSUED FOR REVIEW
B	08/16/23	ISSUED FOR REVIEW
C	11/16/23	REVISED FOR CONSTRUCTION
D	12/27/23	ISSUED FOR REVIEW



SITE INFORMATION:
LV MT VERNON EAST
321 FROSTY HOLLOW ROAD
MT VERNON, KY 40456
ROCK CASTLE COUNTY

SITE NUMBER:
721772
SITE NAME:
LV MT VERNON EAST
PID NUMBER: 16913443
DRAWN BY: RC
CHECKED BY: PL
DATE: 10/25/23
SHEET TITLE:

DETAILED SITE PLAN
SHEET NUMBER:
C — 3
WK PAD & CANOPY REV 3 FINAL 10/16/23

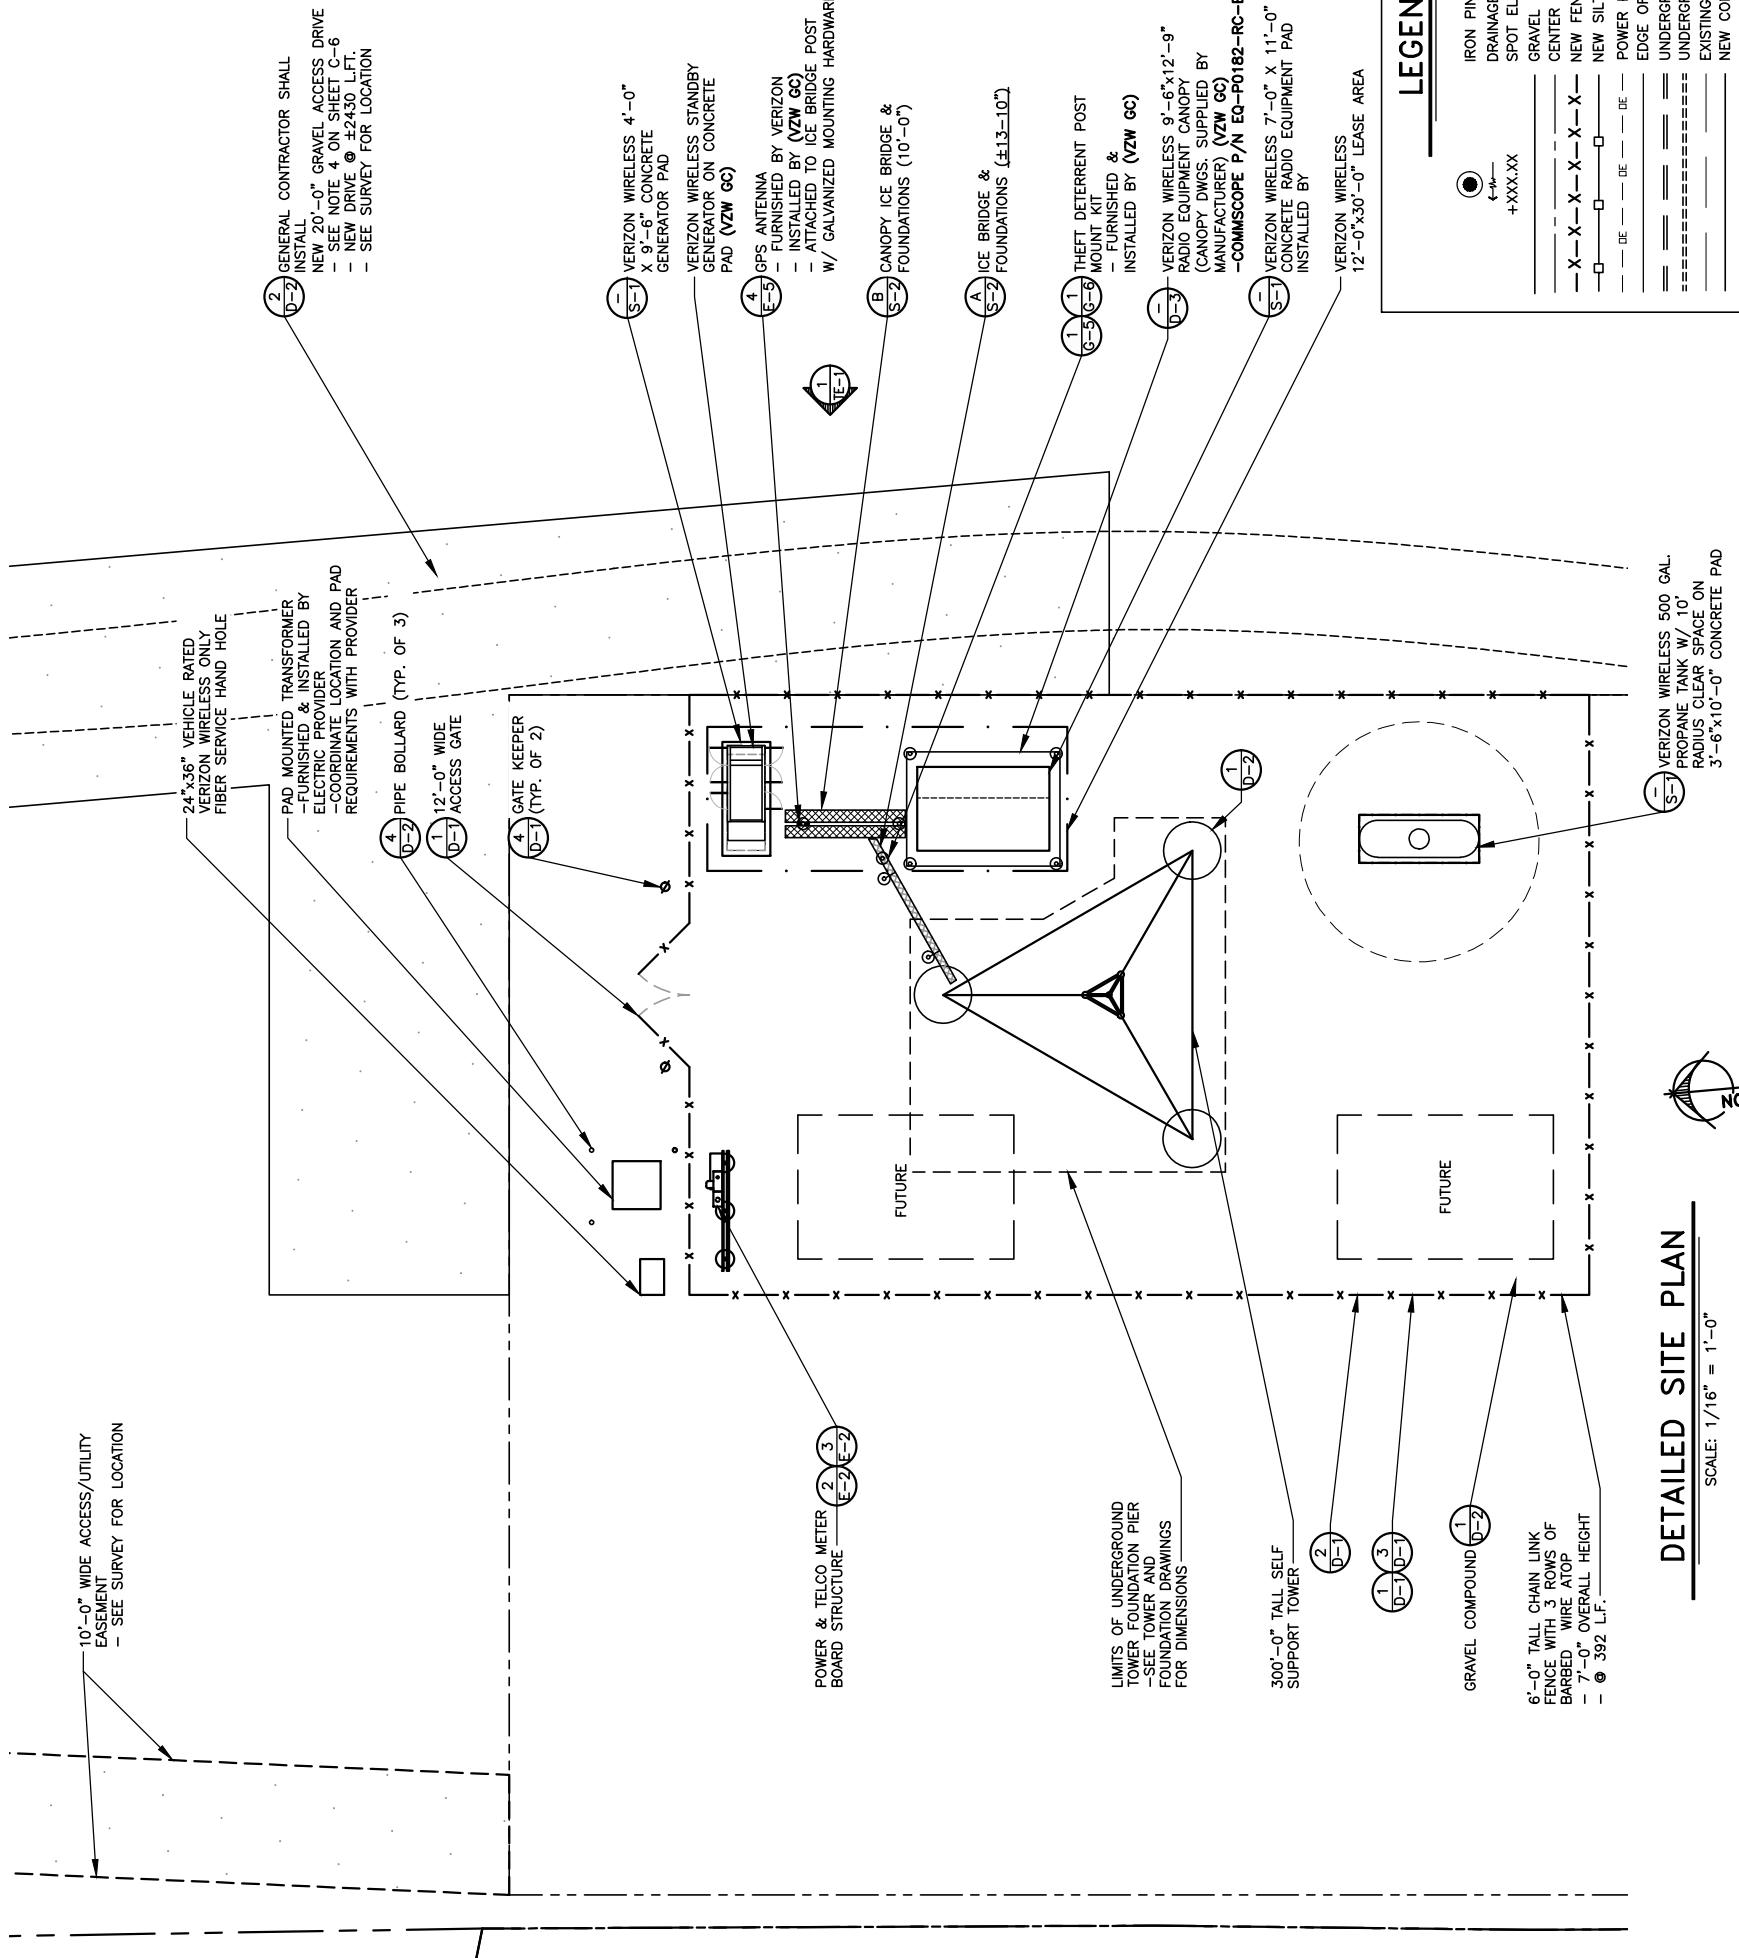

DETAILED SITE PLAN

SCALE: 1/16" = 1'-0"

*NOTE:
GENERAL CONTRACTOR IS TO ENSURE THERE IS NO DISTURBANCE OF PROPERTY, SOIL, ETC., OUTSIDE OF THE STAKED LEASE AREA WITHOUT APPROVAL FROM VERIZON WIRELESS CONSTRUCTION MANAGER



Kentucky 811
Call before you dig.
Call Monday thru Friday - 7 am to 6 pm.
1-800-752-6007
PER KENTUCKY STATE LAW, IT IS AGAINST THE LAW TO EXCAVATE WITHOUT NOTIFYING THE UNDERGROUND LOCATION SERVICE TWO (2) WORKING DAYS BEFORE COMMENCING WORK.

GENERAL SITE CONSTRUCTION NOTES

1. SCHEDULE:

THE CONSTRUCTION OF THE SITE REQUIRES A CERTAIN SEQUENCE OF EVENTS TO MINIMIZE CONSTRUCTION TIME REQUIRED UNTIL AVAILABILITY OF CELLULAR TELEPHONE SERVICE. VERIFY SCHEDULE DURING BID WALK.

2. TOWER OWNER REPRESENTATIVE:

TAG TOWERS, LLC
108 FORBES COURT, SUITE 1
RICHMOND, KY 40475
PHONE: (859) 544-5000

3. ANTENNA INSTALLATION:

THE VERIZON WIRELESS CONTRACTOR (VZW GC) INSTALLING THE FRAME/PLATFORM SHALL ENSURE THAT THE PLATFORM IS ALIGNED BASED ON THE VERIZON WIRELESS RF PLAN. DURING THIS WORK, THE GENERAL CONTRACTOR SHALL BE LIMITED TO THE WORK WHICH CAN BE PERFORMED OUTSIDE THE TOWER.

4. ACCESS DRIVENAY:

THE GENERAL CONTRACTOR SHALL CONSTRUCT THE ACCESS DRIVE PER THE ALIGNMENT SHOWN ON THESE DRAWINGS. IF ANY AREA OF CONSTRUCTION REQUIRES ADDITIONAL FILL OF AGGREGATE, STONE, THAN SHOWN ON THE DRAWINGS, THE GENERAL CONTRACTOR SHALL NOTIFY THE ENGINEER FOR APPROVAL OF THE SIZE, TYPE AND QUANTITY OF STONE/FILL NECESSARY AND SHALL NOT BE USED UNTIL APPROVAL BY THE ENGINEER. THE GENERAL CONTRACTOR SHALL ALSO OBTAIN DRIVE PERMIT FOR NEW ACCESS DRIVE.

5. PREFABRICATED EQUIPMENT CABINETS, CANOPY, AND GENERATOR:

THIS VERIZON WIRELESS CONTRACTOR (VZW GC) SHALL PROVIDE ALL LABOR, EQUIPMENT AND MATERIALS FOR THE PROPER LIFTING, TRANSPORTING AND ASSEMBLY OF THE PREFABRICATED EQUIPMENT CANOPY FROM THE TRANSPORT TRUCK BED TO THE FINAL POSITION. THE EQUIPMENT CABINETS SHALL BE LIFTED INTO PLACE ON THE CONCRETE EQUIPMENT PAD. THE GENERATOR SHALL BE LIFTED INTO PLACE BY USING TWO SPREADER BAR ASSEMBLIES. EACH SPREADER BAR SHALL BE A MINIMUM 3' WIDE (RADAR TO CARRY 3 TONS). THE GENERATOR WEIGHT IS 1,425# WITH TANK PEDESTAL. VERIZON WIRELESS CONTRACTOR (VZW GC) SHALL ANCHOR THE EQUIPMENT CABINETS AND GENERATOR BASE TO THE CONCRETE SLAB USING ANCHOR BOLTS. EXTREME CAUTION SHALL BE TAKEN IN THE INSTALLATION OF ALL EQUIPMENT TO AVOID CONTACT WITH EXISTING OVERHEAD UTILITY LINES.

THE VERIZON WIRELESS CONTRACTOR (VZW GC) IS RESPONSIBLE FOR ATTACHING, SECURING OR ASSEMBLING ANY ACCESSORY OR LOOSE ITEMS THAT ARE SHIPPED WITH THE PREFABRICATED EQUIPMENT CABINETS, CANOPY AND GENERATOR AND SHALL INCLUDE THIS WORK IN THE VZW EQUIPMENT INSTALLATION PORTION OF THE BID.

6. UTILITIES:

THE CONTRACTOR SHALL BE RESPONSIBLE FOR THE EXCAVATION AND PROPER BACKFILLING OF TRENCHES AND SUPPLY CONDUIT REQUIRED FOR UNDERGROUND TELEPHONE & ELECTRICAL UTILITIES. ALL TRENCHING SHALL BE COMPACTED TO 95% MAXIMUM DRY DENSITY IN ACCORDANCE W/ASTM D-1557.

THE CONTRACTOR SHALL RUN AN ELECTRICAL TRENCH WITH 2 1/2" CONDUIT AND DETECTABLE FULL TAPE FROM THE NEW RADIO EQUIPMENT PAD AND END AT THE NEW METER BOARD STRUCTURE. THE CONTRACTOR SHALL THEN RUN (2) TWO 4" CONDUIT WITH PULL TAPE FROM THE METER BOARD TO THE NEW PAD MOUNTED TRANSFORMER LOCATION AND STUB UP 6" ABOVE GRADE. THE ELECTRICAL PROVIDER WILL THEN RUN UNDERGROUND CONDUIT FROM THE NEW TRANSFORMER TO THE NEW UTILITY POLE, CONTACT ---@###-####-####, WITH 22222222 BEFORE BEGINNING CONSTRUCTION TO VERIFY LOCATION, CONDUIT AND CONDUIT, CONDUITS MUST HAVE A MINIMUM DEPTH OF 36". CONTRACTOR SHALL CONTACT ELECTRIC PROVIDER TO HAVE TRENCH AND CONDUIT INSPECTED BEFORE THE TRENCH IS COVERED. THE ELECTRICAL PROVIDER SHALL SUPPLY SERVICE TO THE NEW METER BOARD STRUCTURE. THE CONTRACTOR SHALL CONTACT ---@###-####-#### ENERGY TO SETUP AN INSPECTION OF THE TRENCHES BEFORE THEY ARE BACKFILLED. THE CONTRACTOR SHALL PROPER BACKFILL THE TRENCHES AFTER INSPECTION AND SETTLEMENT. CONTACT ELECTRIC PROVIDER THREE TO FOUR WEEKS PRIOR TO CONSTRUCTION FOR NEW SERVICE AND COORDINATION OF ACCESS TO SITE. THE CONTRACTOR SHALL CONTACT ----- FOR A COPY OF THEIR SPECIFICATIONS BEFORE CONSTRUCTION.

THE TOWER OWNER SHALL ENSURE PERMANENT ELECTRIC POWER IS AVAILABLE FOR VERIZON WIRELESS AT THE METER BASE PRIOR TO THE SITE BEING RELEASED TO VERIZON WIRELESS AS TENANT READY.

THE VERIZON WIRELESS GENERAL CONTRACTOR (VZW GC) SHALL RUN ELECTRICAL CONDUCTORS FROM NEW METER CENTER TO NEW VZW INTEGRATED LOAD CENTER WITHIN METER INSTALLED.

THE VERIZON WIRELESS GENERAL CONTRACTOR (VZW GC) SHALL BE RESPONSIBLE FOR THE ORDERING AND COORDINATING THE DELIVERY OF A FIBER OPTIC SERVICE LINE TO THE RADIO EQUIPMENT ENCLOSURE. COORDINATE WITH THE FIBER PROVIDER AND THE VERIZON WIRELESS FACILITY ENGINEER.

1. ONE 4" SIDR-11.5 HDPE FIBER CONDUITS w/INTEGRATED INNERDUCTS SHALL BE INSTALLED FROM HANDHOLE OUTSIDE COMPOUND MEET POINT AT THE PUBLIC MODEL RIGHT-OF-WAY WITHIN UTILITY EASEMENT WITH PULL TAPE THE HANDHOLE MODEL AS FOLLOWS:

- THE VERIZON FIBER CONDUIT HANDHOLES SHALL BE OLDCASTLE INFRASTRUCTURE SYSTEM'S MODEL PG2436-30 T22 SW 0B 24x36" VERIZON V APPROVED EQUALS ALTERNATIVE CONDUITS MAY BE USED IF MEETING THE DESIGNATED LOADING AND HAVING DIMENSIONS OF AT LEAST 2x3x2.5'. ALL VERIZON HANDHOLES TO HAVE "VERIZON" LOGO ON COVER.
- THE GENERAL USE FIBER CONDUIT HANDHOLE SHALL BE A MODEL AS APPROVED BY THE CONSTRUCTION MANAGER.
- 2. SO THAT SPACING BETWEEN HANDHOLES IS NO GREATER THAN 50 FEET.
- 3. CONTRACTOR SHALL PLACE (1) COPPERHEAD INDUSTRIES ORANGE TRACER WIRE CONDUIT(S).
- 4. ONE 4" SIDR-11.5 HDPE FIBER CONDUIT w/INTEGRATED INNERDUCTS SHALL BE INSTALLED FROM VERIZON WIRELESS EQUIPMENT PAD LOCATION (PER PLANS)

ELECTRIC SERVICE PROVIDED BY:
?????? POWER ADDRESS: STREET ADDRESS
CITY, ST ZIP CODE
CONTACT: TBD
PHONE: TBD
EMAIL: TBD

2. CONTRACTOR'S LICENSE:

THE GENERAL CONTRACTOR, VERIZON WIRELESS GENERAL CONTRACTOR (VZW GC) AND ALL OF THEIR SUBCONTRACTORS THAT DO ANY WORK ON THIS PROJECT SHALL BE CURRENTLY LICENSED TO PERFORM WORK IN THE LOCATION OF THIS SITE. PROOF OF LICENSES SHALL BE SUPPLIED TO VERIZON WIRELESS PRIOR TO THE COMMENCEMENT OF ANY WORK.

12. SEEDING:

ALL DISTURBED AREAS SHALL BE REPAVED AND SEEDED BY THE GENERAL CONTRACTOR, UNLESS OTHERWISE AGREED. SEED DISTURBED AREAS W/4 POUNDS/1000 SQ. FT. - 60% KENTUCKY BLUEGRASS, 18% CREEPING RED FESCUE, 22% ANNUAL RYEGRASS.

13. TRAFFIC CONTROL:

THE CONTRACTOR SHALL FURNISH, INSTALL AND MAINTAIN ALL REQUIRED TRAFFIC CONTROL DEVICES IN ACCORDANCE WITH THE MANUAL OF UNIFORM TRAFFIC CONTROL DEVICES OR GOVERNING LOCAL AGENCIES.

14. CONSTRUCTION STAKING:

THE CONTRACTOR SHALL BE RESPONSIBLE FOR ALL CONSTRUCTION STAKING NEEDED TO COMPLETE ALL THE CONSTRUCTION SHOWN HEREON. CONTACT DESIGN ENGINEER TO SCHEDULE CONSTRUCTION STAKING.

15. THE CONTRACTOR SHALL BE RESPONSIBLE FOR ANY DAMAGE TO EXISTING PROPERTY RESULTING FROM THE CONSTRUCTION ACTIVITIES, INCLUDING BUT NOT LIMITED TO PAVEMENT, FINISHED GRADES, LANDSCAPING, BUILDINGS, SURVEY MARKERS, FIELD TILES, CULVERTS, ETC.

16. IN THE EVENT ANY DISCREPANCIES OR ERRORS ARE FOUND ON THESE PLANS OR ANY CONFICTS OR PROBLEMS ARE ENCOUNTERED DURING CONSTRUCTION, THE GENERAL CONTRACTOR OR VERIZON WIRELESS GENERAL CONTRACTOR (VZW GC) SHALL NOTIFY THE ENGINEER BEFORE PROCEEDING WITH THE WORK. NO ADDITIONAL COMPENSATION WILL BE PAID TO THE GENERAL CONTRACTOR OR VERIZON WIRELESS GENERAL CONTRACTOR (VZW GC) FOR WORK HAVING TO BE REDONE FOR GRADE OR GEOMETRIC DISCREPANCIES IF NOTICE TO THE ENGINEER HAS NOT BEEN PROVIDED. THE ENGINEER RESERVES THE RIGHT TO MAKE MINOR ADJUSTMENTS AS NECESSARY TO ACCOMPLISH THE INTENT OF THESE PLANS.

17. ALL SITE WORK AND CONSTRUCTION SHALL CONFORM TO ANY AND ALL APPLICABLE CODES AND VERIZON WIRELESS STANDARDS AND SPECIFICATIONS.

18. ALL ELEVATIONS AND TOPOGRAPHIC INFORMATION WAS TAKEN FROM A SURVEY SHIPPED TO A&E FIRM BY SURVEYING FIRM. A&E FIRM HAS NOT VERIFIED THIS INFORMATION AND DOES NOT WARRANT ANY INFORMATION SUPPLIED BY OTHERS.

19. THE GENERAL CONTRACTOR SHALL MAINTAIN A COMPLETE AS-BUILT SET OF PLANS AND CONDITIONS, AND SUBMIT SAME TO THE ENGINEER WITHIN 7 DAYS OF COMPLETION OF CONSTRUCTION, AS-BUILT PLANS SUBMITTED TO THE ENGINEER UNDERGROUND UTILITIES, GROUNDING GRID, EQUIPMENT PAD, TOWER PLATEFORM ORIENTATION, AND FENCE WITHIN THE LEASE AREA OR PROPERTY AND BE CERTIFIED BY A LICENSED PROFESSIONAL SURVEYOR.

20. THE GENERAL CONTRACTOR AND VERIZON WIRELESS GENERAL CONTRACTOR (VZW GC) SHALL BE RESPONSIBLE FOR NOTIFICATION OF ALL GOVERNING AGENCIES THAT REQUIRE SITE INSPECTION OF THE WORK AND/OR SIMPLY NOTIFICATION.

21. THE GENERAL CONTRACTOR AND VERIZON WIRELESS GENERAL CONTRACTOR (VZW GC) THAT REQUIRE SITE INSPECTION OR TESTING OF THE WORK AS DIRECTED IN THESE PLANS, GOVERNING AGENCIES AND ALL APPLICABLE CODES.

22. PRIOR TO THE SUBMISSION OF BIDS, THE GENERAL CONTRACTOR AND HIS SUBCONTRACTORS SHALL VERIFY THE DRAWINGS AND SCHEDULES ON THE DRAWINGS AND SPECIFICATIONS PROVIDED BY THE OWNER, FOR MEANING OF ABBREVIATIONS AND ADDITIONAL REQUIREMENTS AND INFORMATION, CHECK ALL CONSTRUCTION DOCUMENTS TO INCLUDE, BUT NOT LIMITED TO, GEOTECHNICAL REPORT, STRUCTURAL ANALYSIS, TOWER, MECHANICAL AND ELECTRICAL DRAWINGS, FOR SCALE, SPACE LIMITATIONS, DOOR SWINGS, ADJACENT EQUIPMENT COORDINATION AND ADDITIONAL INFORMATION, ETC. REPORT ANY DISCREPANCIES, CONFLICTS, ETC. TO THE OWNER BEFORE SUBMITTING BIDS.

24. WORK SITE SAFETY:

A. CONTRACTOR AND VERIZON WIRELESS CONTRACTOR (VZW GC) ARE RESPONSIBLE TO EDUCATE THEIR WORK FORCE OF THE DANGERS AND LIMIT THEIR EXPOSURE TO HAZARDS. THIS EDUCATION SHALL INCLUDE BUT NOT BE LIMITED TO APPROPRIATE TRAINING COURSES AND CERTIFICATIONS, PROPER PERSONAL PROTECTIVE EQUIPMENT USAGE, DAILY TAILGATE MEETINGS AND ANY OTHER PROTECTIVE MEASURES WHICH MAY BE REASONABLY EXPECTED.

B. ALL CONTRACTOR AND VERIZON WIRELESS CONTRACTOR (VZW GC) AND ALL SUB-CONTRACTORS SHALL BE RESPONSIBLE FOR THE SAFETY OF THE WORK AREA, ADJACENT AREAS AND ANY PROPERTY OCCUPANTS WHO MAY BE AFFECTED BY THE WORK UNDER CONTRACT. ALL CONTRACTORS SHALL REVIEW ALL LANDOWNER, PRIME CONTRACTOR, CARRIER, OSHA AND LOCAL SAFETY GUIDELINES AND AT ALL TIMES SHALL CONFORM TO THE MOST RESTRICTIVE OF THESE STANDARDS TO ENSURE A SAFE WORKPLACE.

C. TOWER WORK PRESENTS ADDITIONAL THREATS TO HEALTH AND SAFETY. ALL TOWER WORKERS WORKING ON A TOWER MUST BE ADEQUATELY TRAINED AND MONITORED TO ENSURE THAT SAFE WORK PRACTICES ARE LEARNED AND FOLLOWED. EMPLOYEES MUST BE PROVIDED WITH APPROPRIATE FALL PROTECTION, TRAINED TO USE THIS FALL PROTECTION PROPERLY, AND THE USE OF FALL PROTECTION MUST BE CONSISTENTLY SUPERVISED AND ENFORCED BY THE CONTRACTOR.

C. ALL SAFETY EQUIPMENT SHALL BE INSPECTED ACCORDING TO ALL OSHA AND INDUSTRY SCHEDULED INTERVALS AND ALL INSPECTIONS SHALL BE DOCUMENTED PER APPLICABLE CODES AND STANDARDS.

D. TOWER WORKERS WORKING ON A TOWER MUST BE ADEQUATELY TRAINED AND MONITORED TO ENSURE THAT SAFE WORK PRACTICES ARE LEARNED AND FOLLOWED. EMPLOYEES MUST BE PROVIDED WITH APPROPRIATE FALL PROTECTION, TRAINED TO USE THIS FALL PROTECTION PROPERLY, AND THE USE OF FALL PROTECTION MUST BE CONSISTENTLY SUPERVISED AND ENFORCED BY THE CONTRACTOR.

10. EXCAVATION OF UTILITIES:

SITE INFORMATION:

LV M T VERNON EAST
321 FROSTY HOLLOW ROAD
MT VERNON, KY 40456
ROCK CASTLE COUNTY

SITE NUMBER:

721772

SITE NAME:

LV M T VERNON EAST

PID NUMBER:

16913443

DRAWN BY:

RC

CHECKED BY:

PL

DATE:

10/25/23

TAG
TOWERS
5

108 FORBES COURT, SUITE 1
RICHMOND, KY 40475
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108 FORBES COURT, SUITE 1
R

EROSION & SEDIMENT CONTROL NOTES

- ALL WORK SPECIFIED AS A/AN DOT ITEM SHALL BE GOVERNED BY THE STATE OF INDIANA DEPARTMENT OF TRANSPORTATION CONSTRUCTION AND MATERIAL SPECIFICATION HANDBOOK. IT IS CONTRACTORS RESPONSIBILITY TO POSSESS AND BE FAMILIAR WITH APPLICABLE SECTIONS.
- THIS CONTRACT DRAWING SHALL BE MADE AVAILABLE ON SITE AT ALL TIMES AND PRESENTED UPON REQUEST. IF UNFORESEEN STORM WATER POLLUTION PREVENTION IS ENCOUNTERED, ADDITIONAL STORM WATER POLLUTION PREVENTION (SWPP) MEASURES MAY BE REQUESTED BY THE OWNER, COUNTY ENGINEER, PROJECT ENGINEER OR SOIL CONSERVATION REPRESENTATIVE AT ANYTIME. SUCH REQUESTS SHALL BE IMPLEMENTED IMMEDIATELY AT CONTRACTOR'S EXPENSE.
- ALL STORM WATER POLLUTION PREVENTION ITEMS SHALL BE INSTALLED AS SHOWN OR NOTED ON THIS SHEET.
- PLANT TEMPORARY SEEDING AND MULCHING IN ALL AREAS THAT SHALL BE INACTIVE FOR 7 DAYS OR MORE. ALL DISTURBED OR ERODED EARTH SHALL BE REGRADED AND SEEDED WITHIN 14 DAYS WITH SEEDING AS DEFINED ABOVE AND AS SHOWN ON THE TABLE BELOW. TO ESTABLISH STABILITY AND PROVIDE SEDIMENT CONTROL WHERE POSSIBLE, TEMPORARY SEEDING GROWTH SHALL NOT BE MOVED UNTIL IT HAS GONE TO SEED FOR 1 YEAR.

LAB

49030 Portia Trail, Suite 100
Wixom, Michigan 48393
PHONE: (248) 705-9212



REV.	DATE	DESCRIPTION	JAN. FEB. MAR. APR. MAY JUN. JUL. AUG. SEP. OCT. NOV. DEC.
-	1/22/23	ISSUED FOR REVIEW	
0	1/16/23	REVISED FOR CONSTRUCTION	
B	08/04/23	ISSUED FOR REVIEW	
A	08/04/23	DESCRIPTIVE	



SITE INFORMATION:
LV MT VERNON EAST
321 FROSTY HOLLOW ROAD
MT VERNON, KY 40456
ROCK CASTLE COUNTY

SITE NAME:
LV MT VERNON EAST
PID NUMBER: 16913443
DRAWN BY: RC
CHECKED BY: PL
DATE: 10/25/23
SHEET TITLE: **BEST MANAGEMENT PRACTICES & EROSION CONTROL DETAILS AND NOTES**
SHEET NUMBER: C-7


WK PAD & CANOPY REV 3 FINAL 10/16/23

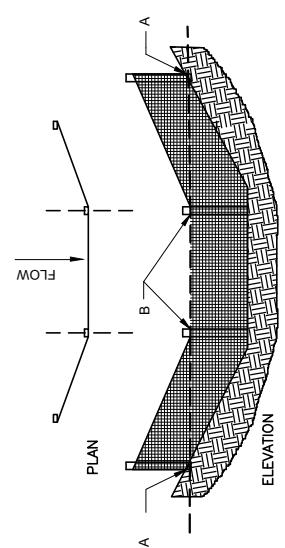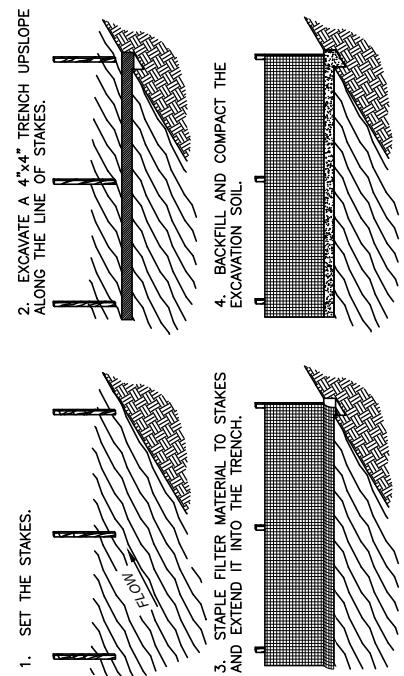

POINTS A SHOULD BE HIGHER THAN POINT B


SILT FENCE DETAIL C-7

SCALE: N.T.S.

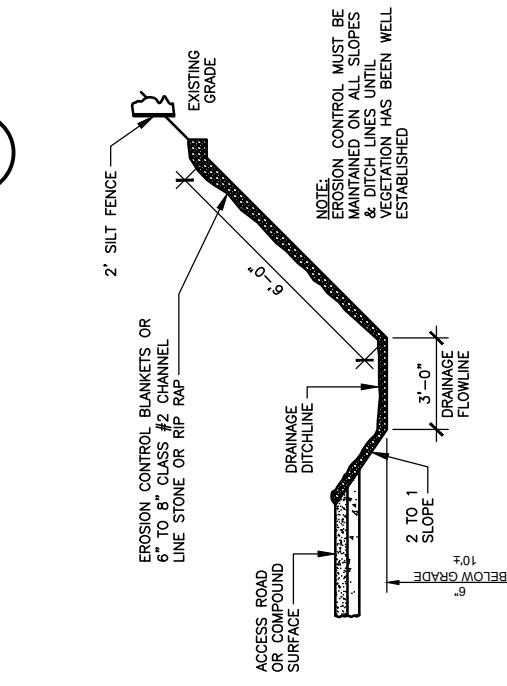

TEMPORARY STABILIZED CONSTRUCTION ENTRANCE 1 C-7

SCALE: N.T.S.

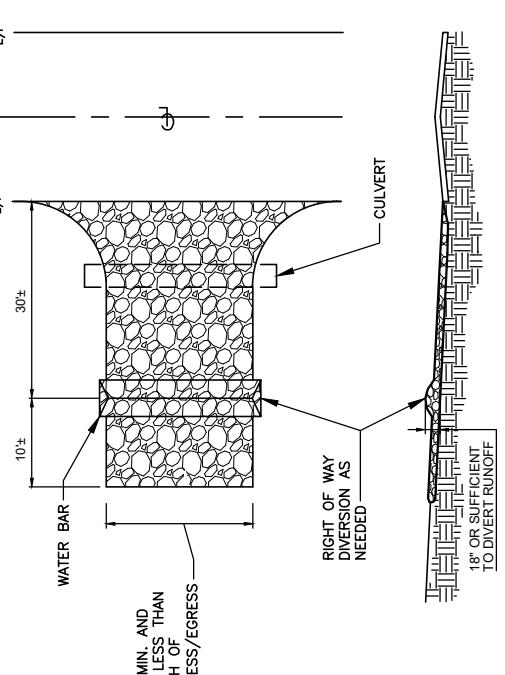

NOTES:

- STONE SIZE - TWO INCH STONE SHALL BE USED, OR RECYCLED CONCRETE EQUIVALENT.
- THE CONSTRUCTION ENTRANCE SHALL CONCIDE WITH THE PROPOSED DRIVE AS SHOWN ON THE PLAN.
- PAVEMENT THICKNESS - STONE LAYER SHALL BE AT LEAST 6" THICK.
- DRIVEWAY WIDTH - THE ENTRANCE SHALL BE AT LEAST 10' WIDE, BUT NOT LESS THAN FULL WIDTH AT POINTS WHERE INGRESS/EGRESS OCCURS.
- BEDDING - A GEOTEXTILE SHALL BE PLACED OVER THE ENTIRE AREA PRIOR TO PLACING STONE. IT SHALL HAVE A GRAB TENSILE STRENGTH OF AT LEAST 200 LBS. AND A MULLEN BURST STRENGTH OF AT LEAST 90 LBS.
- CULVERT - A PIPE OR CULVERT SHALL BE CONSTRUCTED UNDER THE ENTRANCE IF NEEDED TO PREVENT SURFACE WATER FLOWING ACROSS THE ENTRANCE FROM BEING DIRECTED OUT ONTO PAVED SURFACES.
- WATER BAR - A WATER BAR SHALL BE CONSTRUCTED AS PART OF THE CONSTRUCTION ENTRANCE IF NEEDED TO PREVENT SURFACE RUNOFF FROM FLOWING THE LENGTH OF THE CONSTRUCTION ENTRANCE AND OUT ONTO PAVED SURFACES.
- Maintenance - Top dressing of additional stone shall be applied as conditions demand. Mud spilled, dropped, washed or tracked onto public roads, or any surface where runoff is not checked by sediment controls, shall be removed immediately. Removal shall be accomplished by scraping or sweeping.
- Constructions entrances shall not be relied upon to remove mud from vehicles and prevent off site tracking vehicles that enter and leave the muddy areas. Construction shall be restricted from muddy areas.
- Under the entrance if needed to prevent surface water flowing across the entrance from being directed out onto paved surfaces.
- Water bar - a water bar shall be constructed as part of the construction entrance if needed to prevent surface runoff from flowing the length of the construction entrance and out onto paved surfaces.
- Maintenance - top dressing of additional stone shall be applied as conditions demand. Mud spilled, dropped, washed or tracked onto public roads, or any surface where runoff is not checked by sediment controls, shall be removed immediately. Removal shall be accomplished by scraping or sweeping.
- Constructions entrances shall not be relied upon to remove mud from vehicles and prevent off site tracking vehicles that enter and leave the muddy areas. Construction shall be restricted from muddy areas.

CONSTRUCTION SEQUENCE

- STAKE AND/OR FLAG LIMITS OF CLEARING
- DURING PRECONSTRUCTION MEETING ALL EROSION & SEDIMENT CONTROL FACILITIES
- PROCEDURES SHALL BE DISCUSSED.
- CLEARING & GRUBBING AS NECESSARY, FOR INSTALLATION OF PERIMETER CONTROLS.
- INSTALL SILT FENCE PERIMETER CONTROLS AS SHOWN ON PLANS.
- COLLECTION ON VEHICLE TIRES, THE TIRES MUST BE CLEANED BEFORE THE VEHICLES ENTER THE PUBLIC ROADWAY. THE SITE ENTRANCE SHALL BE MAINTAINED IN A CONDITION THAT WILL PREVENT THE TRACKING OR FLOW OF MUD INTO THE PUBLIC RIGHT-OF-WAY. ALL MATERIALS SPILLED, DROPPED, WASHED OR TRACED FROM VEHICLES ONTO THE ROADWAY MUST BE REMOVED FROMPTLY.
- CLEARING & GRUBBING AS REQUIRED TO REACH SUBGRADE.
- BEGIN FILLING & GRAVING DURING FILLING AND GRADING ACTIVITIES.
- CONSTRUCT SITE WORK INCLUDING STORM DRAINAGE FACILITIES.
- MANTAIN EROSION & SEDIMENTATION CONTROL MEASURES UNTIL THE SITE HAS BEEN COMPLETELY STABILIZED.
- REMOVE SEDIMENT CONTROLS.

- NOTES:**
- WHEN FACED WITH SLOPES LESS THAN 2 TO 1 SLOPES, ALL SLOPES SHOULD BE DOZER TRACKED PRIOR TO SEDDING OR RIP RAP EMBEDDED ON SLOPES SURFACES TO REDUCE EROSION.
 - ALL FLOWLINES MUST BE INSTALLED BELOW SUB-GRADE OF COMPOUND. (AT MINIMUM OF 6" BELOW)

DRAINAGE DITCHLINE DETAIL (SWALE) 3 C-7

SCALE: N.T.S.

1. REMOVE SEDIMENT CONTROLS.

2. CONSTRUCT AND MAINTAIN TEMPORARY DRAINAGE SWALES DURING FILLING AND GRADING ACTIVITIES.

3. CONSTRUCT SITE WORK INCLUDING STORM DRAINAGE FACILITIES.

4. MANTAIN EROSION & SEDIMENTATION CONTROL MEASURES UNTIL THE SITE HAS BEEN COMPLETELY STABILIZED.

5. BEGIN FILLING & GRAVING AS REQUIRED TO REACH SUBGRADE.

6. REMOVE SEDIMENT CONTROLS.

7. CONSTRUCT AND MAINTAIN TEMPORARY DRAINAGE SWALES DURING FILLING AND GRADING ACTIVITIES.

8. MANTAIN EROSION & SEDIMENTATION CONTROL MEASURES UNTIL THE SITE HAS BEEN COMPLETELY STABILIZED.

9. CONSTRUCT SITE WORK INCLUDING STORM DRAINAGE FACILITIES.

10. MANTAIN EROSION & SEDIMENTATION CONTROL MEASURES UNTIL THE SITE HAS BEEN COMPLETELY STABILIZED.

11. REMOVE SEDIMENT CONTROLS.

3

C-7

1. REMOVE SEDIMENT CONTROLS.

2. CONSTRUCT AND MAINTAIN TEMPORARY DRAINAGE SWALES DURING FILLING AND GRADING ACTIVITIES.

3. CONSTRUCT SITE WORK INCLUDING STORM DRAINAGE FACILITIES.

4. MANTAIN EROSION & SEDIMENTATION CONTROL MEASURES UNTIL THE SITE HAS BEEN COMPLETELY STABILIZED.

5. BEGIN FILLING & GRAVING AS REQUIRED TO REACH SUBGRADE.

6. REMOVE SEDIMENT CONTROLS.

7. CONSTRUCT AND MAINTAIN TEMPORARY DRAINAGE SWALES DURING FILLING AND GRADING ACTIVITIES.

8. MANTAIN EROSION & SEDIMENTATION CONTROL MEASURES UNTIL THE SITE HAS BEEN COMPLETELY STABILIZED.

9. CONSTRUCT SITE WORK INCLUDING STORM DRAINAGE FACILITIES.

10. MANTAIN EROSION & SEDIMENTATION CONTROL MEASURES UNTIL THE SITE HAS BEEN COMPLETELY STABILIZED.

11. REMOVE SEDIMENT CONTROLS.

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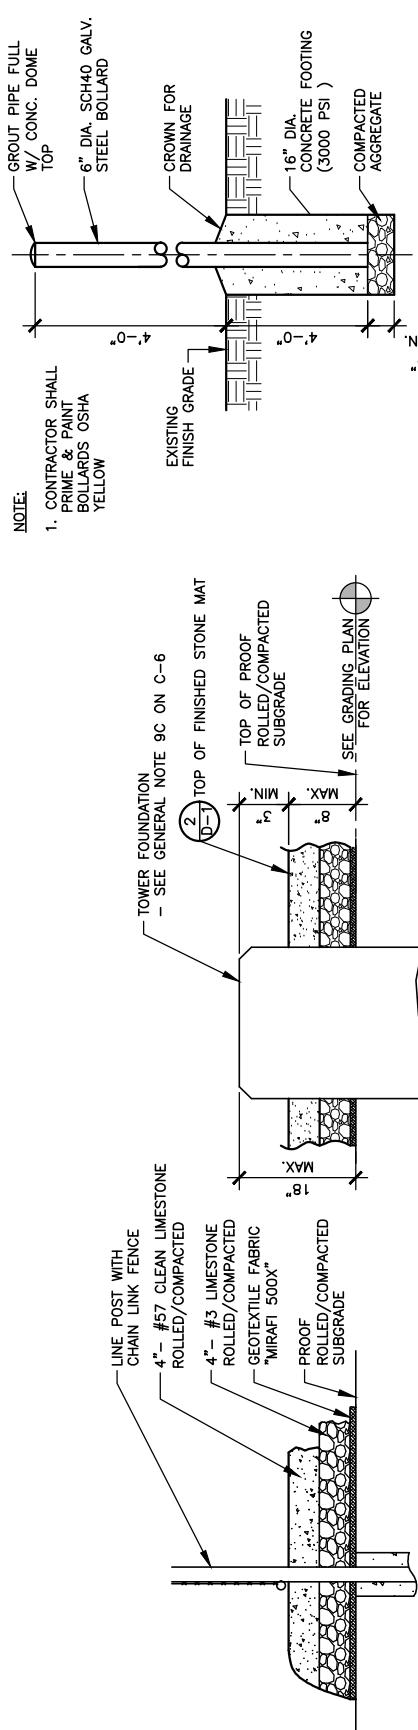
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859-544-5000 (PH)

LAB

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Wixom, Michigan 48393
PHONE: (248) 705-9212



ACCESS DRIVE TYPICAL SECTION **2** **D-2**

SCALE: N.T.S.

REGRADE DRIVE AND COMPACT 6" OF CRUSHER RUN (#57) AGGREGATE LIMESTONE (AFTER INSTALLATION OF TOWER AND BUILDING)

6" #3 LIMESTONE 4 POUNDS/1000 SQ. FT. 60% KENTUCKY BLUEGRASS 18% CREEPING RED FESCUE 22% ANNUAL RYEGRASS

6" #3 LIMESTONE W/DGA SPREAD AND COMPACT
REMOVE TOPSOIL 1'-0" DEEP MINIMUM FROM SITE & COMPACT SUBGRADE TO DOT STANDARDS

SLOPE TO MEET EXISTING GRADE (TYP.)
1/4"/FT. (MAX.)
1/4"/FT. (MAX.)


INSTALL MIRAFI 500X ENGINEERING FABRIC ACCORDING TO MANUFACTURERS RECOMMENDATIONS

CULVERT DETAIL **3** **D-2**

SCALE: N.T.S.

6" MINIMUM AGGREGATE BASE PER DESIGN
EX. DITCH
COMPACTED PFA GRAVEL BACKFILL AND BEDDING
C/L EXISTING DITCH PROPOSED CULVERT
TRANSITION DITCH BACK TO EXISTING IN 15 LF. AT EACH END OF CULVERT
6" BEVEL DITCH PROPOSED IN. EXISTING DITCH
MIN. 1'-0" MIN. 6"

MIN. 6' TEMPORARY DURING FINAL CONFIGURATION LENGTH OF 15" ALUMINIZED STEEL PIPE TYPE 2, 3" x 1" CORR.
- SEE PLAN ON C-2 FOR LOCATIONS
- VERIFY FINAL CULVERT DIAMETER WITH COUNTY HIGHWAY DEPARTMENT

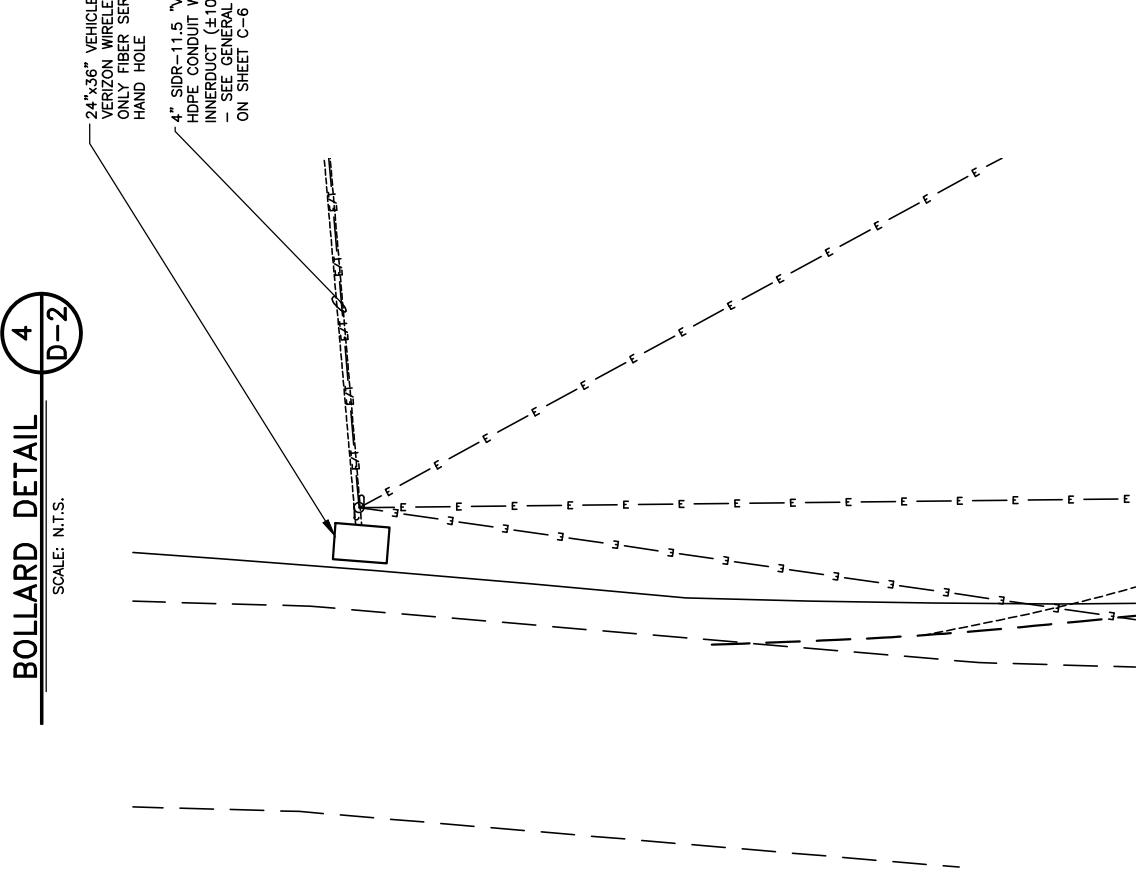

ENLARGED FIBER HAND HOLE PLAN AT R.O.W. **5** **D-2**

SCALE: 3'/32" = 1'-0"



SITE INFORMATION:
LV MT VERNON EAST
321 FROSTY HOLLOW ROAD
MT VERNON, KY 40456
ROCK CASTLE COUNTY

SITE NUMBER:
721772
SITE NAME:
LV MT VERNON EAST

SHEET NUMBER:
16913443
DRAWN BY: RC
CHECKED BY: PL
DATE: 10/25/23
SHEET TITLE:

SITE DETAILS

SHEET NUMBER:
D-2
Wk Pad & Canopy Rev 3 Final 10/16/23



TAG
TOWERS
108 PORTIAC TRAIL, SUITE 1
RICHMOND, KY 40475
859-544-5000 (PH)

LAB

49030 Portiac Trail, Suite 100
Wixom, Michigan 48393
PHONE: (248) 705-9212



SITE INFORMATION:
LV MT VERNON
EAST
321 FROSTY HOLLOW ROAD
MT VERNON, KY 40456
ROCK CASTLE COUNTY


SITE NUMBER:
721772
SITE NAME:
LV MT VERNON EAST

EQUIPMENT PAD &
CANOPY ELEVATIONS

SHEET NUMBER:
D — 3


WK PAD & CANOPY REV 3 FINAL 10/16/23

NOTE:
CANOPY ROOF PANELS PROFILE R/PBR.
PROVIDE 1.7lb DENSITY POLYETHYLENE
FOAM PANEL CLOSURE STRIPS TO MATCH
PROFILE AS MANUFACTURED BY: SATELLITE
BUILDING FASTENERS 'ST CLOSURE'
STRIPS OR EQUAL (VERIFY PROFILE WITH
ROOF PANELS SUPPLIED WITH CANOPY)

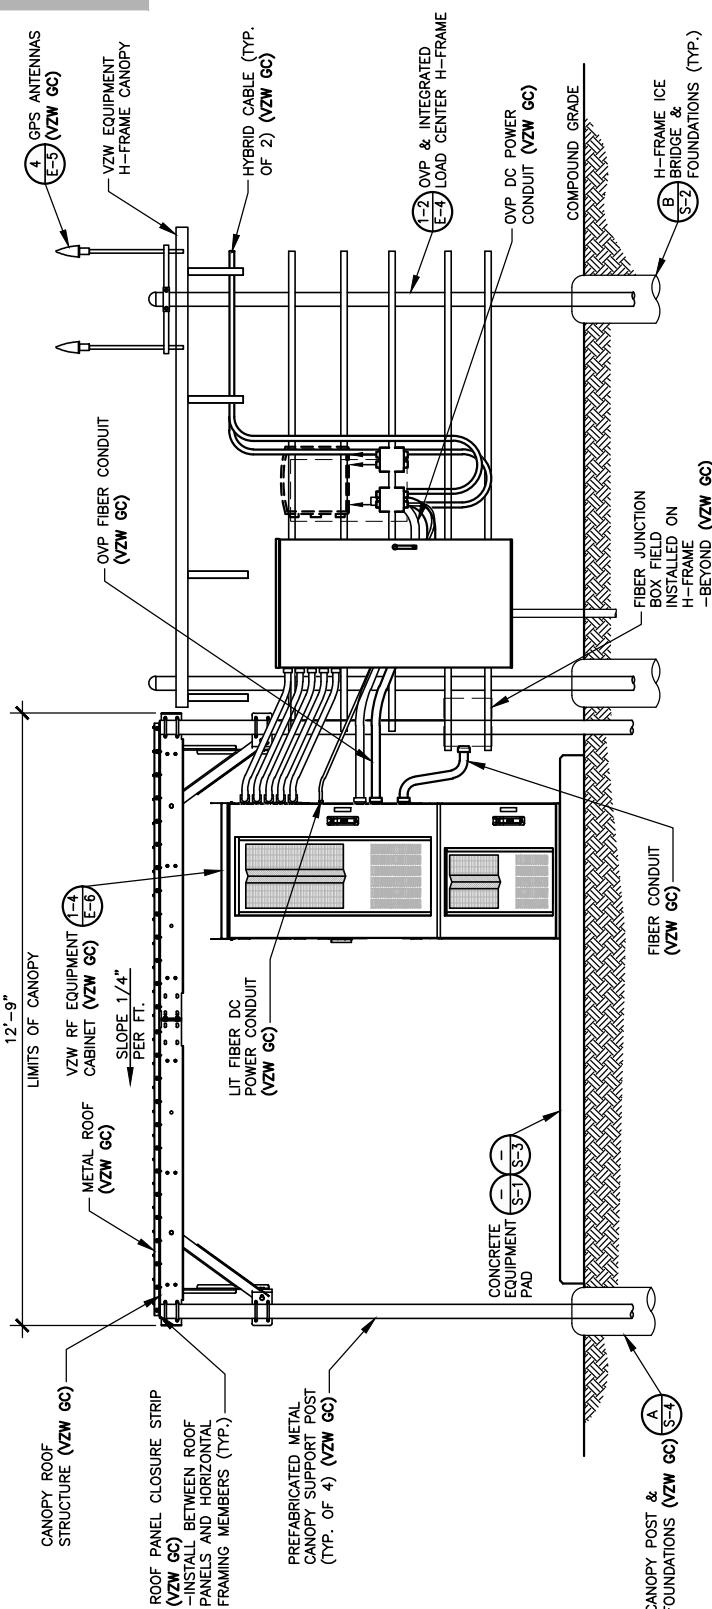


FRONT ELEVATION
SCALE: 1/4" = 1'-0"


NOTE:
VERIZON WIRELESS 9'-6" x 12'-9"
RADIO EQUIPMENT CANOPY
(CANOPY DINGS, SUPPLIED BY
MANUFACTURER) (VZW GC)
-COMMSCOPE P/N EQ-#0162-RC-B

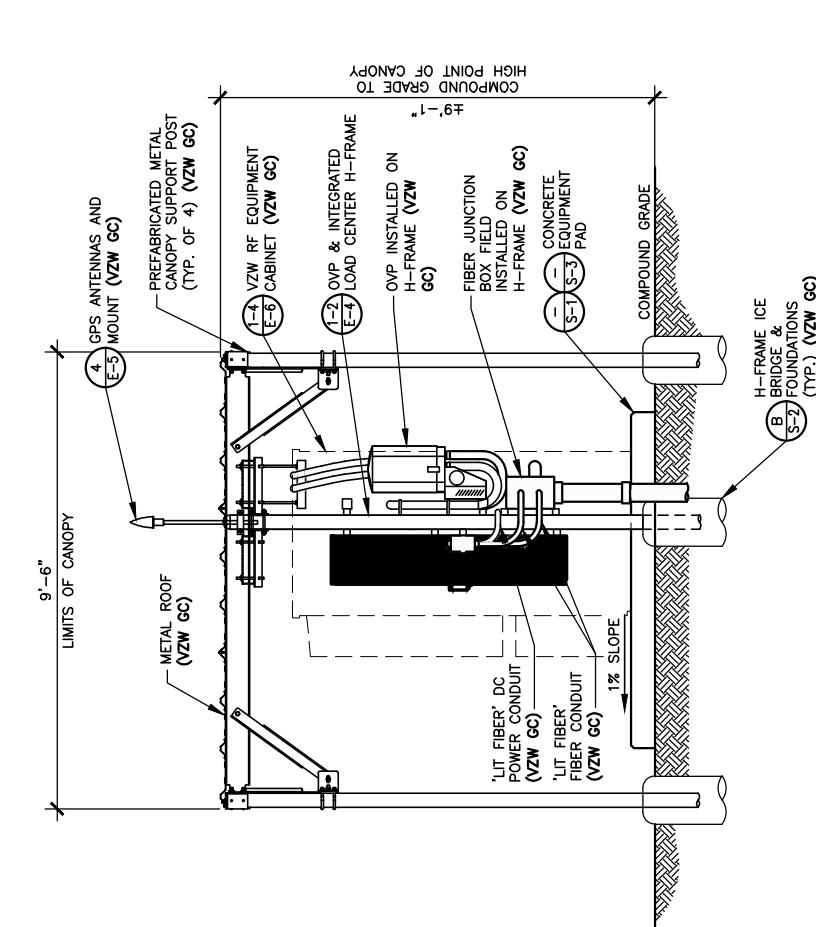

GENERATOR ELEVATION
SCALE: 1/4" = 1'-0"

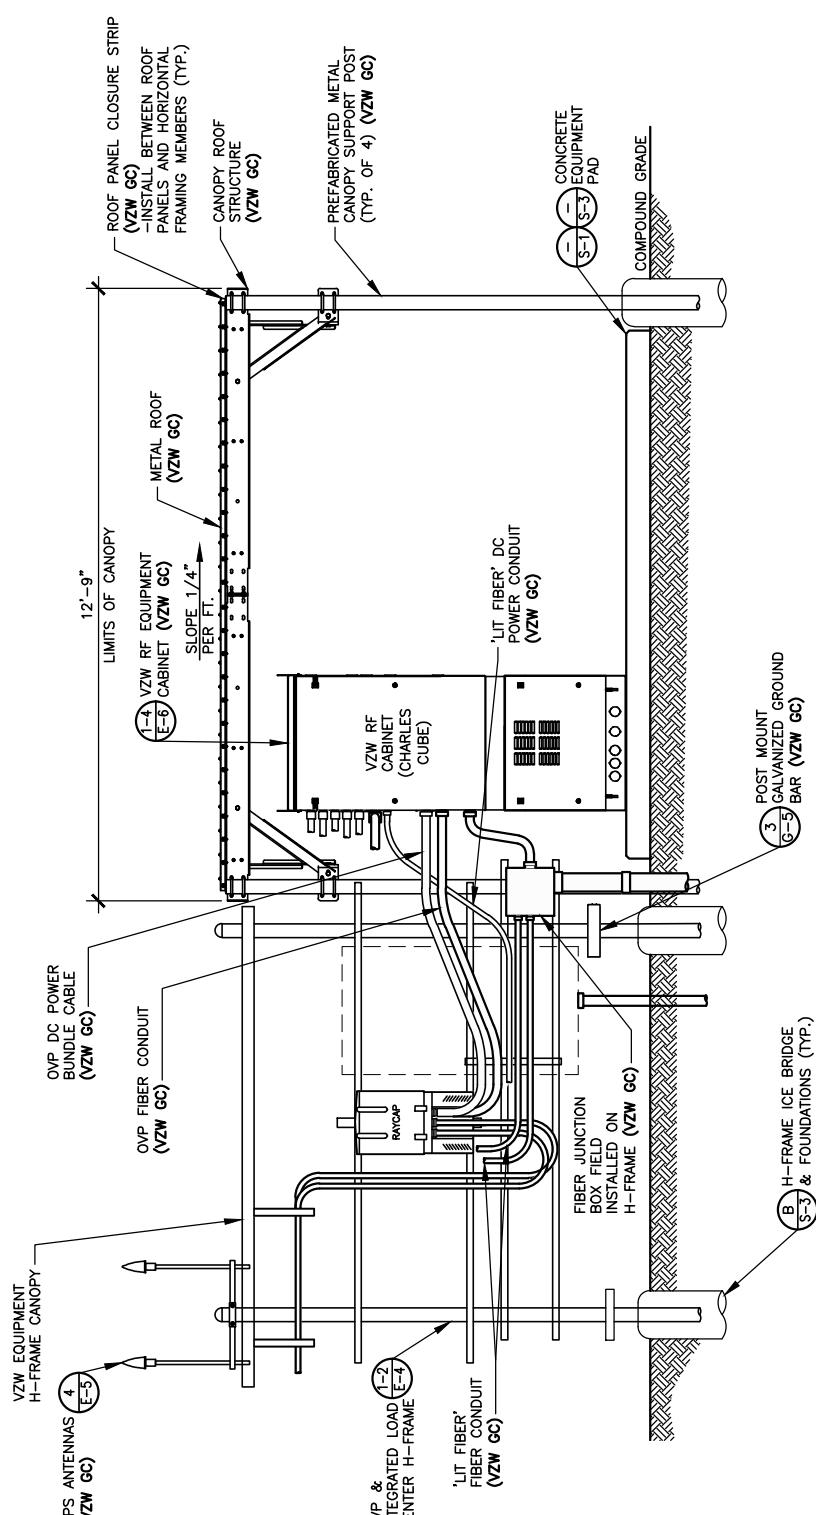

RIGHT ELEVATION
SCALE: 1/4" = 1'-0"

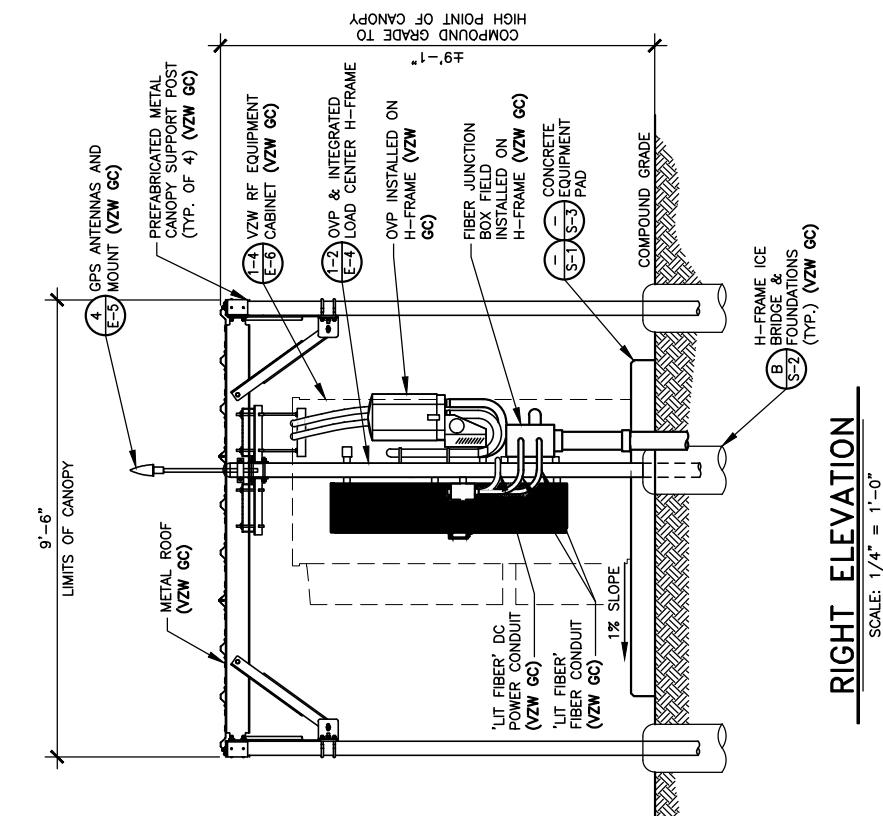

REAR ELEVATION
SCALE: 1/4" = 1'-0"



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859-544-5000 (PH)



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Wixom, Michigan 48393
PHONE: (248) 705-9212

STANDARD SITE SIGNAGE:

REQUIRED SIGNS:	LOCATIONS:
(C1) • N.O.C. "IN CASE OF EMERGENCY"	FRONT ACCESS DOOR OF CABINET (SEE FIGURE 1)
(C2) • NOTICE (CONTACT INFO)	
(C3) • COMBINATION WARNING (SEE NOTE 2)	FRONT ACCESS DOOR OF EACH CABINET WITH BATTERIES (SEE FIGURE 1)
(C4) • COMBINATION WARNING (SEE NOTE 2)	INSIDE FRONT ACCESS DOOR OF EACH CABINET WITH BATTERIES
(C5) • S.D.S.	-N.O.C. STANDS FOR "NETWORK OPERATIONS CENTER" -S.D.S. STANDS FOR "SAFETY DATA SHEET"

NOTES:

- CONTRACTOR SHALL INSTALL ALL SIGNS ON THE FRONT OF EACH CABINET. ALL SIGNS CAN BE PLACED ON ONLY THE UPPER DOOR, IF SPACE IS AVAILABLE.
- CONTRACTOR SHALL INSTALL SIGN C3 OR C4 BASED ON THE TYPE OF BATTERY THAT IS BEING INSTALLED.

(C1)



(C2)



FRONT



FIGURE 1 – EQUIPMENT CABINET SIGNAGE



FIGURE 4 – FENCE COMPOUND A.S.R. SIGN



FIGURE 3 – TOWER A.S.R. SIGN



FIGURE 5 – EME SIGN



FIGURE 6 – DRIVEWAY A.S.R. SIGN

E.M.E. SIGNAGE NOTES:

YWN GC SHALL VERIFY WITH THE VERIZON CONSTRUCTION MANAGER IF ANY E.M.E. SIGNAGE (SEE FIGURE 9) IS REQUIRED. ANY REQUIRED E.M.E. SIGNAGE WILL BE INSTALLED IN ACCORDANCE WITH THE SITE SPECIFIC PRE-E.M.E. REPORT AND MOUNT AS APPROPRIATE FOR THE SIGN LOCATION.



FIGURE 9 – TYPICAL E.M.E. SIGNAGE

LV MT VERNON EAST

PID NUMBER: 16913443
DRAWN BY: RC
CHECKED BY: PL
DATE: 10.25.23
SHEET TITLE: VERIZON WIRELESS SIGNAGE (REFERENCE ONLY)
SHEET NUMBER: D — 4

LV MT VERNON

SITE INFORMATION:
LV MT VERNON EAST
321 FROSTY HOLLOW ROAD
MT VERNON, KY 40456
ROCK CASTLE COUNTY
SITE NUMBER: 721772
SITE NAME: LV MT VERNON EAST

FIGURE 10 – LV MT VERNON EAST

STATE OF KENTUCKY

DIMITRY V. ALBUL
25093
LICENSED PROFESSIONAL ENGINEER
Signature

FIGURE 11 – STATE OF KENTUCKY ENGINEER'S SIGNATURE

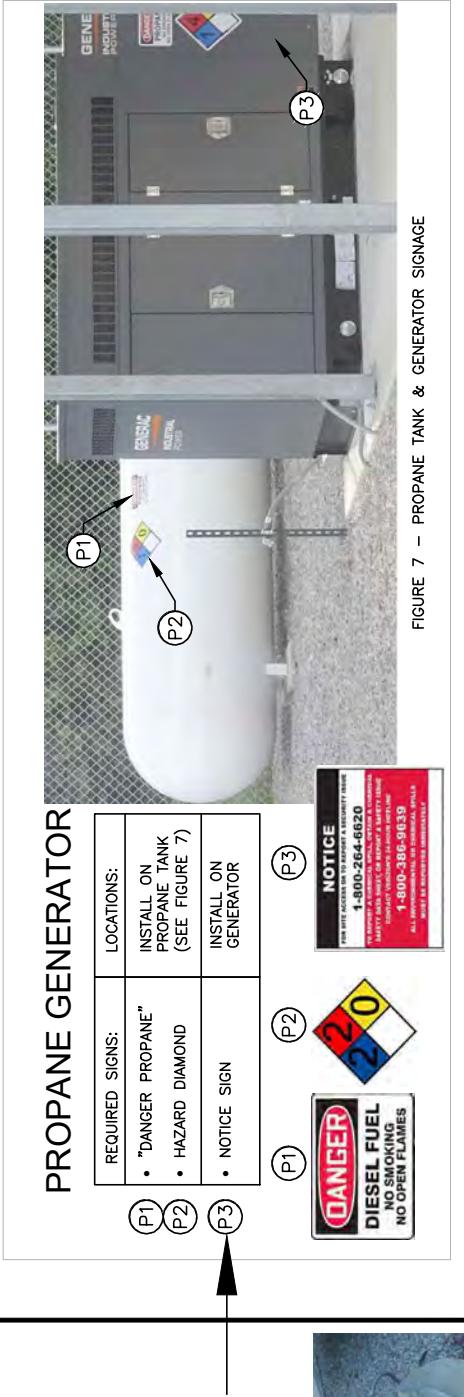


FIGURE 7 – PROPANE TANK & GENERATOR SIGNAGE

PROPANE GENERATOR

REQUIRED SIGNS:	LOCATIONS:
(P1) • "DANGER PROPANE"	INSTALL ON PROPANE TANK (SEE FIGURE 7)
(P2) • HAZARD DIAMOND	
(P3) • NOTICE SIGN	INSTALL ON GENERATOR



FIGURE 3 – TOWER A.S.R. SIGN



FIGURE 4 – FENCE COMPOUND A.S.R. SIGN



FIGURE 5 – EME SIGN



FIGURE 6 – DRIVEWAY A.S.R. SIGN

FIGURE 12 – TYPICAL E.M.E. SIGNAGE

FIGURE 13 – TYPICAL E.M.E. SIGNAGE

FIGURE 14 – TYPICAL E.M.E. SIGNAGE

FIGURE 100 – TYPICAL E.M.E. SIGNAGE



TAG TOWERS LLC
108 FOREST COURT, SUITE 1
RICHMOND, KY 40475
859-544-5000 (PH)

LAB

49030 Portia Trail, Suite 100
Wixom, Michigan 48393
PHONE: (248) 705-9212



SITE INFORMATION:
LV MT VERNON EAST
321 FROSTY HOLLOW ROAD
MT VERNON, KY 40456
ROCK CASTLE COUNTY

SITE NUMBER:
721772

SITE NAME:
LV MT VERNON EAST


PID NUMBER: 16913443
DRAWN BY: RC
CHECKED BY: PL
DATE: 10/25/23

SHEET TITLE:
**TOWER OWNER SITE
FENCE SIGNAGE
(REFERENCE ONLY)**

SHEET NUMBER:

D — 5


Wk Pad & Canopy Rev 3 Final 10/16/23

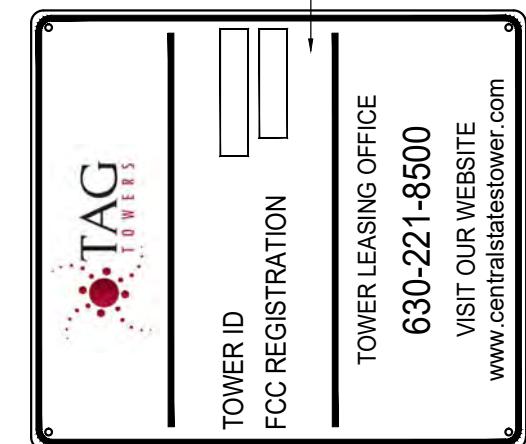**MARKETING/ID SIGN 1**


24" WIDE x 24" HIGH

FCC REGISTRATION SIGN 2**FCC REGISTRATION SIGN 2**

24" WIDE x 18" HIGH

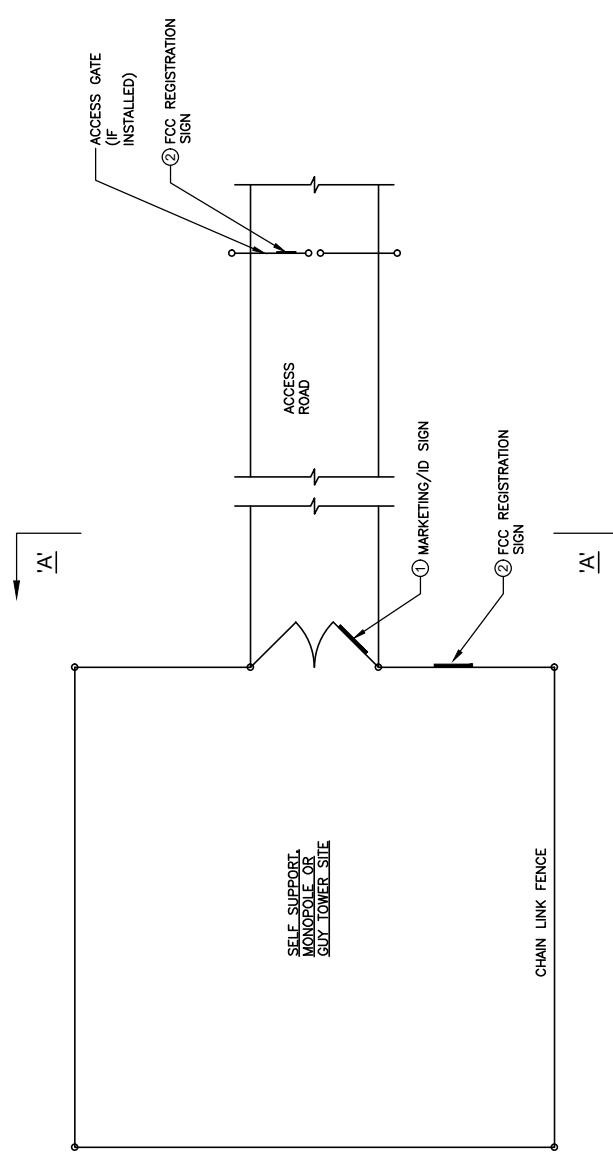**TYPICAL SITE FENCE SIGNAGE PLAN**

SCALE: N. T. S.

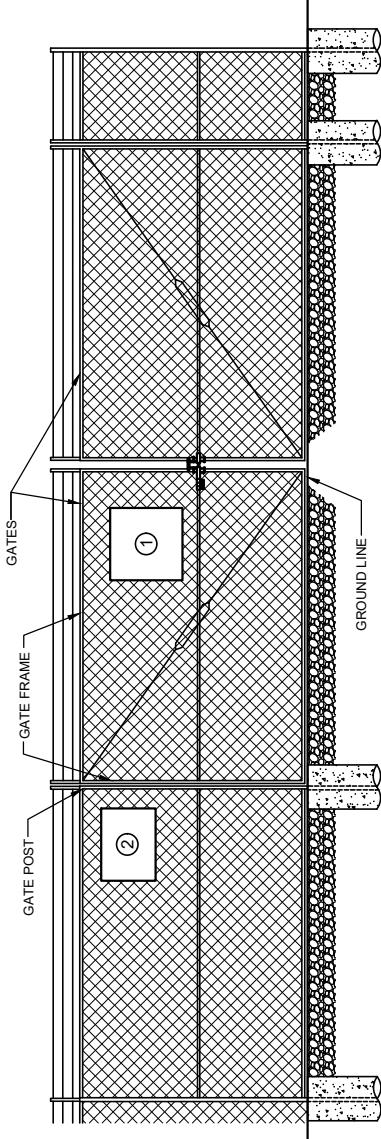**ELEVATION "A-A"**

SCALE: N. T. S.

NOTES:

VERIZON WIRELESS SITE ID SIGN, RFE SIGNS, NOC INFORMATION SIGN AND ALL OTHER SIGNAGE NOT REFERENCED BY VERIZON WIRELESS PERSONNEL PER VERIZON WIRELESS RFE SIGNAGE & DEMARCATON POLICY.



TAG
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108 FOREST COURT, SUITE 1
RICHMOND, KY 40475
859-544-5000 (PH)

STRUCTURAL NOTES

1. CANOPY SYSTEM DESIGN LOADINGS:

ROOF SNOW LOAD 70 PSF
DEAD LOADS ACTUAL MATERIAL WEIGHTS
BASIC WIND SPEED 120 MPH



49030 Portia Trail, Suite 100
Wixom, Michigan 48393
PHONE: (248) 705-9212

DESIGN CODES	INTERNATIONAL BUILDING CODE (IBC) 2015
	MINIMUM DESIGN LOADS FOR BUILDINGS AND OTHER STRUCTURES ASCE7-10
	OSHA REGULATIONS
REV.	DATE
A	08/04/23
B	08/04/23
C	08/04/23
D	11/16/23
E	12/27/23
F	REvised FOR CONSTRUCTION
G	ISSUED FOR REVIEW
H	DESCRIPTION




SITE INFORMATION:
LV MT VERNON EAST
321 FROSTY HOLLOW ROAD
MT VERNON, KY 40456
ROCK CASTLE COUNTY

SITE NUMBER: 16913443
SITE NAME: 721772
DRAWN BY: RC
CHECKED BY: PL
DATE: 10/25/23

SHEET TITLE: EQUIPMENT PAD FOUNDATION PLAN, DETAILS AND STRUCTURAL NOTES
SHEET NUMBER: S-1

WK PAD & CANOPY REV 3 FINAL 10/16/23
Call before you dig.
1-800-752-6007
For Kentucky State Law, it is against the law to move or damage utility lines without first calling the Kentucky Utility Locating Service at least two working days before commencing work.

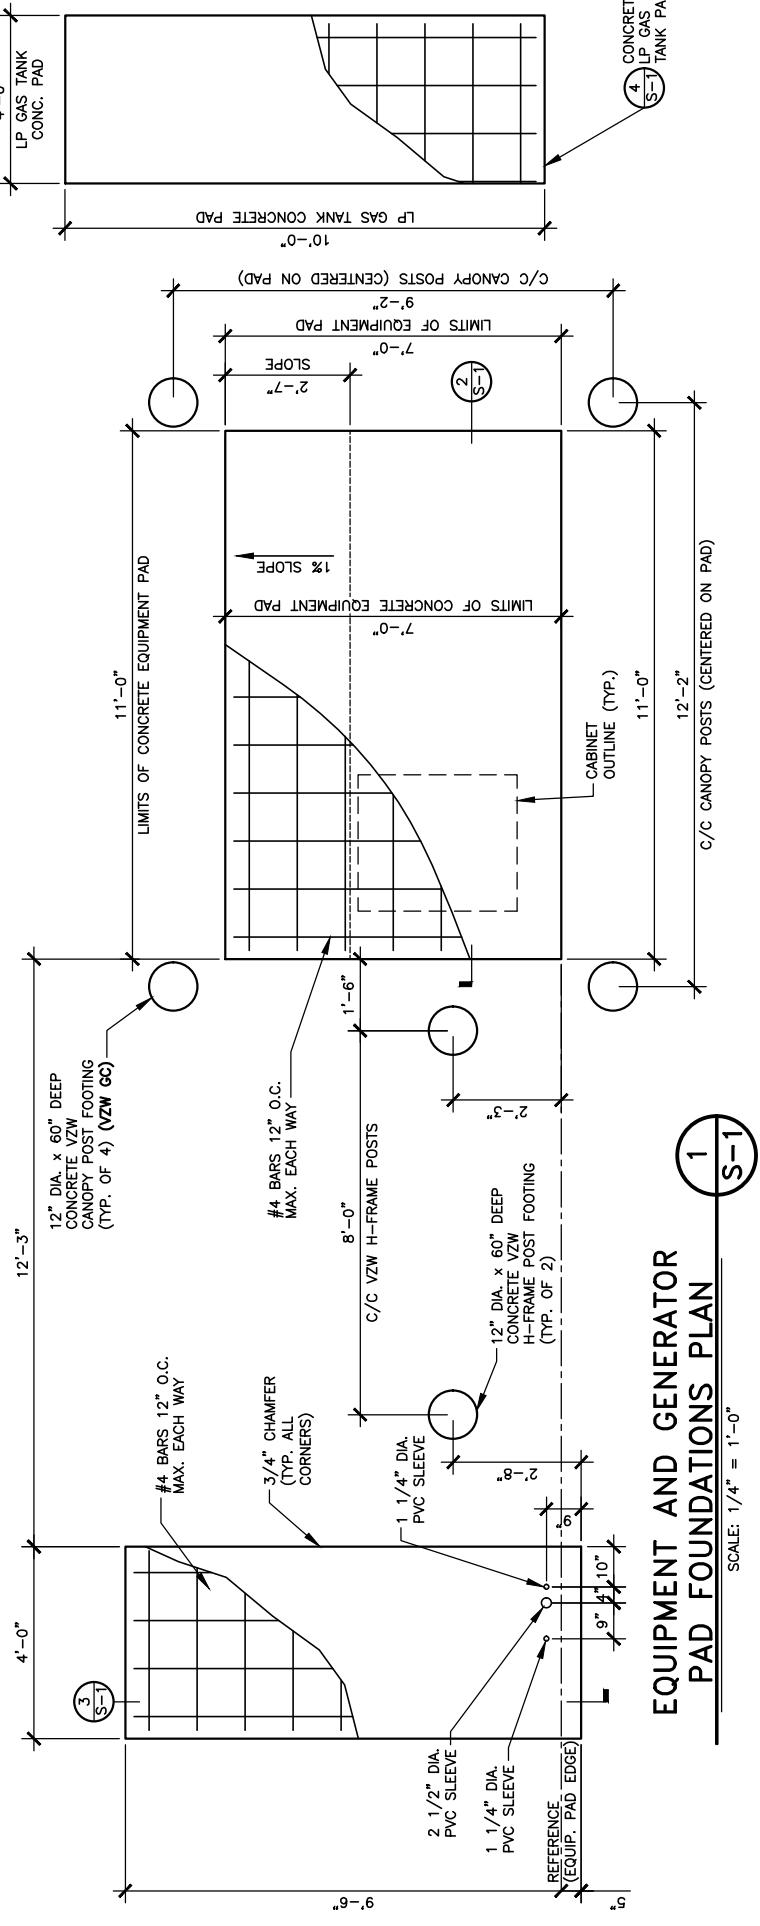




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LAB

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Wixom, Michigan 48393
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ICE BRIDGE SECTION **A** **S-2**
SCALE: 1/4" = 1'-0"

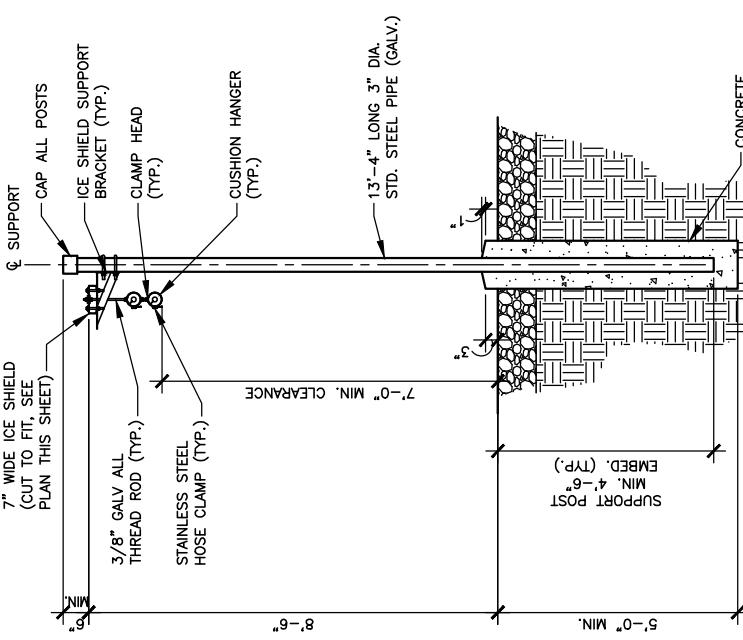


SITE INFORMATION:
LV MT VERNON EAST
321 FROSTY HOLLOW ROAD
MT VERNON, KY 40456
ROCK CASTLE COUNTY


SITE NUMBER:
721772
SITE NAME:
LV MT VERNON EAST
PID NUMBER: 16913443
DRAWN BY: RC
CHECKED BY: PL
DATE: 10/25/23
SHEET TITLE:

ICE BRIDGE PLAN AND DETAILS

SHEET NUMBER:
S - 2
Wk Pad & Canopy Rev 3 Final 10/16/23

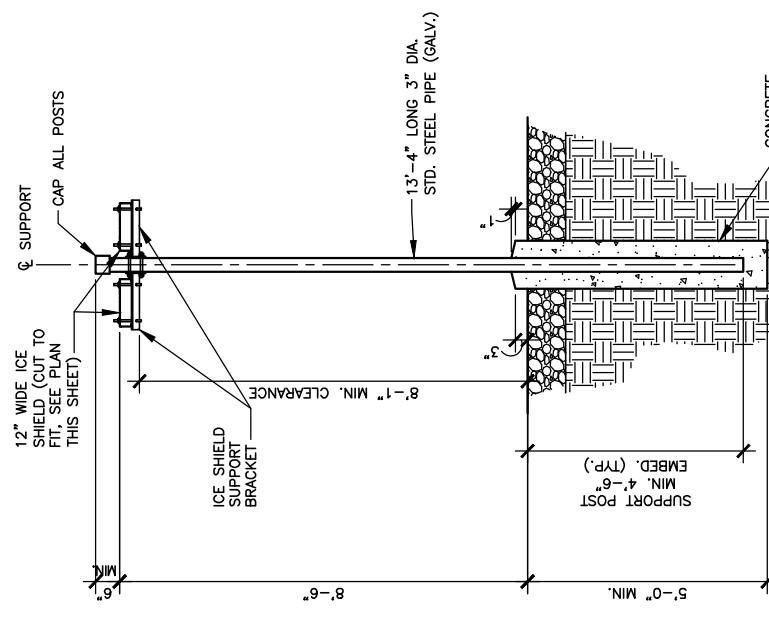

VZW H-FRAME CANOPY SECTION **B** **S-2**
SCALE: 1/4" = 1'-0"

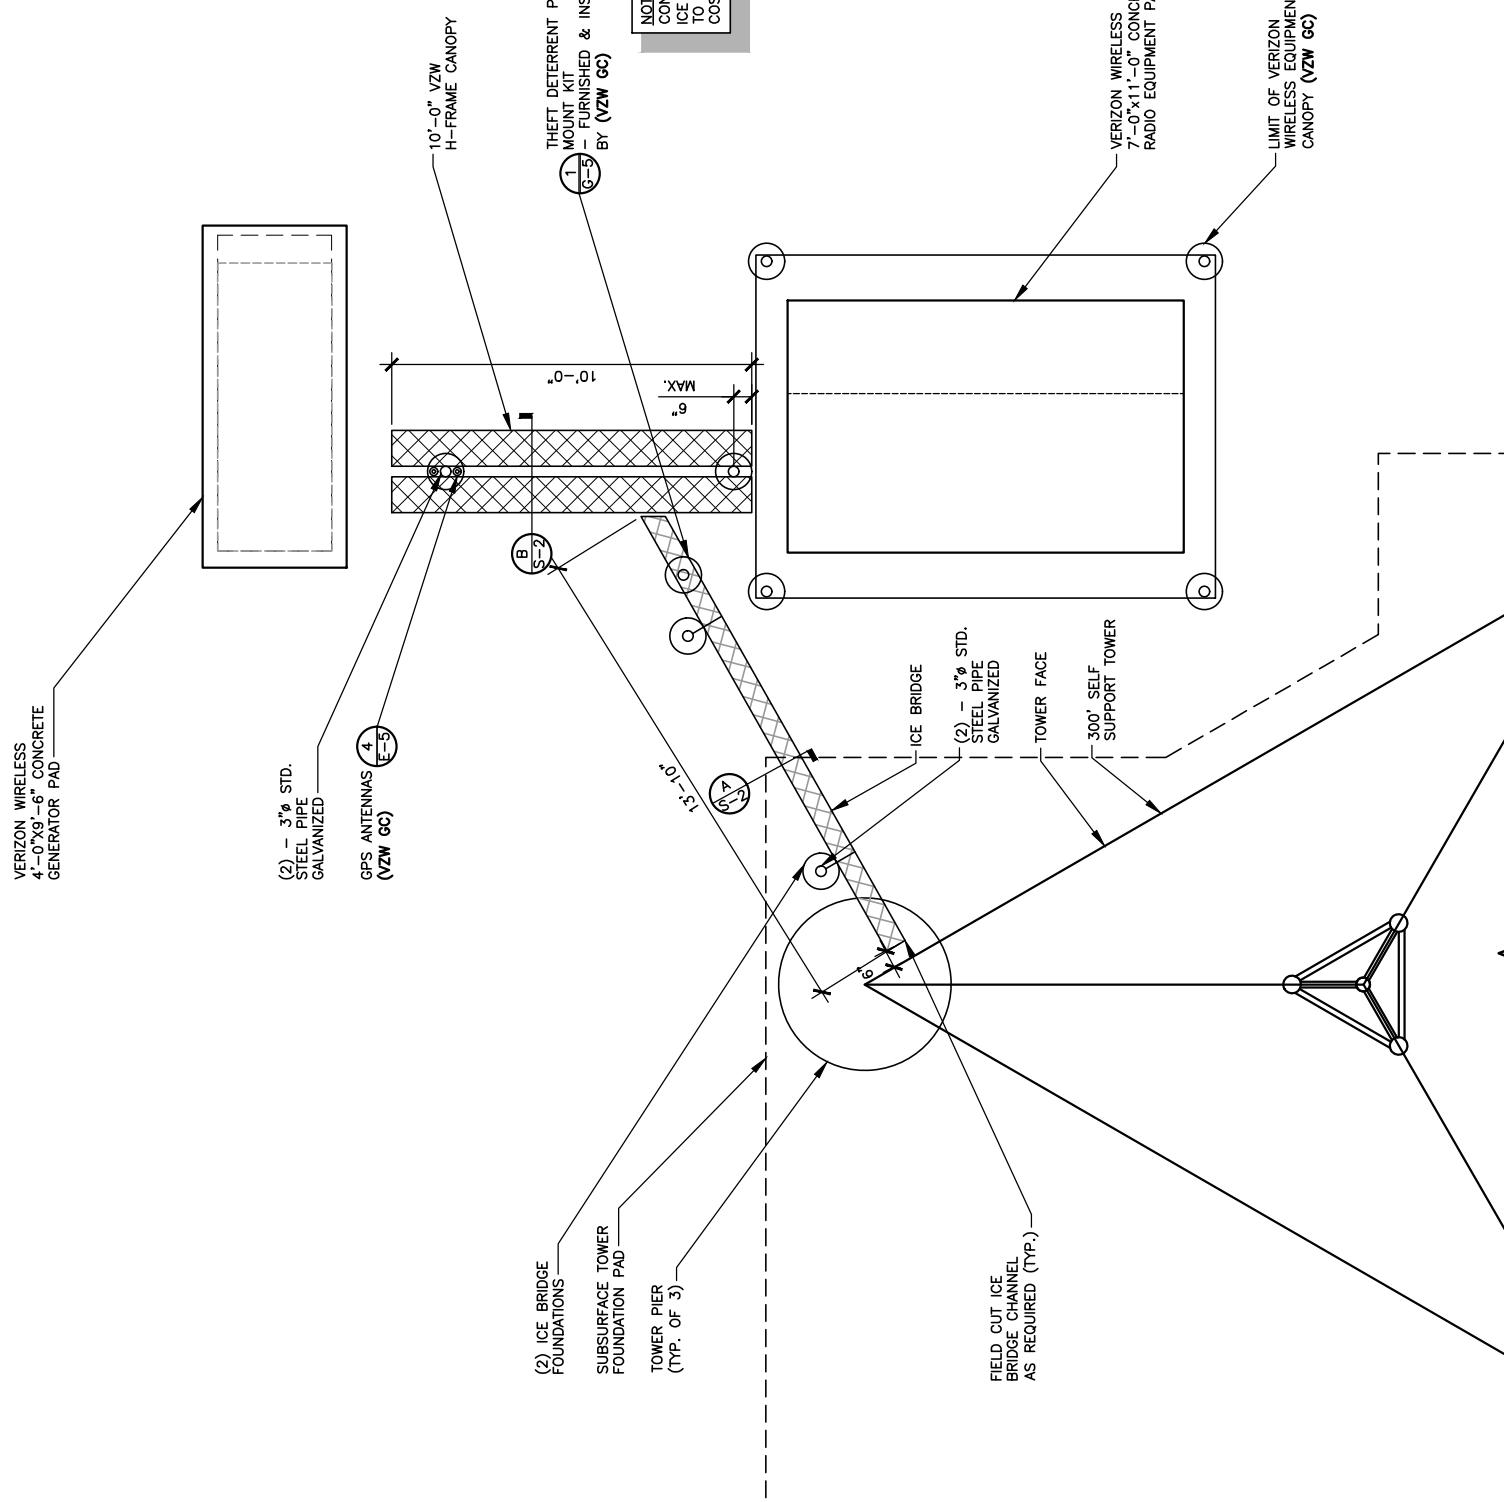

ICE BRIDGE PLAN
SCALE: 3/16" = 1'-0"



Know before you dig.
Call 800-752-6007
PER KENTUCKY STATE LAW IT IS AGAINST THE
LAW TO DIG ON PUBLIC PROPERTY WITHOUT THE
UNDERGROUND CONSTRUCTION SERVICE TWO (2)
WORKING DAYS BEFORE COMMENCING WORK.



TAG TOWERS, LLC
108 FORBES COURT, SUITE 1
RICHMOND, KY 40475
859.544.5000 (PH)

B2

19030 Pontiac Trail, Suite 100
Wixom, Michigan 48393
PHONE: (248) 705-9212

CONDUIT PENETRATION DETAIL

1

S-3

CONDUIT SLEEVE ONE
TRADE SIZE LARGER (TYP.)

3/4" CHAMFER (TYP.)
ALL CORNERS

9"

9"

16'

COMPOUND GRADE

6 MIL.
POLYETHYLENE
VAPOR BARRIER
-INSTALL OVER
ALL DISTURBED
AGGREGATE AREAS

CONDUITS
-VERIFY QUANTITY
W/EQUIPMENT INSTALLED

SCALE: N.T.S.



SITE INFORMATION:
LV MT VERNON EAST
321 FROSTY HOLLOW ROAD
MT VERNON, KY 40456
ROCK CASTLE COUNTY

SITE NAME:	IT VERNON EAST		
NUMBER:	16913443	RC	10.25.23
BY:	PL	SHEET TITLE:	
ED BY:			

**FOUNDATION PLAN
AND DETAILS**

SHEET NUMBER: **C 7**

FOUNDATION PLAN

SCALE: 3/16" = 1'-0"

GENERAL PAD
4'-0"

GEN. PAD
9'-6"

12'-3"

11'-0"

OUTSIDE EDGE OF CANOPY & TOWER

LIMITS OF EQUIPMENT PAD

EQUIPMENT PAD CONCRETE FOUNDATION
S-1

1'-6"

1'-1"

9'-2"

CANOPY POSTS CENTERED ON EQUIPMENT PAD

10'-0" VZW H-FRAME CANOPY SUPPORT POSTS (TYP. OF 2)

10'-0" VZW H-FRAME ICE BRIDGE

VZW H-FRAME CANOPY SUPPORT POSTS (TYP. OF 2)

8'-0"

1'-6"

1'-1"

9'-2"

CANOPY POSTS CENTERED ON EQUIPMENT PAD

12'-2"

ICE BRIDGE

3'-2"

3'-1"

3'-0"

THEFT DETERRENT POST
MOUNT KIT
- FURNISHED & INSTALLED
BY (VZW GC)
(2) ICE BRIDGE FOUNDATIONS

SUBSURFACE TOWER FOUNDATION
TOWER CAISSON (TYP. OF 3)

28'-3"

4' TOWER

NORTH



Know what's below.
Call before you dig.
Call Monday thru Friday - 7 am. to 6 p.
1-800-752-6000
FOR KENTUCKY STATE LAW, IT IS AGAINST THE LAW TO EXCAVATE WITHOUT NOTIFYING LOCAL UNDERGROUND LOCATION SERVICE THREE WORKING DAYS BEFORE COMMENCING



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RICHMOND, KY 40475
859-544-5000 (PH)

LAB

49030 Portia Trail, Suite 100
Wixom, Michigan 48393
PHONE: (248) 705-9212

- NOTE:**
1. IT IS THE INSTALLING CONTRACTOR'S RESPONSIBILITY TO VERIFY ALL ANTENNA INFORMATION AGAINST FINAL RADIO ENGINEERING PLAN PROVIDED BY RURAL CELLULAR CORP d/b/a VERIZON WIRELESS (VZW GC)
 2. ALL TOWER LIGHTING SHALL BE INSTALLED AS REQUIRED BY THE FEDERAL AVIATION ADMINISTRATION AND RECOMMENDED BY THE USFWS INTERIM GUIDELINES (2000) FOR LIGHTING OF TOWERS OVER 200' IN HEIGHT.

REPORT OF SOIL RESISTIVITY TESTING
PREPARED BY CIL ENGINEERING OF
OHIO, INC. ON 09/12/2023

REV.	DATE	DESCRIPTION
A	08/04/23	ISSUED FOR REVIEW
B	08/16/23	ISSUED FOR REVIEW
C	11/16/23	REVISED FOR CONSTRUCTION
D	12/27/23	ISSUED FOR CONSTRUCTION





SITE INFORMATION:
LV MT VERNON EAST
321 FROSTY HOLLOW ROAD
MT VERNON, KY 40456
ROCK CASTLE COUNTY


SITE NAME:
LV MT VERNON EAST
PID NUMBER: 16913443
DRAWN BY: RC
CHECKED BY: PL
DATE: 10/25/23
SHEET TITLE:

TOWER ELEVATION
SHEET NUMBER: **TE-1**
SCALE: N.T.S.
NORTH

VERIZON REV 3 FINAL 10/16/23

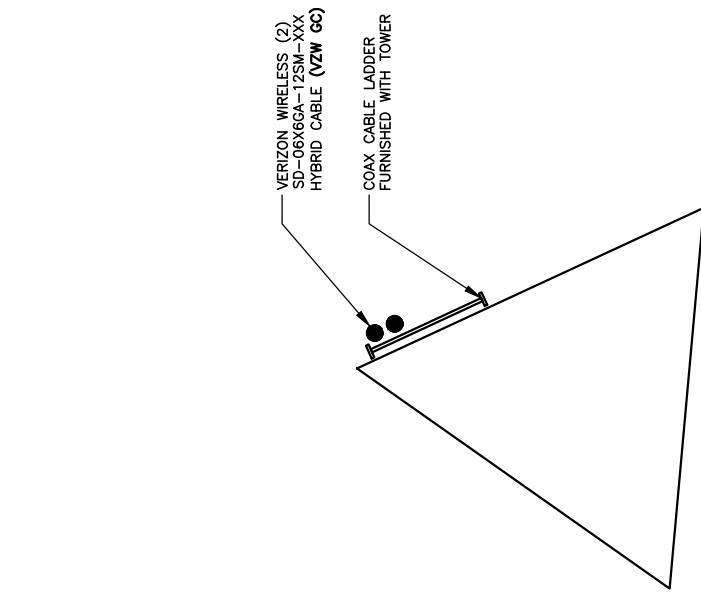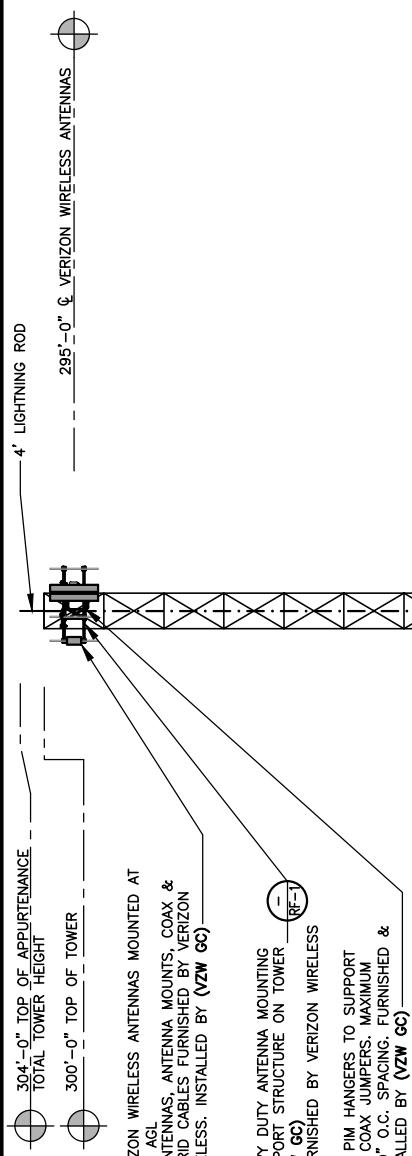

COAX PLAN
SCALE: N.T.S.

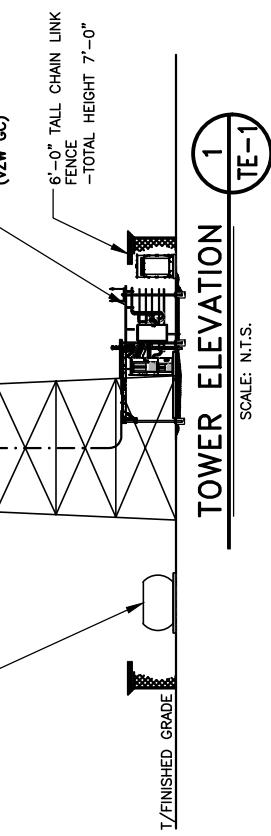

GENERAL ELECTRICAL NOTES




TOWER 5
TAG TOWERS LLC
108 FOREST COURT, SUITE 1
859-544-5000 (PH)



49030 Portia Trail, Suite 100
Wixom, Michigan 48393
PHONE: (248) 705-9212

1. UNLESS NOTED AS VERIZON WIRELESS GENERAL CONTRACTOR OR VZW GC, ALL WORK ITEMS ON ELECTRICAL "E" & GROUNDING "G" SHEETS SHALL BE PERFORMED BY THE GENERAL CONTRACTOR'S ELECTRICAL CONTRACTOR. ALL WORK SHOWN AS NEW UNLESS NOTED EXISTING.
2. THE GENERAL CONTRACTOR AND VERIZON WIRELESS ELECTRICAL CONTRACTORS SHALL BE RESPONSIBLE FOR OBTAINING AN ELECTRICAL PERMIT FROM THE COUNTY.
3. UNDERGROUND CONDUIT SHALL BE SCH. 40 (SCH. 80 UNDER ROADWAY) PVC PLASTIC DUCT WITH ALL BENDS MINIMUM 24" RADIUS 90° SWEEP SCH. 80 UNTILERALLY OTHERWISE NOTED ON DRAWINGS. ELECTRICAL AND FIBER UTILITY LATERAL CONDUITS SHALL BE MINIMUM 36" RADIUS 90° SWEEP SCH. 80. ALL PVC SCH 80 PIPING AND FITTINGS SHALL USE BELL END WHERE FEASIBLE, FITTINGS UNLESS NOTED OTHERWISE.
4. ABOVE GRADE RISER CONDUIT SHALL BE RIGID SCH. 80 PVC WITH MATCHING FITTINGS.
5. ALL CONDUITS SHALL BE PLACED WITH 200 LB POLYETHYLENE PULL TAPES. PULL TAPES SHALL BE SECURELY FASTENED AT EACH END OF CONDUIT. (THIS SHALL ALSO APPLY FOR ALL FIBER CONDUITS).
6. PRIOR TO TRENCHING AND FOR COORDINATING OF THE FIBER AND ELECTRICAL SERVICES, SEE SHEET C-6 GENERAL NOTE #6 FOR UTILITY CONTACT NAMES & PHONE NUMBERS TO ALSO INCLUDE VERIZON WIRELESS CONSTRUCTION MANAGER.
7. ALL WORK SHALL BE IN ACCORDANCE WITH N.F.P.A. AND N.E.C. CODES, NEMA STANDARDS AND ALL LOCAL CODES.
8. ALL WIRE SHALL BE COPPER, 600V THHN-2/THHN-2 OR XHHW-2/90°C UNLESS NOTED OTHERWISE.
9. ALL ELECTRICAL CONTRACTORS SHALL ABIDE BY ALL GUIDELINES REQUIRED BY TOWER OWNER AND VERIZON WIRELESS, INCLUDING BUT NOT LIMITED TO, a) STAGE CONSTRUCTION AND REPORT WHEN ON AND OFF THE SITE, b) PROVIDE LOG BOOK RECORDS OF PERSONNEL ON TOWER, c) PROVIDE R.F. MONITORING DEVICES TO TOWER PERSONNEL, d) VERIZON WIRELESS TO INSPECT ALL TRENCHING BEFORE BACKFILLING.
10. THE ELECTRICAL CONTRACTOR SHALL INSTALL ALL UNDERGROUND CONDUITS SHOWN ON PLANS UNLESS NOTED OTHERWISE. ALL UNDERGROUND CONDUIT SHALL BE STUBBED-UP AND CAPPED AT THE LOCATION INDICATED ON PLANS. VZW CONTRACTOR SHALL COMPLETE ALL CONDUIT TERMINATIONS TO VZW ENCLOSURES SHOWN ON PLANS AND ELECTRICAL PROVIDER DESIGN.
11. THE VZW ELECTRICAL CONTRACTOR SHALL VERIFY ELECTRICAL SERVICE REQUIRED - 120/240V, SINGLE PHASE, 200 AMP BEFORE ROUGH IN.
12. GENERAL CONTRACTOR AND VZW ELECTRICAL CONTRACTORS SHALL PROVIDE FIRE WATCH DURING ALL WELDING OPERATIONS. TWO (2) HAND HELD 30 LB. FIRE EXTINGUISHERS & ADEQUATE WATER SUPPLY SHALL BE APPROVED BY THE CLIENT AND THE TOWNSHIP WATER AUTHORITY.
13. SEAL ALL PENETRATIONS WITH SILICONE SEALANT.
14. ELECTRICAL WORK PRESENTS SPECIFIC THREATS TO THE HEALTH AND SAFETY OF WORKERS IN SITE. SPECIFIC ELECTROTONS ARE THE FOUR LEADING CAUSE OF DEATH ON CONSTRUCTION SITES. ALL ELECTRICAL WORKERS SHALL HAVE CURRENT CERTIFICATIONS WHICH SATISFY ALL TRAINING REQUIREMENTS FOR THE ELECTRICAL WORK THEY ARE PERFORMING PER OSHA STANDARDS. ALL ELECTRICAL WORKERS SHALL ADHERE TO ALL SAFETY RULES AND REGULATIONS FOR WORKER AND PUBLIC SAFETY. ALL WORK SHALL BE PERFORMED BY QUALIFIED ELECTRICIANS TRAINED FOR THE TYPE OF WORK AND THE VOLTAGES PRESENT FOR EACH TASK. THE CONTRACTOR SHALL REVIEW ALL LANDOWNER, PRIME CONTRACTOR, CARRIER, OSHA, NFPA 70E, AND LOCAL SAFETY GUIDELINES AND AT ALL TIMES SHALL CONFORM TO THE MOST RESTRICTIVE OF THESE STANDARDS TO ENSURE A SAFE WORKPLACE.
15. CONNECT NEUTRAL TERMINAL IN SERVICE DISCONNECTING DEVICE TO GROUNDING ELECTRODE (2/0 AWG TINNED STRANDED COPPER GROUNDING ELECTRODE CONDUCTOR IN 1" PVC CONDUIT). CONNECT FIRST GROUNDING ELECTRODE TO SECOND GROUNDING ELECTRODE WITH 2/0 AWG TINNED STRANDED COPPER CONDUCTOR EXOTHERMICALLY WELDED TO ELECTRODES.
16. VZW E.C. SHALL VERIFY SUFFICIENT CAPACITY EXISTS AT EXISTING METER CENTER. NOTIFY ENGINEER IMMEDIATELY IF SERVICE IS NOT ADEQUATE.
17. REFER TO ELECTRICAL SITE PLAN FOR CONDUIT AND WIRE REQUIREMENTS.
18. ALL ELECTRICAL EQUIPMENT PLACARDS MUST BE ENGRAVED PLASTIC LABELS ONLY. NO P-TOUCH LABELS ARE TO BE USED. PLACARDS SHALL BE 1 1/2" x 5" IN SIZE AND PERMANENTLY AFFIXED TO THE ENCLOSURES EASILY VISIBLE LOCATIONS.
19. VZW WIRELESS ELECTRICAL PLACARD REQUIREMENTS:




 - a) AVAILABLE FAULT CURRENT RATING FROM UTILITY PROVIDER WITH DATE.
 - b) VZW WIRELESS SERVICE DISCONNECT AT METER BASE.
 - c) VZW MAIN BREAKER AT INTEGRATED LOAD CENTER ILC.
 - d) GENERATOR NEUTRAL CONDUCTOR BONDED TO SERVICE GROUNDING ELECTRODE IN THIS ENCLOSURE AT METER CENTER AND AUTOMATIC TRANSFER SWITCH "ATS" NEUTRAL BAR.
 - e) VZW WIRELESS GENERATOR PROPERTY OF VERIZON WIRELESS' AT ALL VZW WIRELESS FIBER OPTIC SITES.

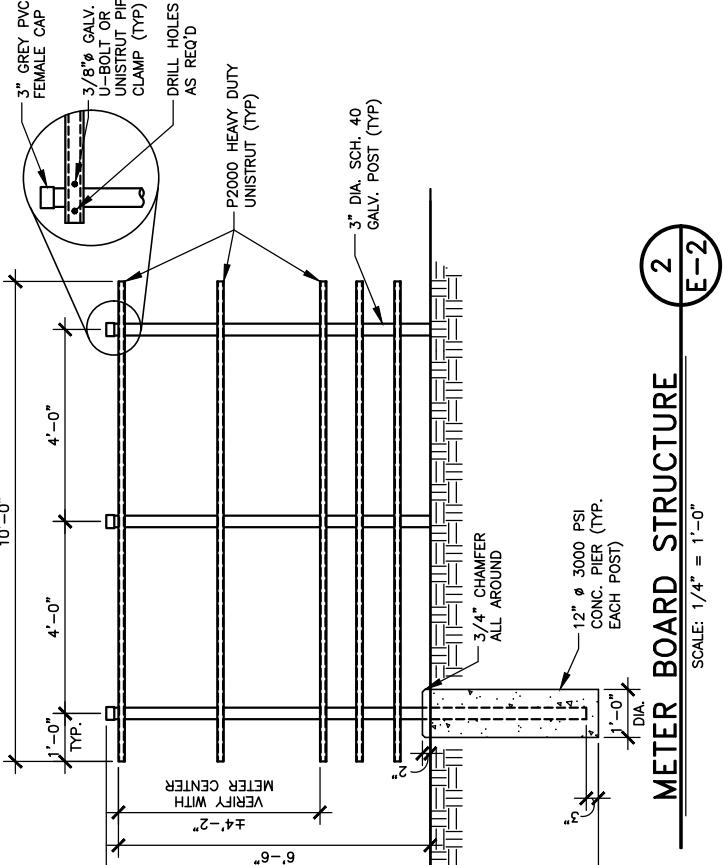

SURFACE MOUNTED NEMA 3R w/DOOR
22K AIC BREAKERS
(E.C. SHALL VERIFY AIC RATINGS W/LOCAL POWER CO.)

PANEL SCHEDULE "A"

SCALE: N.T.S.

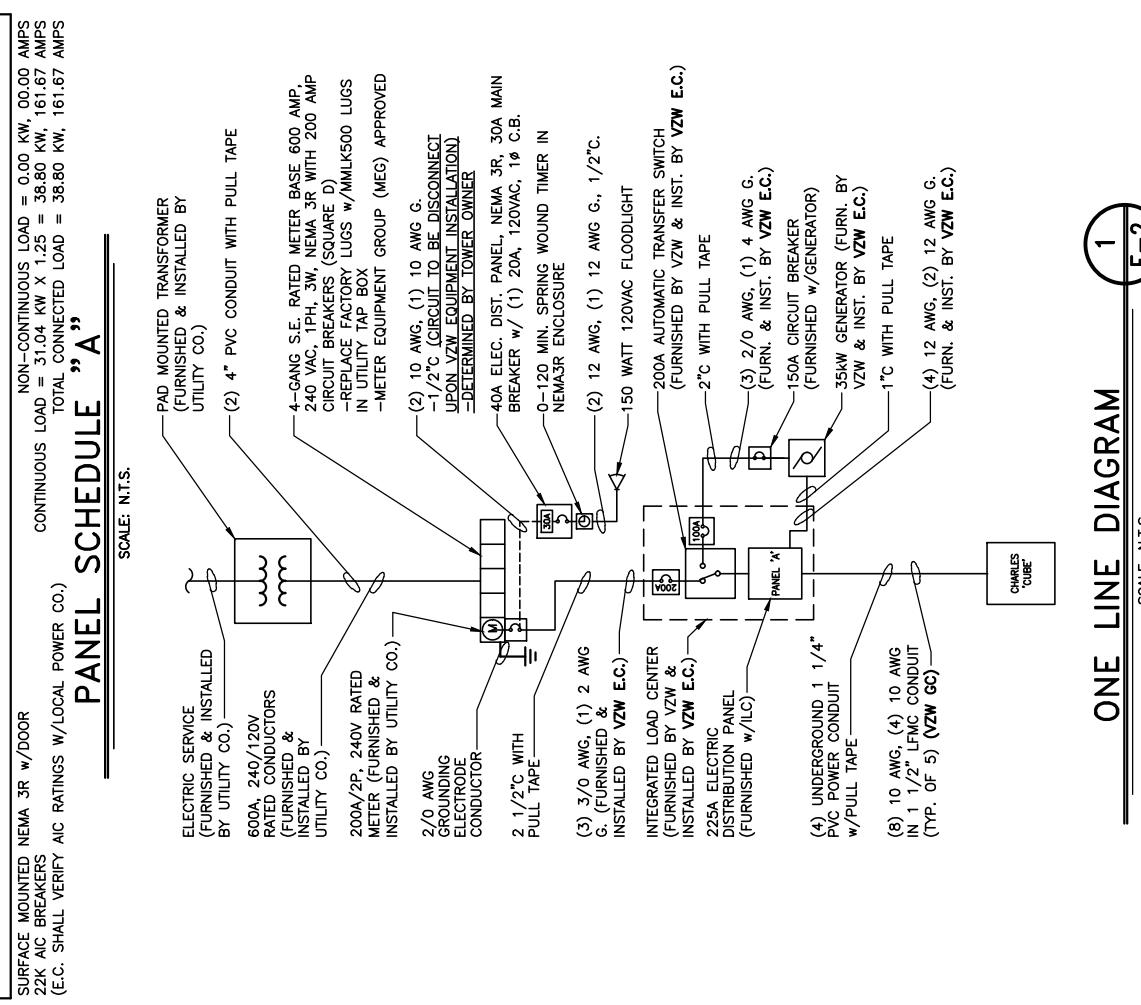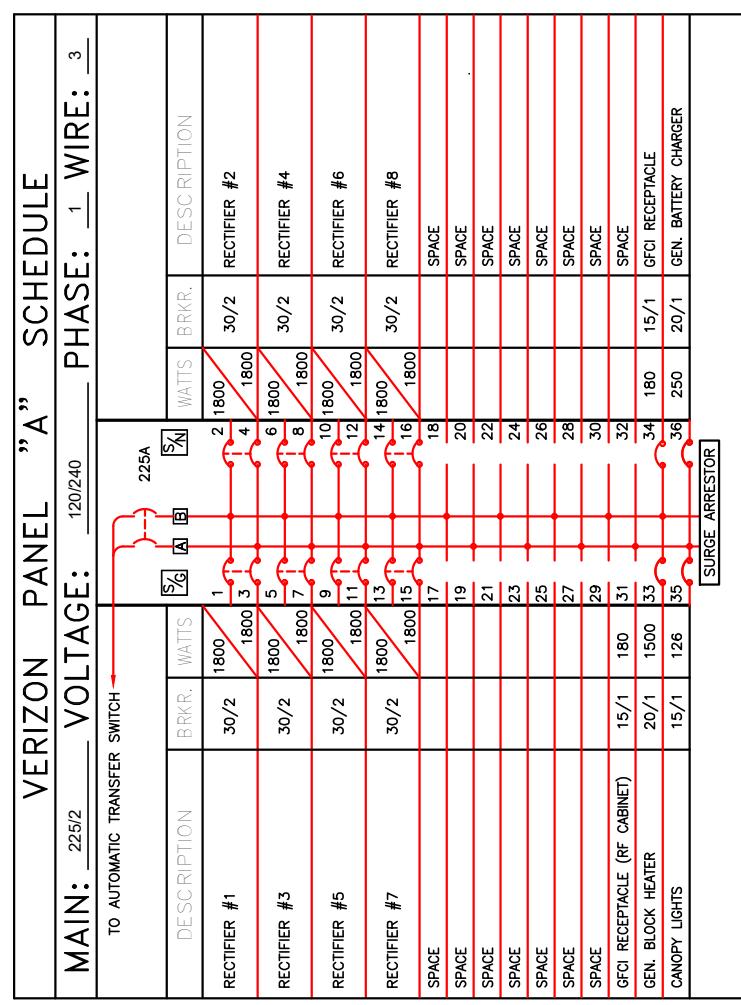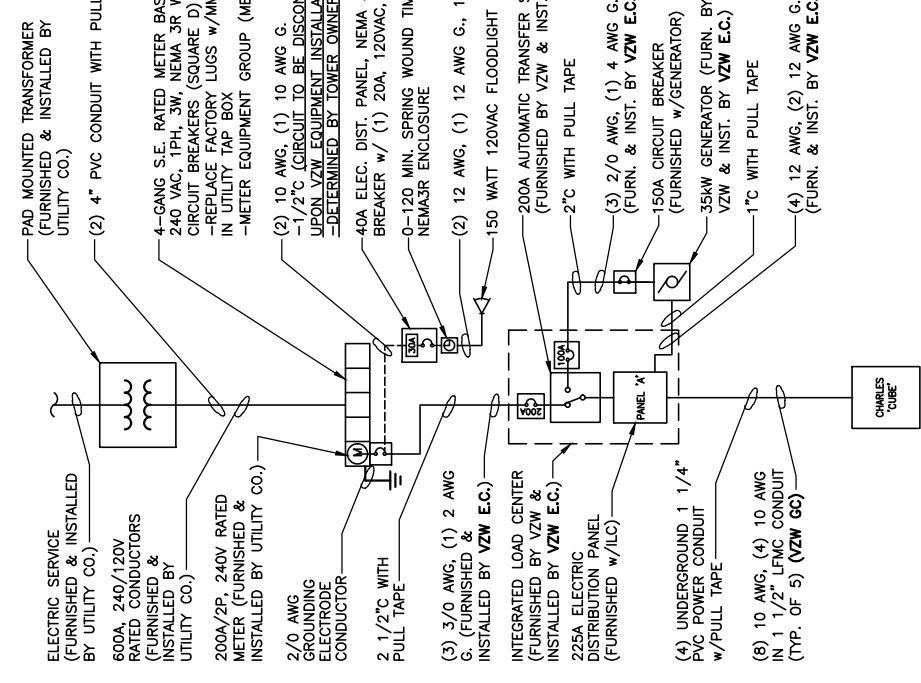

ONE LINE DIAGRAM
E-2

SCALE: N.T.S.







TAG
TOWERS
LLC
108 FOREST COURT, SUITE 1
RICHMOND, KY 40475
859-544-5000 (PH)

LAB

49030 Portiac Trail, Suite 100
Wixom, Michigan 48393
PHONE: (248) 705-9212

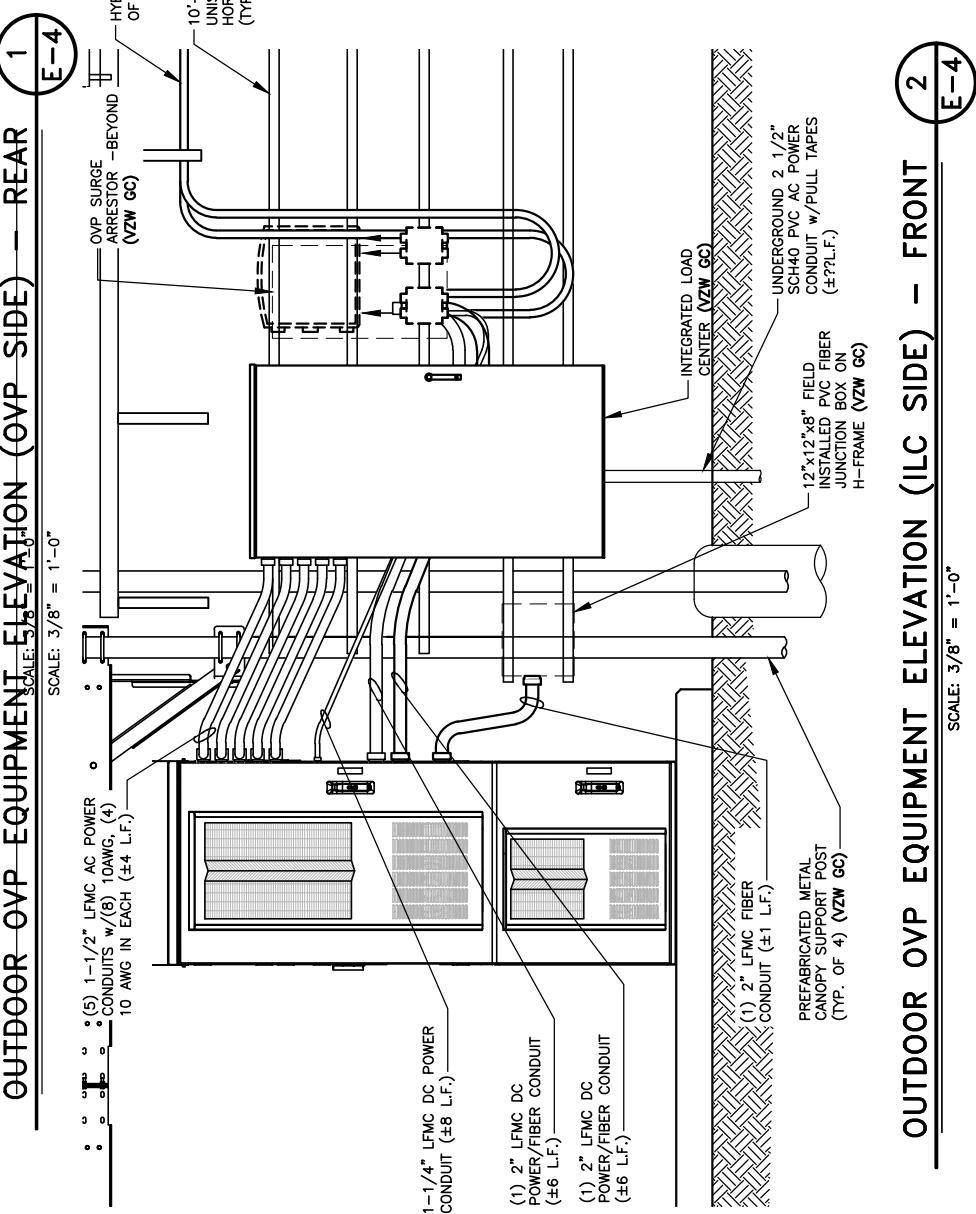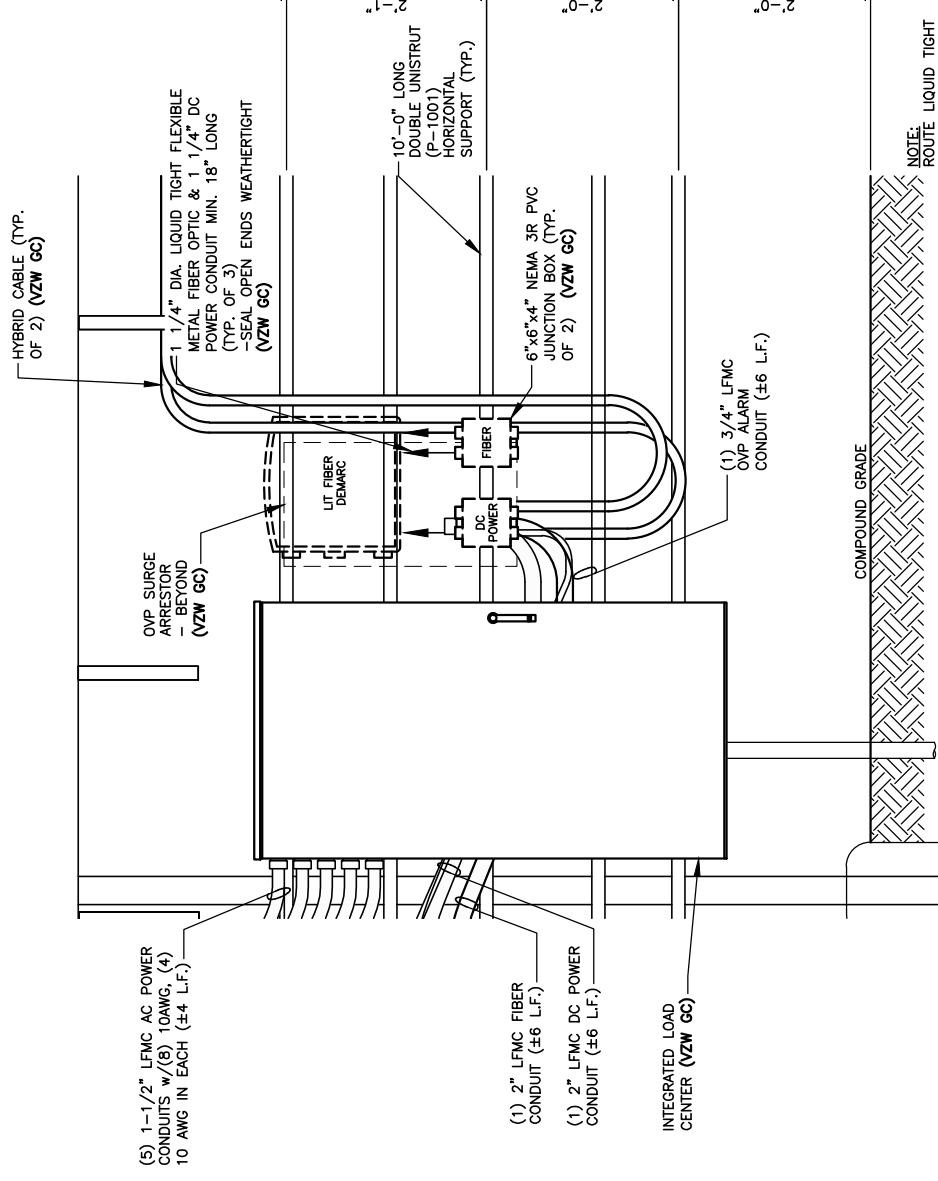

SITE INFORMATION:
LV MT VERNON EAST
321 FROSTY HOLLOW ROAD
MT VERNON, KY 40456
ROCK CASTLE COUNTY

SITE NUMBER:
721772

SHEET NUMBER:
16913443
DRAWN BY: RC
CHECKED BY: PL
DATE: 10/25/23

SHEET TITLE:
OVP & INTEGRATED LOAD CENTER H-FRAME ELEVATIONS AND DETAILS



SHEET NUMBER:
E — 4



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SERVICE LATERAL TRENCH SECTION DETAIL A-E-5

SCALE: N.T.S.

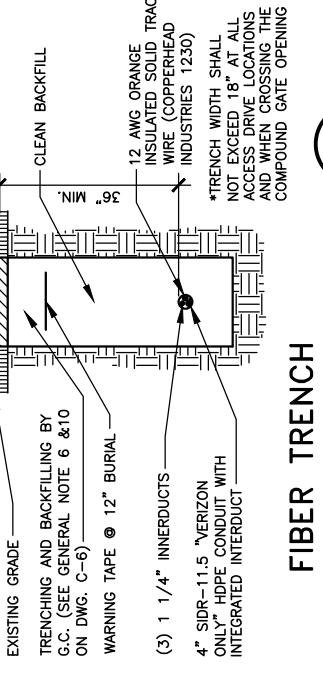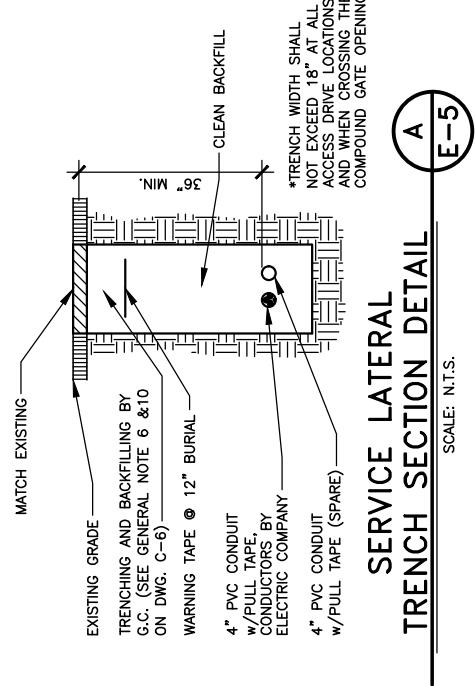


SITE INFORMATION:
LV MT VERNON EAST
321 FROSTY HOLLOW ROAD
MT VERNON, KY 40456
ROCK CASTLE COUNTY

SITE NUMBER:	721772
PID NUMBER:	16913443
DRAWN BY:	RC
CHECKED BY:	PL
DATE:	10/25/23
SHEET TITLE:	ELECTRICAL DETAILS


SHEET NUMBER:
E—5

WK PAD & CANOPY REV 3 FINAL 10/16/23

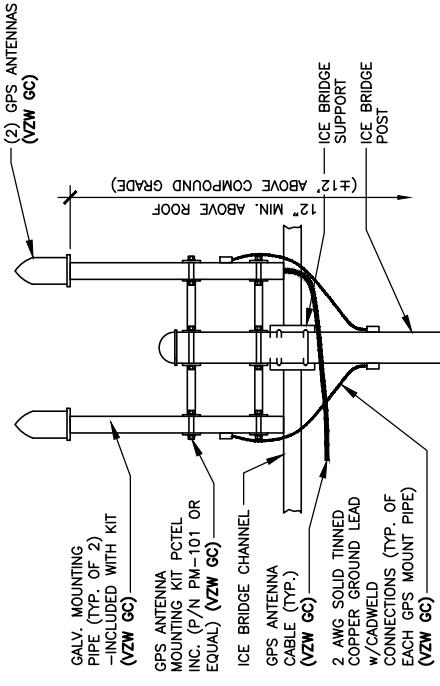



GPS MOUNT DETAIL 4-E-5

SCALE: N.T.S.
(BY VZW GC)

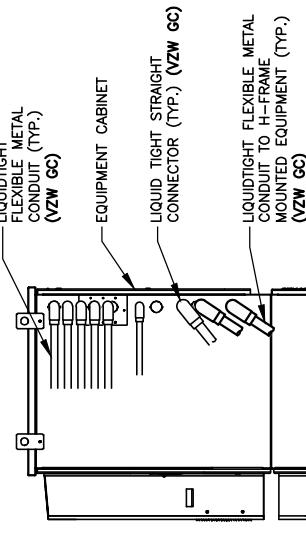


TYP. CABINET CONDUIT ENTRANCE DETAIL 5-E-5

SCALE: N.T.S.
(BY VZW GC)

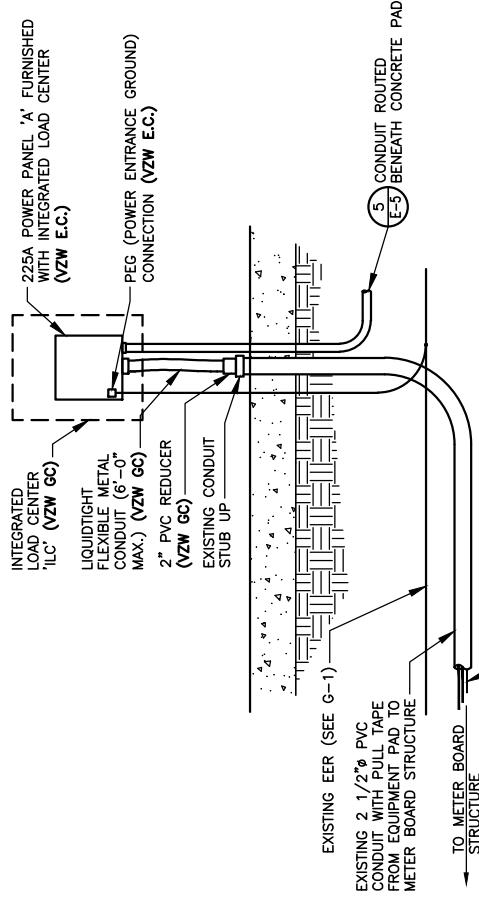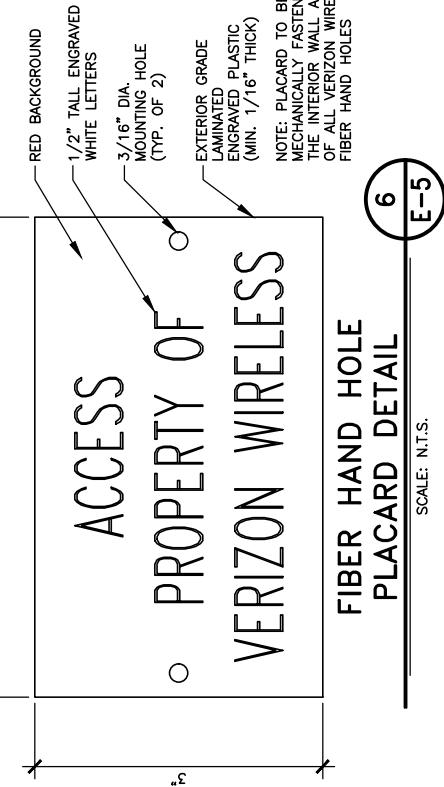


SERVICE ENTRANCE DETAIL 1-E-5

SCALE: N.T.S.

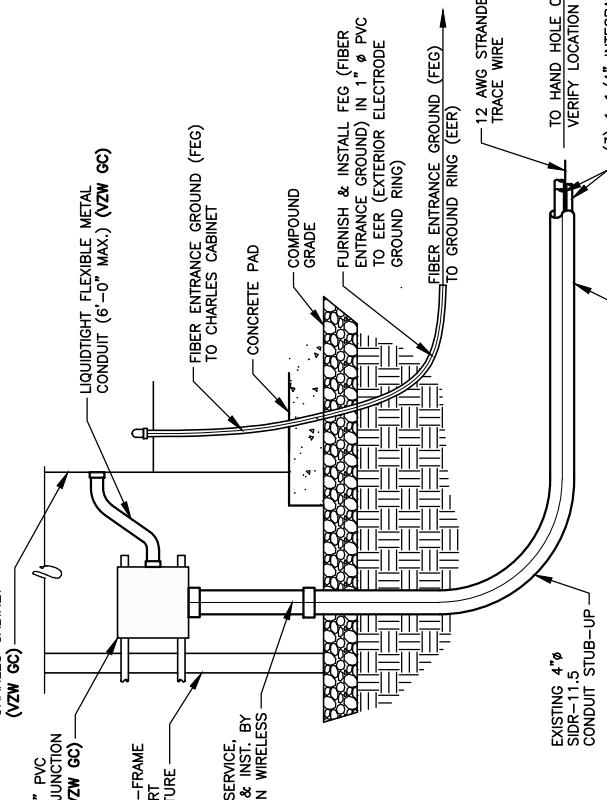

FIBER CONDUIT STUB-UP DETAIL 3-E-5

SCALE: N.T.S.

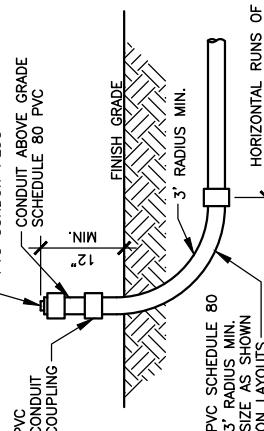




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PHONE: (248) 705-9212

NOTE:
VERIFY INTERIOR EQUIPMENT LOCATION, PRIOR TO
JUNCTION BOX FASTENER INSTALLATION. NO SHARP
FASTENER EDGES PERMITTED WITHIN CABINET

NOTE:
FIBER OPTIC INNERDUCTS SHALL
TERMINATE INSIDE CHARLES CABINET
ONLY



SITE INFORMATION:
LV MT VERNON EAST
DMITRIY V. ALBUL
LICENSED PROFESSIONAL ENGINEER
25093
Signature

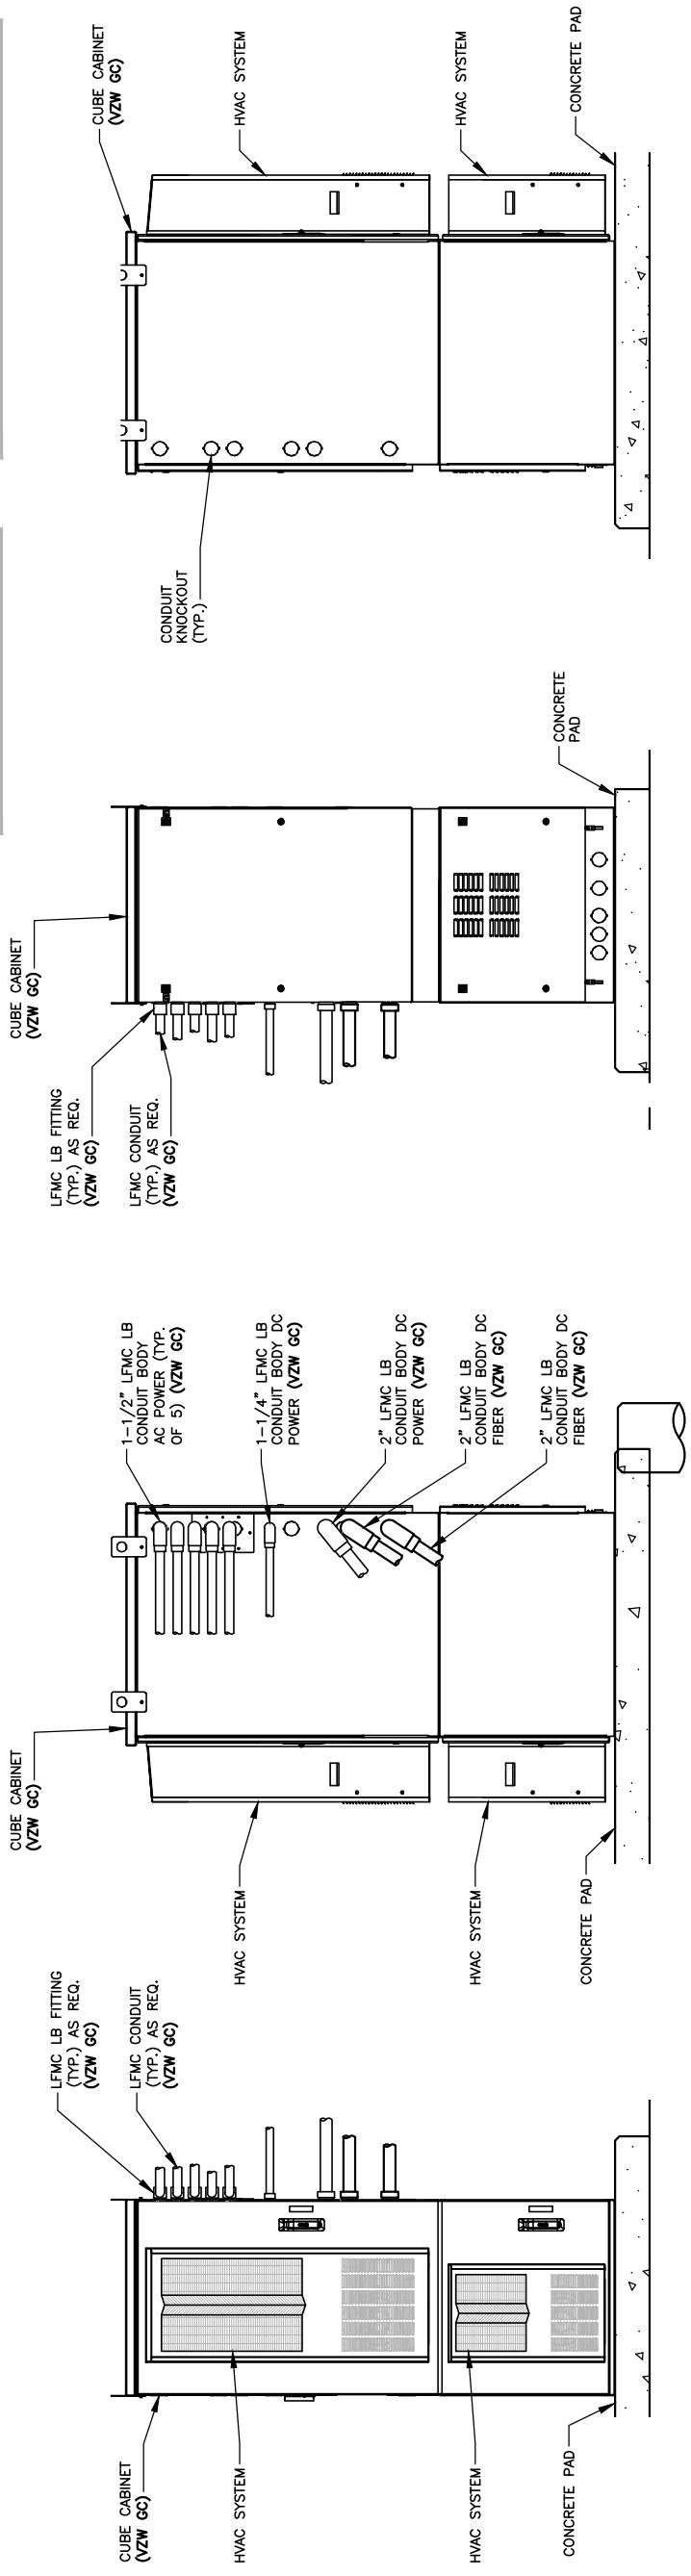SITE NUMBER:
721772
SITE NAME:
LV MT VERNON EAST
PID NUMBER: 16913443
DRAWN BY: RC
CHECKED BY: PL
DATE: 10/25/23
SHEET TITLE:

EQUIPMENT CABINET ELEVATIONS
SHEET NUMBER:

F — 6
WIK PAD & CANOPY REV 3 FINAL 10/16/23

RF CABINET LEFT ELEVATION **4** **E-6**
SCALE: N.T.S.

RF CABINET REAR ELEVATION **3** **E-6**
SCALE: N.T.S.

RF CABINET RIGHT ELEVATION **2** **E-6**
SCALE: N.T.S.

RF CABINET FRONT ELEVATION **1** **E-6**
SCALE: N.T.S.



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REV.	DATE	DESCRIPTION
1	12/27/23	REVISED FOR CONSTRUCTION
0	11/16/23	ISSUED FOR REVIEW
B	08/04/23	ISSUED FOR REVIEW
A	08/04/23	ISSUED FOR REVIEW




SITE INFORMATION:
LV MT VERNON EAST
321 FROSTY HOLLOW ROAD
MT VERNON, KY 40456
ROCK CASTLE COUNTY

SITE NUMBER:
721772
SITE NAME:
LV MT VERNON EAST
PID NUMBER: 16913443
DRAWN BY: RC
CHECKED BY: PL
DATE: 10/25/23
SHEET TITLE:

EQUIPMENT PAD
LIGHTING PLAN
SCALE: N.T.S.
SHEET NUMBER:
F — 7


WK PAD & CANOPY REV 3 FINAL 10/16/23

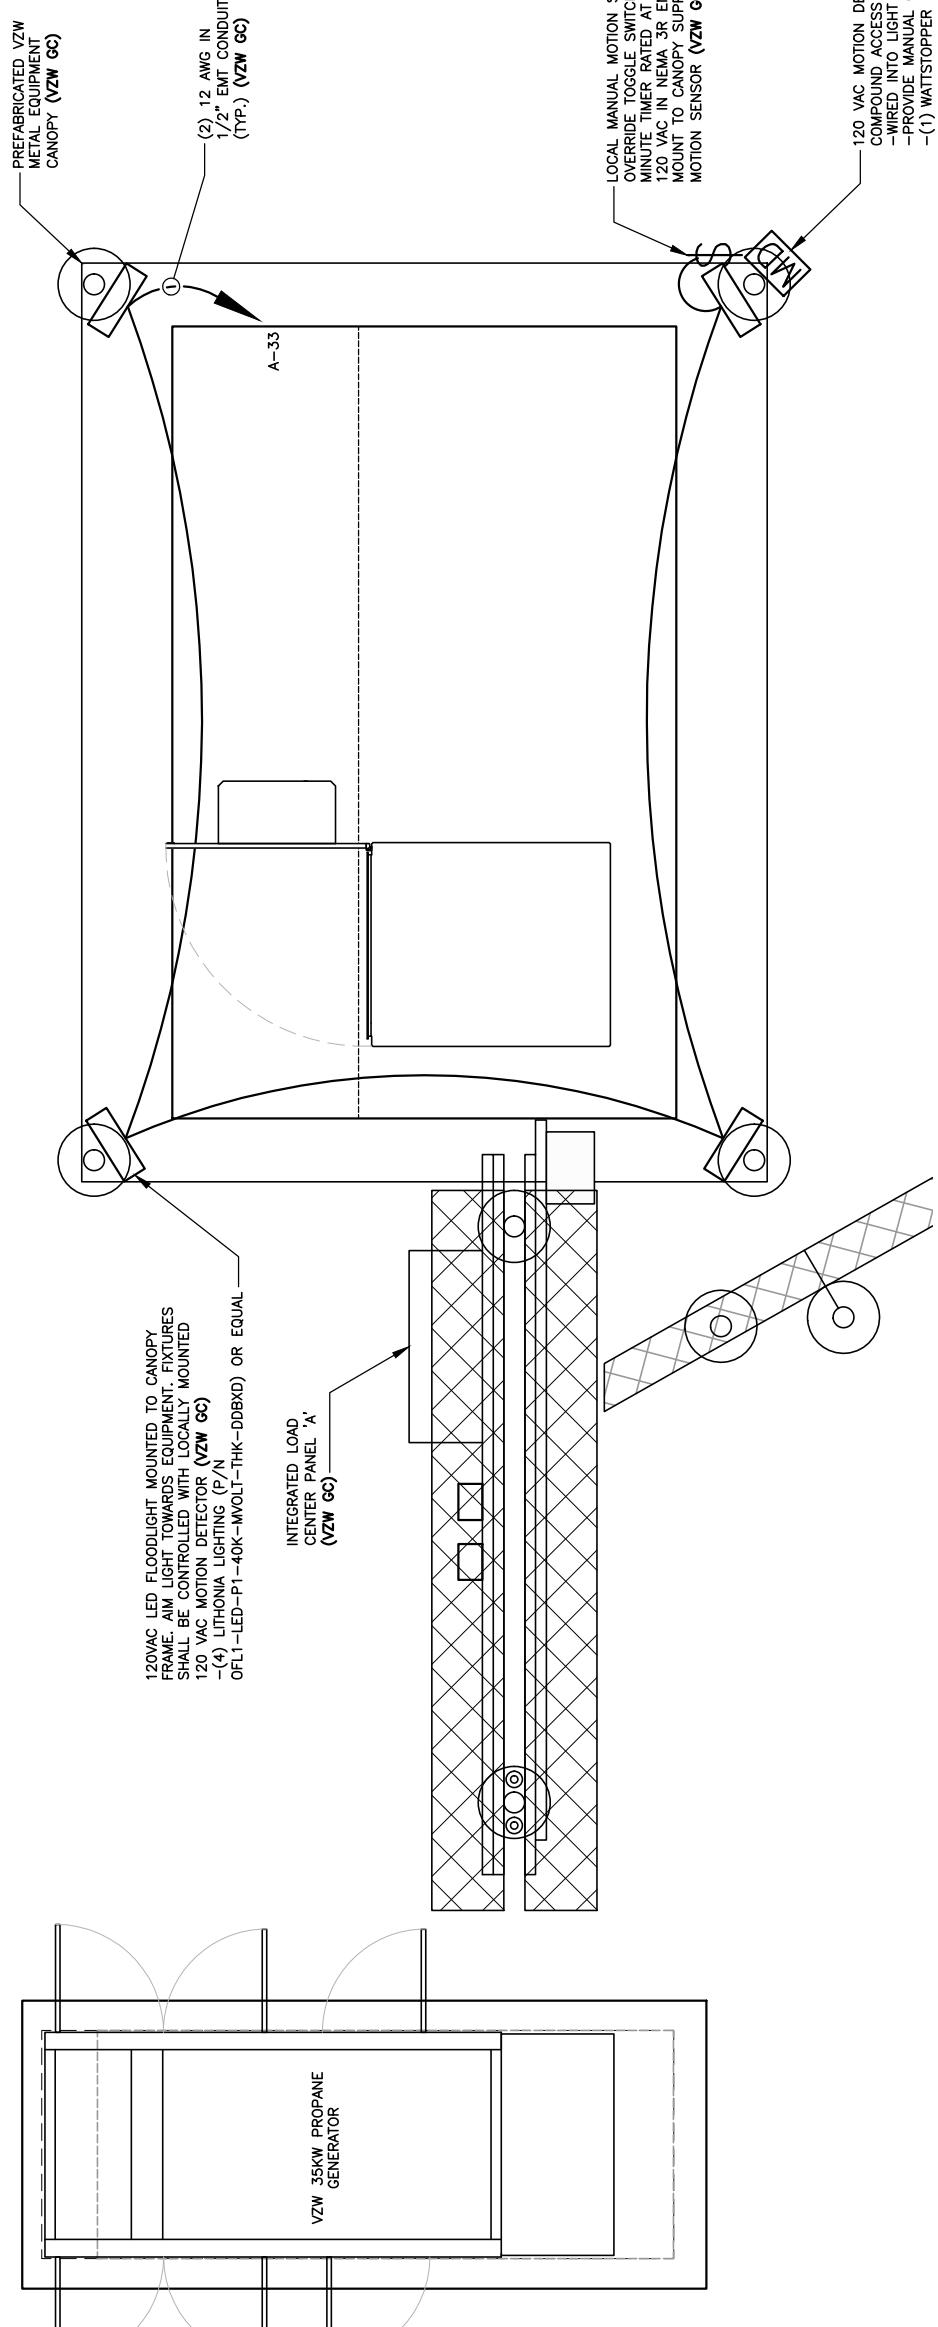

**EQUIPMENT PAD
LIGHTING PLAN**
1
E-7
NORTH
SCALE: N.T.S.

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SITE INFORMATION:
LV MT VERNON EAST
321 FROSTY HOLLOW ROAD
MT VERNON, KY 40456
ROCK CASTLE COUNTY


SITE NUMBER: 721772
SITE NAME: LV MT VERNON EAST
PID NUMBER: 16913443
DRAWN BY: RC
CHECKED BY: PL
DATE: 10/25/23
SHEET TITLE: ALARMING TABLE AND DETAILS (REFERENCE ONLY)
SHEET NUMBER: E—8

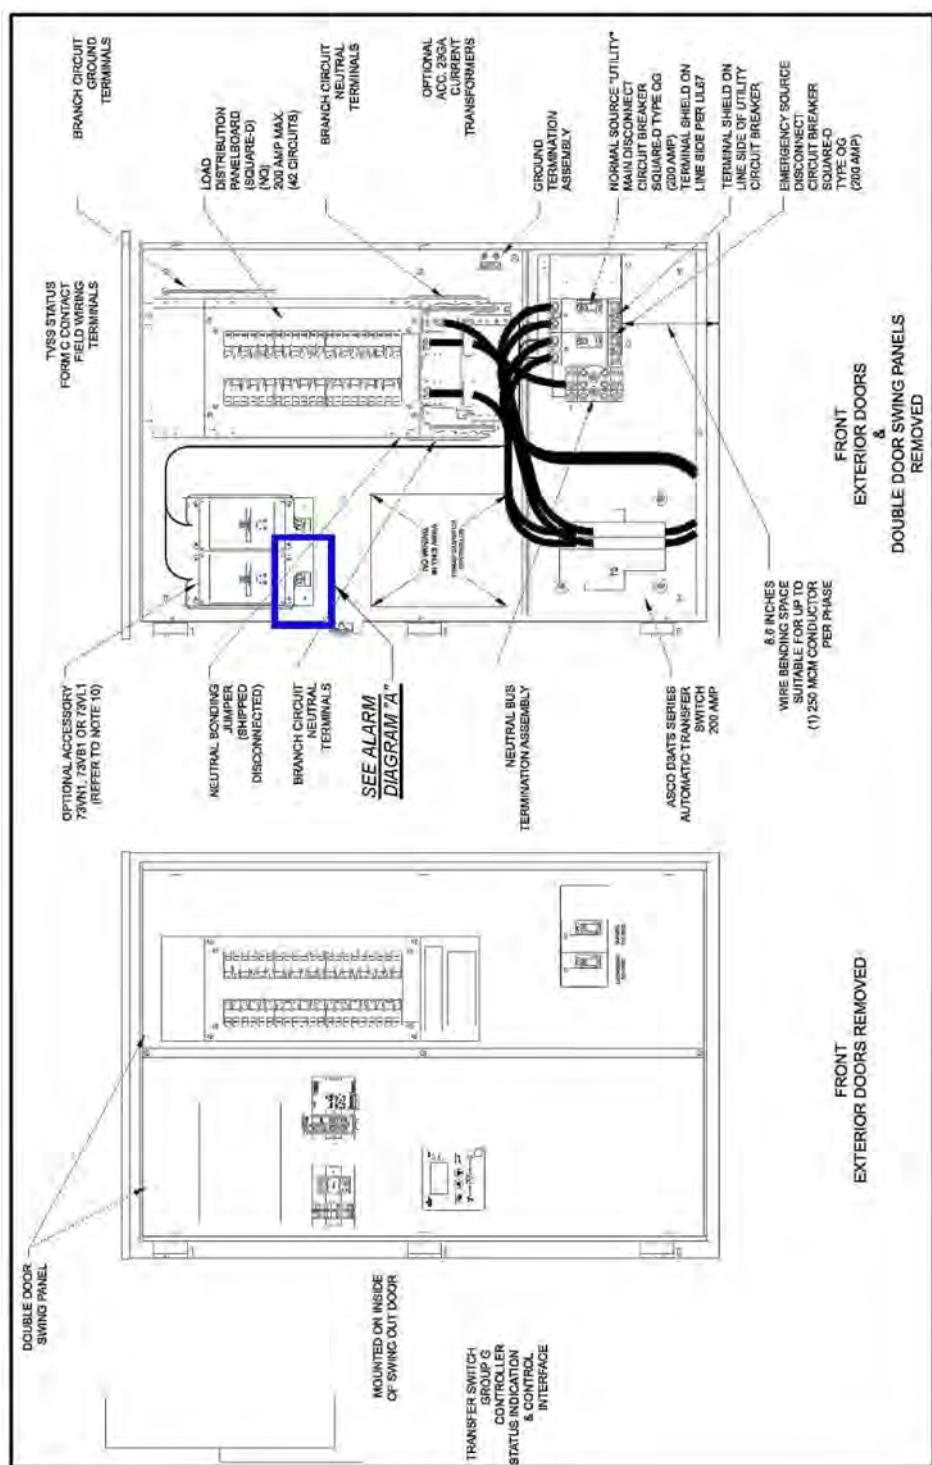NOTE: 1. VERIZON WIRELESS STANDARD ALARM CONTACT NORMALLY CLOSED
ALARM DIAGRAM "A"
SCALE: N.T.S.
E-8

A
E-8

WK PAD & CANOPY REV 3 FINAL 10/16/23

INTEGRATED LOAD CENTER DETAIL

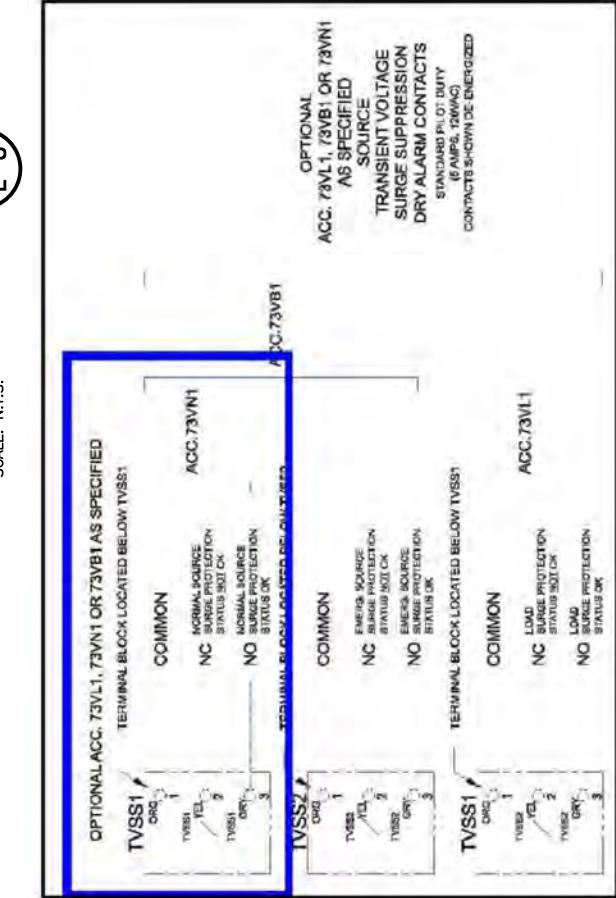

RMX-4000 Wiring - Install on right side of panel when facing front of panel					
Alarm block Pos	Wire color	Alarm	RMX-4000	Wire Color	Misc Wiring - left side of panel
1	White/Orange	Door Intrusion	1-4	White or Blue	Wire Color
2	Orange			Orange	Intrusion Alarm
3	White/Green	Commercial Power Failure	1-4	White or Blue	N/A
4	Green			White or Blue	N/A
5	White/Blue	Surge Suppressor Lighting	1-4	White or Blue	N/A
6	Blue	Arrester		White or Blue	N/A
7	White/Brown	Rectifier Failure	1-4	White or Blue	Green/White
8	Brown			Red/Green	Rectifier Failure
9	White/Orange	Multiple Rectifier Failure	5-8	Red or Blue	Rectifier Failure
10	Orange			White or Red	Multiple Rectifier Failure
11	White/Green	Battery Discharge	5-8	Red or Blue	Failure
12	Green			White	Battery Failure
13	White/Blue	Low Voltage	5-8	Red or Blue	Discharge
14	Blue			Black	High
15	White/Brown	DC Power Failure	5-8	Red or Blue	Low
16	Brown			Black/White	Voltage
17	White/Orange	Generator Running	9-12	Black or Blue	Fuse
18	Orange			N/A	High
19	White/Green	Generator Low Fuel	9-12	Black or Blue	Voltage
20	Green			N/A	Rectifier Failure
21	White/Blue	Generator Failure	9-12	Black or Blue	N/A
22	Blue			N/A	N/A
23	White/Brown	HVAC Failure	9-12	Black or Blue	N/A
24	Brown			N/A	N/A
25	White/Orange	High Temp	13-16	Yellow or Blue	White/Blue
26	Orange			Green	HVAC Failure
27	White/Green	Low Temp	13-16	Yellow or Blue	Overheat Alarm
28	Green			N/A	Overheat Alarm
29	White/Blue	Tower Light	13-16	Yellow or Blue	N/A
30	Blue			N/A	N/A
31	White/Brown	Tower Light Side	13-16	Yellow or Blue	N/A
32	Brown			N/A	N/A
33	White/Orange	RRH Upconverter Failure	17-20	Violet or Blue	RRH Upconverter Failure
34	Orange			Blue	N/A
35	White/Green	RRH Power Failure	17-20	Violet or Blue	N/A
36	Green			N/A	N/A
37	White/Blue	RRH High Humidity	17-20	Violet or Blue	N/A
38	Blue			N/A	N/A
39	White/Brown	RRH Intrusion	17-20	Violet or Blue	N/A
40	Brown			N/A	N/A
41	White/Orange	Smoke Fire	21-24	Blue	N/A
42	Orange			N/A	N/A
43	White/Green	Bus Bar Theft	21-24	Blue	N/A
44	Green			N/A	N/A
45	White/Blue	N/A	21-24	Blue	N/A
46	Blue			N/A	N/A
47	White/Brown	N/A	21-24	Blue	N/A
48	Brown			N/A	N/A
49	White/Orange	Microwave Critical	25-28	Orange or Blue	N/A
50	Orange			N/A	N/A
51	White/Green	Microwave Major	25-28	Orange or Blue	N/A
52	Green			N/A	N/A
53	White/Blue	Dehydrator Alarm	25-28	Orange or Blue	N/A
54	Blue			N/A	N/A
55	White/Brown	Fire Suppression Discharge	25-28	Orange or Blue	N/A
56	Brown			N/A	N/A
57	White/Orange	Fire Suppression Trouble	29-32	Green or Blue	N/A
58	Orange			N/A	N/A
59	White/Green	Secondary HVAC Running	29-32	Green or Blue	N/A
60	Green			N/A	N/A
61	White/Blue	Explosive Gas	29-32	Green or Blue	N/A
62	Blue			N/A	N/A
63	White/Brown	High Humidity	29-32	Green or Blue	N/A
64	Brown			N/A	N/A
65-84	N/A			N/A	N/A


ALARM WIRING TABLE
1
E-8
SCALE: N.T.S.



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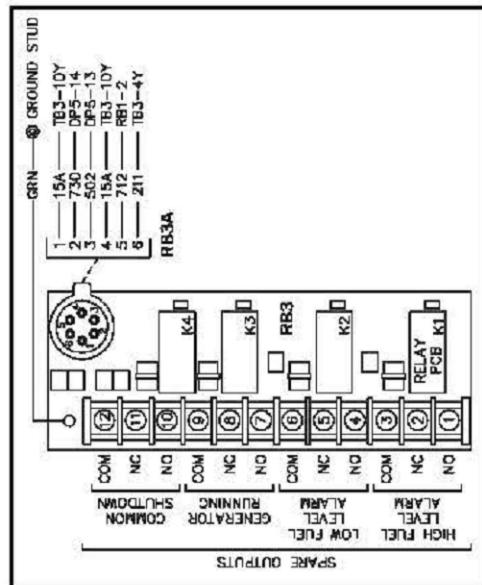
LAB

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PHONE: (248) 705-9212

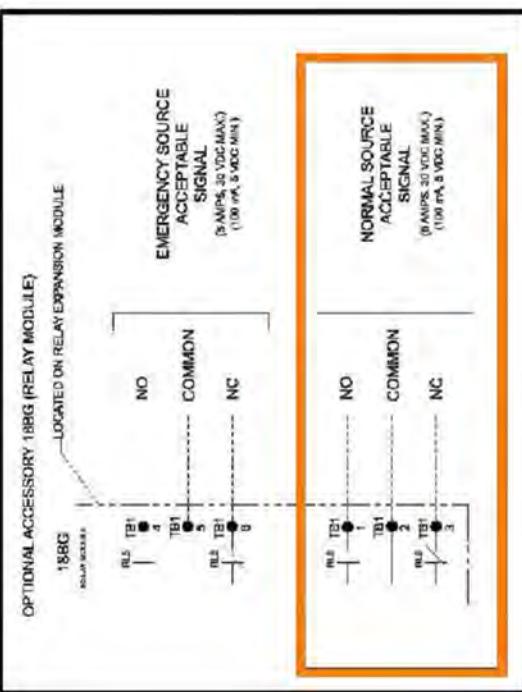

NOTE:
1. VERIZON WIRELESS STANDARD
ALARM CONTACT NORMALLY CLOSED

ALARM DIAGRAM "A" E-9



SITE INFORMATION:
LV MT VERNON
EAST

321 FROSTY HOLLOW ROAD
MT VERNON, KY 40456
ROCK CASTLE COUNTY

SITE NUMBER:
721772

SITE NAME:
LV MT VERNON EAST


SHEET NUMBER:
16913443

DRAWN BY:
RC
CHECKED BY:
PL
DATE:
10/25/23

**ALARMING DIAGRAMS
AND DETAILS
(REFERENCE ONLY)**

SHEET NUMBER:
F — 9

WK PAD & CNDY REV 3 FINAL 10/16/23

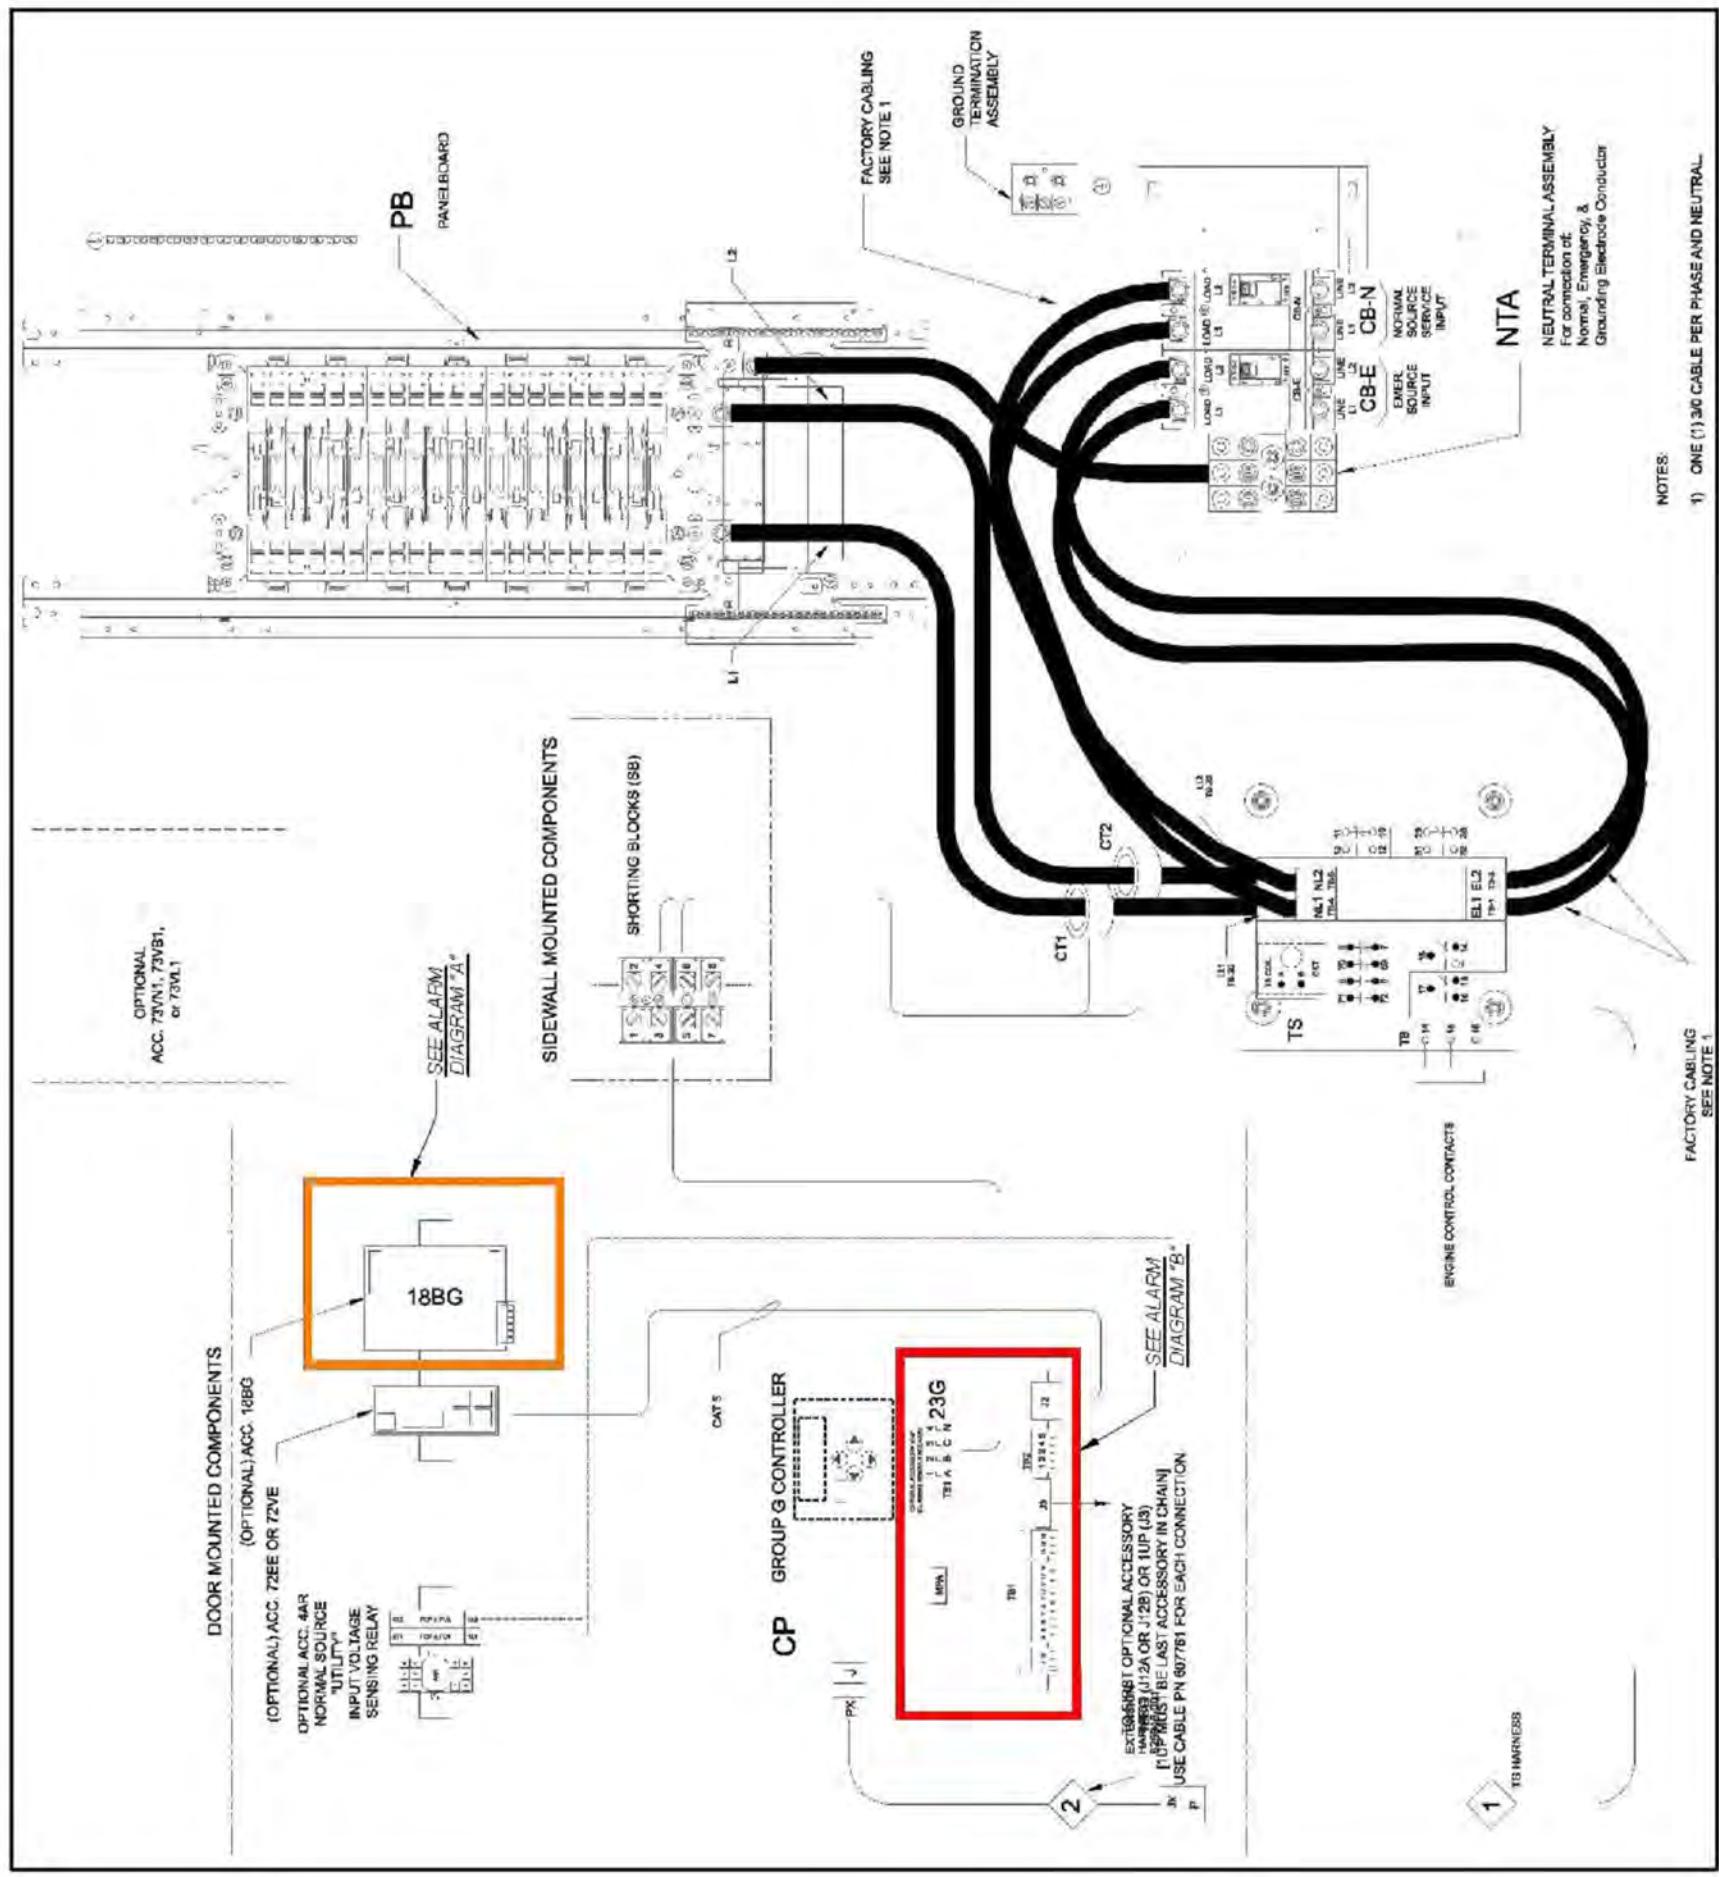



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REV.	DATE	DESCRIPTION
-	12/27/23	REVISED FOR CONSTRUCTION
0	11/16/23	ISSUED FOR REVIEW
A	08/04/23	ISSUED FOR REVIEW
B	08/16/23	ISSUED FOR REVIEW



SITE INFORMATION:
LV MT VERNON
EAST
321 FROSTY HOLLOW ROAD
MT VERNON, KY 40456
ROCK CASTLE COUNTY

SITE NUMBER:
721772

SITE NAME:
LV MT VERNON EAST

PID NUMBER: 16913443
DRAWN BY: RC
CHECKED BY: PL
DATE: 10/25/23

SHEET TITLE:
**ALARM AND FIBER
CABLE ROUTING
(REFERENCE ONLY)**

SHEET NUMBER:

E - 10

SCALE: N.T.S.
E-10

REV. D&C REV 3 FINAL 10/16/23

Alarm wiring for Cabinet

Remove old alarm block and install new panel DRP4722SW

Route wiring from RMX4000 to alarm panel. Wiring will be various colors or all blue as shown

If connector is connected to old alarm block, remove connector and wire to alarm panel

PROV VISUAL

Note: See wiring table on next page

Place alarm block label template on door

Jumper Office Alarm cable wires. Connector J4 position 16 (Blue/Red) and position 10 (Black/red)

Label Template

Updated template
4449 ALPHA 3449 BETA 4449 GAMMA 8843 ALPHA 8843 BETA 8843 GAMMA
6449 ALPHA 6449 BETA 6449 GAMMA 6449 ALPHA 6449 BETA 6449 GAMMA
LINK 1 4408 ALPHA 4408 BETA 4408 GAMMA LINK 1 4408 ALPHA 4408 BETA 4408 GAMMA
LINK 2

Route fibers out the backside of fiber tray. Separate fibers into Alpha, Beta, and Gamma. Route fibers out of fiber tray as shown.

Route fibers UNDER the 6630/6648 Shelf #1 to front side of the cabinet.

Note: Only install Aqua Module #4 if fibers are provided.

Note: Only install Aqua fibers if installed- label each end the same

Fiber 1
Fiber 2
Fiber 3

Alpha fibers
Beta fibers
Gamma fibers

FIBER ROUTING DETAIL 1 E-10

SCALE: N.T.S.

ALARM WIRING CONNECTIONS 2 E-10

SCALE: N.T.S.



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RICHMOND, KY 40475
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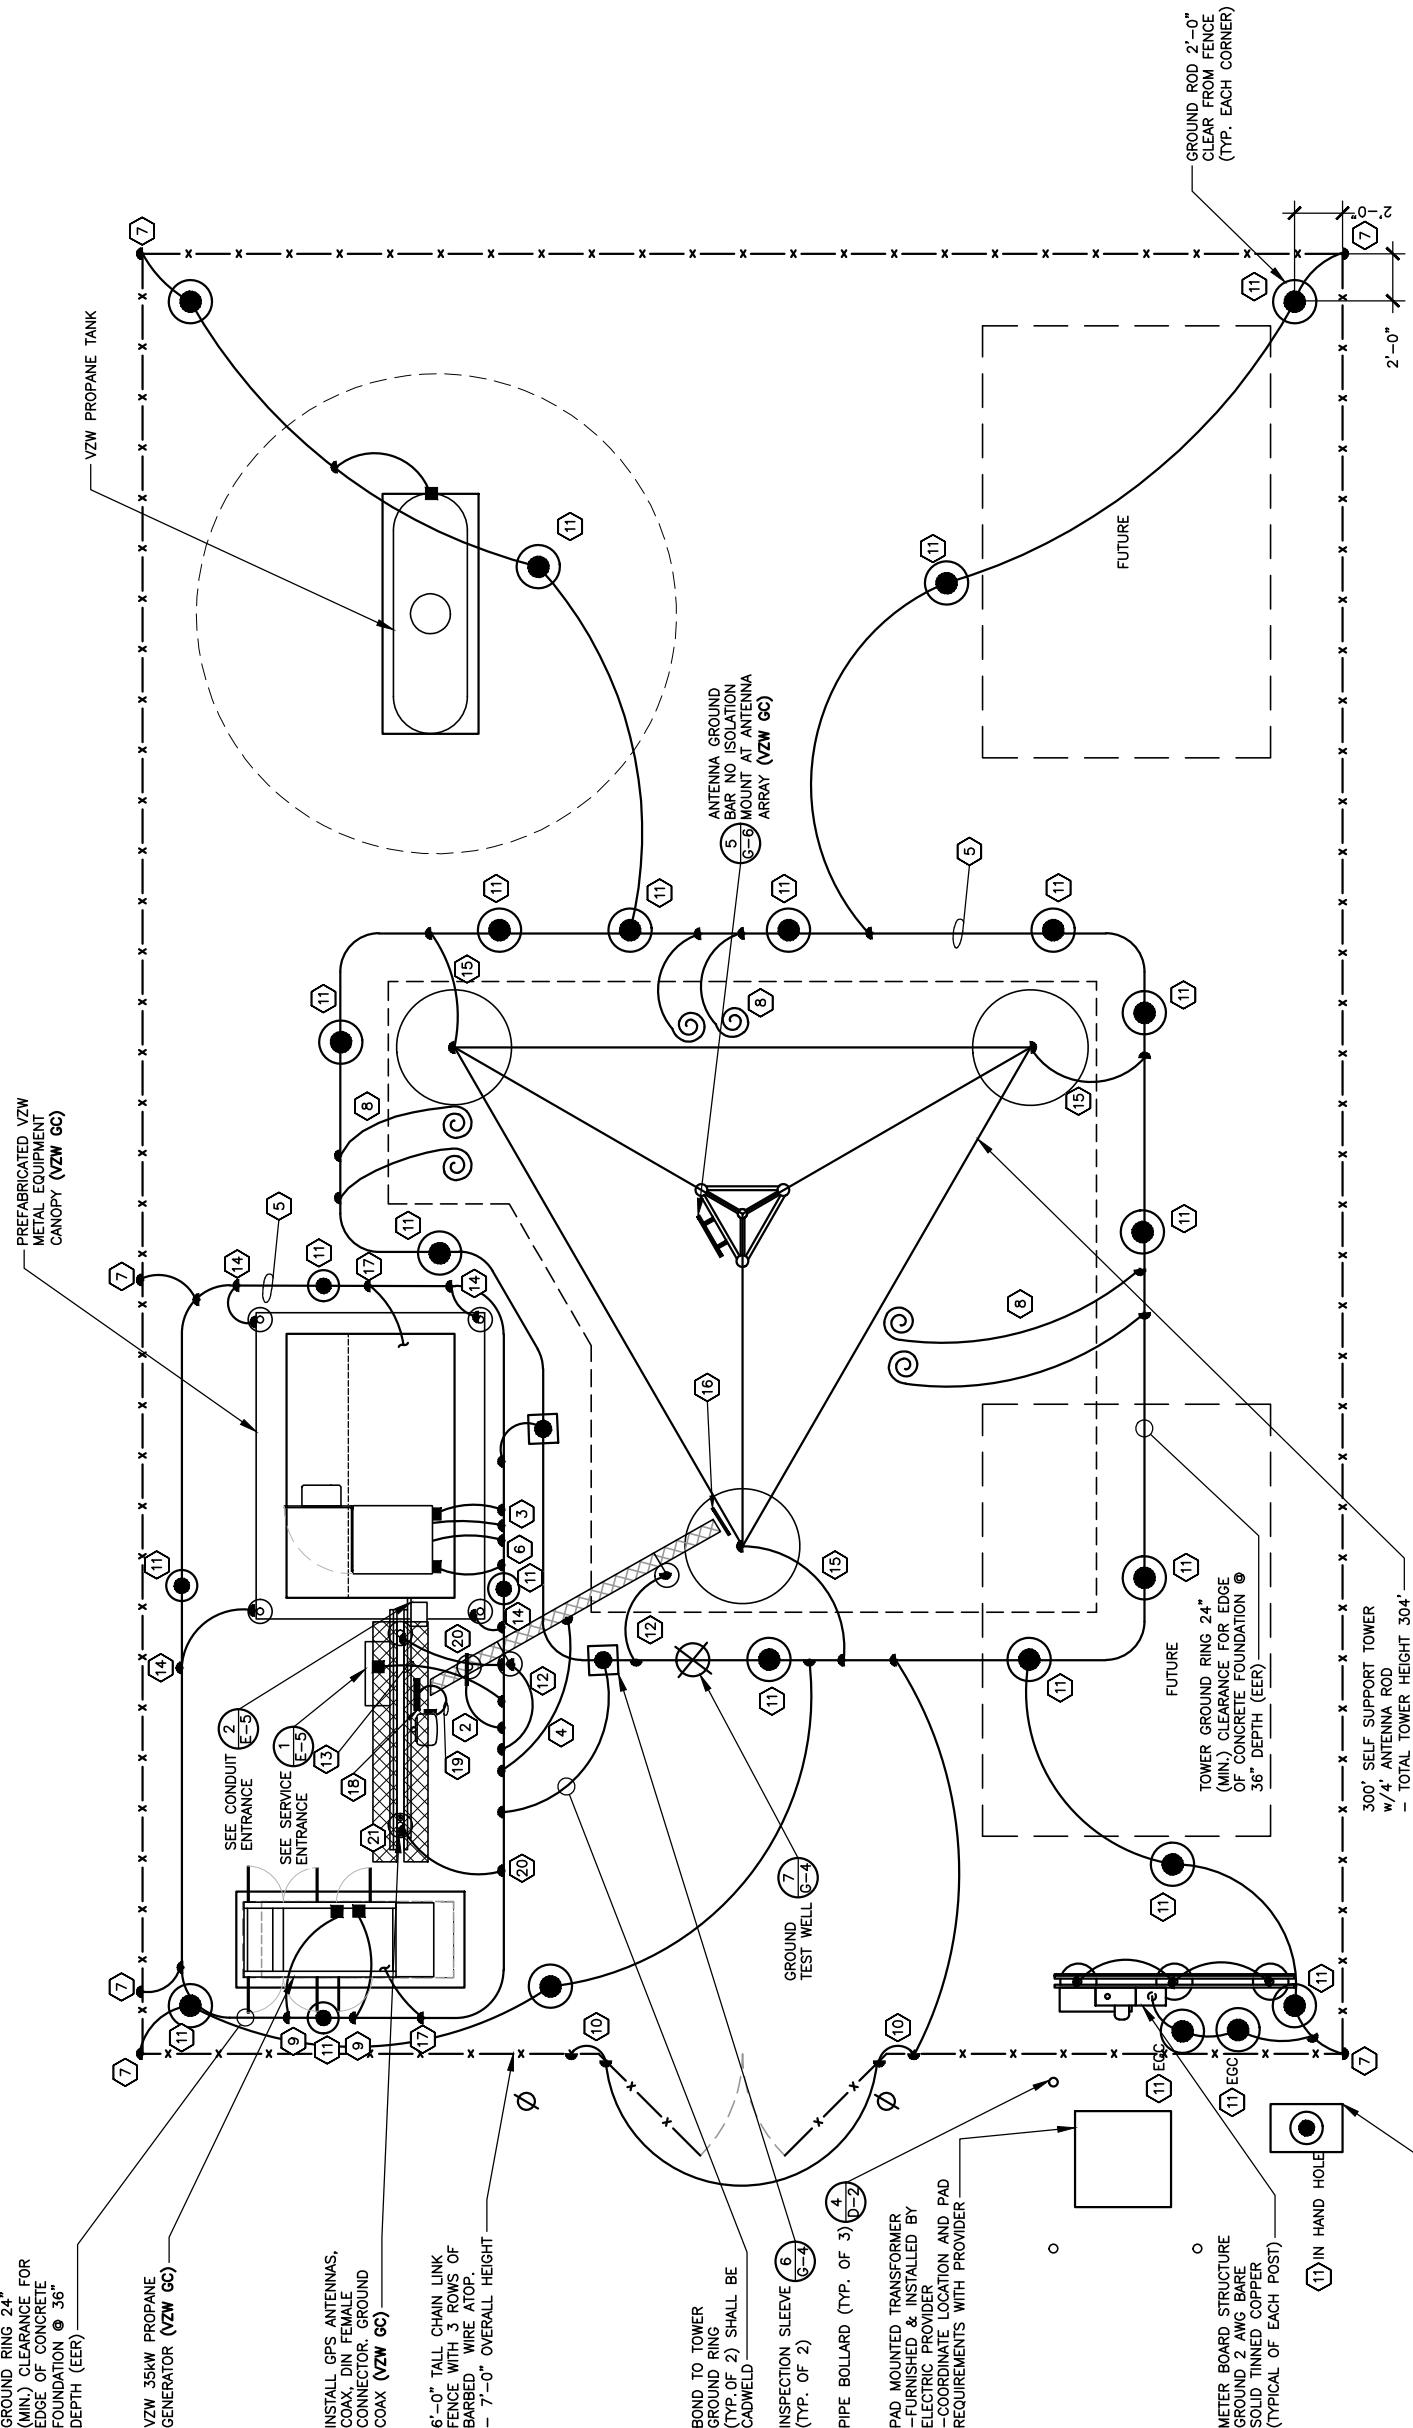


SITE INFORMATION:
LV MT VERNON
EAST
321 FROSTY HOLLOW ROAD
MT VERNON, KY 40456
ROCK CASTLE COUNTY

SITE NUMBER:
721772
SITE NAME:
LV MT VERNON EAST

PID NUMBER: 16913443
DRAWN BY: RC
CHECKED BY: PL
DATE: 10/25/23
SHEET TITLE: GROUNDING SITE PLAN
SHEET NUMBER: C — 1

WK PAD & CANOPY REV 3 FINAL 10/16/23



TOWER GROUND RING NOTES:
1. GROUNDING PLAN SHOWN IS FOR A PAD AND PIER TOWER FOUNDATION. IF THE TOWER OWNER ELECTS TO INSTALL A CAISSON FOUNDATION, THE TOWER GROUND RING (EER) WILL BE MODIFIED. THE TOWER GROUND RING (EER) SHALL BE INSTALLED PER VERIZON WIRELESS STANDARDS. 24" MIN. CLEARANCE FROM THE TOWER FOUNDATIONS AT 36" BELOW GRADE.
2. ALL GROUND RODS SHALL BE INSTALLED PER VERIZON WIRELESS STANDARDS.
3. ALL GROUND LEADS DEPICTED ON THIS PLAN SHALL BE MODIFIED TO CONNECT TO THE MODIFIED TOWER GROUND RING (EER) LOCATION.



GROUNDING SITE PLAN

SCALE: N.F.S.

- NOTES:
1. ALL ABOVE GRADE GROUND LEADS TO BE INSTALLED IN 1/2" NON-CONDUCTIVE FLEXIBLE PVC CONDUIT WITH ANTI-THEFT COMPOUND.
2. COORDINATE ICE BRIDGE POST GROUND LEAD INSTALLATION WITH ICE BRIDGE POST LOCATIONS ON SHEET S-1.
3. SEE SHEET G-2 FOR GROUNDING KEYED NOTES.



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TOWER OWNER GROUNDING NOTES

- ① BBG: FURN. & INST. 1 – 2/0 AWG INSULATED STRANDED COPPER GND. WIRE FOR BATTERY BAY GROUND (BBG) TO (EER). COIL UP 6' ABOVE GRADE. CONNECTION TO (EER) SHALL BE CADWELD.
- ② CEPSC: FURN. & INST. 1 – 2 AWG BARE SOLID TINNED COPPER GND. WIRE FOR CEPSG POST TO (EER).
- ③ CG: FURN. & INST. 2 – 2 AWG BARE SOLID TINNED COPPER GND. WIRE FOR CABINET GROUND (CG) TO (EER).
- ④ CSG: COIL UP 6' ABOVE GRADE. CONNECTION (EER) SHALL BE CADWELD.
- ⑤ EER: FURN. & INST. 2 AWG BARE SOLID TINNED COPPER BURIED EXTERIOR ELECTRODE GROUND RING (EER) AROUND RADIO EQUIPMENT PAD AND TOWER BURIED AT 36" OR 6" BELOW FROST LINE (WHICHEVER IS GREATER). MAINTAIN 24" FROM EQUIPMENT PAD AND TOWER FOUNDATIONS MINIMUM.
- ⑥ FEC: FURN. & INST. 1 – 2 AWG BARE SOLID TINNED COPPER GND. WIRE FOR FIBER ENTRANCE GROUND (FEC) TO (TGE). COIL UP 10' ABOVE GRADE. CONNECTION TO (EER) SHALL BE CADWELD.
- ⑦ FG: FURN. & INST. 1 – 2 AWG BARE SOLID TINNED COPPER GND. WIRE FROM NEW FENCING TO GROUND RING (EER). CONNECTION TO FENCING SHALL BE AT THE BASE OF FENCE POST USING CADWELD AND WEAVE GND. WIRE THRU FABRIC AND ATTACH TO TOP RAIL WITH CADWELD. CONNECTION TO (EER) SHALL BE CADWELD.
- ⑧ FWGL: FURN. & INST. FUTURE TOWER WAVEGUIDE GROUND BAR LEADS. CONTRACTOR SHALL COIL UP TEN (10') OF 2 AWG SOLID TINNED COPPER GROUND (FWGL).
- ⑨ GEG: FURN. & INST. 1 – 2 AWG BARE SOLID TINNED COPPER GND. WIRE FOR THE GENERATOR ENCLOSURE TO (EER). COIL UP 6' ABOVE GRADE. CONNECTION (EER) SHALL BE CADWELD. *GENERATOR SERVICE GROUND WHERE REQUIRED BY JURISDICTION - HAVING AUTHORITY.
- ⑩ GC: FURN. & INST. 1 – 2 AWG BARE SOLID TINNED COPPER GND. WIRE AT EACH GATE POST AND PROVIDE GROUND WIRE TO BONDING JUMPER FROM GATE POST TO FENCE POST.
- ⑪ GRE: FURN. & INST. SPACING OF GND. RODS TO 36" BELOW FROST LINE (OR 6" BELOW FROST LINE, WHICHEVER IS GREATER) AT A MINIMUM. SPACING OF 10'-0" AT RADIO EQUIPMENT PAD, TOWER AND SITE EXTERIOR GROUND SYSTEM. CONNECTION TO (EER) SHALL BE CADWELD. REFER TO DETAIL 5 ON SHEET G-4.
- ⑫ IBSG: FURN. & INST. 1 – 2 AWG BARE SOLID TINNED COPPER GND. WIRE FROM ICE BRIDGE SUPPORT POST TO (EER). CONNECTION (EER) SHALL BE CADWELD. SEE SHEET S-1 FOR ICE BRIDGE POST LOCATIONS.
- ⑬ PEG: FURN. & INST. 1 – 2 AWG BARE SOLID TINNED COPPER GND. WIRE FOR THE 'I'C GROUND BAR TO (EER). COIL UP 6' ABOVE GRADE. CONNECTION (EER) SHALL BE CADWELD.
- ⑭ PCSG: FURN. & INST. 1 – 2 AWG BARE SOLID TINNED COPPER GND. WIRE FOR EACH PAD CANOPY SUPPORT BASE TO (EER). COIL UP 6' ABOVE GRADE. CONNECTION TO (EER) SHALL BE CADWELD.
- ⑮ TBG: FURN. & INST. 1– 2 AWG BARE SOLID TINNED COPPER GND. WIRE FROM TOWER LEG BASE PLATE TO (EER). CONNECTION TO TOWER LEG BASE PLATE SHALL BE CADWELD OR MECHANICAL TO LEG AND (EER) SHALL BE CADWELD.
- ⑯ TWG: FURN. & INST. 1 – 2 AWG BARE SOLID TINNED COPPER GND. WIRE (UFER GROUND) FOR PAD FOUNDATION REINFORCEMENT STEEL CONNECTION TO (EER) SHALL BE CADWELD. PROVIDE HEAT SHRINK TAPE PROTECTION FOR CONDUCTOR AT TRANSITION BETWEEN CONCRETE AND SOIL.
- ⑰ UG: BY VZN E.C.
- ⑱ OGA: BY VZN E.C.
- ⑲ OGL: BY VZN E.C.
- ⑳ OHG: FURN. & INST. 2 – 2 AWG BARE SOLID TINNED COPPER GND. WIRE FOR THE 'OVP' H-FRAME TO (EER). (TP) OF 2 POSTS. CONNECTION (EER) SHALL BE CADWELD.
- ㉑ GPSG: BY VZN E.C.

LEGEND	
BBG	BATTERY BAY GROUND
CEPSG	COAX ENTRY PROTECTION SYSTEM GROUND
CG	CABINET GROUND
CSC	SUPPORT GROUND
EER	BURIED EXTERIOR ELECTRODE GROUND RING
ECC	EQUIPMENT GROUNDING CONDUCTOR (NEC DESIGNATION)
FEG	FIBER ENTRANCE GROUND
FG	FENCE GROUND
FTWGL	FUTURE TOWER WAVEGUIDE GROUND LEAD
GEC	GROUNDING ELECTRODE GROUND
GES	ENCLOSURE GROUND
GG	GATE GROUND
GPGS	GPS ANTENNA MOUNT GROUND
GRE	GROUND ROD ELECTRODE
IBSG	ICE BRIDGE SUPPORT GROUND
OGA	OVP GROUND ASSEMBLY
OGL	OVP GROUND LEAD
OHG	OVP H-FRAME SUPPORT GROUND
PEG	POWER ENTRANCE GROUND
POSG	PAD CANOPY SUPPORT GROUND DOWN LEAD
TBG	TOWER BASE GROUND
TWG	TOWER WAVEGUIDE GROUND ASSEMBLY
UFG	UFER GROUND (PIER FOUNDATION)
•	CABLE TO CABLE CADWELD CONNECTION
○	CABLE TO GND. ROD CADWELD CONNECTION
☒	TEST WELL
□	INSPECTION PORT CABLE TO CABLE CADWELD CONNECTION



SITE INFORMATION:
LV MT VERNON EAST
321 FROSTY HOLLOW ROAD
MT VERNON, KY 40456
ROCK CASTLE COUNTY

SITE NUMBER:
721772
SITE NAME:
LV MT VERNON EAST
PID NUMBER: 16913443
DRAWN BY: RC
CHECKED BY: PL
DATE: 10/25/23
SHEET TITLE:

GROUNDING NOTES
SHEET NUMBER:
C — 2
WK PAD & CANOPY REV 3 FINAL 10/16/23



TAG TOWERS, LLC
3 FORBES COURT, SUITE
RICHMOND, KY 40475
859.544.5000 (PH)

9

9030 Pontiac Trail, Suite 100
Wixom, Michigan 48393
PHONE: (248) 705-9212

PREFABRICATED VZW
METAL EQUIPMENT
CANOPY (VZW GC)

GROUND RING 24"
(MIN.) CLEARANCE FOR
EDGE OF CONCRETE
FOUNDATION @ 36"
DEPTH (EER)

VZW 35kW PROPANE
GENERATOR (VZW GC) -

INSTALL GPS ANTENNAS,
COAX, DIN FEMALE
CONNECTOR. GROUND
COAX (ZW GC)

LEGEND

BIG	BATTERY BAY GROUND
CESPG	COAX ENTRY PROTECTION SYSTEM GROUND
CG	CABINET GROUND
CSG	CABLE SUPPORT GROUND
EER	BURIED EXTERIOR ELECTRODE GROUND RING
EGC	EQUIPMENT GROUNDING CONDUCTOR (NEC DESIGNATION)
FEG	FIBER ENTRANCE GROUND
FG	FENCE GROUND
FTW	FIELD TOWER WAVEGUIDE GROUND LEAD
GEC	GROUNDING ELECTRODE CONDUCTOR (NEC DESIGNATION)
GEG	GENERATOR ENCLOSURE GROUND
GES	GROUNDING ELECTRICAL SYSTEM (NEC DESIGNATION)
CG	CATE GROUND
GPSG	GPS ANTENNA MOUNT GROUND
GRE	GROUND ROD ELECTRODE
IBSG	ICE BRIDGE SUPPORT GROUND
OGA	OVP GROUND ASSEMBLY
OGL	OVP GROUND LEAD
OHG	OVP H-FRAME SUPPORT GROUND
PEG	POWER ENTRANCE GROUND
PSG	PAD CANOPY SUPPORT GROUND DOWN LEAD
TBS	TOWER BASE GROUND
TWG	TOWER WAVEGUIDE GROUND ASSEMBLY
UG	UTTER GROUND (FIER FOUNDATION)
●	CABLE TO GND, CADWELD CONNECTION
TEST WELL	TEST WELL
INSPECTION PORT	INSPECTION PORT
CABLE CADWELD CONNECTION	CABLE CADWELD CONNECTION

VERIZON WIRELESS GROUNDING KEYED NOT

SCALE: NT\$.

CAFE: N.T.S.

- | VERIZON WIRELESS GROUNDING KETED NOTES | |
|--|--|
| ① B8G: | VZN E.C. SHALL CONNECT THE 1 – 2/0 AWG INSULATED STRANDED COPPER GND. WIRE COILED UP BY THE TOWER OWNER E.C. FOR THE BATTERY BAY GROUND (BBG). CONNECTION TO THE GROUND BAR IN THE BATTERY BAY SHALL BE MECHANICAL. ROUTE LEAD IN LIQUIDTIGHT FLEXIBLE NONMETALLIC CONDUIT w/ANTI-THEFT CONDUIT. |
| ② CEPSC: | VZN E.C. SHALL FURNISH & INSTALL THE THEFT DETERRENT POST ASSEMBLY PART # DSACP14 FOR THE COAX ENTRY PROTECTION SYSTEM (AS MFG'D. BY ERICO LTD) AND SUPPLIED BY VZN E.C. TO THE POST. CONNECT THE 2 AWG BARE SOLID TINNED COPPER COILED UP BY TOWER OWNER E.C. TO THE POST. THE CONNECTION TO POST SHALL BE CADWELD. REFER TO THE GENERAL INSTALLATION GUIDE AS SUPPLIED WITH THEFT DETERRENT POST MOUNT GROUND ASSEMBLY. SEE DETAIL 1 ON SHEET G-5 FOR DETAILS. |
| ③ CG: | VZN E.C. SHALL FURNISH & INSTALL TWO HOLE LONG BARREL LUGS ON EXISTING 2 AWG BARE TINNED COPPER LEADS. VZN E.C. SHALL FURNISH & INSTALL DRAGON TOOTH WASHERS AND #8 STAINLESS STEEL FASTENERS ON ALL EQUIPMENT CABINET EXTERIOR GROUND LOCATIONS (TYP. 2 PER CABINET). REMOVE ALL SURFACE PAINT AND USE ANTIODIXENT COMPOUND BETWEEN METAL AND WASHER. ALL LEADS SHALL BE DRESSED TO REDUCE TRIP HAZARDS. DETAIL 3 ON SHEET G-5 FOR DETAILS. |
| ④ CSG: | BY TOWER OWNER E.C. |
| ⑤ EER: | BY TOWER OWNER E.C. |
| ⑥ FEG: | VZN E.C. SHALL BRING THE 2 AWG BARE SOLID TINNED COPPER GND. WIRE COILED UP BY TOWER OWNER E.C. FOR (FIBER ENTRANCE GROUND) INTO THE POWER PLANT CABINET AND MAKE A MECHANICAL CONNECTION TO THE FIBER SERVICE GROUND POINT. ROUTE LEAD IN FLEXIBLE NONMETALLIC CONDUIT w/ANTI-THEFT CONDUIT. |
| ⑦ FG: | BY TOWER OWNER E.C. |
| ⑧ FWGL: | VZN E.C. SHALL CONNECT THE 1 – 2 AWG BARE SOLID TINNED COPPER GND. WIRE COILED UP BY TOWER OWNER E.C. FOR THE GENERATOR ENCLOSURE. CONNECTION TO GENERATOR INCLOSURE SHALL BE MECHANICAL. ROUTE LEAD IN FLEXIBLE NONMETALLIC CONDUIT w/ANTI-THEFT CONDUIT. *GENERATOR SERVICE GROUND |
| ⑨ GEG: | FOR GPS ANTENNA MOUNT POLE TO H-FRAME SUPPORT POST (TYP. OF 2). CONNECTION TO PIPE AND POST SHALL BE CADWELD. |
| ⑩ GG: | BY TOWER OWNER E.C. |
| ⑪ GRE: | BY TOWER OWNER E.C. |
| ⑫ IBCS: | BY TOWER OWNER E.C. |
| ⑬ PEG: | VZW E.C. SHALL CONNECT 1 – 2 AWG BARE SOLID TINNED COPPER GND WIRE FOR THE POWER ENTRANCE GROUND (PEG) COILED UP BY TOWER OWNER E.C. CONNECTION OF THE COILED WIRE TO THE INTEGRATED LOAD CENTER GND BAR SHALL BE MECHANICAL. ROUTE LEAD IN FLEXIBLE NONMETALLIC CONDUIT w/ANTI-THEFT CONDUIT. |
| ⑭ PCSG: | VZW E.C. SHALL CONNECT SOLID TINNED COPPER ONE HOLE GROUND TAB TO COILED UP GROUND WIRE BY TOWER OWNER E.C. WITH AN EXOTHERMIC CONNECTION. THE CONNECTION OF THE COILED GROUND WIRE AND LUG TO THE CANOPY SUPPORT BASE SHALL BE MECHANICAL. SEE DETAIL 3 ON SHEET G-5. ROUTE LEAD IN FLEXIBLE NONMETALLIC CONDUIT w/ANTI-THEFT CONDUIT. |
| ⑮ TBG: | BY TOWER OWNER E.C. |
| ⑯ TWG: | VZW E.C. SHALL FURN. & INST. THEFT DETERRENT GROUND ASSEMBLY KIT PART #TDGAPC14 FOR THE TOWER WAVEGUIDE GROUND (TWG) DIRECTLY TO THE TOWER (SEE SITE SPECIFIC GROUNDING PLAN OF DESIGN DRAWINGS). |
| ⑰ UG: | BY TOWER OWNER E.C. |
| ⑱ OGA: | VZW E.C. SHALL FURN. & INST. THEFT DETERRENT GROUND ASSEMBLY KIT PART #TDGAPC14 FOR THE OPG GROUND (OGL) DIRECTLY TO THE OPG H-FRAME POST. SEE DETAIL 4 ON SHEET G-5. |
| ⑲ OGL: | VZW E.C. SHALL FURN. & INST. 1 – 6 AWG GREEN INSULATED STRANDED COPPER GND. WIRE FROM OPG GROUND ASSEMBLY (OGA). CONNECTION TO GROUND BAR SHALL BE MECHANICAL. |
| ⑳ OHG: | BY TOWER OWNER E.C. |
| ㉑ GPSG: | VZW E.C. SHALL FURN. & INST. 1 – 2 AWG BARE SOLID TINNED COPPER GND. WIRE FOR GPS ANTENNA MOUNT POLE TO H-FRAME SUPPORT POST (TYP. OF 2). |

VERIZON WIRELESS CABLE INIDING NOTES



SITE INFORMATION:
LVM VERNON

EAST
321 FROSTY HOLLOW ROAD
MT VERNON, KY 40456
ROCK CASTLE COUNTY

SITE NUMBER:

721772

SITE NAME:

V MT VERNON EAST

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109 | 3443

DRAWN BY: RC

PL 10-25-23
HECKED BY:
ATE:

SHEET TITLE.

VERIZON WIRELESS

VERZON WILLENS

AND NOTES

SHEET NUMBER:






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TAG
TOWERS
108 FOREST COURT, SUITE 1
RICHMOND, KY 40475
859-544-5000 (PH)

LAB

49030 Portiac Trail, Suite 100
Wixom, Michigan 48393
PHONE: (248) 705-9212



REV.	DATE	DESCRIPTION
-	12/27/23	REVISED FOR CONSTRUCTION
0	11/16/23	ISSUED FOR REVIEW
B	08/16/23	ISSUED FOR REVIEW
A	08/04/23	ISSUED FOR REVIEW

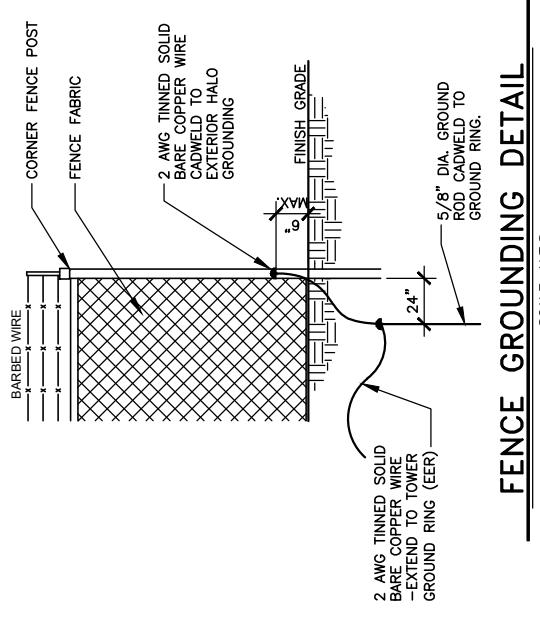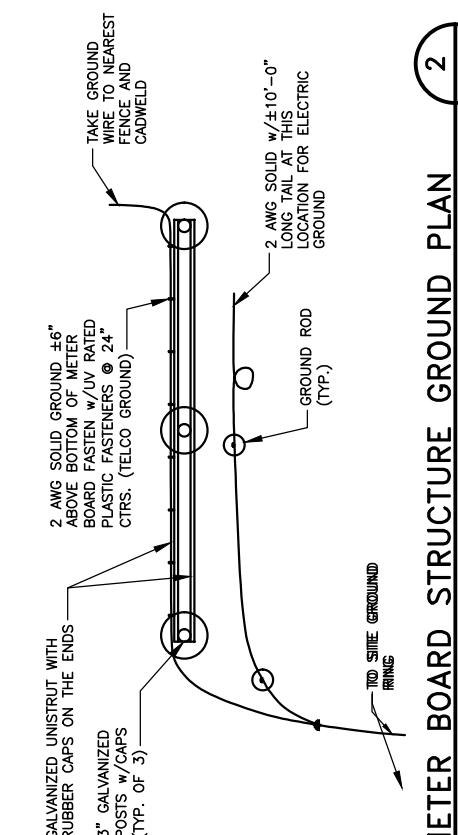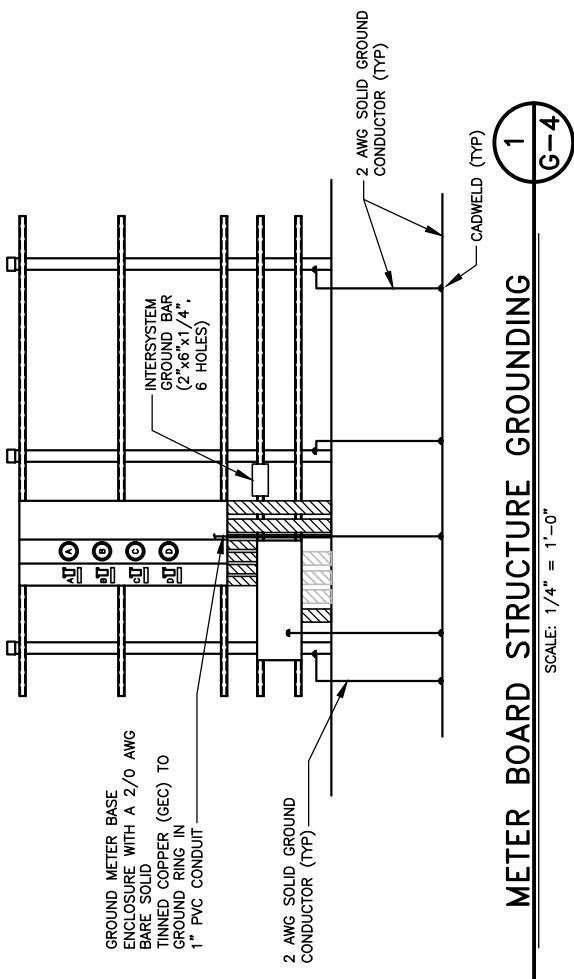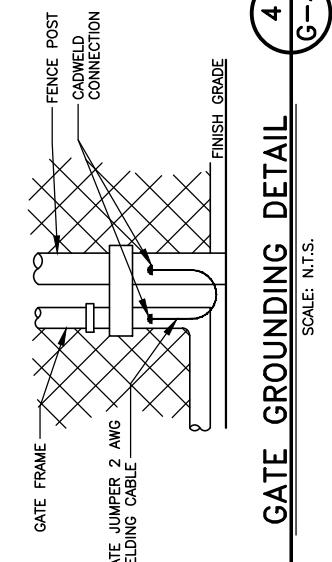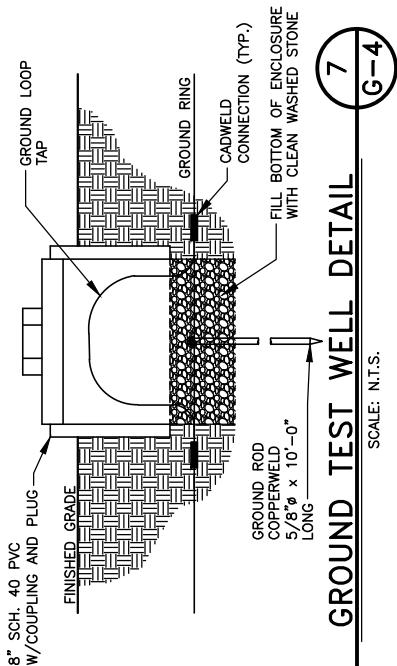

SITE INFORMATION:

LV MT VERNON
EAST
321 FROSTY HOLLOW ROAD
MT VERNON, KY 40456
ROCK CASTLE COUNTY

SITE NUMBER:
721772

SITE NAME:
LV MT VERNON EAST
PID NUMBER: 16913443
DRAWN BY: RC
CHECKED BY: PL
DATE: 10/25/23
SHEET TITLE:

GROUNDING DETAILS
SHEET NUMBER:

C — 4
WIK PAD & CANOPY REV 3 FINAL 10/16/23



TAG TOWERS LLC
108 FOREST COURT, SUITE 1
RICHMOND, KY 40475
859-544-5000 (PH)

LAB

49030 Portiac Trail, Suite 100
Wixom, Michigan 48393
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1	12/27/23	REVISED FOR CONSTRUCTION
0	11/16/23	ISSUED FOR REVIEW
B	08/04/23	ISSUED FOR REVIEW
A	08/04/23	ISSUED FOR REVIEW



SITE INFORMATION:
LV MT VERNON

EAST
321 FROSTY HOLLOW ROAD
MT VERNON, KY 40456
ROCK CASTLE COUNTY

SITE NUMBER:
721772


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LV MT VERNON EAST

PID NUMBER: 16913443
DRAWN BY: RC
CHECKED BY: PL
DATE: 10/25/23


GROUNDING DETAILS

SHEET NUMBER:
G—5

WIK PAD & CANOPY REV 3 FINAL 10/16/23

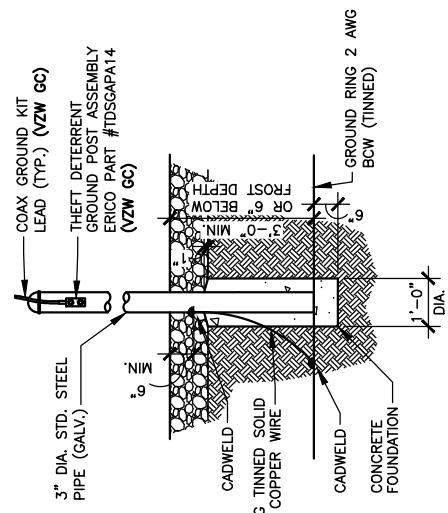

THEFT DETERRENT POST MOUNT GROUND DETAIL (CEPSG) 1 G-5

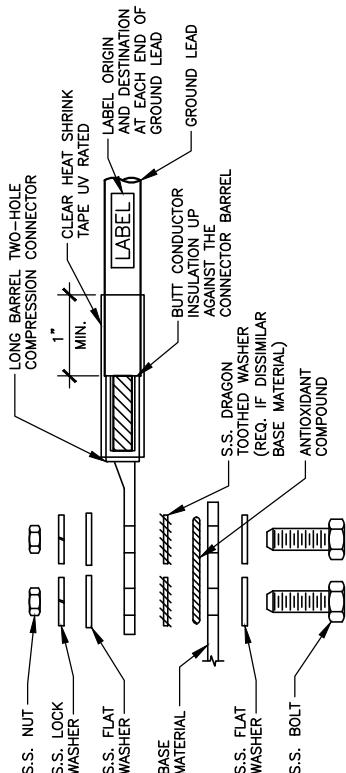


1. ALL HARDWARE SHALL BE 18-8 STAINLESS STEEL.
2. CHOOSE BOLT LENGTH TO ALLOW EXPOSURE OF AT LEAST TWO THREADS.
3. BACK TO BACK LUG CONNECTIONS ARE ACCEPTABLE WHEN BONDED TO A GROUND BAR OR ANY OTHER OBJECT.
4. AT CONNECTIONS MADE TO STEEL OR ANY OTHER DISSIMILAR METALS, A DRAGON TOOTH WASHER SHALL BE USED BETWEEN THE CONNECTOR AND METAL.
5. IF NO DRAGON TOOTH WASHER IS USED, THOROUGHLY REMOVE A SECTION OF THE COATING APPROXIMATELY THE SIZE OF THE CONNECTOR WITH AN ABRASIVE STYLE TOOL.
6. NO-OX ID ANTI-OXIDATION COMPOUND (SANCHEM) SHALL BE USED AT ALL COPPER TO COPPER CONNECTIONS.
7. A ZINC BASED (GRAY COLORED) ANTI-OXIDATION COMPOUND SHALL BE USED AT ALL COPPER TO STEEL CONNECTIONS.
8. PENTRON OR EQUAL ANTI-OXIDATION COMPOUND SHALL BE USED AT ALL COPPER TO ALUMINUM CONNECTIONS.

GROUND LUG INSTALLATION DETAIL 2 G-5

SCALE: N.T.S.
(BY VZW GC)

OVP GROUND ASSEMBLY (OGA) 3 G-5

SCALE: N.T.S.
(BY VZW GC)

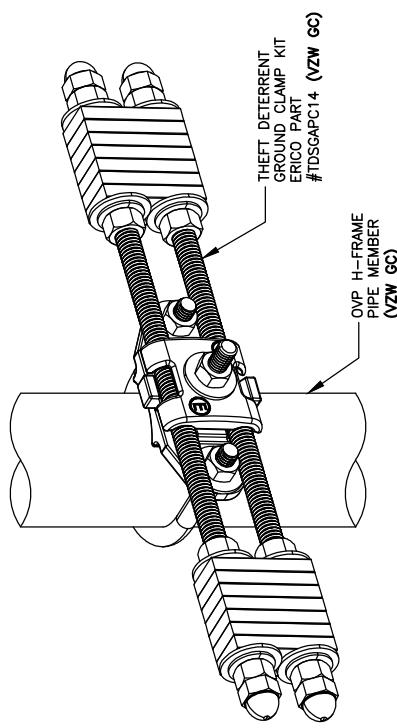

OVP GROUND ASSEMBLY (OGA) 3 G-5

SCALE: N.T.S.
(BY VZW GC)



TAG
TOWERS
108 FOREST COURT, SUITE 1
RICHMOND, KY 40475
859-544-5000 (PH)

LAB


49030 Portia Trail, Suite 100
Wixom, Michigan 48393
PHONE: (248) 705-9212



SITE INFORMATION:
LV MT VERNON
EAST
321 FROSTY HOLLOW ROAD
MT VERNON, KY 40456
ROCK CASTLE COUNTY



SITE NUMBER:
721772
SITE NAME:
LV MT VERNON EAST
PID NUMBER: 16913443
DRAWN BY: RC
CHECKED BY: PL
DATE: 10/25/23
SHEET TITLE:
GROUNDS DETAILS

SHEET NUMBER:
G — 6
WIK PAD & CANOPY REV 3 FINAL 10/16/23

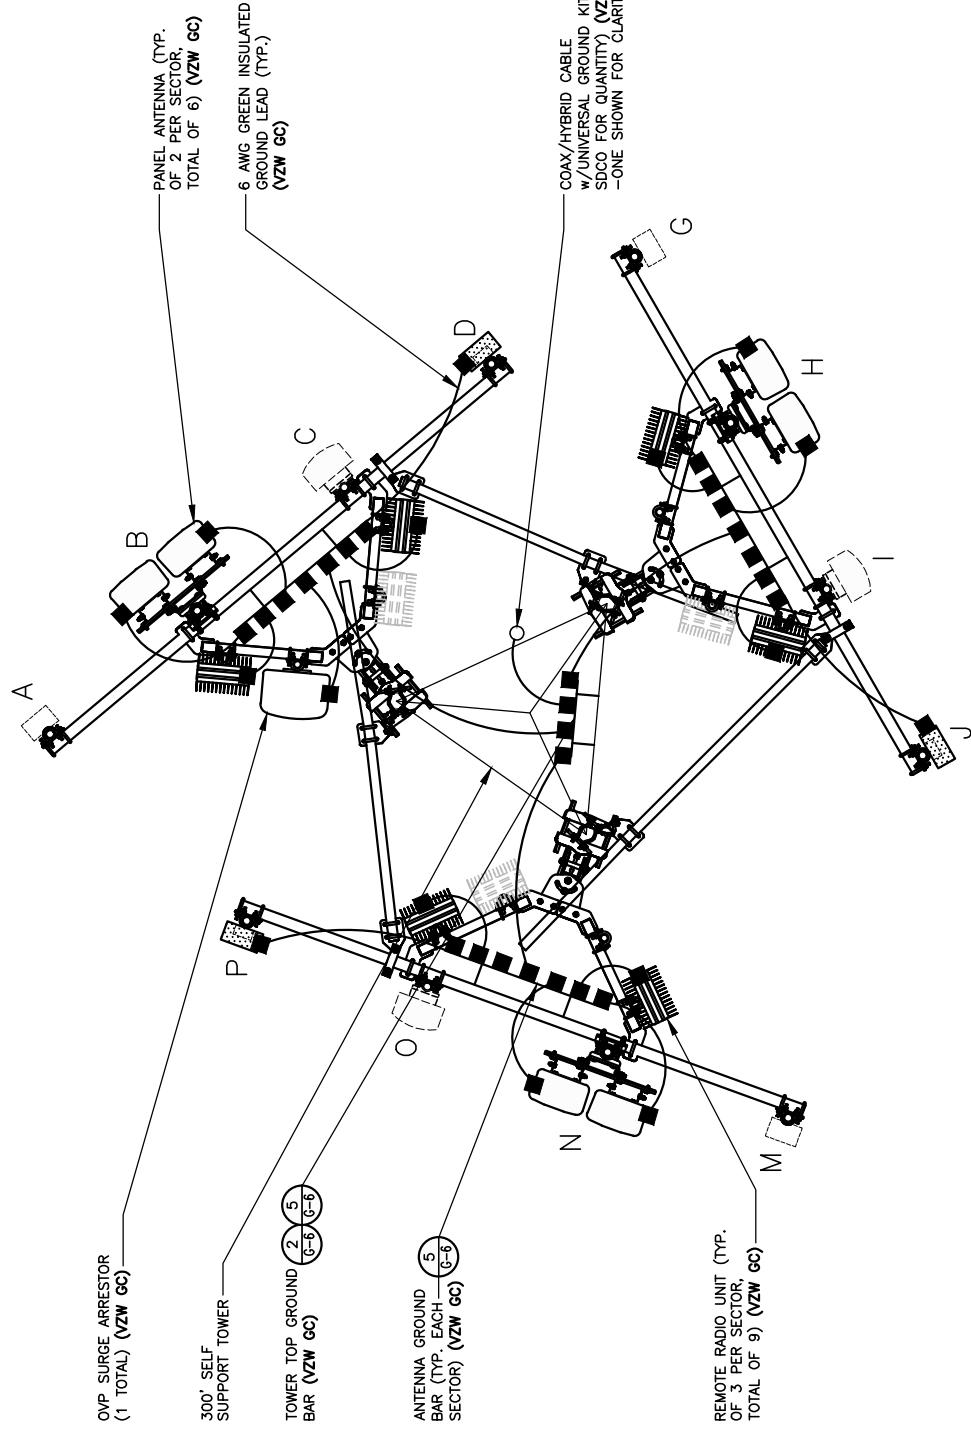


ANTENNA LEVEL GROUNDING PLAN (G-6)

SCALE: N.T.S.

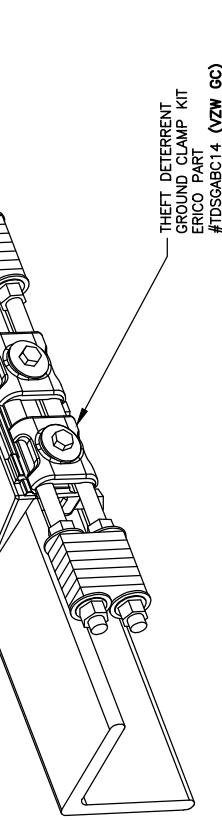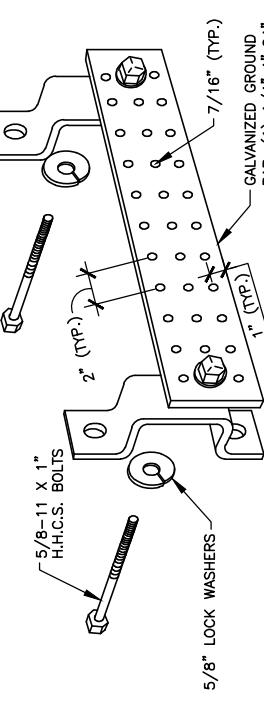


ANTENNA & TOWER TOP GROUND BAR (G-6)

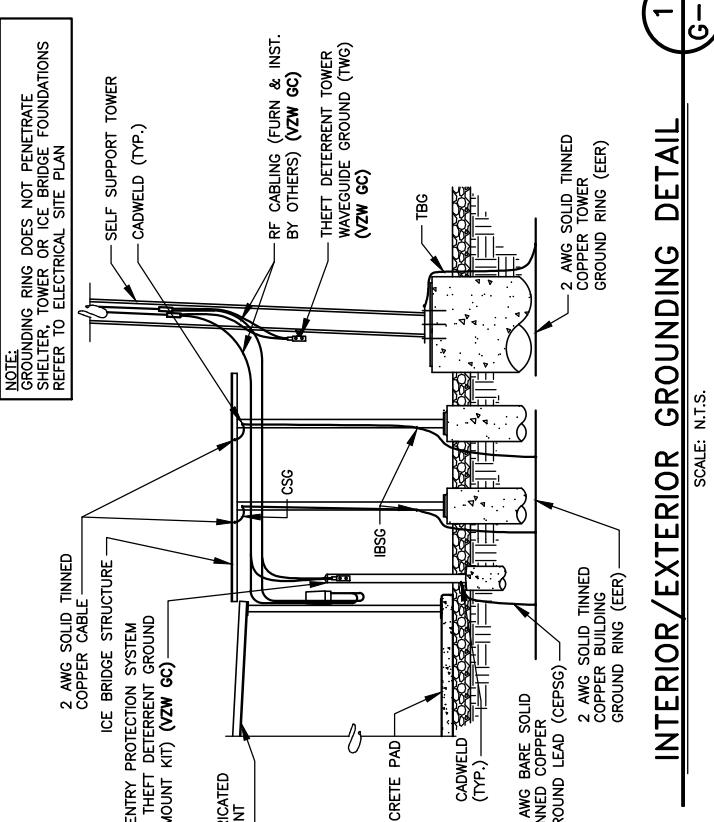SCALE: N.T.S.
(BY VZW GC)



INTERIOR/EXTERIOR GROUNDING DETAIL (G-6)

SCALE: N.T.S.

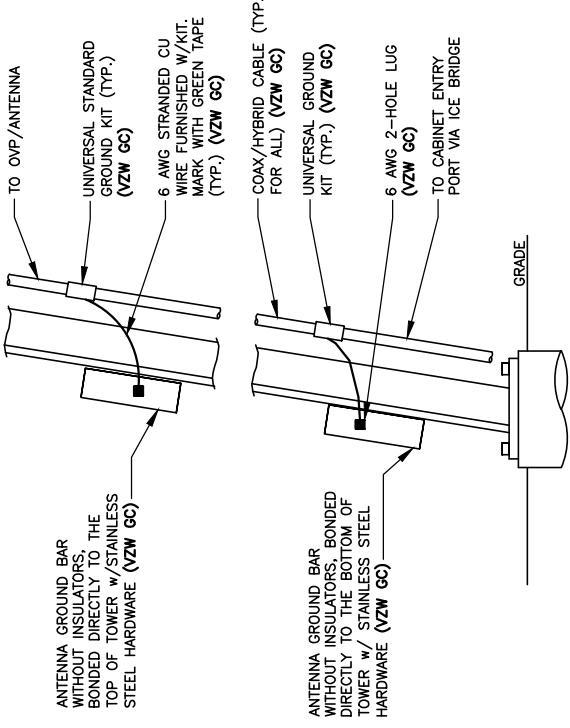

NOTE:
1. NUMBER OF GROUNDING BARS MAY VARY DEPENDING ON THE TYPE OF TOWER, ANTENNA LOCATIONS AND CONNECTION
2. INSTALL UNIVERSAL GROUND KITS AT ALL GROUND BAR LOCATIONS. (VZW GC)

ANTENNA CABLE GROUND INSTALLATION DETAIL (G-6)

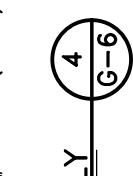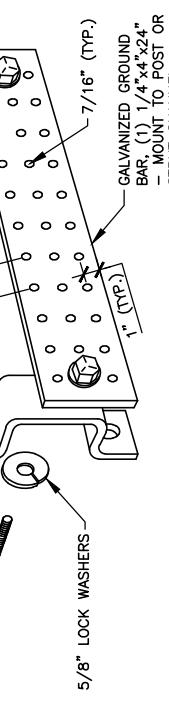SCALE: N.T.S.
(BY VZW GC)

TOWER BOTTOM GROUND ASSEMBLY (G-6)

SCALE: N.T.S.
(BY VZW GC)



TAG
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108 FOREST COURT, SUITE 1
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LAB

49030 Portia Trail, Suite 100
Wixom, Michigan 48393
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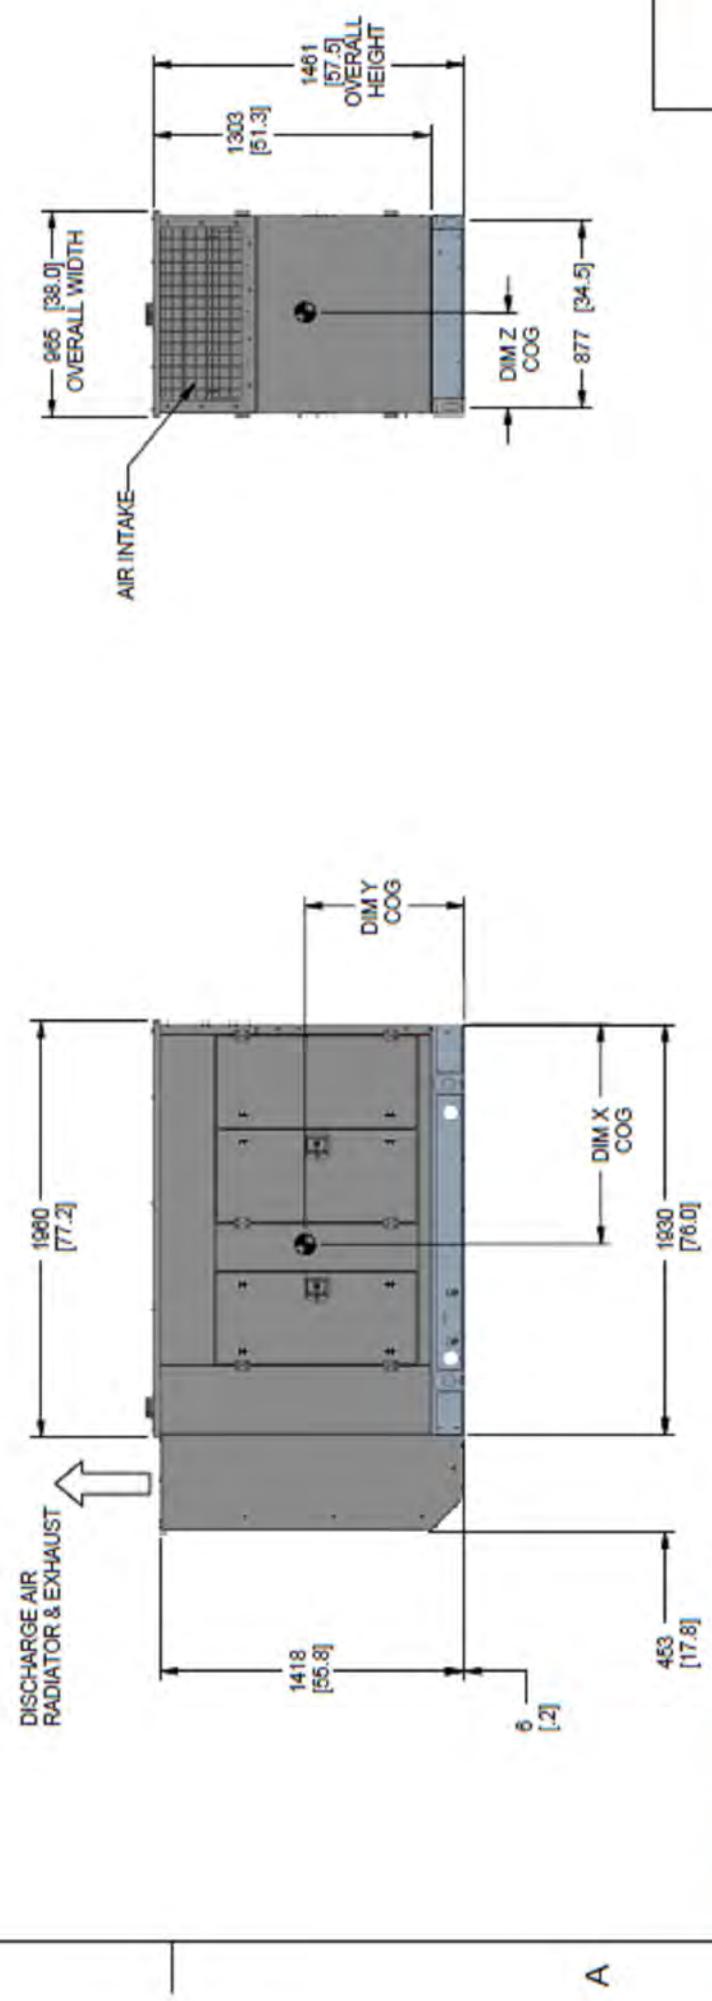
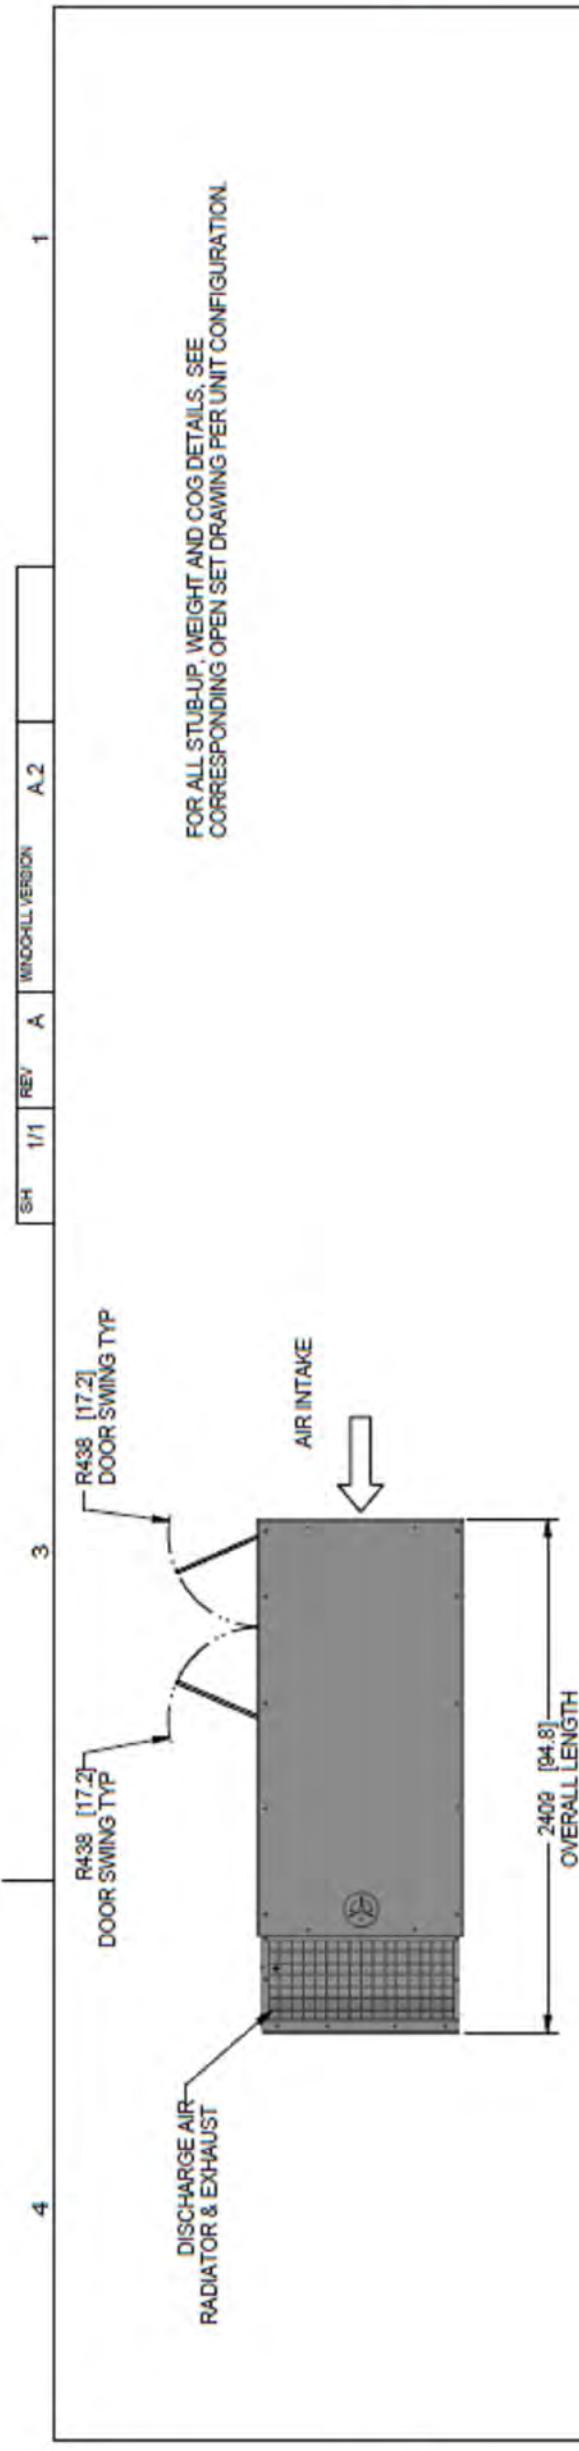
REV.	DATE	DESCRIPTION
1	12/27/23	REVISED FOR CONSTRUCTION
0	11/16/23	ISSUED FOR REVIEW
B	08/04/23	ISSUED FOR REVIEW
A	08/04/23	DESCRIPTON



SITE INFORMATION:
LV MT VERNON EAST
321 FROSTY HOLLOW ROAD
MT VERNON, KY 40456
ROCK CASTLE COUNTY

SITE NAME:
LV MT VERNON EAST
PID NUMBER: 16913443
DRAWN BY: RC
CHECKED BY: PL
DATE: 10/25/23
SHEET TITLE:
GENERATOR SPECIFICATIONS (REFERENCE ONLY)

SHEET NUMBER:
REF — 1
WK PAD & CANDY REV 3 FINAL 10/16/23



INSTALLATION DRAWING

DRAWING NUMBER: G4.5L 50&60HZ

ISSUE DATE: 10/16/23

SIZE CAGE NO DWG NO A0000335178 REV A

SCALE 0.035 WT-KG N/A SHEET 1 of 1

ELECTRONICALLY APPROVED: INZEC WINDCHILL

4

3

2

1

1

REF — 1



TAG
TOWERS
108 FOREST COURT, SUITE 1
RICHMOND, KY 40475
859-544-5000 (PH)

LAB

49030 Portiac Trail, Suite 100
Wixom, Michigan 48393
PHONE: (248) 705-9212

REV.	DATE	DESCRIPTION
A	08/04/23	ISSUED FOR REVIEW
B	08/16/23	ISSUED FOR REVIEW
C	11/16/23	REVISED FOR CONSTRUCTION
D	12/27/23	ISSUED FOR CONSTRUCTION



SITE INFORMATION:
LV MT VERNON

EAST

321 FROSTY HOLLOW ROAD
MT VERNON, KY 40456
ROCK CASTLE COUNTY

SITE NUMBER:
721772

SITE NAME:
LV MT VERNON EAST

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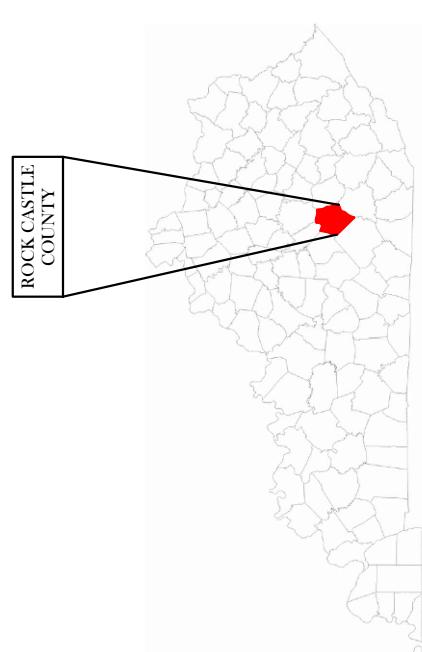
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RC
CHECKED BY:
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DATE:
10/25/23

SHEET TITLE:
PSC MAP

SHEET NUMBER:
WK PAD & CANOPY REV 3 FINAL 10/16/23


PSC — 1

CITY OF MT VERNON
ROCK CASTLE COUNTY, KENTUCKY
VERIZON WIRELESS SITE LV MT
VERNON EAST
TOWER LOCATION EXHIBIT



KENTUCKY


MAP NOT TO SCALE

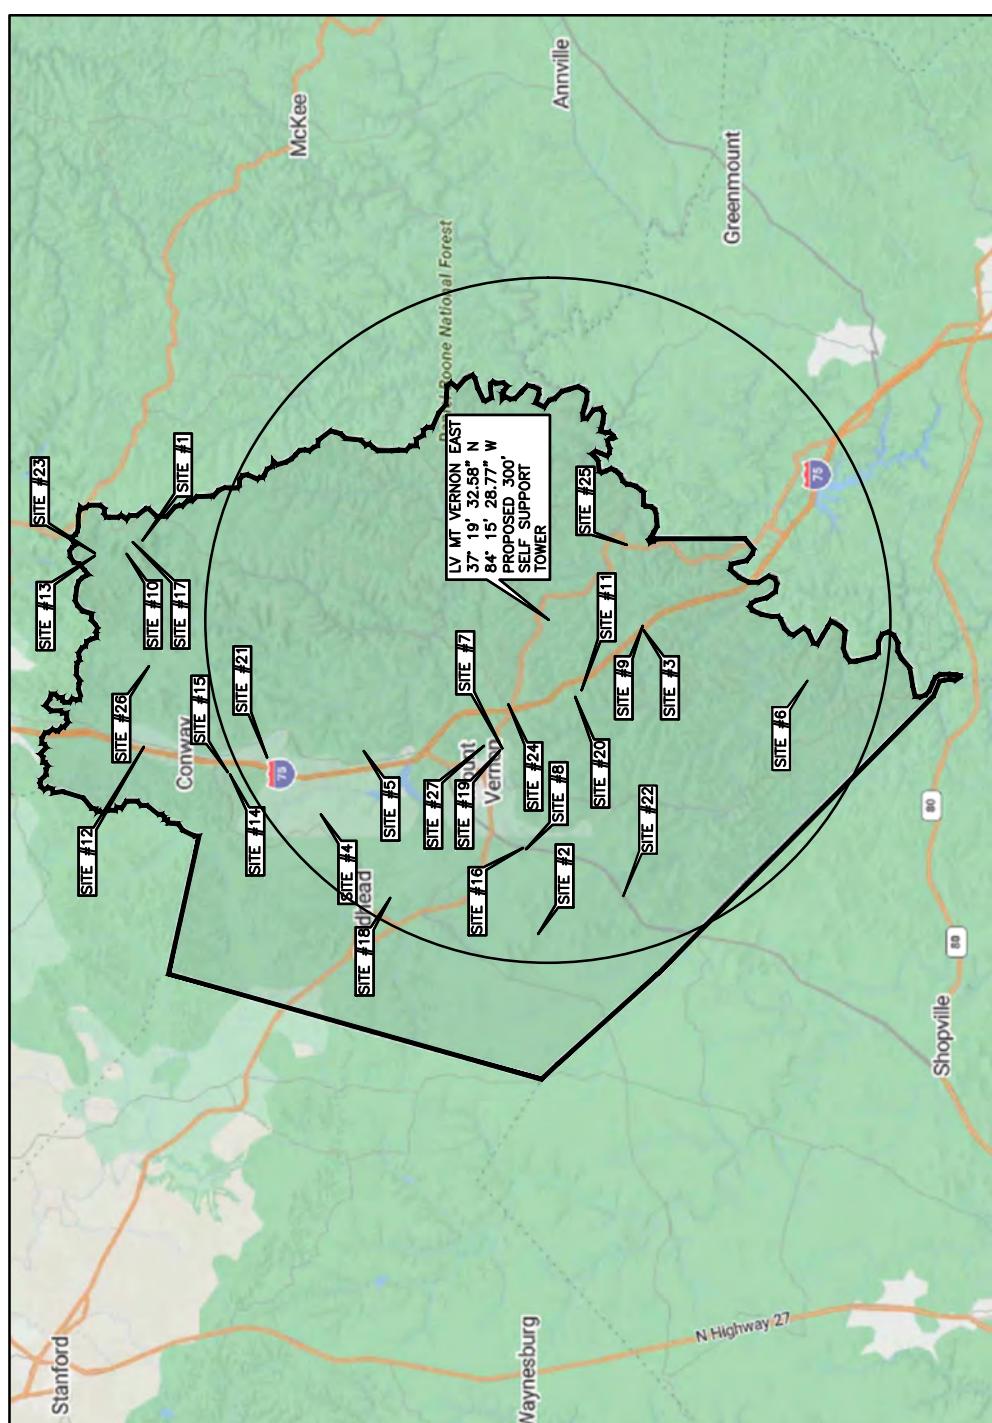

- SITE#1: FCC# 1008337, AMERICAN TOWERS (DELAWARE), INC, LLC 37° 30' 15.0"N, 084° 12' 58.0"W
 SITE#2: FCC# 1042054, BELLSOUTH TELECOMMUNICATIONS, INC, LLC 37° 20' 04.7"N, 084° 25' 45.2"W
 SITE#3: FCC# 1042208, GLOBAL TOWER, LLC, THROUGHAMERICAN TOWERS, LLC 37° 17' 21.0"N, 084° 15' 52.0"W
 SITE#4: FCC# 1042209, GLOBAL TOWER, LLC, THROUGHAMERICAN TOWERS, LLC 37° 25'40.0"N, 084° 21' 52.0"W
 SITE#5: FCC# 1043626, CELLULAR PHONE OF KENTUCKY, INC, LLC 37° 24' 34.0"N, 084° 19' 48.0"W
 SITE#6: FCC# 1043627, CELLULAR PHONE OF KENTUCKY, LLC, LLC 37° 13' 06.3"N, 084° 17' 30.8"W
 SITE#7: FCC# 1044617, KENTUCKY UTILITIES COMPANY, LLC 37° 21' 00.0"N, 084° 19' 43.0"W
 SITE#8: FCC# 1044811, KENTUCKY, COMMONWEALTH OF DBA, LLC 37° 20' 23.7"N, 084° 22' 59.2"W
 SITE#9: FCC# 1047745, HUFF, ETHEL DBA = WGE FM, LLC 37° 17' 22.0"N, 084° 15' 46.0"W
 SITE#10: FCC# 1056243, VOICE, VIDEO, & DATA SERVICES INC, LLC 37° 30' 38.0"N, 084° 13' 20.0"W
 SITE#11: FCC# 1204260, CROWN COMMUNICATIONS, LLC 37° 18' 57.1"N, 084° 17' 49.7"W
 SITE#12: FCC# 1204267, CROWN COMMUNICATIONS, LLC 37° 30' 14.0"N, 084° 19' 39.5"W
 SITE#13: FCC# 1307089, MADISON, COUNTY OF, LLC 37° 31' 37.3"N, 084° 13' 26.7"W
 SITE#14: FCC# 1228218, AMERICAN TOWER THROUGHUNISTE, INC, LLC 37° 28' 01.7"N, 084° 20' 33.4"W
 SITE#15: FCC# 1228349, AMERICAN TOWER THROUGHUNISTE, INC, LLC 37° 28' 01.7"N, 084° 20' 33.4"W
 SITE#16: FCC# 1230621, SBA INFRASTRUCTURES, LLC 37° 20' 26.7"N, 084° 22' 57.7"W
 SITE#17: FCC# 1233662, LONDON RADIO SERVICE, INC, LLC 37° 30' 32.3"N, 084° 13' 00.7"W
 SITE#18: FCC# 1242831, SBA 2012 TC ASSETS, LLC, LLC 37° 23' 53.4"N, 084° 24' 34.0"W
 SITE#19: FCC# 1242832, SBA 2012 TC ASSETS, LLC, 37° 21' 02.1"N, 084° 19' 46.3"W
 SITE#20: FCC# 1246941, CELLO PARTNERSHIP LLC, 37° 19' 06.0"N, 084° 18' 01.7"W
 SITE#21: FCC# 1246951, CELLO PARTNERSHIP LLC, 37° 27' 00.8"N, 084° 20' 01.8"W
 SITE#22: FCC# 1260232, SBA TOWERS III LLC, 37° 17' 52.7"N, 084° 24' 31.1"W
 SITE#23: FCC# 1269019, MADISON COUNTY EMERGENCY MANAGEMENT AGENCY, 37° 31' 37.4"N, 084° 13' 22.6"W
 SITE#24: FCC# 1274515, LONDON RADIO SERVICE, INC, 37° 20' 46.6"N, 084° 18' 16.6"W
 SITE#25: FCC# 1299205, ENGLE-VERNON, 37° 17' 46.8"N, 084° 13' 06.2"W
 SITE#26: FCC# 1309542, ECO-SITE LLC, 37° 30' 05.3"N, 084° 17' 00.8"W
 SITE#27: FCC# 1317789, UNITI TOWERS LLC, 37° 21' 11.7"N, 084° 19' 38.3"W

verizon

RURAL CELLULAR
CORP D/B/A

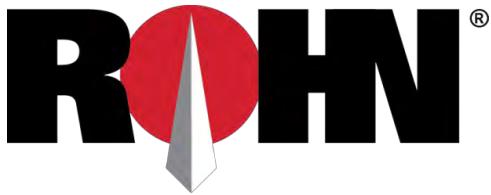

1 Fairholm Avenue
Peoria, IL 61603 USA
Phone: (309)-566-3000
Fax: (309)-566-3079

DATE: SEPTEMBER 18, 2023

PURCHASER: TAG TOWERS, LLC

PROJECT: 300FT RTL SELF SUPPORT TOWER
MT VERNON EAST, KY

FILE NUMBER: 244307


I CERTIFY THAT THE ATTACHED DRAWINGS WERE PREPARED UNDER MY SUPERVISION
IN ACCORDANCE WITH THE DESIGN AND LOADING CRITERIA SPECIFIED BY THE PURCHASER
AND THAT I AM A REGISTERED PROFESSIONAL ENGINEER UNDER THE LAWS OF THE STATE OF
KENTUCKY.



Products for a Growing World of Technology®

GENERAL NOTES

- ROHN PRODUCTS, LLC TOWER DESIGNS CONFORM TO ANSI/TIA-222-H UNLESS OTHERWISE SPECIFIED UNDER TOWER DESIGN LOADING.
- THE DESIGN LOADING CRITERIA INDICATED HAS BEEN PROVIDED TO ROHN. THE DESIGN LOADING CRITERIA HAS BEEN ASSUMED TO BE BASED ON SITE-SPECIFIC DATA IN ACCORDANCE WITH ANSI/TIA-222-H AND MUST BE VERIFIED BY OTHERS PRIOR TO INSTALLATION.
- ANTENNAS AND LINES LISTED IN TOWER DESIGN LOADING TABLE ARE PROVIDED BY OTHERS UNLESS OTHERWISE SPECIFIED.
- STEP BOLTS WITH SAFETY CLIMB SYSTEM ARE PROVIDED AS A CLIMBING FACILITY FOR THE INSTALLATION OF THE STRUCTURE.
- TOWER MEMBER DESIGN DOES NOT INCLUDE STRESSES DUE TO ERECTION SINCE ERECTION EQUIPMENT AND CONDITIONS ARE UNKNOWN. DESIGN ASSUMES COMPETENT AND QUALIFIED PERSONNEL WILL ERECT THE TOWER.
- WORK SHALL BE IN ACCORDANCE WITH ANSI/TIA-222-H, "STRUCTURAL STANDARDS FOR STEEL ANTENNA TOWERS AND ANTENNA SUPPORTING STRUCTURES".
- THE MINIMUM YIELD STRENGTH OF STRUCTURAL STEEL MEMBERS SHALL BE 50 KSI.
- FIELD CONNECTIONS SHALL BE BOLTED. NO FIELD WELDS SHALL BE ALLOWED.
- STRUCTURAL BOLTS SHALL CONFORM TO GRADE A325 PER ASTM F3125, EXCEPT WHERE NOTED.
- A NUT LOCKING DEVICE IS PROVIDED FOR ALL TOWER BOLTS.
- STRUCTURAL STEEL AND CONNECTION BOLTS SHALL BE HOT-DIPPED GALVANIZED AFTER FABRICATION, IN ACCORDANCE WITH ANSI/TIA-222-H.
- ALL HIGH STRENGTH BOLTS, UNLESS OTHERWISE NOTED FOR DOUBLE ANGLE MEMBERS, ARE TO BE TIGHTENED TO A "SNUG TIGHT" CONDITION AS DEFINED IN THE RCSC "SPECIFICATION FOR STRUCTURAL JOINTS USING HIGH-STRENGTH BOLTS". NO OTHER MINIMUM BOLT TENSION OR TORQUE VALUES ARE REQUIRED.
- PURCHASER SHALL VERIFY THE INSTALLATION IS IN CONFORMANCE WITH LOCAL, STATE, AND FEDERAL REQUIREMENTS FOR OBSTRUCTION MARKING AND LIGHTING.
- TOLERANCE ON TOWER STEEL HEIGHT IS EQUAL TO PLUS 1% OR MINUS 1/2%.
- DESIGN ASSUMES THAT, AS A MINIMUM, MAINTENANCE AND INSPECTION WILL BE PERFORMED OVER THE LIFE OF THE STRUCTURE IN ACCORDANCE WITH ANSI/TIA-222-H.
- DESIGN ASSUMES LEVEL GRADE AT TOWER SITE.
- DESIGN ASSUMES ALL ANTENNAS ARE MOUNTED SYMMETRICALLY TO MINIMIZE TORQUE, IF APPLICABLE.
- FOUNDATIONS SHALL BE DESIGNED TO SUPPORT THE REACTIONS SHOWN FOR THE CONDITIONS EXISTING AT THE SITE.

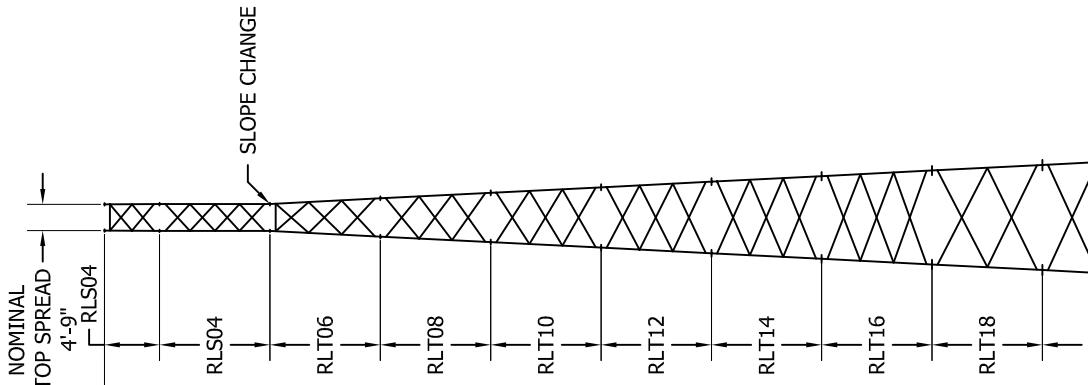


DESIGN WIND LOAD PER ANSI/TIA-222-H USING THE FOLLOWING DESIGN CRITERIA:
RISK CATEGORY: II
BASIC WIND SPEED (NO ICE): 105 MPH PER ASCE 7-16
BASIC WIND SPEED (W/ICE): 30 MPH PER ASCE 7-16
DESIGN ICE THICKNESS: 1.50 INCHES PER ASCE 7-16
GROUND ELEVATION, Z_s: 1,191 FT
EXPOSURE CATEGORY: B
TOPOGRAPHIC METHOD: 1, CATEGORY: 1
SEISMIC DESIGN PARAMETERS, S_s: 0.201, S_i: 0.087, T_i: 12, SITE CLASS: D

THIS STRUCTURE HAS BEEN DESIGNED TO SUPPORT THE FOLLOWING LOADS:

ELEVATION (FT)	ANTENNA LOADING	LINE SIZE (NOM)
TOP	BEACON & LIGHTNING ROD	(1) 0-3/4" CONDUIT
295	42,000 SQ-IN [92 SQFT] MAX EPA	(2) 1-5/8"
280	25,000 SQ-IN [74 SQFT] MAX EPA	(2) 1-5/8"
265	25,000 SQ-IN [74 SQFT] MAX EPA	(2) 1-5/8"
250	25,000 SQ-IN [74 SQFT] MAX EPA	(2) 1-5/8"

SECTION MAIN MEMBER SCHEDULE			
SECTION	LEGS	DIAGONALS	HORIZONTALS
RLS04	PIPE 2.85x0.203	L1 3/4x1 3/4x1/8 (2)	L1 3/4x1 3/4x3/16 (1)
RLS04	PIPE 3.50x0.216	L1 3/4x1 3/4x1/8 (4)	N/A
RLT06	PIPE 4.50x0.237	L1 3/4x1 3/4x1/8 (3)	L1 3/4x1 3/4x3/16 (1)
RLT08	PIPE 5.56x3x0.258	L2x2x1/8 (3)	N/A
RLT10	PIPE 5.56x3x0.375	L2x2x3/16 (3)	N/A
RLT12	PIPE 5.56x3x0.375	L2 1/2x2 1/2x3/16 (3)	N/A
RLT14	PIPE 5.56x3x0.375	L2 1/2x2 1/2x3/16 (3)	N/A
RLT16	PIPE 6.625x0.340	L2 1/2x2 1/2x3/16 (3)	N/A
RLT18	PIPE 6.625x0.432	L3x3x3/16 (2)	N/A
RLT20	PIPE 6.625x0.432	L3x3x3/16 (2)	N/A
RLT22	PIPE 8.625x0.375	L3 1/2x3 1/2x1/4 (2)	N/A
RLT25	PIPE 8.625x0.375	L4x4x1/4 (3)	N/A
RLT28	PIPE 8.625x0.375	L4x4x1/4 (2)	L3 1/2x3 1/2x1/4 (2)
RLT31	PIPE 8.625x0.375	L4x4x1/4 (2)	L4x4x1/4 (2)

MAXIMUM FACTORED REACTIONS			
COMPRESSION PER LEG	=	409.2 KIPS	
TENSION PER LEG	=	351.6 KIPS	
SHEAR PER LEG	=	35.2 KIPS	
TOTAL SHEAR	=	57.3 KIPS	
TOTAL O.T.M	=	10,747.8 FT-KIPS	

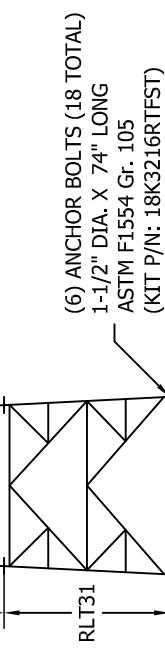


TOWER CONFIGURATION
N.T.S.
120°
(TP)

NOTE:
SECTION NUMBERS ARE FOR REFERENCE ONLY.
FOR NOMINAL FACE WIDTH DIMENSIONS, REFER TO THE STRESS ANALYSIS.
THE NUMBERS SHOWN IN PARENTHESES INDICATE THE NUMBER OF BAYS FROM TOP TO BOTTOM.

FILE NO. 244307
REV. 0
DESCRIPTION DWN CHK APP
DRAWS: AS PRJ. ENGR: AS DRAWING NO: 244307-01-D1
PRJ. MNGR: AS SHEET #: 1 OF 1
DATE: 09/18/2023
REV: 0

GENERAL NOTES


- 1 FOUNDATION DESIGN HAS BEEN DEVELOPED IN ACCORDANCE WITH GENERALLY ACCEPTED PROFESSIONAL ENGINEERING PRINCIPLES AND PRACTICES WITHIN THE LIMITS OF THE SUBSURFACE DATA PROVIDED. FOUNDATION DESIGN MODIFICATIONS MAY BE REQUIRED IN THE EVENT THE FOLLOWING DESIGN PARAMETERS ARE NOT APPLICABLE FOR THE SUBSURFACE CONDITIONS ENCOUNTERED.
- A) ULTIMATE SOIL BEARING PRESSURE AT 5.25 FT DEPTH = 11,500 PSF.
 B) GROUND WATER TABLE IS AT OR BELOW FOUNDATION DEPTH.
 C) MAXIMUM FROST PENETRATION DEPTH LESS THAN FOUNDATION DEPTH.
- 2 WORK SHALL BE IN ACCORDANCE WITH THE PROJECT CONSTRUCTION DOCUMENTS, LOCAL CODES, SAFETY REGULATIONS AND UNLESS OTHERWISE NOTED, THE LATEST REVISION OF ACI 318, "BUILDING CODE REQUIREMENTS FOR REINFORCED CONCRETE". PROCEDURES FOR THE PROTECTION OF EXCAVATIONS, EXISTING CONSTRUCTION AND UTILITIES SHALL BE ESTABLISHED PRIOR TO FOUNDATION INSTALLATION.
- 3 CONCRETE MATERIALS SHALL CONFORM TO THE APPROPRIATE STATE REQUIREMENTS FOR EXPOSED STRUCTURAL CONCRETE.
- 4 PROPORTIONS OF CONCRETE MATERIALS SHALL BE SUITABLE FOR THE INSTALLATION METHOD UTILIZED AND SHALL RESULT IN DURABLE CONCRETE FOR RESISTANCE TO LOCAL ANTICIPATED AGGRESSIVE ACTIONS. THE DURABILITY REQUIREMENTS OF ACI 318 SHALL BE SATISFIED BASED ON THE CONDITIONS EXPECTED AT THE SITE, AS A MINIMUM, CONCRETE SHALL DEVELOP A MINIMUM COMPRESSIVE STRENGTH OF 4,500 PSI IN 28 DAYS.
- 5 MAXIMUM SIZE OF AGGREGATE SHALL NOT EXCEED SIZE SUITABLE FOR INSTALLATION METHOD UTILIZED OR 3/4 CLEAR DISTANCE BEHIND OR BETWEEN REINFORCING. WORKABILITY AND METHODS OF CONSOLIDATION SUCH AS VIBRATING SHALL BE UTILIZED TO PREVENT HONEYCOMBS OR VOIDS.
- 6 REINFORCEMENT SHALL BE DEFORMED AND CONFORM TO THE REQUIREMENTS OF ASTM A615 GRADE 60 UNLESS OTHERWISE NOTED. SPLICES IN REINFORCEMENT SHALL NOT BE ALLOWED UNLESS OTHERWISE INDICATED.
- 7 WELDING IS PROHIBITED ON REINFORCING STEEL AND EMBEDMENTS.
- 8 MINIMUM CONCRETE COVER FOR REINFORCEMENT SHALL BE 3 INCHES UNLESS OTHERWISE NOTED. APPROVED SPACERS SHALL BE USED TO INSURE A 3 INCH MINIMUM COVER ON REINFORCEMENT.
- 9 CONCRETE COVER FROM TOP OF FOUNDATION TO ENDS OF VERTICAL REINFORCEMENT SHALL NOT EXCEED 3 INCHES NOR BE LESS THAN 2 INCHES.
- 10 FOUNDATION DESIGN ASSUMES STRUCTURAL BACKFILL TO BE COMPACTED IN 8 INCH MAXIMUM LAYERS TO 95% OF MAXIMUM DRY DENSITY AT OPTIMUM MOISTURE CONTENT IN ACCORDANCE WITH ASTM D1557. ADDITIONALLY, STRUCTURAL BACKFILL MUST HAVE A MINIMUM COMPACTED UNIT WEIGHT OF 110 POUNDS PER CUBIC FOOT.
- 11 FOUNDATION DESIGN HAS BEEN BASED ON GEOTECHNICAL REPORT NO. **23121213 DATED 09/13/2023** BY **ENGINEERED TOWER SOLUTIONS, PLLC**.
- 12 FOUNDATION DEPTH INDICATED IS BASED ON THE GRADE LINE DESCRIBED IN THE REFERENCED GEOTECHNICAL REPORT. FOUNDATION MODIFICATION MAY BE REQUIRED IN THE EVENT CUT OR FILL OPERATIONS HAVE TAKEN PLACE SUBSEQUENT TO THE GEOTECHNICAL INVESTIGATION.
- 13 FOUNDATION DESIGN ASSUMES THE RECOMMENDATIONS IN THE REFERENCED GEOTECHNICAL REPORT CONCERNING VERIFICATION OF SUBSURFACE CONDITIONS ARE IMPLEMENTED PRIOR TO PLACEMENT OF CONCRETE.
- 14 FOUNDATION INSTALLATION SHALL BE SUPERVISED BY PERSONNEL KNOWLEDGEABLE AND EXPERIENCED WITH THE PROPOSED FOUNDATION TYPE. CONSTRUCTION SHALL BE IN ACCORDANCE WITH GENERALLY ACCEPTED INSTALLATION PRACTICES.
- 15 ALL CONSTRUCTION AND SAFETY EQUIPMENT AND TEMPORARY SUPPORTS REQUIRED FOR CONSTRUCTION SHALL BE DETERMINED, FURNISHED AND INSTALLED BY THE CONTRACTOR BASED ON THE MEANS AND METHODS CHOSEN BY THE CONTRACTOR. ALL CONSTRUCTION ACTIVITIES SHALL BE PERFORMED BY COMPETENT, QUALIFIED AND TRAINED PERSONNEL.
- 16 FOUNDATION DESIGN ASSUMES INSTALLATION PROCEDURES WILL INCORPORATE THE PROCEDURES RECOMMENDED IN THE REFERENCED GEOTECHNICAL REPORT.
- 17 FOUNDATION DESIGN ASSUMES FIELD INSPECTIONS WILL BE PERFORMED TO VERIFY THAT CONSTRUCTION MATERIALS, INSTALLATION METHODS AND ASSUMED DESIGN PARAMETERS ARE ACCEPTABLE BASED ON CONDITIONS EXISTING AT THE SITE.
- 18 FOR FOUNDATION AND ANCHOR TOLERANCES SEE ANCHOR ROD LAYOUT DRAWING.
- 19 LOOSE MATERIAL SHALL BE REMOVED FROM BOTTOM OF EXCAVATION PRIOR TO CONCRETE PLACEMENT.
- 20 CONCRETE SHALL BE PLACED IN A MANNER THAT WILL PREVENT SEGREGATION OF CONCRETE MATERIALS, INFILTRATION OF WATER OR SOIL AND OTHER OCCURRENCES WHICH MAY DECREASE THE STRENGTH OR DURABILITY OF THE FOUNDATION.
- 21 CONCRETE PREFERABLY SHALL BE PLACED AGAINST UNDISTURBED SOIL. WHEN FORMS ARE NECESSARY, THEY SHALL BE REMOVED PRIOR TO PLACING STRUCTURAL BACKFILL.
- 22 CONSTRUCTION JOINTS, IF REQUIRED AT THE BASE OF THE PIERS, SHALL BE INTENTIONALLY ROUGHENED TO A FULL AMPLITUDE OF 1/4 INCH. FOUNDATION DESIGN ASSUMES NO OTHER CONSTRUCTION JOINTS.
- 23 TOP OF FOUNDATION SHALL BE SLOPED TO DRAIN WITH A FLOATED FINISH.
- 24 EXPOSED EDGES OF CONCRETE SHALL BE CHAMFERED 3/4" X 3/4" MINIMUM.

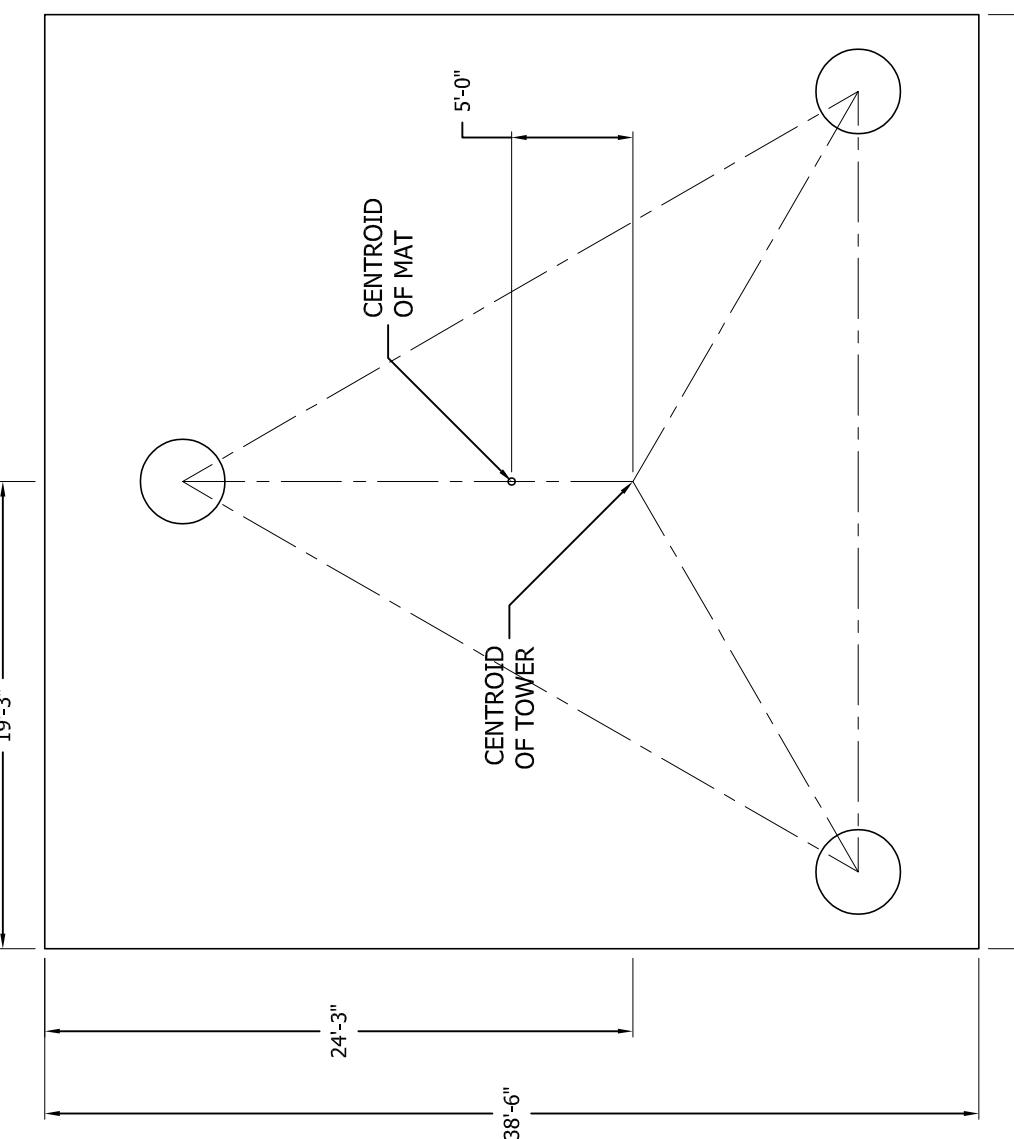

PLAN VIEW

(2) NO. 4 CIRCULAR STIRRUPS ENCLOSING VERTICAL BARS @ 2-1/2" C-C W/ 180 DEG. STAGGERED 6" MIN LAPS TERMINATED AT EACH END WITH A STD. ACI 318 HOOK ENGAGING A VERTICAL BAR WITH 2" COVER (TYP).

NO. 4 CIRCULAR STIRRUPS ENCLOSING VERTICAL BARS WITH 24" LAPS STAGGERED 180 DEG, ON 6" CENTERS (TYP)

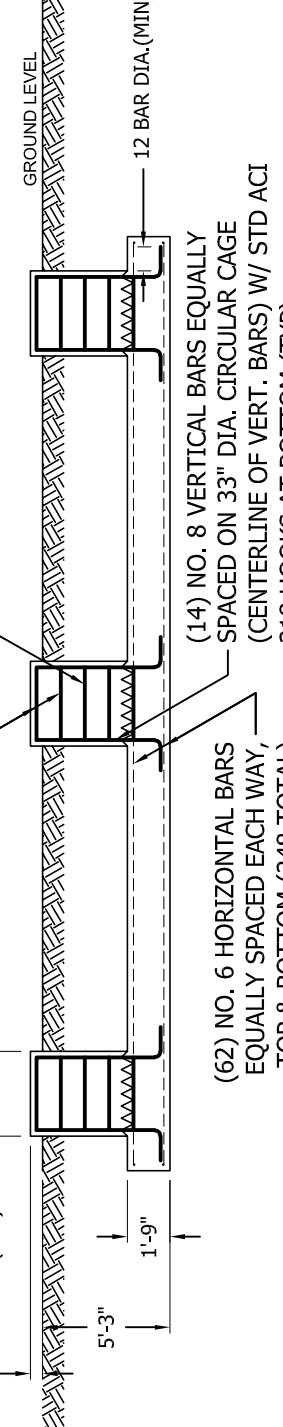

ELEVATION VIEW

FACTORED REACTIONS

Maximum O.T.M =	10,747.8 FT-K
Total Tower Wt =	58.4 KIPS
Total Shear =	57.3 KIPS
Max. Shear/Leg =	351.6 KIPS
Max. Comp./Leg =	409.2 KIPS

CONCRETE VOLUME

ROUND PIERS	4.3 CU.YDS
PAD	96.1 CU.YDS
TOTAL	100.3 CU.YDS



- 21 CONSTRUCTION JOINTS, IF REQUIRED AT THE BASE OF THE PIERS, SHALL BE INTENTIONALLY ROUGHENED TO A FULL AMPLITUDE OF 1/4 INCH. FOUNDATION DESIGN ASSUMES NO OTHER CONSTRUCTION JOINTS.

- 22 TOP OF FOUNDATION SHALL BE SLOPED TO DRAIN WITH A FLOATED FINISH.

- 23 EXPOSED EDGES OF CONCRETE SHALL BE CHAMFERED 3/4" X 3/4" MINIMUM.

GENERAL NOTES:

- FOUNDATION DESIGN HAS BEEN DEVELOPED IN ACCORDANCE WITH GENERALLY ACCEPTED PROFESSIONAL ENGINEERING PRINCIPLES AND PRACTICES WITHIN THE LIMITS OF THE SUBSURFACE DATA PROVIDED. FOUNDATION DESIGN MODIFICATIONS MAY BE REQUIRED IN THE EVENT THE FOLLOWING DESIGN PARAMETERS ARE NOT APPLICABLE FOR THE SUBSURFACE CONDITIONS ENCOUNTERED.
 - DEPTH NEGLECTED FOR SKIN FRICTION = TOP 3.0 FT
 - AVERAGE ULTIMATE SKIN SHEAR FOR UPLIFT: 3.0 FT TO 6.0 FT DEPTH = 2300 PSF, AND 6.0 FT TO 9.0 FT DEPTH = 2000 PSF, AND 9.0 FT TO 19.0 FT DEPTH = 1300 PSF.
 - AVERAGE ULTIMATE SKIN SHEAR FOR DOWNLOAD: 3.0 FT TO 6.0 FT DEPTH = 2300 PSF, AND 6.0 FT TO 9.0 FT DEPTH = 2000 PSF, AND 9.0 FT TO 19.0 FT DEPTH = 1300 PSF.
 - ULTIMATE NET END BEARING AT 19.0 FT = 40.0 KSF.
 - GROUNDWATER TABLE BELOW FOUNDATION DEPTH.
- WORK SHALL BE IN ACCORDANCE WITH LOCAL CODES, SAFETY REGULATIONS AND UNLESS OTHERWISE NOTED, THE LATEST REVISION OF ACI 318, "BUILDING CODE REQUIREMENTS FOR REINFORCED CONCRETE". PROCEDURES FOR THE PROTECTION OF EXCAVATIONS, EXISTING CONSTRUCTION AND UTILITIES SHALL BE ESTABLISHED PRIOR TO FOUNDATION INSTALLATION.
- CONCRETE MATERIALS SHALL CONFORM TO THE APPROPRIATE STATE REQUIREMENTS FOR EXPOSED STRUCTURAL CONCRETE.
- PROPORTIONS OF CONCRETE MATERIALS SHALL BE SUITABLE FOR THE INSTALLATION METHOD UTILIZED AND SHALL RESULT IN DURABLE CONCRETE FOR RESISTANCE TO LOCAL ANTICIPATED AGGRESSIVE ACTIONS. THE DURABILITY REQUIREMENTS OF ACI 318 CHAPTER 4 SHALL BE SATISFIED BASED ON THE CONDITIONS EXPECTED AT THE SITE. AS A MINIMUM, CONCRETE SHALL DEVELOP A MINIMUM COMPRESSIVE STRENGTH OF 4,500 PSI (31.0 MPa) IN 28 DAYS.
- MAXIMUM SIZE OF AGGREGATE SHALL NOT EXCEED SIZE SUITABLE FOR INSTALLATION METHOD UTILIZED OR 1/3 CLEAR DISTANCE BEHIND OR BETWEEN REINFORCING. MAXIMUM SIZE MAY BE INCREASED TO 2/3 CLEAR DISTANCE PROVIDED WORKABILITY AND METHODS OF CONSOLIDATION SUCH AS VIBRATING WILL PREVENT HONEYCOMBS OR VOIDS.
- REINFORCEMENT SHALL BE DEFORMED AND CONFORM TO THE REQUIREMENTS OF ASTM A615 GRADE 60 UNLESS OTHERWISE NOTED. SPLICES IN REINFORCEMENT SHALL NOT BE ALLOWED UNLESS OTHERWISE INDICATED.
- REINFORCING CAGES SHALL BE BRACED TO RETAIN PROPER DIMENSIONS DURING HANDLING AND THROUGHOUT PLACEMENT OF CONCRETE. WHEN TEMPORARY CASING IS UTILIZED, BRACING SHALL BE ADEQUATE TO RESIST FORCES OCCURRING FROM FLOWING CONCRETE DURING CASING EXTRACTION.
- WELDING IS PROHIBITED ON REINFORCING STEEL AND EMBEDMENTS.
- MINIMUM CONCRETE COVER FOR REINFORCEMENT SHALL BE 3 INCHES (76 MM) UNLESS OTHERWISE NOTED. APPROVED SPACERS SHALL BE USED TO INSURE A 3 INCH (76 MM) MINIMUM COVER ON REINFORCEMENT.
- SPACERS SHALL BE ATTACHED INTERMITTENTLY THROUGHOUT THE ENTIRE LENGTH OF VERTICAL REINFORCING CAGES TO INSURE CONCENTRIC PLACEMENT OF CAGES IN EXCAVATIONS
- FOUNDATION DESIGN HAS BEEN BASED ON GEOTECHNICAL REPORT NO. **23121213** DATED **09/13/2023** BY **ENGINEERED TOWER SOLUTIONS, PLLC.**
- FOUNDATION DEPTH INDICATED IS BASED ON THE GRADE LINE DESCRIBED IN THE REFERENCED GEOTECHNICAL REPORT.
- FOUNDATION MODIFICATION MAY BE REQUIRED IN THE EVENT CUT OR FILL OPERATIONS HAVE TAKEN PLACE SUBSEQUENT TO THE GEOTECHNICAL INVESTIGATION.
- FOUNDATION DESIGN ASSUMES THE RECOMMENDATIONS IN THE REFERENCED GEOTECHNICAL REPORT CONCERNING VERIFICATION OF SUBSURFACE CONDITIONS ARE IMPLEMENTED PRIOR TO PLACEMENT OF CONCRETE.
- FOUNDATION INSTALLATION SHALL BE SUPERVISED BY PERSONNEL KNOWLEDGEABLE AND EXPERIENCED WITH THE PROPOSED FOUNDATION TYPE. CONSTRUCTION SHALL BE IN ACCORDANCE WITH GENERALLY ACCEPTED INSTALLATION PRACTICES.
- FOUNDATION DESIGN ASSUMES INSTALLATION PROCEDURES WILL INCORPORATE THE PROCEDURES RECOMMENDED IN THE REFERENCED GEOTECHNICAL REPORT.
- FOUNDATION DESIGN ASSUMES FIELD INSPECTIONS WILL BE PERFORMED TO VERIFY THAT CONSTRUCTION MATERIALS, INSTALLATION METHODS AND ASSUMED DESIGN PARAMETERS ARE ACCEPTABLE BASED ON CONDITIONS EXISTING AT THE SITE.
- FOR FOUNDATION INSTALLATION TOLERANCES SEE STRUCTURE ASSEMBLY DRAWING.
- LOOSE MATERIAL SHALL BE REMOVED FROM BOTTOM OF EXCAVATION PRIOR TO CONCRETE PLACEMENT. SIDES OF EXCAVATION SHALL BE ROUGH AND FREE OF LOOSE CUTTINGS.
- CONCRETE SHALL BE PLACED IN A MANNER THAT WILL PREVENT SEGREGATION OF CONCRETE MATERIALS, INFILTRATION OF WATER OR SOIL AND OTHER OCCURRENCES WHICH MAY DECREASE THE STRENGTH OR DURABILITY OF THE FOUNDATION.
- FREE FALL CONCRETE MAY BE USED PROVIDED FALL IS VERTICAL DOWN WITHOUT HITTING SIDES OF EXCAVATION, FORMWORK, REINFORCING BARS, FORM TIES, CAGE BRACING OR OTHER OBSTRUCTIONS. UNDER NO CIRCUMSTANCES SHALL CONCRETE FALL THROUGH WATER.
- TOP OF FOUNDATION OUTSIDE LIMITS OF ANCHOR BOLTS SHALL BE SLOPED TO DRAIN WITH A FLOATED FINISH. AREA INSIDE LIMITS OF ANCHOR BOLTS SHALL BE LEVEL WITH A SCRATCHED FINISH.
- EXPOSED EDGES OF CONCRETE SHALL BE CHAMFERED 3/4" X 3/4" (19MM X 19MM) MINIMUM.
- FOUNDATION DESIGN ASSUMES CASING, IF USED, WILL NOT BE LEFT IN PLACE. EQUIPMENT, PROCEDURES, AND PROPORTIONS OF CONCRETE MATERIALS SHALL INSURE CONCRETE WILL NOT BE ADVERSELY DISTURBED UPON CASTING REMOVAL.

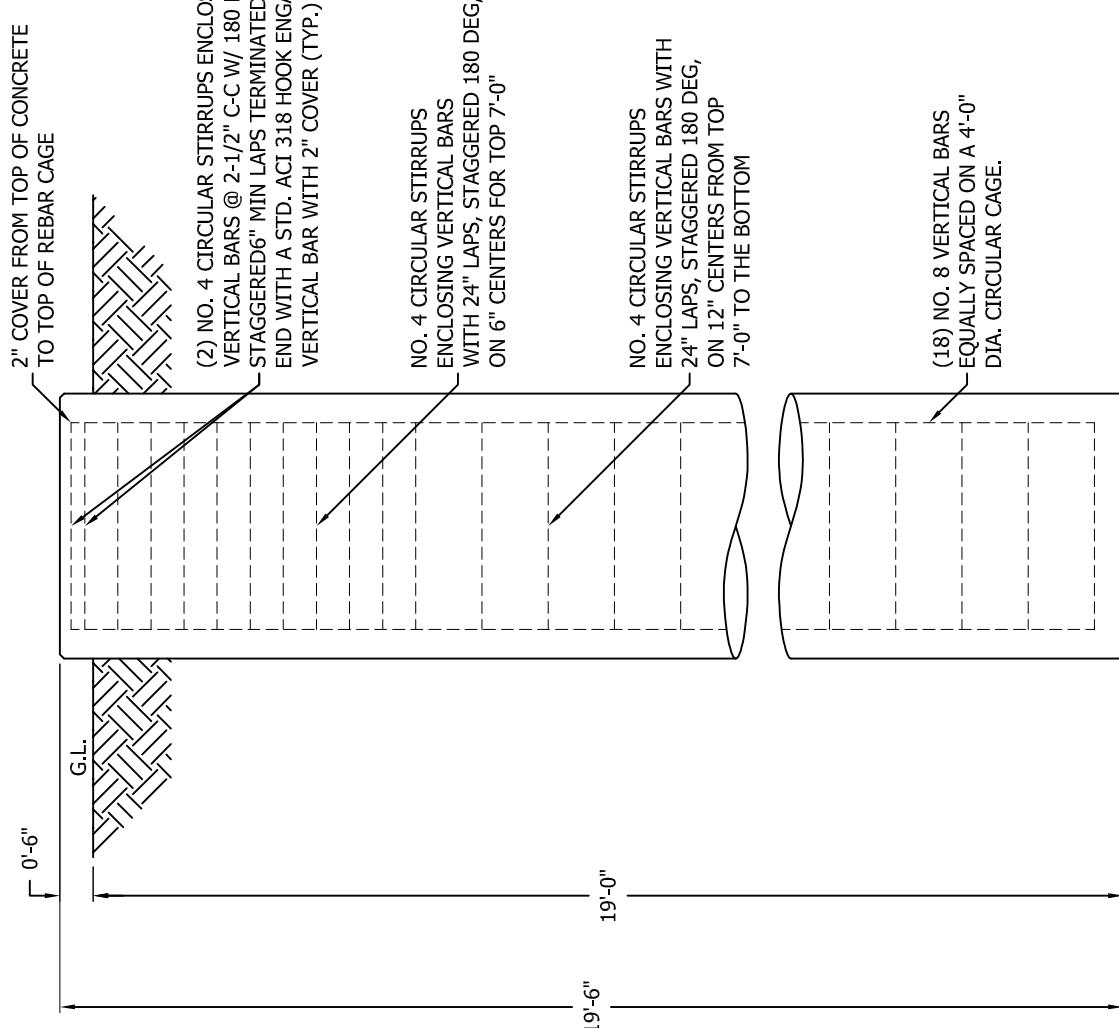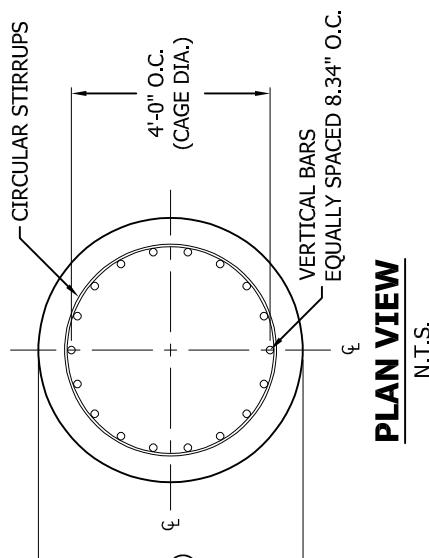**FACTORED REACTIONS/LEG**

DOWNLOAD =	409.2 KIPS	SHEET #:	1 OF 1
UPLIFT =	351.6 KIPS	PRJ. MNGR:	
SHEAR =	35.2 KIPS	DRAWING NO.:	244307-01-F2

VOLUME OF CONCRETE

(1) FOUNDATION	14.2 CU. YDS	DATE:	09/18/2023
(3) FOUNDATIONS	42.6 CU. YDS	ENGR:	AS

ROHN
PRODUCTS LLC

PO BOX 5999
PEORIA, IL 61601-5999
TOLL FREE 800-727-ROHN

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TAG TOWERS, LLC
DRILLED PIER
FOUNDATION DETAILS
MT VERNON EAST, KY

DWN: AS CHKD: SY DATE: 09/18/2023
ENGR: AS SHEET #: 1 OF 1
PRJ. ENGR: AS PRJ. MNGR:
DRAWING NO.:

REV: 0



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Contract: 244307
Project: 300 FT RTL TOWER
Date and Time: 9/18/2023 1:25:31 PM

Revision: 0
Site: MT VERNON EAST- KY
Engineer: AS

Section A: PROJECT DATA

Project Title: 300 FT RTL TOWER
Customer Name: TAG TOWERS- LLC
Site: MT VERNON EAST- KY
Contract No.: 244307
Revision: 0
Engineer: AS
Date: Sep 18 2023
Time: 01:23:08 PM

Design Standard: ANSI/TIA-222-H-2017

ENGINEERING
CHECKED BY: SY
09/18/2023

GENERAL DESIGN CONDITIONS

Start wind direction: 0.00 (Deg)
End wind direction: 330.00 (Deg)
Increment wind direction: 30.00 (Deg)
Elevation above ground: 0.00 (ft)
Mean elevation of base of structure above sea level Zs: 1191.00 (ft)
Rooftop wind speed-up factor Ks: 1.00
Gust Response Factor Gh: 0.85
Risk category: II
Exposure category: B
Topographic category: 1
Material Density: 490.1(lbs/ft^3)
Young's Modulus: 29000.0(ksi)
Poisson Ratio: 0.30
Weight Multiplier: 1.00
Minimum Bracing Resistance as per 4.4.1

WIND ONLY CONDITIONS:
Basic Wind Speed (No Ice): 105.00 (mph)
Directionality Factor Kd: 0.85
Importance Factor I: 1.00
Wind Load Factor: 1.00
Dead Load Factor: 1.20
Dead Load Factor for Uplift: 0.90

WIND AND ICE CONDITIONS:
Basic Wind Speed (With Ice): 30.00 (mph)
Directionality Factor Kd: 0.85
Wind Load Importance Factor Iw: 1.00
Ice Thickness Importance Factor II: 1.00
Ice Thickness: 1.50 (in)
Ice Density: 56.19 (lbs/ft^3)
Wind Load Factor: 1.00
Dead Load Factor: 1.20
Ice Load Factor: 1.00

WIND ONLY SERVICEABILITY CONDITIONS:
Serviceability Wind Speed: 60.00 (mph)
Directionality Factor Kd: 0.85
Importance Factor I: 1.00
Wind Load Factor: 1.00
Dead Load Factor: 1.00

PATTERN LOADING (IF APPLICABLE) CONDITIONS:
Basic Wind Speed (No Ice): 105.00 (mph)
Directionality Factor Kd: 0.85
Importance Factor I: 1.00
Wind Load Factor: 1.00



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Dead Load Factor: 1.20
Dead Load Factor for Uplift: 0.90

EARTHQUAKE CONDITIONS:

Site class definition: D
Spectral response acceleration Ss: 0.201
Spectral response acceleration S1: 0.087
Long-period transition period TL: 12.000
Accelaration-based site coefficient Fa: 1.600
Velocity-based site coefficient Fv: 2.400
Design spectral response acceleration Sds: 0.214
Design spectral response acceleration Sd1: 0.139
Seismic analysis method: 1
Fundamental frequency of structure f1: 0.608
Total seismic shear Vs (Kips) : 1.75

Analysis performed using: TowerSoft Finite Element Analysis Program

File: W:\Jobs\2023\244307\ENGINEERING\244307.out

Contract: 244307

Project: 300 FT RTL TOWER

Date and Time: 9/18/2023 1:25:31 PM

Revision: 0

Site: MT VERNON EAST- KY

Engineer: AS

Section B: STRUCTURE GEOMETRY

TOWER GEOMETRY

Cross-Section	Height (ft)	Tot Height (ft)	# of Section	Bot Width (in)	Top Width (in)
Triangular	300.00	310.00	14	385.97	56.99

SECTION GEOMETRY

Sec #	Sec. Name	Elevation		Widths		Masses					Brcg. Clear. (in)	
		Bottom (ft)	Top (ft)	Bottom (in)	Top (in)	Legs (lbs)	Brcg. (lbs)	Sec.Brc (lbs)	Int.Brc (lbs)	Sect. (lbs)	Database (lbs)	
14	RLS04	290.00	300.00	58	57	175	149	0	0	324	0	0.787
13	RLS04	270.00	290.00	58	58	459	239	0	0	698	0	0.787
12	RLT06	250.00	270.00	83	58	651	261	0	0	912	0	0.787
11	RLT08	230.00	250.00	107	83	882	305	0	0	1187	0	0.787
10	RLT10	210.00	230.00	131	107	1252	522	0	0	1774	0	0.787
9	RLT12	190.00	210.00	156	131	1252	756	0	0	2009	0	0.787
8	RLT14	170.00	190.00	180	156	1252	856	0	0	2109	0	0.787
7	RLT16*	150.00	170.00	204	180	1374	957	0	0	2331	0	0.787
6	RLT18*	130.00	150.00	228	204	1722	917	0	0	2639	0	0.787
5	RLT20*	110.00	130.00	254	228	1722	999	0	0	2721	0	0.787
4	RLT22*	90.00	110.00	278	254	1987	1679	0	0	3666	0	0.787
3	RLT25*	60.00	90.00	314	278	2981	3165	0	0	6145	0	0.787
2	RLT28*	30.00	60.00	350	314	2980	2567	1129	464	7140	0	0.787
1	RLT31*	0.00	30.00	386	350	2980	2908	1223	593	7703	0	0.787
Total Mass:				386	350	2980	21669	16279	2352	1057	41357	0

PANEL GEOMETRY

Sec#	Pnl#	Type	SecBrcg	Mid. Continuous	Horiz	Horiz	Height	Bottom Width	Top Width	Plan Bracing	Hip Bracing	Gusset Plate	Gusset Plate Area	Gusset Weight
14	2	X	(None)		Yes	5.0	57.3	57.0	(None)	(None)	(None)	0.300	0.30	
14	1	X	(None)		None	5.0	57.5	57.3	(None)	(None)	(None)	0.300	0.30	
13	4	X	(None)		None	5.0	57.7	57.5	(None)	(None)	(None)	0.300	0.30	
13	3	X	(None)		None	5.0	58.0	57.7	(None)	(None)	(None)	0.300	0.30	
13	2	X	(None)		None	5.0	58.2	58.0	(None)	(None)	(None)	0.300	0.30	
13	1	X	(None)		None	5.0	58.4	58.2	(None)	(None)	(None)	0.300	0.30	
12	3	X	(None)		Yes	6.7	66.7	58.4	(None)	(None)	(None)	0.300	0.30	
12	2	X	(None)		None	6.7	75.0	66.7	(None)	(None)	(None)	0.300	0.30	
12	1	X	(None)		None	6.7	83.3	75.0	(None)	(None)	(None)	0.300	0.30	
11	3	X	(None)		None	6.7	91.3	83.3	(None)	(None)	(None)	0.300	0.30	
11	2	X	(None)		None	6.7	99.3	91.3	(None)	(None)	(None)	0.300	0.30	
11	1	X	(None)		None	6.7	107.3	99.3	(None)	(None)	(None)	0.300	0.30	
10	3	X	(None)		None	6.7	115.3	107.3	(None)	(None)	(None)	0.300	0.30	
10	2	X	(None)		None	6.7	123.3	115.3	(None)	(None)	(None)	0.300	0.30	
10	1	X	(None)		None	6.7	131.3	123.3	(None)	(None)	(None)	0.300	0.30	
9	3	X	(None)		None	6.7	139.6	131.3	(None)	(None)	(None)	0.300	0.30	
9	2	X	(None)		None	6.7	147.9	139.6	(None)	(None)	(None)	0.300	0.30	
9	1	X	(None)		None	6.7	156.2	147.9	(None)	(None)	(None)	0.300	0.30	
8	3	X	(None)		None	6.7	164.2	156.2	(None)	(None)	(None)	0.300	0.30	
8	2	X	(None)		None	6.7	172.2	164.2	(None)	(None)	(None)	0.300	0.30	
8	1	X	(None)		None	6.7	180.2	172.2	(None)	(None)	(None)	0.300	0.30	
7	3	X	(None)		None	6.7	188.2	180.2	(None)	(None)	(None)	0.300	0.30	
7	2	X	(None)		None	6.7	196.2	188.2	(None)	(None)	(None)	0.300	0.30	
7	1	X	(None)		None	6.7	204.2	196.2	(None)	(None)	(None)	0.300	0.30	
6	2	X	(None)		None	10.0	216.2	204.2	(None)	(None)	(None)	0.300	0.30	
6	1	X	(None)		None	10.0	228.2	216.2	(None)	(None)	(None)	0.300	0.30	
5	2	X	(None)		None	10.0	241.1	228.2	(None)	(None)	(None)	0.300	0.30	
5	1	X	(None)		None	10.0	254.0	241.1	(None)	(None)	(None)	0.300	0.30	
4	2	X	(None)		None	10.0	266.0	254.0	(None)	(None)	(None)	0.300	0.30	

File: W:\Jobs\2023\244307\ENGINEERING\244307.out

Contract: 244307

Project: 300 FT RTL TOWER

Date and Time: 9/18/2023 1:25:31 PM

Revision: 0

Site: MT VERNON EAST- KY

Engineer: AS

4	1	X	(None)	None	10.0	278.0	266.0	(None)	(None)	0.300	0.30
3	3	X	(None)	None	10.0	290.0	278.0	(None)	(None)	0.300	0.30
3	2	X	(None)	None	10.0	302.0	290.0	(None)	(None)	0.300	0.30
3	1	X	(None)	None	10.0	314.0	302.0	(None)	(None)	0.300	0.30
2	2	K	2-Subdiv.	Yes	15.0	332.0	314.0	2-Subdiv.	(None)	0.300	0.30
2	1	K	2-Subdiv.	Yes	15.0	350.0	332.0	2-Subdiv.	(None)	0.300	0.30
1	2	K	2-Subdiv.	Yes	15.0	368.0	350.0	2-Subdiv.	(None)	0.300	0.30
1	1	K	2-Subdiv.	Yes	15.0	386.0	368.0	2-Subdiv.	(None)	0.300	0.30

MEMBER PROPERTIES

Sec/ Member	Type	Description	Steel Grade	Conn. Type	Bolt #-Size	Bolt Grade	End Dist.	Edge Dist.	Gusset Thick.	Gusset Grade	Bolt Space	Dble Mem.
<hr/>												
Pnl Spacing												
<hr/>												
Stitch												
<hr/>												
Bolt												
<hr/>												
(ft)												
14/2	Leg	PIPE 2.875x0.203	A500 gr.CSTension	4-0.750	A325X							
14/2	Diag	L1 3/4x1 3/4x1/8	A529 gr.50Bolted	1-0.625	A325X	1.500	0.875	0.250	A572 gr.50			2.000
14/2	Horiz	L1 3/4x1 3/4x3/16	A529 gr.50Bolted	1-0.625	A325X	1.500	0.875	0.250	A572 gr.50			2.000
14/1	Leg	PIPE 2.875x0.203	A500 gr.CSTension	4-0.750	A325X							
14/1	Diag	L1 3/4x1 3/4x1/8	A529 gr.50Bolted	1-0.625	A325X	1.500	0.875	0.250	A572 gr.50			2.000
13/4	Leg	PIPE 3.500x0.216	A500 gr.CSTension	5-0.875	A325X							
13/4	Diag	L1 3/4x1 3/4x1/8	A529 gr.50Bolted	1-0.625	A325X	1.500	0.875	0.250	A572 gr.50			2.000
13/3	Leg	PIPE 3.500x0.216	A500 gr.CSTension	5-0.875	A325X							
13/3	Diag	L1 3/4x1 3/4x1/8	A529 gr.50Bolted	1-0.625	A325X	1.500	0.875	0.250	A572 gr.50			2.000
13/2	Leg	PIPE 3.500x0.216	A500 gr.CSTension	5-0.875	A325X							
13/2	Diag	L1 3/4x1 3/4x1/8	A529 gr.50Bolted	1-0.625	A325X	1.500	0.875	0.250	A572 gr.50			2.000
13/1	Leg	PIPE 3.500x0.216	A500 gr.CSTension	5-0.875	A325X							
13/1	Diag	L1 3/4x1 3/4x1/8	A529 gr.50Bolted	1-0.625	A325X	1.500	0.875	0.250	A572 gr.50			2.000
12/3	Leg	PIPE 4.500x0.237	A500 gr.CSTension	5-1.000	A325X							
12/3	Diag	L1 3/4x1 3/4x1/8	A529 gr.50Bolted	1-0.625	A325X	1.500	0.875	0.250	A572 gr.50			2.000
12/3	Horiz	L1 3/4x1 3/4x3/16	A529 gr.50Bolted	1-0.625	A325X	1.500	0.875	0.250	A572 gr.50			2.000
12/2	Leg	PIPE 4.500x0.237	A500 gr.CSTension	5-1.000	A325X							
12/2	Diag	L1 3/4x1 3/4x1/8	A529 gr.50Bolted	1-0.625	A325X	1.500	0.875	0.250	A572 gr.50			2.000
12/1	Leg	PIPE 4.500x0.237	A500 gr.CSTension	5-1.000	A325X							
12/1	Diag	L1 3/4x1 3/4x1/8	A529 gr.50Bolted	1-0.625	A325X	1.500	0.875	0.250	A572 gr.50			2.000
11/3	Leg	PIPE 5.563x0.258	A500 gr.CSTension	5-1.000	A325X							
11/3	Diag	L2x2x1/8	A529 gr.50Bolted	1-0.625	A325X	1.500	1.000	0.250	A572 gr.50			2.000
11/2	Leg	PIPE 5.563x0.258	A500 gr.CSTension	5-1.000	A325X							
11/2	Diag	L2x2x1/8	A529 gr.50Bolted	1-0.625	A325X	1.500	1.000	0.250	A572 gr.50			2.000
11/1	Leg	PIPE 5.563x0.258	A500 gr.CSTension	5-1.000	A325X							
11/1	Diag	L2x2x1/8	A529 gr.50Bolted	1-0.625	A325X	1.500	1.000	0.250	A572 gr.50			2.000

File: W:\Jobs\2023\244307\ENGINEERING\244307.out

Contract: 244307

Project: 300 FT RTL TOWER

Date and Time: 9/18/2023 1:25:31 PM

Revision: 0

Site: MT VERNON EAST- KY

Engineer: AS

10/3	Leg	PIPE 5.563x0.375	A500 gr.CSTension	5-1.000	A325X							
10/3	Diag	L2x2x3/16	A529 gr.50Bolted	1-0.625	A325X	1.500	1.000	0.250	A572 gr.50			2.000
10/2	Leg	PIPE 5.563x0.375	A500 gr.CSTension	5-1.000	A325X							
10/2	Diag	L2x2x3/16	A529 gr.50Bolted	1-0.625	A325X	1.500	1.000	0.250	A572 gr.50			2.000
10/1	Leg	PIPE 5.563x0.375	A500 gr.CSTension	5-1.000	A325X							
10/1	Diag	L2x2x3/16	A529 gr.50Bolted	1-0.625	A325X	1.500	1.000	0.250	A572 gr.50			2.000
9/3	Leg	PIPE 5.563x0.375	A500 gr.CSTension	5-1.000	A325X							
9/3	Diag	L2 1/2x2 1/2x3/16	A529 gr.50Bolted	1-0.625	A325X	1.500	1.250	0.250	A572 gr.50			2.000
9/2	Leg	PIPE 5.563x0.375	A500 gr.CSTension	5-1.000	A325X							
9/2	Diag	L2 1/2x2 1/2x3/16	A529 gr.50Bolted	1-0.625	A325X	1.500	1.250	0.250	A572 gr.50			2.000
9/1	Leg	PIPE 5.563x0.375	A500 gr.CSTension	5-1.000	A325X							
9/1	Diag	L2 1/2x2 1/2x3/16	A529 gr.50Bolted	1-0.625	A325X	1.500	1.250	0.250	A572 gr.50			2.000
8/3	Leg	PIPE 5.563x0.375	A500 gr.CSTension	6-1.000	A325X							
8/3	Diag	L2 1/2x2 1/2x3/16	A529 gr.50Bolted	1-0.625	A325X	1.500	0.875	0.250	A572 gr.50			2.000
8/2	Leg	PIPE 5.563x0.375	A500 gr.CSTension	6-1.000	A325X							
8/2	Diag	L2 1/2x2 1/2x3/16	A529 gr.50Bolted	1-0.625	A325X	1.500	0.875	0.250	A572 gr.50			2.000
8/1	Leg	PIPE 5.563x0.375	A500 gr.CSTension	6-1.000	A325X							
8/1	Diag	L2 1/2x2 1/2x3/16	A529 gr.50Bolted	1-0.625	A325X	1.500	0.875	0.250	A572 gr.50			2.000
7/3	Leg	PIPE 6.625x0.340	A500 gr.CSTension	6-1.000	A325X							
7/3	Diag	L2 1/2x2 1/2x3/16	A529 gr.50Bolted	2-0.625	A325X	1.125	1.250	0.375	A572 gr.50			2.000
7/2	Leg	PIPE 6.625x0.340	A500 gr.CSTension	6-1.000	A325X							
7/2	Diag	L2 1/2x2 1/2x3/16	A529 gr.50Bolted	2-0.625	A325X	1.125	1.250	0.375	A572 gr.50			2.000
7/1	Leg	PIPE 6.625x0.340	A500 gr.CSTension	6-1.000	A325X							
7/1	Diag	L2 1/2x2 1/2x3/16	A529 gr.50Bolted	2-0.625	A325X	1.125	1.250	0.375	A572 gr.50			2.000
6/2	Leg	PIPE 6.625x0.432	A500 gr.CSTension	6-1.000	A325X							
6/2	Diag	L3x3x3/16	A529 gr.50Bolted	2-0.625	A325X	1.500	1.500	0.375	A572 gr.50			2.000
6/1	Leg	PIPE 6.625x0.432	A500 gr.CSTension	6-1.000	A325X							
6/1	Diag	L3x3x3/16	A529 gr.50Bolted	2-0.625	A325X	1.500	1.500	0.375	A572 gr.50			2.000
5/2	Leg	PIPE 6.625x0.432	A500 gr.CSTension	6-1.500	A325X							
5/2	Diag	L3x3x3/16	A529 gr.50Bolted	2-0.625	A325X	1.125	1.500	0.375	A572 gr.50			2.000
5/1	Leg	PIPE 6.625x0.432	A500 gr.CSTension	6-1.500	A325X							
5/1	Diag	L3x3x3/16	A529 gr.50Bolted	2-0.625	A325X	1.125	1.500	0.375	A572 gr.50			2.000
4/2	Leg	PIPE 8.625x0.375	A500 gr.CSTension	6-1.500	A325X							
4/2	Diag	L3 1/2x3 1/2x1/4	A529 gr.50Bolted	2-0.625	A325X	1.125	1.750	0.375	A572 gr.50			2.000
4/1	Leg	PIPE 8.625x0.375	A500 gr.CSTension	6-1.500	A325X							
4/1	Diag	L3 1/2x3 1/2x1/4	A529 gr.50Bolted	2-0.625	A325X	1.125	1.750	0.375	A572 gr.50			2.000
3/3	Leg	PIPE 8.625x0.375	A500 gr.CSTension	6-1.500	A325X							
3/3	Diag	L4x4x1/4	A529 gr.50Bolted	2-0.625	A325X	1.125	2.000	0.375	A572 gr.50			2.000

File: W:\Jobs\2023\244307\ENGINEERING\244307.out

Contract: 244307

Project: 300 FT RTL TOWER

Date and Time: 9/18/2023 1:25:31 PM

Revision: 0

Site: MT VERNON EAST- KY

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3/2	Leg	PIPE 8.625x0.375	A500 gr.CSTension	6-1.500	A325X							
3/2	Diag	L4x4x1/4	A529 gr.50Bolted	2-0.625	A325X	1.125	2.000	0.375	A572 gr.50			2.000
3/1	Leg	PIPE 8.625x0.375	A500 gr.CSTension	6-1.500	A325X							
3/1	Diag	L4x4x1/4	A529 gr.50Bolted	2-0.625	A325X	1.125	2.000	0.375	A572 gr.50			2.000
2/2	Leg	PIPE 8.625x0.375	A500 gr.CSTension	6-1.500	A325X							
2/2	Diag	L4x4x1/4	A529 gr.50Bolted	2-0.625	A325X	1.125	2.000	0.375	A572 gr.50			2.000
2/2	Horiz	L3 1/2x3 1/2x1/4	A529 gr.50Bolted	2-0.625	A325X	1.125	1.750	0.375	A572 gr.50			2.000
2/2	SecD1	L3x3x1/4	A529 gr.50Bolted	1-0.625	A325X	1.500	1.500	0.250	A572 gr.50			2.000
2/2	SecH1	L3x3x1/4	A529 gr.50Bolted	1-0.625	A325X	1.500	1.500	0.250	A572 gr.50			2.000
2/2	PlanH1	L3 1/2x3 1/2x1/4	A529 gr.50Bolted	1-0.625	A325X	1.500	1.750	0.250	A572 gr.50			2.000
2/1	Leg	PIPE 8.625x0.375	A500 gr.CSTension	6-1.500	A325X							
2/1	Diag	L4x4x1/4	A529 gr.50Bolted	2-0.625	A325X	1.125	2.000	0.375	A572 gr.50			2.000
2/1	Horiz	L3 1/2x3 1/2x1/4	A529 gr.50Bolted	2-0.625	A325X	1.125	1.750	0.375	A572 gr.50			2.000
2/1	SecD1	L3x3x1/4	A529 gr.50Bolted	1-0.625	A325X	1.500	1.500	0.250	A572 gr.50			2.000
2/1	SecH1	L3x3x1/4	A529 gr.50Bolted	1-0.625	A325X	1.500	1.500	0.250	A572 gr.50			2.000
2/1	PlanH1	L3 1/2x3 1/2x1/4	A529 gr.50Bolted	1-0.625	A325X	1.500	1.750	0.250	A572 gr.50			2.000
1/2	Leg	PIPE 8.625x0.375	A500 gr.CSTension	6-1.500	A325X							
1/2	Diag	L4x4x1/4	A529 gr.50Bolted	2-0.625	A325X	1.125	2.000	0.375	A572 gr.50			2.000
1/2	Horiz	L4x4x1/4	A529 gr.50Bolted	2-0.625	A325X	1.125	2.000	0.375	A572 gr.50			2.000
1/2	SecD1	L3x3x1/4	A529 gr.50Bolted	1-0.625	A325X	1.500	1.500	0.250	A572 gr.50			2.000
1/2	SecH1	L3x3x1/4	A529 gr.50Bolted	1-0.625	A325X	1.500	1.500	0.250	A572 gr.50			2.000
1/2	PlanH1	L4x4x1/4	A529 gr.50Bolted	1-0.625	A325X	1.500	2.000	0.250	A572 gr.50			2.000
1/1	Leg	PIPE 8.625x0.375	A500 gr.CSTension	6-1.500	A325X							
1/1	Diag	L4x4x1/4	A529 gr.50Bolted	2-0.625	A325X	1.125	2.000	0.375	A572 gr.50			2.000
1/1	Horiz	L4x4x1/4	A529 gr.50Bolted	2-0.625	A325X	1.125	2.000	0.375	A572 gr.50			2.000
1/1	SecD1	L3x3x1/4	A529 gr.50Bolted	1-0.625	A325X	1.500	1.500	0.250	A572 gr.50			2.000
1/1	SecH1	L3x3x1/4	A529 gr.50Bolted	1-0.625	A325X	1.500	1.500	0.250	A572 gr.50			2.000
1/1	PlanH1	L4x4x1/4	A529 gr.50Bolted	1-0.625	A325X	1.500	2.000	0.250	A572 gr.50			2.000



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Contract: 244307

Project: 300 FT RTL TOWER

Date and Time: 9/18/2023 1:25:31 PM

Revision: 0

Site: MT VERNON EAST- KY

Engineer: AS

Section D: TRANSMISSION LINE DATA

Transmission Lines Position

No.	Bot El (ft)	Top El (ft)	Desc.	Radius (ft)	Az. (ft)	Orient.	No.	No. of Rows	Vert.	Antenna	User Ka
1	0.00	300.00	3/8 CABLE	19.00	0.00	0.00	1	1	Yes		
2	0.00	300.00	RC0.75-Cnd	16.19	60.00	5.00	1	1	No		
3	0.00	295.00	TX Ladder	10.72	60.00	30.00	1	1	No		
4	280.00	295.00	LDF7P-50A	1.61	60.00	30.00	2	1	No		
5	265.00	280.00	LDF7P-50A	1.80	60.00	30.00	4	1	No		
6	250.00	265.00	LDF7P-50A	2.31	60.00	30.00	6	1	No		
7	0.00	250.00	LDF7P-50A	10.72	60.00	30.00	8	1	No		

Transmission Lines Details

No.	Desc.	Width (in)	Depth (in)	Unit Mass (lb/ft)	Line Spacing (in)	Row Spacing (in)
1	3/8 CABLE	0.38	0.38	1.00	2.750	2.750
2	RC0.75-Cnd	1.05	1.05	1.09	2.750	2.750
3	TX Ladder	4.70	1.50	4.00	2.750	2.750
4	LDF7P-50A	2.01	2.01	0.92	2.250	2.750
5	LDF7P-50A	2.01	2.01	0.92	2.250	2.750
6	LDF7P-50A	2.01	2.01	0.92	2.250	2.750
7	LDF7P-50A	2.01	2.01	0.92	2.250	2.750



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Contract: 244307

Project: 300 FT RTL TOWER

Date and Time: 9/18/2023 1:25:31 PM

Revision: 0

Site: MT VERNON EAST- KY

Engineer: AS

Section F: POINT LOAD DATA

Structure Azimuth from North: 0.00

POINT LOADS

No.	Description	Elev.	Radius	Azim.	Orient.	Vertical Offset	Tx Line	Comments
		(ft)	(ft)	(Deg)	(Deg)	(ft)		
1	BEACON & LR	300.00	1.00	0.0	0.0	0.00		
2	42,000 SQ-IN MAX EPA	295.00	0.00	0.0	0.0	0.00		
3	25,000 SQ-IN MAX EPA	280.00	0.00	0.0	0.0	0.00		
4	25,000 SQ-IN MAX EPA	265.00	0.00	0.0	0.0	0.00		
5	25,000 SQ-IN MAX EPA	250.00	0.00	0.0	0.0	0.00		

POINT LOADS WIND AREAS AND WEIGHTS

No.	Description	Frontal Bare Area	Lateral Bare Area	Frontal Iced Area	Lateral Iced Area	Weight Bare	Weight Iced	Gh
		(ft^2)	(ft^2)	(ft^2)	(ft^2)	(Kips)	(Kips)	
1	BEACON & LR	5.00	5.00	10.00	10.00	0.25	0.50	0.85
2	42,000 SQ-IN MAX EPA	292.00	292.00	584.00	584.00	4.00	8.00	0.85
3	25,000 SQ-IN MAX EPA	174.00	174.00	348.00	348.00	3.00	6.00	0.85
4	25,000 SQ-IN MAX EPA	174.00	174.00	348.00	348.00	3.00	6.00	0.85
5	25,000 SQ-IN MAX EPA	174.00	174.00	348.00	348.00	3.00	6.00	0.85

File: W:\Jobs\2023\244307\ENGINEERING\244307.out

Contract: 244307

Project: 300 FT RTL TOWER

Date and Time: 9/18/2023 1:25:31 PM

Revision: 0

Site: MT VERNON EAST- KY

Engineer: AS

Section H: STRUCTURE DISPLACEMENT DATA

Load Combination Wind Only - Serviceability

Wind Direction Maximum displacements

Node	Elev. (ft)	N-S Disp (in)	W-E Disp (in)	Vert. Disp (in)	N-S Rot (Deg)	W-E Rot (Deg)	Twist (Deg)
126	300.0	18.0	18.3	-0.2	0.69	0.70	-0.01
123	295.0	17.3	17.5	-0.2	0.71	0.71	0.02
120	290.0	16.5	16.8	-0.2	0.70	0.71	0.01
117	285.0	15.8	16.0	-0.2	0.68	0.69	0.01
114	280.0	15.1	15.3	-0.2	0.69	0.69	0.02
111	275.0	14.3	14.6	-0.2	0.65	0.66	0.01
108	270.0	13.7	13.9	-0.1	0.62	0.63	0.01
105	263.3	12.8	13.0	-0.1	0.60	0.60	0.01
102	256.7	12.0	12.2	-0.1	0.55	0.55	0.02
99	250.0	11.2	11.4	-0.1	0.54	0.55	-0.01
96	243.3	10.5	10.7	-0.1	0.49	0.50	-0.02
93	236.7	9.8	10.0	-0.1	0.48	0.49	0.01
90	230.0	9.1	9.3	-0.1	0.43	0.44	0.01
87	223.3	8.5	8.7	-0.1	0.43	0.44	0.01
84	216.7	7.9	8.0	-0.1	0.40	0.40	0.01
81	210.0	7.3	7.5	-0.1	0.39	0.40	0.01
78	203.3	6.8	6.9	-0.1	0.35	0.36	0.01
75	196.7	6.3	6.4	-0.1	0.35	0.36	0.01
72	190.0	5.8	5.9	-0.1	0.32	0.32	0.01
69	183.3	5.4	5.5	-0.1	0.32	0.32	0.01
66	176.7	4.9	5.0	-0.1	0.28	0.29	0.01
63	170.0	4.5	4.6	-0.1	0.28	0.29	-0.01
60	163.3	4.1	4.2	-0.1	0.25	0.26	0.01
57	156.7	3.8	3.9	-0.1	0.25	0.26	0.00
54	150.0	3.4	3.5	-0.1	0.22	0.22	0.01
51	140.0	3.0	3.0	-0.1	0.21	0.21	0.00
48	130.0	2.5	2.6	-0.1	0.18	0.19	0.00
45	120.0	2.1	2.2	-0.1	0.17	0.18	0.00
42	110.0	1.8	1.8	-0.1	0.15	0.15	0.00
39	100.0	1.5	1.5	-0.1	0.14	0.14	0.00
36	90.0	1.2	1.2	-0.1	0.12	0.12	0.00
33	80.0	0.9	0.9	-0.1	0.11	0.11	0.00
30	70.0	0.7	0.7	0.0	0.09	0.09	0.00
26	60.0	0.5	0.5	0.0	0.07	0.07	0.00
20	45.0	0.3	0.3	0.0	0.05	0.05	0.00
14	30.0	0.1	-0.1	0.0	0.03	0.03	0.00
8	15.0	0.0	0.0	0.0	0.01	-0.01	0.00
3	0.0	0.0	0.0	0.0	0.00	0.00	0.00

File: W:\Jobs\2023\244307\ENGINEERING\244307.out

Contract: 244307

Project: 300 FT RTL TOWER

Date and Time: 9/18/2023 1:25:31 PM

Revision: 0

Site: MT VERNON EAST- KY

Engineer: AS

Section L: STRENGTH ASSESSMENT SORTED DATA

Load Combination Max Envelope
Wind Direction Maximum

Sec	Pnl	Elev.	MType	Desc.	Len	kl/r	Gov. comp.	Gov. tens.	Max Compr.	Max Tens.	Asses. Ratio
					(ft)	(ft)	(Kips)	(Kips)	(Kips)	(Kips)	
14	2	295.00	Leg	PIPE 2.875x0.203	5.00	63.4	57.1	76.5	0.9	0.5	0.02
14	1	290.00	Leg	PIPE 2.875x0.203	5.00	63.4	57.1	76.5	6.4	3.2	0.11
13	4	285.00	Leg	PIPE 3.500x0.216	5.00	51.7	82.5	100.4	18.2	14.6	0.22
13	3	280.00	Leg	PIPE 3.500x0.216	5.00	51.7	82.5	100.4	27.1	23.5	0.33
13	2	275.00	Leg	PIPE 3.500x0.216	5.00	51.7	82.5	100.4	42.6	36.5	0.52
13	1	270.00	Leg	PIPE 3.500x0.216	5.00	51.7	82.5	100.4	59.5	53.2	0.72
12	3	263.33	Leg	PIPE 4.500x0.237	6.68	53.1	116.1	142.6	73.3	66.3	0.63
12	2	256.67	Leg	PIPE 4.500x0.237	6.68	53.1	116.1	142.6	91.9	82.4	0.79
12	1	250.00	Leg	PIPE 4.500x0.237	6.68	53.1	116.1	142.6	105.1	95.4	0.91
11	3	243.33	Leg	PIPE 5.563x0.258	6.68	42.6	169.4	193.5	121.6	109.1	0.72
11	2	236.67	Leg	PIPE 5.563x0.258	6.68	42.6	169.4	193.5	137.5	124.5	0.81
11	1	230.00	Leg	PIPE 5.563x0.258	6.68	42.6	169.4	193.5	150.9	137.3	0.89
10	3	223.33	Leg	PIPE 5.563x0.375	6.68	43.6	239.4	275.0	163.5	149.3	0.68
10	2	216.67	Leg	PIPE 5.563x0.375	6.68	43.6	239.4	275.0	174.6	159.7	0.73
10	1	210.00	Leg	PIPE 5.563x0.375	6.68	43.6	239.4	275.0	185.3	169.6	0.77
9	3	203.33	Leg	PIPE 5.563x0.375	6.68	43.6	239.4	275.0	194.6	178.2	0.81
9	2	196.67	Leg	PIPE 5.563x0.375	6.68	43.6	239.4	275.0	203.8	186.5	0.85
9	1	190.00	Leg	PIPE 5.563x0.375	6.68	43.6	239.4	275.0	211.9	193.8	0.89
8	3	183.33	Leg	PIPE 5.563x0.375	6.68	43.6	239.4	275.0	220.5	201.4	0.92
8	2	176.67	Leg	PIPE 5.563x0.375	6.68	43.6	239.4	275.0	228.2	208.4	0.95
8	1	170.00	Leg	PIPE 5.563x0.375	6.68	43.6	239.4	275.0	236.4	215.6	0.99
7	3	163.33	Leg	PIPE 6.625x0.340	6.68	36.0	274.8	302.1	243.8	222.1	0.89
7	2	156.67	Leg	PIPE 6.625x0.340	6.68	36.0	274.8	302.1	251.6	228.9	0.92
7	1	150.00	Leg	PIPE 6.625x0.340	6.68	36.0	274.8	302.1	258.6	234.9	0.94
6	2	140.00	Leg	PIPE 6.625x0.432	10.02	54.6	304.3	330.3	267.8	242.8	0.88
6	1	130.00	Leg	PIPE 6.625x0.432	10.02	54.6	304.3	330.3	278.0	251.4	0.91
5	2	120.00	Leg	PIPE 6.625x0.432	10.02	54.6	304.2	378.5	287.9	259.7	0.95
5	1	110.00	Leg	PIPE 6.625x0.432	10.02	54.6	304.2	378.5	297.1	267.1	0.98
4	2	100.00	Leg	PIPE 8.625x0.375	10.02	41.2	386.4	437.4	306.6	274.7	0.79
4	1	90.00	Leg	PIPE 8.625x0.375	10.02	41.2	386.4	437.4	316.2	282.4	0.82
3	3	80.00	Leg	PIPE 8.625x0.375	10.02	41.2	386.4	437.4	326.4	290.4	0.84
3	2	70.00	Leg	PIPE 8.625x0.375	10.02	41.2	386.4	437.4	336.0	297.8	0.87
3	1	60.00	Leg	PIPE 8.625x0.375	10.02	41.2	386.4	437.4	346.1	305.6	0.90
2	2	45.00	Leg	PIPE 8.625x0.375	15.02	30.9	407.9	437.4	351.8	308.7	0.86
2	1	30.00	Leg	PIPE 8.625x0.375	15.02	30.9	407.9	437.4	366.6	319.8	0.90
1	2	15.00	Leg	PIPE 8.625x0.375	15.02	30.9	407.9	437.4	381.4	330.6	0.94
1	1	0.00	Leg	PIPE 8.625x0.375	15.02	30.9	407.9	437.4	396.1	341.2	0.97
14	2	295.00	Diag	L1 3/4x1 3/4x1/8	6.90	106.8	10.5	7.1	1.1	1.2	0.17
14	1	290.00	Diag	L1 3/4x1 3/4x1/8	6.92	107.1	10.5	7.1	4.1	4.0	0.56
13	4	285.00	Diag	L1 3/4x1 3/4x1/8	6.93	106.3	10.6	7.1	4.1	4.1	0.58
13	3	280.00	Diag	L1 3/4x1 3/4x1/8	6.95	106.5	10.6	7.1	4.3	4.2	0.60
13	2	275.00	Diag	L1 3/4x1 3/4x1/8	6.96	106.6	10.5	7.1	6.5	6.6	0.93
13	1	270.00	Diag	L1 3/4x1 3/4x1/8	6.97	106.8	10.5	7.1	6.7	6.7	0.94
12	3	263.33	Diag	L1 3/4x1 3/4x1/8	8.47	131.8	6.9	7.1	5.8	5.5	0.83
12	2	256.67	Diag	L1 3/4x1 3/4x1/8	8.91	140.3	6.1	7.1	5.9	6.0	0.97
12	1	250.00	Diag	L1 3/4x1 3/4x1/8	9.38	149.1	5.4	7.1	5.3	5.2	0.99
11	3	243.33	Diag	L2x2x1/8	9.87	135.9	7.5	7.9	6.9	6.9	0.92
11	2	236.67	Diag	L2x2x1/8	10.37	143.9	6.6	7.9	6.3	6.3	0.95
11	1	230.00	Diag	L2x2x1/8	10.89	152.0	5.9	7.9	5.9	5.9	0.99
10	3	223.33	Diag	L2x2x3/16	11.43	164.5	7.5	11.8	5.6	5.6	0.75
10	2	216.67	Diag	L2x2x3/16	11.97	173.2	6.8	11.8	5.4	5.4	0.79
10	1	210.00	Diag	L2x2x3/16	12.53	182.0	6.1	11.8	5.2	5.2	0.85
9	3	203.33	Diag	L2 1/2x2 1/2x3/16	13.11	152.0	11.2	14.1	4.8	4.8	0.43
9	2	196.67	Diag	L2 1/2x2 1/2x3/16	13.71	159.5	10.1	14.1	4.7	4.8	0.47

File: W:\Jobs\2023\244307\ENGINEERING\244307.out

Contract: 244307

Project: 300 FT RTL TOWER

Date and Time: 9/18/2023 1:25:31 PM

Revision: 0

Site: MT VERNON EAST- KY

Engineer: AS

9	1	190.00	Diag	L2 1/2x2 1/2x3/16	14.32	167.1 9.2	14.1	4.7	4.7	0.51
8	3	183.33	Diag	L2 1/2x2 1/2x3/16	14.93	174.5 8.5	10.7	4.9	5.0	0.58
8	2	176.67	Diag	L2 1/2x2 1/2x3/16	15.53	181.9 7.8	10.7	5.0	4.9	0.64
8	1	170.00	Diag	L2 1/2x2 1/2x3/16	16.13	189.4 7.2	10.7	5.0	5.0	0.69
7	3	163.33	Diag	L2 1/2x2 1/2x3/16	16.74	176.8 8.2	18.8	5.0	5.0	0.61
7	2	156.67	Diag	L2 1/2x2 1/2x3/16	17.35	182.6 7.7	18.8	5.0	5.1	0.65
7	1	150.00	Diag	L2 1/2x2 1/2x3/16	17.97	188.4 7.3	18.8	5.1	5.1	0.71
6	2	140.00	Diag	L3x3x3/16	20.18	178.7 9.8	23.2	5.6	5.6	0.57
6	1	130.00	Diag	L3x3x3/16	21.05	185.5 9.1	23.2	5.7	5.6	0.62
5	2	120.00	Diag	L3x3x3/16	21.97	193.5 8.3	21.1	5.1	5.1	0.61
5	1	110.00	Diag	L3x3x3/16	22.93	201.0 7.7	21.1	5.2	5.2	0.67
4	2	100.00	Diag	L3 1/2x3 1/2x1/4	23.86	180.6 14.8	31.1	5.9	6.0	0.40
4	1	90.00	Diag	L3 1/2x3 1/2x1/4	24.77	186.8 13.9	31.1	6.1	6.1	0.44
3	3	80.00	Diag	L4x4x1/4	25.69	170.2 19.2	34.1	6.3	6.3	0.33
3	2	70.00	Diag	L4x4x1/4	26.62	175.5 18.0	34.1	6.5	6.4	0.36
3	1	60.00	Diag	L4x4x1/4	27.55	180.9 17.0	34.1	6.6	6.6	0.39
2	2	45.00	Diag	L4x4x1/4	20.41	180.3 17.1	34.1	9.7	9.7	0.57
2	1	30.00	Diag	L4x4x1/4	20.92	185.3 16.2	34.1	9.8	9.8	0.61
1	2	15.00	Diag	L4x4x1/4	21.45	190.5 15.3	34.1	9.9	9.9	0.65
1	1	0.00	Diag	L4x4x1/4	22.00	195.7 14.5	34.1	10.0	10.0	0.69
14	2	295.00	Horiz	L1 3/4x1 3/4x3/16	4.75	145.7 8.4	10.7	0.7	0.7	0.09
12	3	263.33	Horiz	L1 3/4x1 3/4x3/16	4.87	145.1 8.4	10.7	0.1	0.0	0.01
2	2	45.00	Horiz	L3 1/2x3 1/2x1/4	13.08	179.7 15.0	31.1	6.6	6.5	0.44
2	1	30.00	Horiz	L3 1/2x3 1/2x1/4	13.83	187.7 13.7	31.1	6.9	6.8	0.50
1	2	15.00	Horiz	L4x4x1/4	14.58	175.2 18.1	34.1	7.1	7.0	0.39
1	1	0.00	Horiz	L4x4x1/4	15.33	182.1 16.8	34.1	7.4	7.3	0.44
2	2	45.00	SecH1	L3x3x1/4	6.54	133.0 17.2	17.2	6.1	6.1	0.35
2	2	45.00	SecD1	L3x3x1/4	9.71	197.5 10.6	17.2	4.8	4.8	0.45
2	2	45.00	PlanH1	L3 1/2x3 1/2x1/4	13.08	227.5 9.3	17.2	0.0	0.0	0.00
2	1	30.00	SecH1	L3x3x1/4	6.92	140.7 17.2	17.2	6.3	6.3	0.37
2	1	30.00	SecD1	L3x3x1/4	9.95	202.5 10.1	17.2	4.8	4.8	0.48
2	1	30.00	PlanH1	L3 1/2x3 1/2x1/4	13.83	240.6 8.4	17.2	0.0	0.0	0.01
1	2	15.00	SecH1	L3x3x1/4	7.29	148.3 17.2	17.2	6.6	6.6	0.38
1	2	15.00	SecD1	L3x3x1/4	10.20	207.5 9.6	17.2	4.9	4.9	0.51
1	2	15.00	PlanH1	L4x4x1/4	14.58	218.7 11.6	17.2	0.0	0.0	0.00
1	1	0.00	SecH1	L3x3x1/4	7.67	155.9 17.0	17.2	6.8	6.8	0.40
1	1	0.00	SecD1	L3x3x1/4	10.46	212.8 9.1	17.2	4.9	4.9	0.54
1	1	0.00	PlanH1	L4x4x1/4	15.33	230.0 10.5	17.2	0.0	0.0	0.00

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Contract: 244307

Project: 300 FT RTL TOWER

Date and Time: 9/18/2023 1:25:31 PM

Revision: 0

Site: MT VERNON EAST- KY

Engineer: AS

Section M: SECTION PROPERTIES DATA

Sec	Pan	Memb.	Steel	Conn.	Bolts	Bolt	Bolt	End	Gusset	kl/r	Comp	Tens	Bolt	Bear.	Block
		Type	Grade	Type	Bolts	Size	Grade	Dist.	Thick.		Cap.	Cap.	Cap.	Cap.	Shear
						(in)		(in)	(in)	(Kips)	(Kips)	(Kips)	(Kips)	(Kips)	(Kips)
14	2	Leg	A500 gr.CS	Tension	4	0.750	A325X	1.800	N/A	63.4	57.1	76.5	121.7T	N/A	N/A
14	2	Diag	A529 gr.50	Bolted	1	0.625	A325X	1.500	0.250	106.8	10.5	11.9	17.2S	9.8	7.1
14	2	Horiz	A529 gr.50	Bolted	1	0.625	A325X	1.500	0.250	145.7	8.4	17.4	17.2S	14.7	10.7
14	1	Leg	A500 gr.CS	Tension	4	0.750	A325X	1.800	N/A	63.4	57.1	76.5	121.7T	N/A	N/A
14	1	Diag	A529 gr.50	Bolted	1	0.625	A325X	1.500	0.250	107.1	10.5	11.9	17.2S	9.8	7.1
13	4	Leg	A500 gr.CS	Tension	5	0.875	A325X	2.100	N/A	51.7	82.5	100.4	209.9T	N/A	N/A
13	4	Diag	A529 gr.50	Bolted	1	0.625	A325X	1.500	0.250	106.3	10.6	11.9	17.2S	9.8	7.1
13	3	Leg	A500 gr.CS	Tension	5	0.875	A325X	2.100	N/A	51.7	82.5	100.4	209.9T	N/A	N/A
13	3	Diag	A529 gr.50	Bolted	1	0.625	A325X	1.500	0.250	106.5	10.6	11.9	17.2S	9.8	7.1
13	2	Leg	A500 gr.CS	Tension	5	0.875	A325X	2.100	N/A	51.7	82.5	100.4	209.9T	N/A	N/A
13	2	Diag	A529 gr.50	Bolted	1	0.625	A325X	1.500	0.250	106.6	10.5	11.9	17.2S	9.8	7.1
13	1	Leg	A500 gr.CS	Tension	5	0.875	A325X	2.100	N/A	51.7	82.5	100.4	209.9T	N/A	N/A
13	1	Diag	A529 gr.50	Bolted	1	0.625	A325X	1.500	0.250	106.8	10.5	11.9	17.2S	9.8	7.1
12	3	Leg	A500 gr.CS	Tension	5	1.000	A325X	2.400	N/A	53.1	116.1	142.6	275.3T	N/A	N/A
12	3	Diag	A529 gr.50	Bolted	1	0.625	A325X	1.500	0.250	131.8	6.9	11.9	17.2S	9.8	7.1
12	3	Horiz	A529 gr.50	Bolted	1	0.625	A325X	1.500	0.250	145.1	8.4	17.4	17.2S	14.7	10.7
12	2	Leg	A500 gr.CS	Tension	5	1.000	A325X	2.400	N/A	53.1	116.1	142.6	275.3T	N/A	N/A
12	2	Diag	A529 gr.50	Bolted	1	0.625	A325X	1.500	0.250	140.3	6.1	11.9	17.2S	9.8	7.1
12	1	Leg	A500 gr.CS	Tension	5	1.000	A325X	2.400	N/A	53.1	116.1	142.6	275.3T	N/A	N/A
12	1	Diag	A529 gr.50	Bolted	1	0.625	A325X	1.500	0.250	149.1	5.4	11.9	17.2S	9.8	7.1
11	3	Leg	A500 gr.CS	Tension	5	1.000	A325X	2.400	N/A	42.6	169.4	193.5	275.3T	N/A	N/A
11	3	Diag	A529 gr.50	Bolted	1	0.625	A325X	1.500	0.250	135.9	7.5	14.1	17.2S	9.8	7.9
11	2	Leg	A500 gr.CS	Tension	5	1.000	A325X	2.400	N/A	42.6	169.4	193.5	275.3T	N/A	N/A
11	2	Diag	A529 gr.50	Bolted	1	0.625	A325X	1.500	0.250	143.9	6.6	14.1	17.2S	9.8	7.9
11	1	Leg	A500 gr.CS	Tension	5	1.000	A325X	2.400	N/A	42.6	169.4	193.5	275.3T	N/A	N/A
11	1	Diag	A529 gr.50	Bolted	1	0.625	A325X	1.500	0.250	152.0	5.9	14.1	17.2S	9.8	7.9
10	3	Leg	A500 gr.CS	Tension	5	1.000	A325X	2.400	N/A	43.6	239.4	275.0	275.3T	N/A	N/A
10	3	Diag	A529 gr.50	Bolted	1	0.625	A325X	1.500	0.250	164.5	7.5	20.7	17.2S	14.7	11.8
10	2	Leg	A500 gr.CS	Tension	5	1.000	A325X	2.400	N/A	43.6	239.4	275.0	275.3T	N/A	N/A
10	2	Diag	A529 gr.50	Bolted	1	0.625	A325X	1.500	0.250	173.2	6.8	20.7	17.2S	14.7	11.8
10	1	Leg	A500 gr.CS	Tension	5	1.000	A325X	2.400	N/A	43.6	239.4	275.0	275.3T	N/A	N/A
10	1	Diag	A529 gr.50	Bolted	1	0.625	A325X	1.500	0.250	182.0	6.1	20.7	17.2S	14.7	11.8
9	3	Leg	A500 gr.CS	Tension	5	1.000	A325X	2.400	N/A	43.6	239.3	275.0	275.3T	N/A	N/A
9	3	Diag	A529 gr.50	Bolted	1	0.625	A325X	1.500	0.250	152.0	11.2	27.7	17.2S	14.7	14.1
9	2	Leg	A500 gr.CS	Tension	5	1.000	A325X	2.400	N/A	43.6	239.3	275.0	275.3T	N/A	N/A
9	2	Diag	A529 gr.50	Bolted	1	0.625	A325X	1.500	0.250	159.5	10.1	27.7	17.2S	14.7	14.1
9	1	Leg	A500 gr.CS	Tension	5	1.000	A325X	2.400	N/A	43.6	239.3	275.0	275.3T	N/A	N/A
9	1	Diag	A529 gr.50	Bolted	1	0.625	A325X	1.500	0.250	167.1	9.2	27.7	17.2S	14.7	14.1
8	3	Leg	A500 gr.CS	Tension	6	1.000	A325X	2.400	N/A	43.6	239.4	275.0	330.3T	N/A	N/A
8	3	Diag	A529 gr.50	Bolted	1	0.625	A325X	1.500	0.250	174.5	8.5	27.7	17.2S	14.7	10.7
8	2	Leg	A500 gr.CS	Tension	6	1.000	A325X	2.400	N/A	43.6	239.4	275.0	330.3T	N/A	N/A
8	2	Diag	A529 gr.50	Bolted	1	0.625	A325X	1.500	0.250	181.9	7.8	27.7	17.2S	14.7	10.7
8	1	Leg	A500 gr.CS	Tension	6	1.000	A325X	2.400	N/A	43.6	239.4	275.0	330.3T	N/A	N/A
8	1	Diag	A529 gr.50	Bolted	1	0.625	A325X	1.500	0.250	189.4	7.2	27.7	17.2S	14.7	10.7
7	3	Leg	A500 gr.CS	Tension	6	1.000	A325X	2.400	N/A	36.0	274.8	302.1	330.3T	N/A	N/A
7	3	Diag	A529 gr.50	Bolted	2	0.625	A325X	1.125	0.375	176.8	8.2	27.7	34.5S	25.7	18.8
7	2	Leg	A500 gr.CS	Tension	6	1.000	A325X	2.400	N/A	36.0	274.8	302.1	330.3T	N/A	N/A
7	2	Diag	A529 gr.50	Bolted	2	0.625	A325X	1.125	0.375	182.6	7.7	27.7	34.5S	25.7	18.8
7	1	Leg	A500 gr.CS	Tension	6	1.000	A325X	2.400	N/A	36.0	274.8	302.1	330.3T	N/A	N/A
7	1	Diag	A529 gr.50	Bolted	2	0.625	A325X	1.125	0.375	188.4	7.3	27.7	34.5S	25.7	18.8

File: W:\Jobs\2023\244307\ENGINEERING\244307.out

Contract: 244307

Project: 300 FT RTL TOWER

Date and Time: 9/18/2023 1:25:31 PM

Revision: 0

Site: MT VERNON EAST- KY

Engineer: AS

6	2	Leg	A500 gr.CS Tension	6	1.000	A325X	2.400	N/A	54.6	304.3	378.5	330.3T	N/A	N/A
6	2	Diag	A529 gr.50 Bolted	2	0.625	A325X	1.500	0.375	178.7	9.8	34.6	34.5S	29.4	23.2
6	1	Leg	A500 gr.CS Tension	6	1.000	A325X	2.400	N/A	54.6	304.3	378.5	330.3T	N/A	N/A
6	1	Diag	A529 gr.50 Bolted	2	0.625	A325X	1.500	0.375	185.5	9.1	34.6	34.5S	29.4	23.2
5	2	Leg	A500 gr.CS Tension	6	1.500	A325X	3.600	N/A	54.6	304.2	378.5	765.3T	N/A	N/A
5	2	Diag	A529 gr.50 Bolted	2	0.625	A325X	1.125	0.375	193.5	8.3	34.6	34.5S	25.7	21.1
5	1	Leg	A500 gr.CS Tension	6	1.500	A325X	3.600	N/A	54.6	304.2	378.5	765.3T	N/A	N/A
5	1	Diag	A529 gr.50 Bolted	2	0.625	A325X	1.125	0.375	201.0	7.7	34.6	34.5S	25.7	21.1
4	2	Leg	A500 gr.CS Tension	6	1.500	A325X	3.600	N/A	41.2	386.4	437.4	765.3T	N/A	N/A
4	2	Diag	A529 gr.50 Bolted	2	0.625	A325X	1.125	0.375	180.6	14.8	54.8	34.5S	34.1	31.1
4	1	Leg	A500 gr.CS Tension	6	1.500	A325X	3.600	N/A	41.2	386.4	437.4	765.3T	N/A	N/A
4	1	Diag	A529 gr.50 Bolted	2	0.625	A325X	1.125	0.375	186.8	13.9	54.8	34.5S	34.1	31.1
3	3	Leg	A500 gr.CS Tension	6	1.500	A325X	3.600	N/A	41.2	386.4	437.4	765.3T	N/A	N/A
3	3	Diag	A529 gr.50 Bolted	2	0.625	A325X	1.125	0.375	170.2	19.2	63.9	34.5S	34.1	34.2
3	2	Leg	A500 gr.CS Tension	6	1.500	A325X	3.600	N/A	41.2	386.4	437.4	765.3T	N/A	N/A
3	2	Diag	A529 gr.50 Bolted	2	0.625	A325X	1.125	0.375	175.5	18.0	63.9	34.5S	34.1	34.2
3	1	Leg	A500 gr.CS Tension	6	1.500	A325X	3.600	N/A	41.2	386.4	437.4	765.3T	N/A	N/A
3	1	Diag	A529 gr.50 Bolted	2	0.625	A325X	1.125	0.375	180.9	17.0	63.9	34.5S	34.1	34.2
2	2	Leg	A500 gr.CS Tension	6	1.500	A325X	3.600	N/A	30.9	407.9	437.4	765.3T	N/A	N/A
2	2	Diag	A529 gr.50 Bolted	2	0.625	A325X	1.125	0.375	180.3	17.1	63.9	34.5S	34.1	34.2
2	2	Horiz	A529 gr.50 Bolted	2	0.625	A325X	1.125	0.375	179.7	15.0	54.8	34.5S	34.1	31.1
2	2	SecH1	A529 gr.50 Bolted	1	0.625	A325X	1.500	0.250	133.0	23.3	45.6	17.2S	19.5	21.8
2	2	SecD1	A529 gr.50 Bolted	1	0.625	A325X	1.500	0.250	197.5	10.6	45.6	17.2S	19.5	21.8
2	2	PlanH1	A529 gr.50 Bolted	1	0.625	A325X	1.500	0.250	227.5	9.3	54.8	17.2S	19.5	24.8
2	1	Leg	A500 gr.CS Tension	6	1.500	A325X	3.600	N/A	30.9	407.9	437.4	765.3T	N/A	N/A
2	1	Diag	A529 gr.50 Bolted	2	0.625	A325X	1.125	0.375	185.3	16.2	63.9	34.5S	34.1	34.2
2	1	Horiz	A529 gr.50 Bolted	2	0.625	A325X	1.125	0.375	187.7	13.7	54.8	34.5S	34.1	31.1
2	1	SecH1	A529 gr.50 Bolted	1	0.625	A325X	1.500	0.250	140.7	20.8	45.6	17.2S	19.5	21.8
2	1	SecD1	A529 gr.50 Bolted	1	0.625	A325X	1.500	0.250	202.5	10.1	45.6	17.2S	19.5	21.8
2	1	PlanH1	A529 gr.50 Bolted	1	0.625	A325X	1.500	0.250	240.6	8.4	54.8	17.2S	19.5	24.8
1	2	Leg	A500 gr.CS Tension	6	1.500	A325X	3.600	N/A	30.9	407.9	437.4	765.3T	N/A	N/A
1	2	Diag	A529 gr.50 Bolted	2	0.625	A325X	1.125	0.375	190.5	15.3	63.9	34.5S	34.1	34.2
1	2	Horiz	A529 gr.50 Bolted	2	0.625	A325X	1.125	0.375	175.2	18.1	63.9	34.5S	34.1	34.2
1	2	SecH1	A529 gr.50 Bolted	1	0.625	A325X	1.500	0.250	148.3	18.7	45.6	17.2S	19.5	21.8
1	2	SecD1	A529 gr.50 Bolted	1	0.625	A325X	1.500	0.250	207.5	9.6	45.6	17.2S	19.5	21.8
1	2	PlanH1	A529 gr.50 Bolted	1	0.625	A325X	1.500	0.250	218.7	11.6	63.9	17.2S	19.5	27.9
1	1	Leg	A500 gr.CS Tension	6	1.500	A325X	3.600	N/A	30.9	407.9	437.4	765.3T	N/A	N/A
1	1	Diag	A529 gr.50 Bolted	2	0.625	A325X	1.125	0.375	195.7	14.5	63.9	34.5S	34.1	34.2
1	1	Horiz	A529 gr.50 Bolted	2	0.625	A325X	1.125	0.375	182.1	16.8	63.9	34.5S	34.1	34.2
1	1	SecH1	A529 gr.50 Bolted	1	0.625	A325X	1.500	0.250	155.9	17.0	45.6	17.2S	19.5	21.8
1	1	SecD1	A529 gr.50 Bolted	1	0.625	A325X	1.500	0.250	212.8	9.1	45.6	17.2S	19.5	21.8
1	1	PlanH1	A529 gr.50 Bolted	1	0.625	A325X	1.500	0.250	230.0	10.5	63.9	17.2S	19.5	27.9



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Contract: 244307

Project: 300 FT RTL TOWER

Date and Time: 9/18/2023 1:25:31 PM

Revision: 0

Site: MT VERNON EAST- KY

Engineer: AS

Section N: LEG REACTION DATA

Load Combination Max Envelope
Wind Direction Maximum

Force-Y Download (Kips)	Force-Y Uplift (Kips)	Shear-X (Kips)	Shear-Z (Kips)	Max Shear (Kips)
409.20	351.64			35.17

File: W:\Jobs\2023\244307\ENGINEERING\244307.out

Contract: 244307

Project: 300 FT RTL TOWER

Date and Time: 9/18/2023 1:25:31 PM

Revision: 0

Site: MT VERNON EAST- KY

Engineer: AS

Section O: TOWER FOUNDATION DATALoad Combination Max Envelope
Wind Direction Maximum

Axial Load (Kips)	Shear Load-X (Kips)	Shear Load-Z (Kips)	Total Shear (Kips)	Moment-X (Kipsft)	Moment-Y (Kipsft)	Moment-Z (Kipsft)	Total Moment (Kipsft)
52.61	28.64	49.62	57.30	9308.88	-3.42	-5372.15	10747.80
52.61	28.64	49.62	57.30	9308.88	-3.42	-5372.15	10747.80

File: W:\Jobs\2023\244307\ENGINEERING\244307.out

Contract: 244307

Project: 300 FT RTL TOWER

Date and Time: 9/18/2023 1:25:31 PM


Revision: 0

Site: MT VERNON EAST- KY

Engineer: AS

DESIGN SPECIFICATION

Sct.	Length (ft)	Top W. (in)	Bot Width (in)
1	30.00	349.97	385.97
2	30.00	313.97	349.97
3	30.00	277.97	313.97
4	20.00	253.97	277.97
5	20.00	228.24	253.97
6	20.00	204.24	228.24
7	20.00	180.24	204.24
8	20.00	156.24	180.24
9	20.00	131.32	156.24
10	20.00	107.32	131.32
11	20.00	83.32	107.32
12	20.00	58.40	83.32
13	20.00	57.53	58.40
14	10.00	56.99	57.53

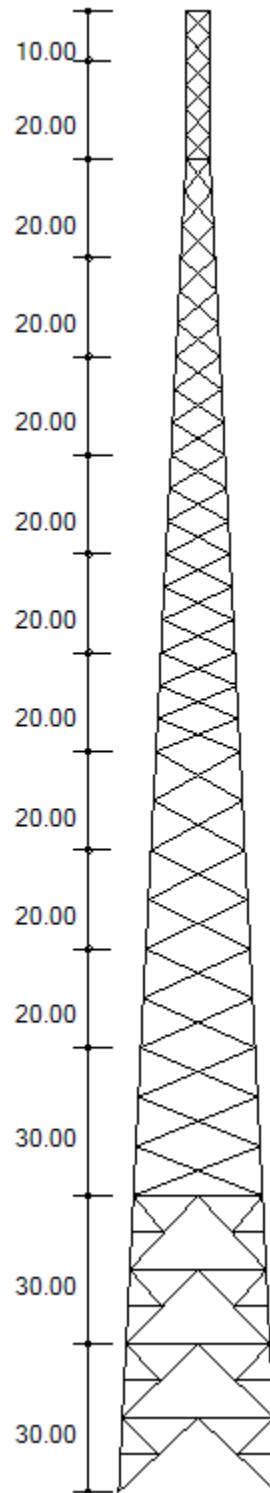

MAXIMUM BASE REACTIONS

Download (Kips)	409.2
Uplift (Kips)	351.6
Shear (Kips)	35.2

Customer: TAG TOWERS, LLC
 Project: 300 FT RTL TOWER
 Site: MT VERNON EAST, KY
 Engr. File: 244307
 Build Code: ANSI/TIA-222-H-2016



Mat Foundation

ver.3.0.4

Design Parameters

Description	Load Case					
	1	2	3	4	5	Service
Total Moment, ft-kips	10,747.04	10,747.80	1,603.64	419.51	418.50	3,587.64
Total Shear, kips	57.29	57.30	7.87	1.75	1.75	19.35
Total Tower Wt, kips	70.14	52.61	158.34	70.12	52.59	58.44
Max. Uplift, kips	345.83	351.64	4.79	.00	.00	104.01
Shear, kips	30.74	31.06	1.79	9.71	9.71	9.71
Max Download, kips	409.20	403.39	110.21	38.43	32.55	148.28
Shear	35.17	34.84	7.84	2.40	2.07	12.54
Soil L.F.	1.20	0.90	1.20	1.20	0.90	1.00
Concrete L.F.	1.20	0.90	1.20	1.20	0.90	1.00

Foundation	
Ht. AGL, ft	0.50
Depth, ft.	5.25
Tower	
Face Width, ft	32.16
Offset, in	60.00
Soil	
Blow Count	N/A
Inplace Unit Wt, pcf	110.00
Submerged Unit Wt, pcf	60.00
Friction Angle, ϕ , deg.	30.00
Cohesion, ksf	N/A
Uplift Angle, deg.	30.00
Water Depth, ft	None
Ult Bearing Capacity, ksf	11.50

Mat	
Thickness, ft	1.75
Width, ft	38.50
EA, in	15.00
Batter, in/ft	0.00

Pier	
Height, ft	4.00
Diameter, ft	3.50
No. Piers	3
Shape	Round

Anchor Bolts	
Diameter, in	1.5000
No.	6
Length, in	74.00
Bolt Circle, in	20.00
Projection, in	9.00

Pocket	
Diameter, in	N/A
Thickness, ft	N/A

Concrete	
28 Day Strength, ksi	4.50
Dry Unit Wt, pcf	150.00
Wet Unit Wt, pcf	88.00

Rebar Fy	
Vertical, ksi	60.00
Circular, ksi	60.00
Horizontal, ksi	60.00

Results

ϕM_N – Parallel Axis	16,595.29 ft-kips
ϕM_N – Diagonal Axis	18,279.47 ft-kips
Moment – Interaction Ratio	0.685
ϕV_N – Lateral Load	242.02 kips
Lateral Load – Interaction Ratio	0.237

Final Mat Dimension : 38.50 x 38.50 x 1.75 ft. thick w/ (3) 3.50 ft. Dia. Piers

Final Pocket Dimension : Pockets not required

Total Volume of Concrete : 100.3 yd³

Designed By: AS

Date: 18 September, 2023 @ 01:37 PM

ENGINEERING
CHECKED BY: SY
09/18/2023

Customer: TAG TOWERS, LLC
 Project: 300 FT RTL TOWER
 Site: MT VERNON EAST, KY
 Engr. File: 244307
 Build Code: ANSI/TIA-222-H-2016



Mat Foundation

ver.3.0.4

OTM Capacity

Controlling Load Case: 2 [Wind w/Min. Dead Load]

Foundation Width = 38.50 ft

$M_U = 11,371.4 \text{ ft-kips}$

	$\phi M_N, \text{ ft-kips}$	x, ft	N	σ_{ur}
Parallel	16,595.3	3.850	0.100	8.50
Diagonal	18,279.5	12.175	0.224	8.50

$\phi M_N = 16,595.29 \text{ ft-kips}$

$\phi V_N = 242.02 \text{ kips}$

IRatio = 0.685

IRatio = 0.237

Mat Design

$\gamma_e = 123.33 \text{ pcf}$

Exterior Slab	x, ft	N	$\sigma_R, \text{ ksf}$	$P_s \text{ kips}$	$P_{su} \text{ kips}$	Moment, ft-kips/ft		Shear, kips/ft	
						DownLoad Side	Uplift Side	Download Side	Uplift Side
Parallel	14.481	0.376	1.68	23.08	0.00	8.50	8.32	4.32	3.64
Diagonal	22.821	0.419	1.80	23.08	0.00	59.98	43.14	12.45	8.49

Interior Slab	Moment, ft-kips/ft			Shear, kips/ft		
	DownLoad Side	Uplift Side	Download Side	Uplift Side	Soil Pressure Termination	
	40.57	45.95	6.70	6.22	5.90	

Punching Shear	Download			Uplift			Description	
	Interior	Edge	Corner	Interior	Edge	Corner		
b _o , ft	17.74	15.21	12.57	15.08	13.88	11.91	2-Way Shear	
V _{su} , psi	133.10	162.70	206.70	132.88	150.50	185.79		
$\phi V_c, \text{ psi}$	228.08	228.08	228.08	228.08	228.08	228.08		
IR	0.58	0.71	0.91	0.58	0.66	0.81		
M _{ut} , ft-kips	84.4			74.5			Moment transfer to slab	
B _e , ft	7.5			7.2				
M _u , ft-kips/ft	11.2			10.4				

Edge Distances: a = 5.68 ft. b = 3.17 ft. c = 4.97 ft.

Summary	Max. Value	Utilization
Slab Moment, ft-kips/ft	59.98	0.979
Slab Shear, kips/ft	12.45	0.569
Punching Shear, psi	206.70	0.906
Soil Bearing Required, σ_{UR} , ksf	2.40	0.209

Mat Reinforcement	
Min. Steel Area (Strength)	.694 in ² /ft.
Min. Steel Area (Temperature)	.227 in ² /ft.
Steel Strain Actual	0.018
Minimum Steel Strain Required	0.005

62 - #6 Horizontal bars equally spaced @7.48 in., each way, top and bottom, total of 248, A_s = 0.711 in²/ft

Designed By: AS

Date: 18 September, 2023 @ 01:37 PM

Customer: TAG TOWERS, LLC
Project: 300 FT RTL TOWER
Site: MT VERNON EAST, KY
Engr. File: 244307
Build Code: ANSI/TIA-222-H-2016



Mat Foundation

ver.3.0.4

Pier Design

Controlling Load Case: 2 [Wind w/Min. Dead Load]

C = 403.39 kips	Vc = 34.84 kips	Mc = 139.36 ft-kips
T = 351.64 kips	Vt = 31.06 kips	Mt = 124.24 ft-kips
Fy = 60.00 ksi	Fyt = 60.00 ksi	L.F. = 1.00
H = 42.00 in.	Ds = 33.00 in.	F'c = 4.50 ksi
U = 1.00	Irs = Round	

*** NOTE: Pier cross section is Round ***

SUMMARY OF ANALYSIS

Minimum area of steel required	= 10.959 in ²	(Rhomin = 0.0079)
Area of steel provided.	= 10.996 in ²	(Rhoactual= 0.0079)
Maximum steel area limit	= 110.836 in ²	(Rhomax = 0.0800)

(14) #8 Vertical Bars equally spaced w/ #4 Circular Ties @ 6" on center.

CIRCULAR TIE DATA

Vu < 0.85*Vc/2, shear reinforcement is not required

Use maximum tie spacing specified in ACI 318,
Section 7.10.5 for compression reinforcement.

DEVELOPMENT LENGTH MODIFIERS FOR BAR DEVELOPMENT

Modifier for tension development	= 1.000
Modifier for compression development	= 0.169
REQUIRED Ld = MODIFIER * BASIC Ld * ACI 318 MODIFIERS, (12 in. min.)	

Designed By: AS

Date: 18 September, 2023 @ 01:37 PM

File no : 244307

By: AS

Customer: **TAG TOWERS, LLC**

Date 09/18/23

Chk:

Description: **300 FT RTL TOWER**

Page 1

ENGINEERING
CHECKED BY: SY
09/18/2023

MT VERNON EAST, KY

Ver. 11/16/01

FACTORED REACTIONS / LEGTower Type: RT

COMPRESSION = 409.20 k (6) - 1.5 " dia A.B. per leg
 UPLIFT = 351.64 k $f'_c = 4,500$ psi
 SHEAR = 35.17 k $f_y = 60,000$ psi

SOIL PARAMETERS

A) Depth neglected for skin friction = Top 3.0 ft

B) Average ultimate skin shear for uplift:

3.0 ft to 6.0 ft depth = 2300 psf, and 6.0 ft to 9.0 ft depth = 2000 psf, and 9.0 ft to 19.0 ft depth = 1300 psf.

C) Average ultimate skin shear for download:

3.0 ft to 6.0 ft depth = 2300 psf, and 6.0 ft to 9.0 ft depth = 2000 psf, and 9.0 ft to 19.0 ft depth = 1300 psf.

D) Ultimate net end bearing at 19.0 ft = 40.00 ksf.

E) Groundwater table below foundation depth.

**USE 5'- 0" DIAMETER AND 19'- 0" DEEP DRILLED PIER
WITH 0'- 6" CAP**

Perimeter = 15.71 ft Area = 19.63 ft^2

Total Download = 409.20 + [1.2 x 0.15 - 0.75 x 0.120] x 19 x 19.63 =
 = 443.7 k

Tension Capacity = 19.63 x (19.5 x 0.15 + 0.0 x 0.09) x 0.90 +
 15.71 x (2.300 x 3.0 + 2.000 x 3.0 + 1.300 x 10.0) x 0.75 =
 51.7 + 305.2 = 356.9 k
 356.9 >= 351.64 OK

Comp. Capacity = 19.63 x 40.00 x 0.75 +
 15.71 x (2.300 x 3.0 + 2.000 x 3.0 + 1.300 x 10.0) x 0.75 =
 588.9 + 305.2 = 894.1 k
 894.1 >= 443.7 OK

LATERAL - SEE ATTACHED CALCULATIONS USING WIGGINS METHOD

Max M = 251.36 ft-k Max V = 41.04 k

REINFORCEMENT - SEE ATTACHED SHAFT PROGRAM

USE 18 - # 8 BARS VERTICAL WITH *
 # 4 TIES AT 6" IN TOP 7.0 FT AND AT
 12 " IN REST OF PIER
 {48.0 in Cage Diameter}

CONCRETE VOLUME 19.63 x 19.5 / 27 = 14.2 cu yds / pier

Drilled Pier Analysis

```
*****
** WIGGINS METHOD **
*****
** DETERMINE MAXIMUM LATERAL SOIL PRESSURE   **
** AND MAXIMUM MOMENT IN THE SHAFT FOR        **
** A DRILLED PIER FOUNDATION                  **
***** Mon Sep 18 13:33:15 2023 *****
Ver. 2.3 NT
```

FILE NO.- 244307

ENGR.- AS

DESCR.- 244307 300 FT RTL TOWER MT VER

FORMULAS USED

$$S1 = \frac{6*P*(1+N)}{D*L*(1-N)*(1-N)}$$

$$L = (MA/P) + R + E$$

$$S2 = \frac{(N+3)*(N+3)*S1}{8*(N+1)*(N+2)}$$

$$NL = (MA/P) + R + G$$

$$K = \frac{1 - (N*N)}{2 * (2 + N)}$$

$$N = NL / L$$


$$Y = \frac{L * (1 - K) - NL}{2}$$

$$SP1 = S1 / E$$

$$M = P * (NL + 5/8 * Y)$$

$$SP2 = S2 / (Y + G)$$

$$V = S1 * D * K * L / 2. \text{ or } P \text{ whichever is greater}$$

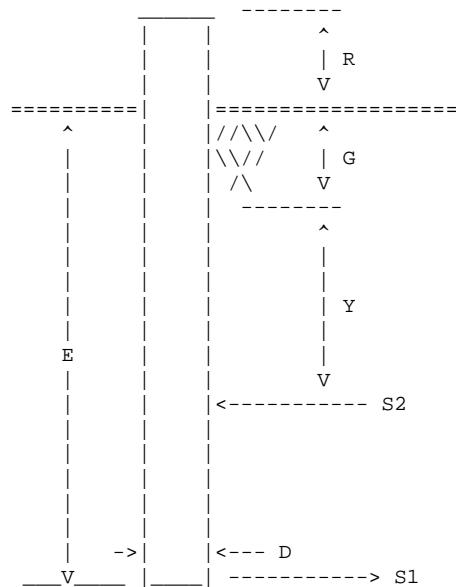

Diameter of Pier = D = 5.00 ft
 Projection Above Grade = R = .50 ft
 Embedment Depth = E = 19.00 ft
 Depth of Soil Ignored = G = 3.00 ft

Equivalent Length of Pier = L = 19.50 ft
 Length for NO Soil Resistance = NL = 3.50 ft
 Applied Moment at Top of Pier = MA = .00 ft-k
 Shear at Top of Pier = P = 35.17 kips

MAXIMUM LATERAL SOIL PRESSURES

$$K = .2220 \quad S1 = 3.792 \text{ ksf} \quad SP1 = 200 \text{ psf/ft}$$

$$Y = 5.84 \text{ ft} \quad S2 = 1.864 \text{ ksf} \quad SP2 = 211 \text{ psf/ft}$$

MAXIMUM VALUES IN SHAFT

$$M = 251.36 \text{ ft-k}$$

$$V = 41.04 \text{ kips}$$

Drilled Pier Analysis

** * * * * COMPARISION DATA * *
** * * * * *****

244307
244307 300 FT RTL

BROMS ---->	SAND	CLAY
	PHI = 30.0 degrees	C = 1.00 ksf
	DENSITY = 100.00pcf	
	E = 15.22 ft	E = 16.47 ft
	Max. M = 254.19 ft-k	Max. M = 308.85 ft-k
	Max. V = 103.59 kips	Max. V = 83.36 kips
	Ls = 11.106 ft	

EIA REV. E NORMAL SOIL -----> E = 10.76 ft

EIA REV. F NORMAL SOIL -----> E = 13.36 ft

Drilled Pier Analysis

•&18DNAME: AS

FILE NO. 244307

PAGE NO. 1

SHAFT REINFORCING PROGRAM VER. 91.7

=====

DESIGNED BY: AS
ENG. FILE NO.: 244307
DATE: 09/18/23

CUSTOMER: 244307
DESCRIPTION: 300 FT RTL TOWERMT VERNON EAST, KY

INPUT DATA

=====

C = 409.20 Kips	Vc = 41.04 Kips	Mc = 251.36 Ft-K
T = 351.64 Kips	Vt = 41.04 Kips	Mt = 251.36 Ft-K
Fy = 60.00 Ksi	Fyt = 60.00 Ksi	L.F. = 1.00
H = 60.00 In.	Ds = 48.00 In.	F'c = 4.50 Ksi
U = 1.00	Irs = 1	

*** SHAFT CROSS SECTION IS ROUND ***

SUMMARY OF ANALYSIS

=====

Minimum area of steel req'd. = 14.14 sq.in. (Rhomin = 0.0050)

Maximum steel area limit = 226.20 sq.in. (Rhomax = 0.0800)

CIRCULAR TIE DATA

=====

Vu < .85*Vc/2, shear reinforcement is not required.

Use maximum tie spacing specified in A.C.I. 318-83,
Section 7.10.5 for compression reinforcement.

DEVELOPMENT LENGTH MODIFIERS FOR TENSION AND COMPRESSION BAR DEVELOPMENT

=====

DLMT = MODIFIER FOR TENSION DEVELOPMENT = 1.000

DLMC = MODIFIER FOR COMPRESSION DEVELOPMENT = .313

REQUIRED Ld = MODIFIER * BASIC Ld * ACI 318 MODIFIERS (12 in. min.)

DLMT = MODIFIER FOR TENSION DEVELOPMENT = 1.000

DLMC = MODIFIER FOR COMPRESSION DEVELOPMENT = .339

REQUIRED Ld = MODIFIER * BASIC Ld * ACI 318 MODIFIERS (12 in. min.)



TAG TOWERS, LLC
108 FOREST COURT, SUITE 1
RICHMOND, KY 40475
659-544-5000 (P/H)



49030 Pontiac Trail, Suite 100
Wixom, Michigan 48393
PHONE: (248) 705-9212

REV.	DATE	DESCRIPTION
0	11/16/23	ISSUED FOR CONSTRUCTION
B	08/16/23	ISSUED FOR REVIEW
A	08/04/23	DESCRIPTOR



SITE INFORMATION:
LV MT VERNON

EAST
321 FROSTY HOLLOW ROAD
MT VERNON, KY 40456
ROCK CASTLE COUNTY

SITE NUMBER:
721772

SITE NAME:
LV MT VERNON EAST


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CHECKED BY: PL
DATE: 10/25/23
SHEET TITLE:

PSC MAP


SHEET NUMBER:
PSC—1

REV. P&G & CNDY REV 2 FINAL 09/30/23

CITY OF MT VERNON
ROCK CASTLE COUNTY, KENTUCKY
VERIZON WIRELESS SITE LV MT
VERNON EAST
TOWER LOCATION EXHIBIT

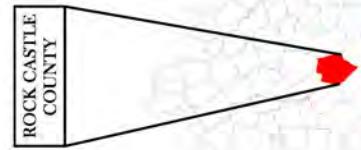

KENTUCKY

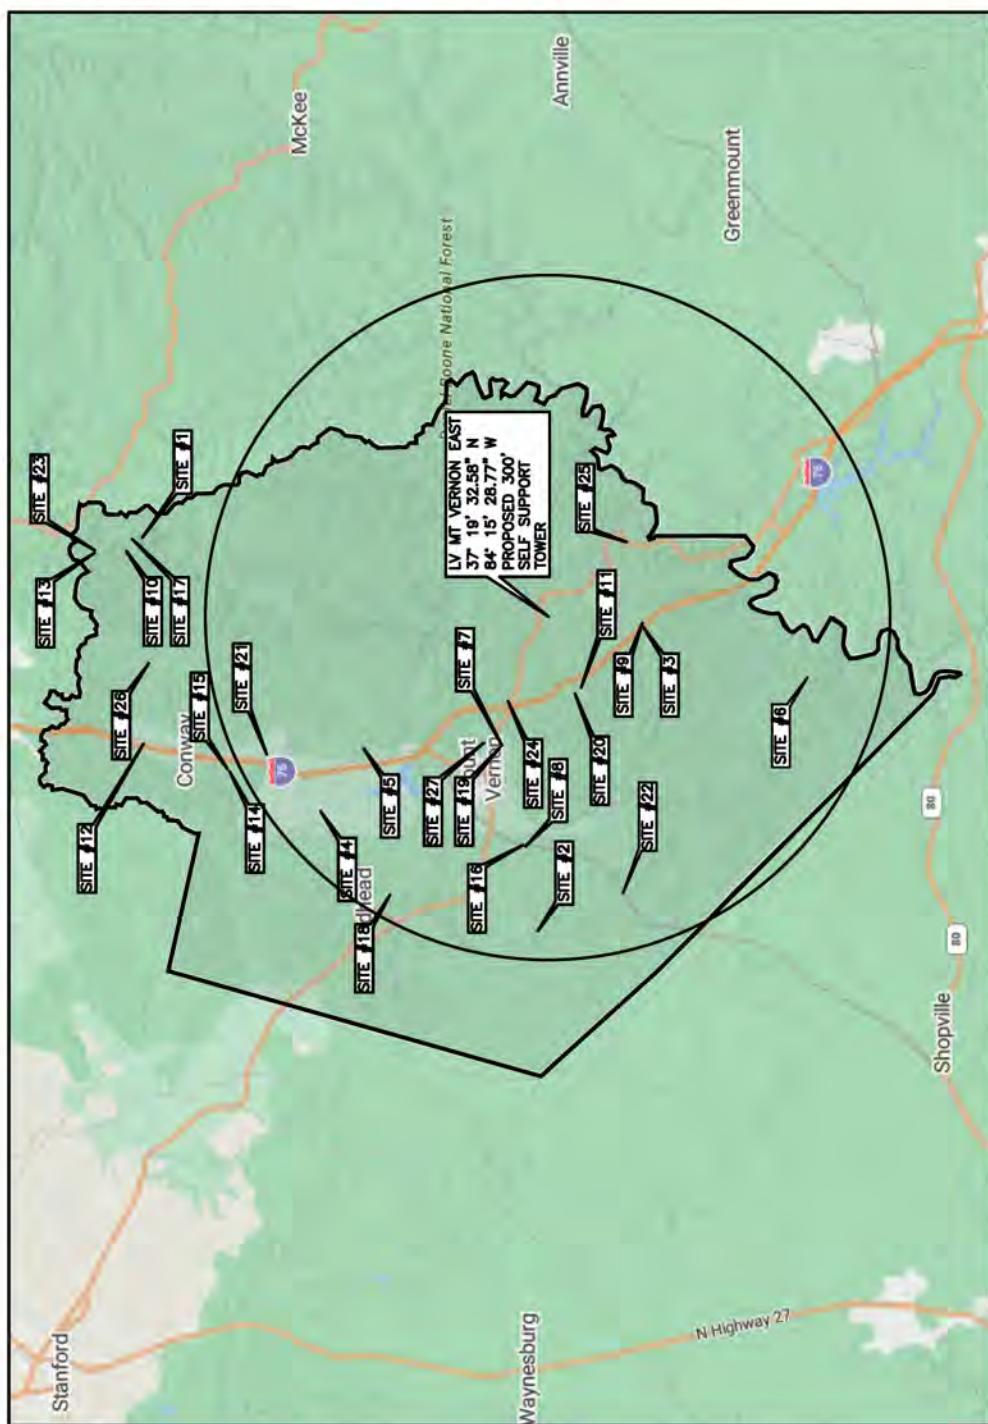

- SITE#1: FCC# 1008337, AMERICAN TOWERS (DELAWARE), INC, LLC 37° 30' 15.0"N, 084° 12' 58.0"W
 SITE#2: FCC# 1042054, BELLSOUTH TELECOMMUNICATIONS, INC, LLC 37° 20' 04.1"N, 084° 25' 45.2"W
 SITE#3: FCC# 1042208, GLOBAL TOWER, LLC, THROUGHAMERICAN TOWERS, LLC 37° 17' 21.0"N, 084° 15' 52.0"W
 SITE#4: FCC# 1042209, GLOBAL TOWER, LLC, THROUGHAMERICAN TOWERS, LLC 37° 25'40.0"N, 084° 21' 52.0"W
 SITE#5: FCC# 1043626, CELLULAR PHONE OF KENTUCKY, INC, LLC 37° 24' 34.0"N, 084° 19' 48.0"W
 SITE#6: FCC# 1043627, CELLULAR PHONE OF KENTUCKY, LLC 37° 13' 06.3"N, 084° 17' 30.8"W
 SITE#7: FCC# 1044617, KENTUCKY UTILITIES COMPANY, LLC 37° 21' 00.0"N, 084° 19' 43.0"W
 SITE#8: FCC# 1044811, KENTUCKY, COMMONWEALTH OF DBA, LLC 37° 20' 23.7"N, 084° 22' 59.2"W
 SITE#9: FCC# 1047745, HUFF, ETHEL DBA = WYGE FM, LLC 37° 17' 22.0"N, 084° 15' 46.0"W
 SITE#10: FCC# 1056243, VOICE, VIDEO, & DATA SERVICES INC, LLC 37° 30' 38.0"N, 084° 13' 20.0"W
 SITE#11: FCC# 1204260, CROWN COMMUNICATIONS, LLC 37° 18' 57.1"N, 084° 17' 49.7"W
 SITE#12: FCC# 1204267, CROWN COMMUNICATIONS, LLC 37° 30' 14.0"N, 084° 19' 39.5"W
 SITE#13: FCC# 1307089, MADISON, COUNTY OF, LLC 37° 31' 37.3"N, 084° 13' 26.7"W
 SITE#14: FCC# 1228218, AMERICAN TOWER THROUGHUNISITE, INC, LLC 37° 28' 01.7"N, 084° 20' 33.4"W
 SITE#15: FCC# 1228349, AMERICAN TOWER THROUGHUNISITE, INC, LLC 37° 28' 01.7"N, 084° 20' 33.4"W
 SITE#16: FCC# 1230621, SBA INFRASTRUCTURES, LLC 37° 20' 26.7"N, 084° 22' 57.7"W
 SITE#17: FCC# 1235662, LONDON RADIO SERVICE, INC, LLC 37° 30' 32.3"N, 084° 13' 00.7"W
 SITE#18: FCC# 1242831, SBA 2012 TC ASSETS, LLC, 37° 23' 53.4"N, 084° 24' 34.0"W
 SITE#19: FCC# 1242832, SBA 2012 TC ASSETS, LLC, 37° 21' 02.1"N, 084° 19' 46.3"W
 SITE#20: FCC# 1246941, CELLO PARTNERSHIP LLC, 37° 19' 06.0"N, 084° 18' 01.7"W
 SITE#21: FCC# 1246951, CELLO PARTNERSHIP LLC, 37° 27' 00.8"N, 084° 20' 01.8"W
 SITE#22: FCC# 1260232, SBA TOWERS III LLC, 37° 17' 52.7"N, 084° 24' 31.1"W
 SITE#23: FCC# 1269019, MADISON COUNTY EMERGENCY MANAGEMENT AGENCY, 37° 31' 37.4"N, 084° 13° 22.6"W
 SITE#24: FCC# 1274515, LONDON RADIO SERVICE, INC, 37° 20' 46.6"N, 084° 18' 16.6"W
 SITE#25: FCC# 1299205, ENGLE-VERNON, 37° 17' 46.8"N, 084° 13' 06.2"W
 SITE#26: FCC# 1309542, ECO-SITE LLC, 37° 30' 05.3"N, 084° 17' 00.8"W
 SITE#27: FCC# 1311778, UNITI TOWERS LLC, 37° 21' 11.7"N, 084° 19' 38.3"W

RURAL CELLULAR
CORP D/B/A

verizon

**Proposed Case for : 2023-ASO-23317-OE****For information only.**

This proposal has not yet been studied. Study outcomes will be posted at a later date.
Public comments are not requested, and will not be considered at this time.

Overview									
Study (ASN): 2023-ASO-23317-OE		Received Date: 07/17/2023							
Prior Study:		Entered Date: 07/17/2023							
Status: Work In Progress		Map: View Map							
Construction Info									
Notice Of: CONSTR		Structure Summary							
Duration: PERM (Months: 0 Days: 0)		Structure Type: Antenna Tower							
Work Schedule:									
Structure Details									
Latitude (NAD 83): 37° 19' 32.58" N Longitude (NAD 83): 84° 15' 28.77" W Datum: NAD 83 City: Mt Vernon State: KY Nearest County: Rockcastle									
Height and Elevation									
Proposed Site Elevation: 1201 Structure Height: 305 Total Height (AMSL): 1506									
Frequencies									
Low Freq	High Freq	Unit	ERP	Unit					
6	7	GHz	55	dBW					
6	7	GHz	42	dBW					
10	11.7	GHz	55	dBW					
10	11.7	GHz	42	dBW					
17.7	19.7	GHz	55	dBW					
17.7	19.7	GHz	42	dBW					
21.2	23.6	GHz	55	dBW					
21.2	23.6	GHz	42	dBW					
614	698	MHz	2000	W					
614	698	MHz	1000	W					
698	806	MHz	1000	W					
806	901	MHz	500	W					
806	824	MHz	500	W					
824	849	MHz	500	W					
851	866	MHz	500	W					
869	894	MHz	500	W					
896	901	MHz	500	W					
901	902	MHz	7	W					
929	932	MHz	3500	W					
930	931	MHz	3500	W					
931	932	MHz	3500	W					
932	932.5	MHz	17	dBW					
935	940	MHz	1000	W					
940	941	MHz	3500	W					
1670	1675	MHz	500	W					
1710	1755	MHz	500	W					
1850	1910	MHz	1640	W					
1850	1990	MHz	1640	W					
1930	1990	MHz	1640	W					
1990	2025	MHz	500	W					
2110	2200	MHz	500	W					
2305	2360	MHz	2000	W					
2305	2310	MHz	2000	W					
2345	2360	MHz	2000	W					
2496	2690	MHz	500	W					
3700	3980	MHz	3280	W					

Previous [Back to
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[Result](#)



Issued Date: 11/01/2023

David Ginter
TAG Towers, LLC
108 Forbes Court
Suite 1
Richmond, KY 40475

**** DETERMINATION OF NO HAZARD TO AIR NAVIGATION ****

The Federal Aviation Administration has conducted an aeronautical study under the provisions of 49 U.S.C., Section 44718 and if applicable Title 14 of the Code of Federal Regulations, part 77, concerning:

Structure:	Antenna Tower Mt. Vernon East			
Location:	Mt Vernon, KY			
Latitude:	37-19-32.58N NAD 83			
Longitude:	84-15-28.77W			
Heights:	<table><tbody><tr><td>1201 feet site elevation (SE)</td></tr><tr><td>305 feet above ground level (AGL)</td></tr><tr><td>1506 feet above mean sea level (AMSL)</td></tr></tbody></table>	1201 feet site elevation (SE)	305 feet above ground level (AGL)	1506 feet above mean sea level (AMSL)
1201 feet site elevation (SE)				
305 feet above ground level (AGL)				
1506 feet above mean sea level (AMSL)				

This aeronautical study revealed that the structure does not exceed obstruction standards and would not be a hazard to air navigation provided the following condition(s), if any, is(are) met:

Emissions from this site must be in compliance with the parameters set by collaboration between the FAA and telecommunications companies and reflected in the FAA 5G C band compatibility evaluation process (such as power, frequencies, and tilt angle). Operational use of this frequency band is not objectionable provided the Wireless Providers (WP) obtain and adhere to the parameters established by the FAA 5G C band compatibility evaluation process. **Failure to comply with this condition will void this determination of no hazard.**

As a condition to this Determination, the structure is to be marked/lighted in accordance with FAA Advisory circular 70/7460-1 M, Obstruction Marking and Lighting, a med-dual system-Chapters 4,8(M-Dual),&15.

Any failure or malfunction that lasts more than thirty (30) minutes and affects a top light or flashing obstruction light, regardless of its position, should be reported immediately to (877) 487-6867 so a Notice to Air Missions (NOTAM) can be issued. As soon as the normal operation is restored, notify the same number.

It is required that FAA Form 7460-2, Notice of Actual Construction or Alteration, be e-filed any time the project is abandoned or:

 At least 10 days prior to start of construction (7460-2, Part 1)
X Within 5 days after the construction reaches its greatest height (7460-2, Part 2)

See attachment for additional condition(s) or information.

This determination expires on 05/01/2025 unless:

- (a) the construction is started (not necessarily completed) and FAA Form 7460-2, Notice of Actual Construction or Alteration, is received by this office.
- (b) extended, revised, or terminated by the issuing office.
- (c) the construction is subject to the licensing authority of the Federal Communications Commission (FCC) and an application for a construction permit has been filed, as required by the FCC, within 6 months of the date of this determination. In such case, the determination expires on the date prescribed by the FCC for completion of construction, or the date the FCC denies the application.

NOTE: REQUEST FOR EXTENSION OF THE EFFECTIVE PERIOD OF THIS DETERMINATION MUST BE E-FILED AT LEAST 15 DAYS PRIOR TO THE EXPIRATION DATE. AFTER RE-EVALUATION OF CURRENT OPERATIONS IN THE AREA OF THE STRUCTURE TO DETERMINE THAT NO SIGNIFICANT AERONAUTICAL CHANGES HAVE OCCURRED, YOUR DETERMINATION MAY BE ELIGIBLE FOR ONE EXTENSION OF THE EFFECTIVE PERIOD.

This determination is based, in part, on the foregoing description which includes specific coordinates, heights, frequency(ies) and power. Any changes in coordinates, heights, and frequencies or use of greater power, except those frequencies specified in the Colo Void Clause Coalition; Antenna System Co-Location; Voluntary Best Practices, will void this determination. Any future construction or alteration, including increase to heights, power, or the addition of other transmitters, requires separate notice to the FAA. This determination includes all previously filed frequencies and power for this structure.

If construction or alteration is dismantled or destroyed, you must submit notice to the FAA within 5 days after the construction or alteration is dismantled or destroyed.

This determination does include temporary construction equipment such as cranes, derricks, etc., which may be used during actual construction of the structure. However, this equipment shall not exceed the overall heights as indicated above. Equipment which has a height greater than the studied structure requires separate notice to the FAA.

This determination concerns the effect of this structure on the safe and efficient use of navigable airspace by aircraft and does not relieve the sponsor of compliance responsibilities relating to any law, ordinance, or regulation of any Federal, State, or local government body.

A copy of this determination will be forwarded to the Federal Communications Commission (FCC) because the structure is subject to their licensing authority.

If we can be of further assistance, please contact our office at (718) 553-2611, or angelique.eersteling@faa.gov. On any future correspondence concerning this matter, please refer to Aeronautical Study Number 2023-ASO-23317-OE.

Signature Control No: 593594700-603475467

Angelique Eersteling
Technician

(DNE)

Attachment(s)
Additional Information
Case Description
Frequency Data
Map(s)

cc: FCC

Additional information for ASN 2023-ASO-23317-OE

BASIS FOR DECISION

Part 77 authorizes the FAA to evaluate a structure or object's potential electromagnetic effects on air navigation, communication facilities, and other surveillance systems. It also authorizes study of impact on arrival, departure, and en route procedures for aircraft operating under visual or instrument flight rules, as well as the impact on airport traffic capacity at existing public use airports. Broadcast in the 3.7 to 3.98 GHz frequency (5G C band) currently causes errors in certain aircraft radio altimeters and the FAA has determined they cannot be relied upon to perform their intended function when experiencing interference from wireless broadband operations in the 5G C band. The FAA has adopted Airworthiness Directives for all transport and commuter category aircraft equipped with radio altimeters that prohibit certain operations when in the presence of 5G C band

This determination of no hazard is based upon those mitigations implemented by the FAA and operators of transport and commuter category aircraft, and helicopters operating in the vicinity of your proposed location. It is also based on telecommunication industry and FAA collaboration on acceptable power levels and other parameters as reflected in the FAA 5G C band evaluation process.

The FAA 5G C band compatibility evaluation is a data analytics system used by FAA to evaluate operational hazards related to aircraft design. The FAA 5G C band compatibility evaluation process refers to the process in which the telecommunication companies and the FAA have set parameters, such as power output, locations, frequencies, and tilt angles for antenna that mitigate the hazard to aviation. As the telecommunication companies and FAA refine the tools and methodology, the allowable frequencies and power levels may change in the FAA 5G C band compatibility evaluation process. Therefore, your proposal will not have a substantial adverse effect on the safe and efficient use of the navigable airspace by aircraft provided the equipment and emissions are in compliance with the parameters established through the FAA 5G C band compatibility evaluation process.

Any future changes that are not consistent with the parameters listed in the FAA 5G C band compatibility evaluation process will void this determination of no hazard.


Case Description for ASN 2023-ASO-23317-OE

Wireless telecom Self-support tower


Frequency Data for ASN 2023-ASO-23317-OE

LOW FREQUENCY	HIGH FREQUENCY	FREQUENCY UNIT	ERP	ERP UNIT
6	7	GHz	55	dBW
6	7	GHz	42	dBW
10	11.7	GHz	55	dBW
10	11.7	GHz	42	dBW
17.7	19.7	GHz	55	dBW
17.7	19.7	GHz	42	dBW
21.2	23.6	GHz	55	dBW
21.2	23.6	GHz	42	dBW
614	698	MHz	2000	W
614	698	MHz	1000	W
698	806	MHz	1000	W
806	901	MHz	500	W
806	824	MHz	500	W
824	849	MHz	500	W
851	866	MHz	500	W
869	894	MHz	500	W
896	901	MHz	500	W
901	902	MHz	7	W
929	932	MHz	3500	W
930	931	MHz	3500	W
931	932	MHz	3500	W
932	932.5	MHz	17	dBW
935	940	MHz	1000	W
940	941	MHz	3500	W
1670	1675	MHz	500	W
1710	1755	MHz	500	W
1850	1910	MHz	1640	W
1850	1990	MHz	1640	W
1930	1990	MHz	1640	W
1990	2025	MHz	500	W
2110	2200	MHz	500	W
2305	2360	MHz	2000	W
2305	2310	MHz	2000	W
2345	2360	MHz	2000	W
2496	2690	MHz	500	W
3700	3980	MHz	3280	W

TOPO Map for ASN 2023-ASO-23317-OE

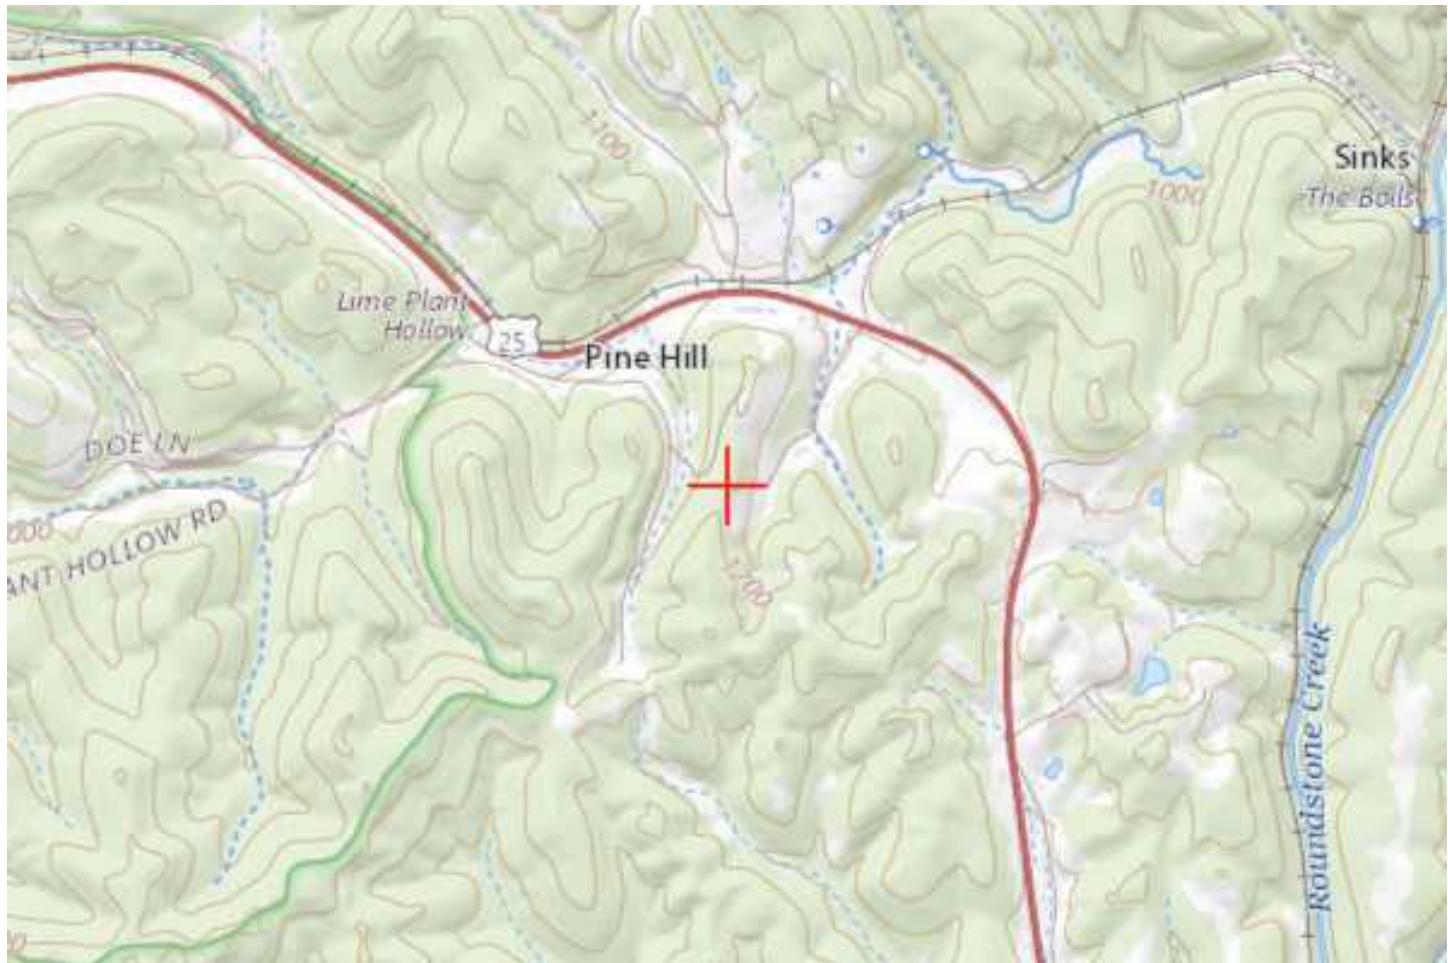

Sectional Map for ASN 2023-ASO-23317-OE

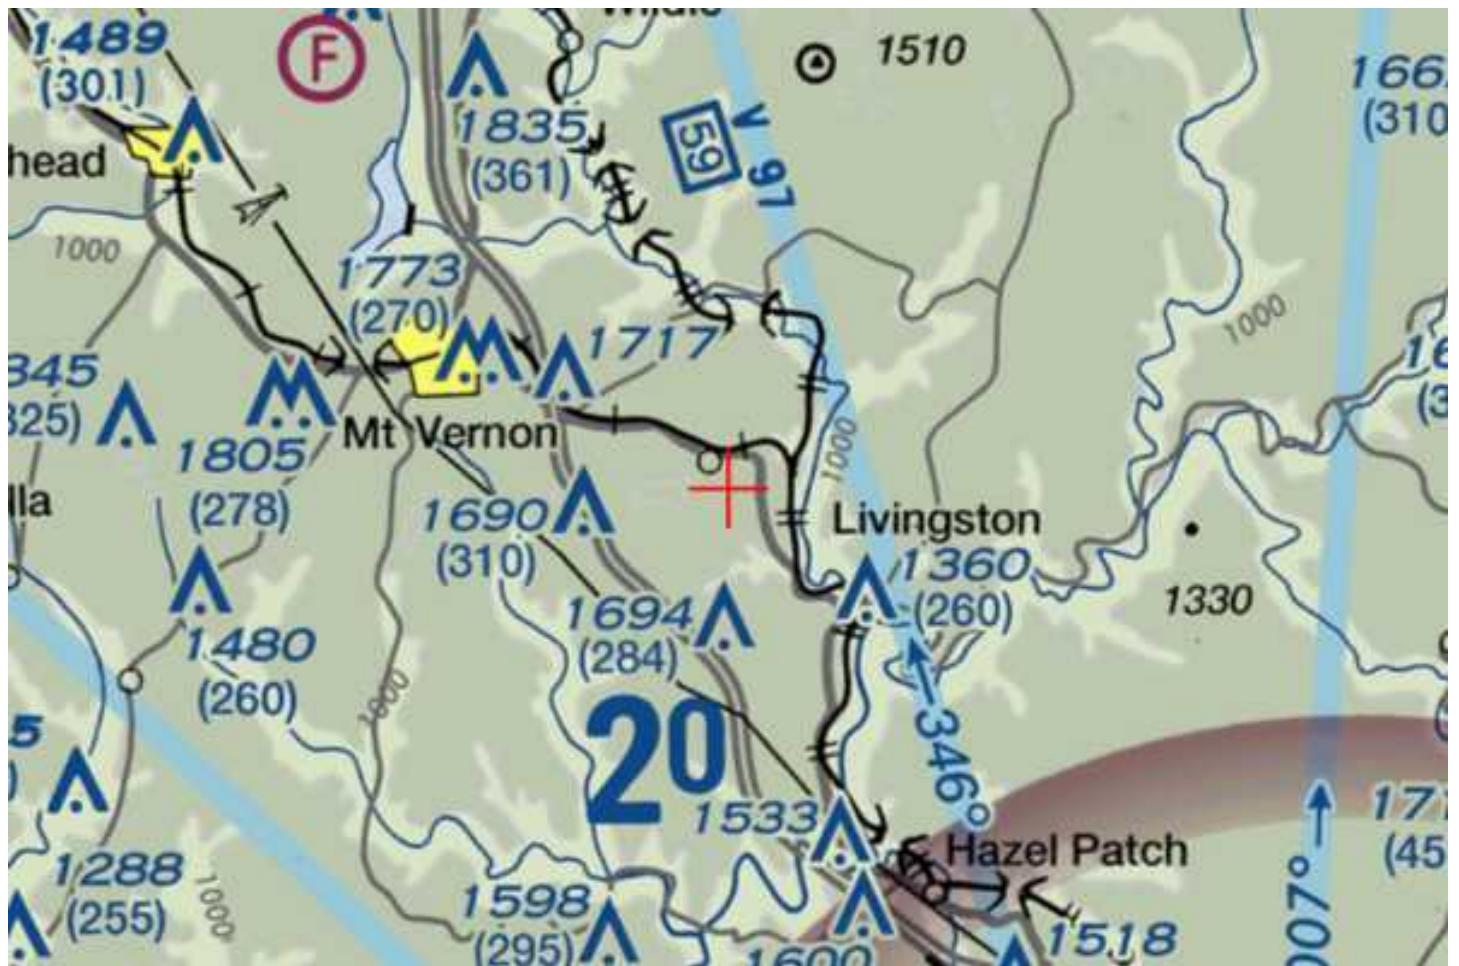



KENTUCKY TRANSPORTATION CABINET

KENTUCKY AIRPORT ZONING COMMISSION

TC 55-2

Rev. 06/2020

Page 2 of 2

APPLICATION FOR PERMIT TO CONSTRUCT OR ALTER A STRUCTURE

APPLICANT (name) TAG Towers, LLC	PHONE 859.544.5000	FAX N/A	KY AERONAUTICAL STUDY #
ADDRESS (street) 108 Forbes Court, Ste 1	CITY Richmond	STATE KY	ZIP 40475
APPLICANT'S REPRESENTATIVE (name) David Ginter	PHONE 859.544.5000	FAX N/A	
ADDRESS (street) 108 FOrbes Court, Ste 1	CITY Richmond	STATE KY	ZIP 40475
APPLICATION FOR <input checked="" type="checkbox"/> New Construction <input type="checkbox"/> Alteration <input type="checkbox"/> Existing	WORK SCHEDULE		
DURATION <input type="checkbox"/> Permanent <input type="checkbox"/> Temporary (months days)	Start 1/12/24 End 3/29/24		
TYPE <input type="checkbox"/> Crane <input type="checkbox"/> Building <input checked="" type="checkbox"/> Antenna Tower <input type="checkbox"/> Power Line <input type="checkbox"/> Water Tank <input type="checkbox"/> Landfill <input type="checkbox"/> Other	MARKING/PAINTING/LIGHTING PREFERRED <input type="checkbox"/> Red Lights & Paint <input type="checkbox"/> White- medium intensity <input type="checkbox"/> White- high intensity <input checked="" type="checkbox"/> Dual- red & medium intensity white <input type="checkbox"/> Dual- red & high intensity white <input type="checkbox"/> Other		
LATITUDE 37°19'32.58"	LONGITUDE 84°15'28.77"	DATUM <input checked="" type="checkbox"/> NAD83 <input type="checkbox"/> NAD27 <input type="checkbox"/> Other	
NEAREST KENTUCKY City Mt Vernon County Rockcastle	NEAREST KENTUCKY PUBLIC USE OR MILITARY AIRPORT Madison Co Airport		
SITE ELEVATION (AMSL, feet) 1201	TOTAL STRUCTURE HEIGHT (AGL, feet) 305	CURRENT (FAA aeronautical study #) 2023-ASO-23317-OE	
OVERALL HEIGHT (site elevation plus total structure height, feet) 1506	PREVIOUS (FAA aeronautical study #) N/A		
DISTANCE (from nearest Kentucky public use or Military airport to structure) 21 Miles Approximately	PREVIOUS (KY aeronautical study #) N/A		
DIRECTION (from nearest Kentucky public use or Military airport to structure) South			
DESCRIPTION OF LOCATION (Attach USGS 7.5 minute quadrangle map or an airport layout drawing with the precise site marked and any certified survey.) Off of State Rt 25, Frosty Hollow Road			
DESCRIPTION OF PROPOSAL Proposed telecommunications tower			
FAA Form 7460-1 (Has the "Notice of Construction or Alteration" been filed with the Federal Aviation Administration?) <input checked="" type="checkbox"/> No <input type="checkbox"/> Yes, when?			
CERTIFICATION (I hereby certify that all the above entries, made by me, are true, complete, and correct to the best of my knowledge and belief.)			
PENALTIES (Persons failing to comply with KRS 183.861 to 183.990 and 602 KAR 050 are liable for fines and/or imprisonment as set forth in KRS 183.990(3). Noncompliance with FAA regulations may result in further penalties.)			
NAME David Ginter	TITLE Manager	SIGNATURE 	DATE 8/23/23
COMMISSION ACTION	<input type="checkbox"/> Chairperson, KAZC <input type="checkbox"/> Administrator, KAZC		
<input type="checkbox"/> Approved <input type="checkbox"/> Disapproved	SIGNATURE	DATE	



KENTUCKY AIRPORT ZONING COMMISSION

ANDY BESHEAR
Governor

Department of Aviation, 90 Airport Road
Frankfort, KY 40601
www.transportation.ky.gov
502-564-0151

JIM GRAY
Secretary

APPROVAL OF APPLICATION

Friday, November 3, 2023

TAG Towers, LLC
108 Forbes Court, Ste 1
Richmond. KY 40475

AS-2023-061-RGA **Central Kentucky Regional**
APPLICANTS NAME: TAG Towers, LLC
NEAREST CITY: MT Vernon, KY
LATITUDE/LONGITUDE: 37°19'32.58" N, 84°15'28.77" W
HEIGHT (In Feet): 305' AGL/1506' AMSL
CONSTRUCTION PROPOSED: 305' Telecommunication Tower.

NOTES: The proposed tower is approx 21 nm S of RGA and penetrates no protected air surfaces.

FAA DETERMINATION: 2023-ASO-23317-OE. No Hazard No Impact to Air Navigation. Must comply with the FAA 5G C band compatibility. Must be marked and lighted IAW FAA AC 70/7460-1M, med-dual system- Chapters 4,8 (M-Dual),&15.

This letter is to notify you that the Kentucky Airport Zoning Commission approved your permit application for the construction of Structures at the Location, Coordinates, and Height as indicated above. Construction must comply with requirements, if any, listed in the FAA Determination.

This permit is valid for a period of 18 Month(s) from its date of issuance. If construction is not completed within said 18-Month period, this permit shall lapse and be void, and no work shall be performed without the issuance of a new permit.

An email of this letter was also sent to your representative, David Ginter, dginter@tagtowers.com. If you have any questions, please contact us.

Respectfully,
Anthony Adams

Airport Zoning Commission Administrator
KY Department of Aviation
502-564-0151 Office
AirportZoning@ky.gov

GEOTECHNICAL REPORT OF SUBSURFACE INVESTIGATION


September 13, 2023

PROPOSED SELF SUPPORT TOWER MT VERNON EAST 721772

Frosty Hollow Road
Mt. Vermon, KY 40456

37.3257, -84.2579

Prepared by:

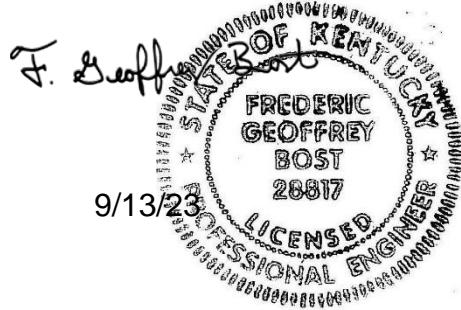

Jorge Varela

Jorge Varela, P.E.
Geotechnical Engineer

Frederic G. Bost, P.E.
Registered KY 28817

Project Summary

Item	Description
Project Description	A geotechnical exploration and report have been prepared for this proposed self-supported tower. Included in this report are the results of the field exploration and the recommendations for the design of the foundation system.
Site Coordinates	Latitude: 37.3257 Longitude: -84.2579
Site Condition	The proposed tower will be installed at Frosty Hollow Road in Mt. Vernon, Kentucky.
Frost Depth	Based on the TIA Standard (TIA-222-H), dated October 2017, the recommended design frost penetration depth to be used for Rockcastle County, KY is 20 inches (1.6 ft).
Groundwater	Subsurface groundwater was not encountered at the time of drilling. Please note that subsurface water levels will fluctuate with seasonal and cyclical temperatures and precipitation and can be higher or lower at other times.
Proposed Foundation	We assume the proposed foundation will be supported with either pad and pier or drilled shaft (caisson).

Field Exploration

Item	Description
Date	September 8 th , 2023
Number of Borings	1
Location	Latitude: 37.3257 Longitude: -84.2579
Equipment Used	CME 45
Advancement Method	Hollow Stem Auger (HSA) and Rock Coring
Sampling Method	ASTM D-1586 with 1.5 I.D. Split Spoon Sampler ASTM D2113 Standard Practice for Rock Core Drilling and Sampling of Rock for Site Exploration

Laboratory Classification and Testing

Standard	Description
ASTM D2488	Standard Practice for Description and Identification of Soils

Subsurface Profile

Based on the results of our borings, the soils beneath the surface can be summarized in the table below:

Material Encountered	Approximate Depth to Bottom of Stratum	Description	Consistency / Density
CLAY	9	Red and tan sandy lean clay	Stiff to Hard
SILSTONE	12	Moderately weathered and fractured	--
SANDSTONE	19	Moderately weathered and fractured	--

Detailed descriptions of conditions encountered at each exploration point are indicated on the individual logs in the Appendix B. Stratification boundaries on the boring logs represent the approximate location of changes in soil types; in-situ, the transition between materials may be gradual.

Groundwater was not encountered at the time of drilling. Groundwater levels will fluctuate with seasonal and climatic changes and may be different at other times.

Earthwork Recommendations – Equipment Mat

Earthwork is anticipated to include excavations and fill placement. The following sections provide recommendations for use in the preparation of the equipment mat foundation area and access drive.

Site Preparation

The subgrade should be evaluated under the direction of the Geotechnical Engineer. Areas where soft material are present or excessively wet or dry material should either be removed, or moisture conditioned and recompacted.

Fill Material Types

Soil Type	USCS Classification	Acceptable Parameters (for Structural Fill)
Imported Low- to Moderate- Plasticity Soil ²	CL, ML, SC or SM	All locations and elevations
Sand / Gravel with greater than 12% fines	GW/GP, SW/SP	Crushed stone base course may be used for the access roadway or beneath shallow foundations as a replacement material for overexcavated soils.
Near-Surface On-site soils ²	CL	On-site soils generally appear suitable for use as fill when they contain at least 12% fines (clay and/or silt) and are compacted at an appropriate moisture content.

1. Controlled, compacted fill should consist of approved materials that are free of organic matter and debris. A sample of each material type should be submitted to the geotechnical engineer for evaluation.

2. Low- to moderate-plasticity cohesive soil or granular soil having at least 12% fines

Fill Compaction Requirements

Item	Structural Fill	General Fill
Maximum Lift Thickness	8 inches or less in loose thickness when heavy, self-propelled compaction equipment is used	Same as Structural fill
Minimum Compaction Requirements ^{1,2}	98% of max. below foundations and within 1 foot of finished pavement subgrade 95% of max. above foundations, below floor slabs, and more than 1 foot below finished pavement subgrade	92% of max.
Water Content Range ¹	Low plasticity cohesive: -2% to +3% of optimum High plasticity cohesive: 0 to +4% of optimum Granular: -3% to +3% of optimum	As required to achieve min. compaction requirements

1. Maximum density and optimum water content as determined by the standard Proctor test (ASTM D 698).

2. High plasticity cohesive fill should not be compacted to more than 100% of standard Proctor maximum dry density.

Excavations

Groundwater was not encountered at the time of drilling. Although not expected, if encountered in deep trench excavations during construction, groundwater or perched groundwater will require dewatering until backfilling operations are complete.

All excavations that may be required should, at a minimum, comply with applicable local, state and federal safety regulations, including the current OSHA Excavation and Trench Safety Standards to provide stability and safe working conditions.

Slopes

For permanent slopes in unreinforced compacted fill areas, we recommended maximum configurations of 3:1 (Horizontal: Vertical) for the cohesive soils (clay) found at the site.

If steeper slopes are required for site development, stability analyses should be completed to design the grading plan. The face of all slopes should be compacted to the minimum specification for fill embankments. Fill slopes should be overbuilt and trimmed to compacted material.

Earthwork Construction Considerations

The near-surface, on-site soils will lose strength when exposed to moisture. To the extent practical, earthwork should be performed during drier periods of weather. Increased remedial measures due to wet and soft or otherwise unsuitable conditions should be expected if earthwork is performed during colder and wetter periods of weather.

A qualified geotechnical engineer should be retained during the earthwork phase of the project to observe earthwork and to perform necessary tests and observations during subgrade preparation; to monitor proof-rolling, placement and compaction of controlled compacted fills, and backfilling of excavations to the completed subgrade.

Foundations Recommendations

The following recommendations are made based on our review of the test boring data and our past experience with similar projects and subsurface conditions. Ultimate soil strength parameters are presented on table below.

Ultimate Strength Parameters

Boring #	Depth (ft)	Unified Soil Classification	Total Unit Weight (pcf)	Friction Angle (degrees)	Cohesion (psf)
B-1	0.0 – 1.5	CL	115	--	1,100
	1.5 – 3.0	CL	115	--	2,900
	3.0 – 6.0	CL	115	--	4,500
	6.0 – 9.0	CL	115	--	4,000
	9.0 – 19.0	BEDROCK	145	45	--

1. Groundwater was not encountered.

Based on the subsurface conditions and typical design foundation loads for similar self-support towers, we recommend that either a caisson (drilled shaft) or a pad/pier be used to support the new tower.

Modulus of Subgrade Reaction

A vertical and horizontal modulus of subgrade reaction may be derived using the following equations and soils parameters expressed in the above table:

$$k_{s-v} = 12 \cdot SF \cdot q_a$$

$$k_{s-h} = k_{s-v} \cdot B$$

Where:

q_a = Allowable Bearing Capacity (ksf)

SF = Safety Factor

B = Base width (ft), use 1 if $B < 1\text{ft}$

k_{s-v} = Vertical Modulus of Subgrade Reaction (kcf)

k_{s-h} = Horizontal Modulus of Subgrade Reaction (ksf)

Caisson (Drilled Shaft)

Should caissons (drilled shafts) be used, the caissons (drilled shafts) will achieve compressive (downward) and tensile (uplift) resistance through skin friction along the sides of the shafts. In addition to skin friction, bearing resistance at the caisson's tip will contribute to compressive capacity. We recommend the values given the table below be used for this project. Please note the tip bearing capacity and skin frictions are net ultimate and ultimate values respectively. Appropriate factors of safety or resistance factors should be used. Lateral loads can be resisted by the lateral stiffness of the soil. Parameters for analysis of the laterally loaded caisson are also given the table below.

Caisson (Drilled Shaft) Parameters

Depth (ft)	Net Ultimate Tip Bearing Capacity (ksf)	Ultimate Skin Friction ¹ (ksf)		Lateral Modulus (pci)	ϵ_{50} (in/in)
		Compressive	Uplift		
0.0 – 1.5	--	--	--	--	--
1.5 – 3.0	--	1.5	1.5	1,000	0.005
3.0 – 6.0	--	2.3	2.3	1,000	0.005
6.0 – 9.0	36	2.0	2.0	2,000	0.004
9.0 – 19.0	40	1.3	1.3	225	--

1. We recommend the skin friction be ignored for the top 3 ft of the caisson

Based on the subsurface soil conditions, excavations for the caissons (drilled shafts) should be possible using a large, truck-mounted, hydraulic-advanced drill rig. All debris, loose or disturbed soil should be removed from the excavation prior to placing reinforced steel and/or concrete. Reinforcing steel and/or concrete should be placed immediately upon completion of the excavation.

The excavations may be susceptible to caving. Drilling fluid or casing could be used to assist in keeping the drilled hole open. If casing is used, we recommend it be removed from the excavation as concrete is being placed. Continuous vibration or other approved methods should be used during casing withdrawal to reduce the potential for void-space formation within the concrete. If water is present during concrete placement and/or drilling fluids are used to maintain hole stability,

concrete should be pumped or otherwise discharged to the bottom of the hole via a hose or tremie pipe. The end of the hose or tremie pipe must remain below the top surface of any water, drilling fluid and the in-place concrete at all times. Additionally, concrete should be consolidated using vibration methods over the entire length and width of the caissons and the consolidation should be performed only after these fluids are removed and to the extent possible.

Pad & Pier / Single Mat Foundation

If the site has been prepared in accordance with the requirements noted in *Earthwork Recommendations – Equipment Mat*, the tower's foundation capacity can be determined using the soil's bearing capacity, passive pressure resistance, and a sliding friction factor.

Net Ultimate Bearing Capacity and Sliding Friction Factor

Depth² (ft)	Net Ultimate Bearing Capacity¹ (psf)	Sliding Friction Factor¹
0.0 – 2.0	--	--
2.0 – 4.0	11,500	0.30
4.0 – 9.0	14,300	

1. This value is a net ultimate value and an appropriate factor of safety or resistance factor should be used

Ultimate Passive Pressure and Friction Factor

Boring #	Depth (ft)	Ultimate Passive Pressure ¹ (psf) ¹
B-1	0.0 – 2.0	0 – 400
	2.0 – 4.0	400 – 800
	4.0 – 9.0	800 – 1,800
	9.0 – 12.0	1,800 – 4,200

1. Ultimate passive pressure can be interpolated for foundation depths with the depth ranges given

Seismic Parameters

The seismic design requirements for buildings and other structures are based on Seismic Design Category. Site Classification is required to determine the Seismic Design Category for a structure. The Site Classification is based on the upper 100 feet of the site profile defined by a weighted average value of either shear wave velocity, standard penetration resistance, or undrained shear strength in accordance with Section 20.4 of ASCE 7 and the International Building Code (IBC)

Seismic Site Classification

Item	Seismic Parameter
2018 International Building Code Seismic Site Classification	C ¹
Design Spectral Response Acceleration Parameters	$S_{ds} = 0.175g$ $S_{d1} = 0.087g$

1. The IBC seismic site classification is based on the subsurface profile depth of 100 feet. The scope of work did not authorize exploration to a depth of 100 feet. A seismic Site Soil Classification of D should be used if insufficient details are known about the 100-foot soil profile.

LIMITATIONS OF REPORT


This report has been prepared in accordance with generally accepted geotechnical engineering practices for the specific application of this project. The conclusions in this report are based on the applicable standards of our practice in this geographic area at the time this report was prepared. No other warranty, expressed or implied, is made.

The analyses and conclusions submitted herein are based, in part, upon the data obtained from the subsurface exploration performed for this analysis. The soil and ground water conditions can vary across the site. Opinions and conclusions are subject to change if new or additional information is submitted for review.

**APPENDIX A
LOCATION INFORMATION**

SITE LOCATION PLAN
MT VERNON EAST (721772)
Job Number: 23121213

September 13, 2023

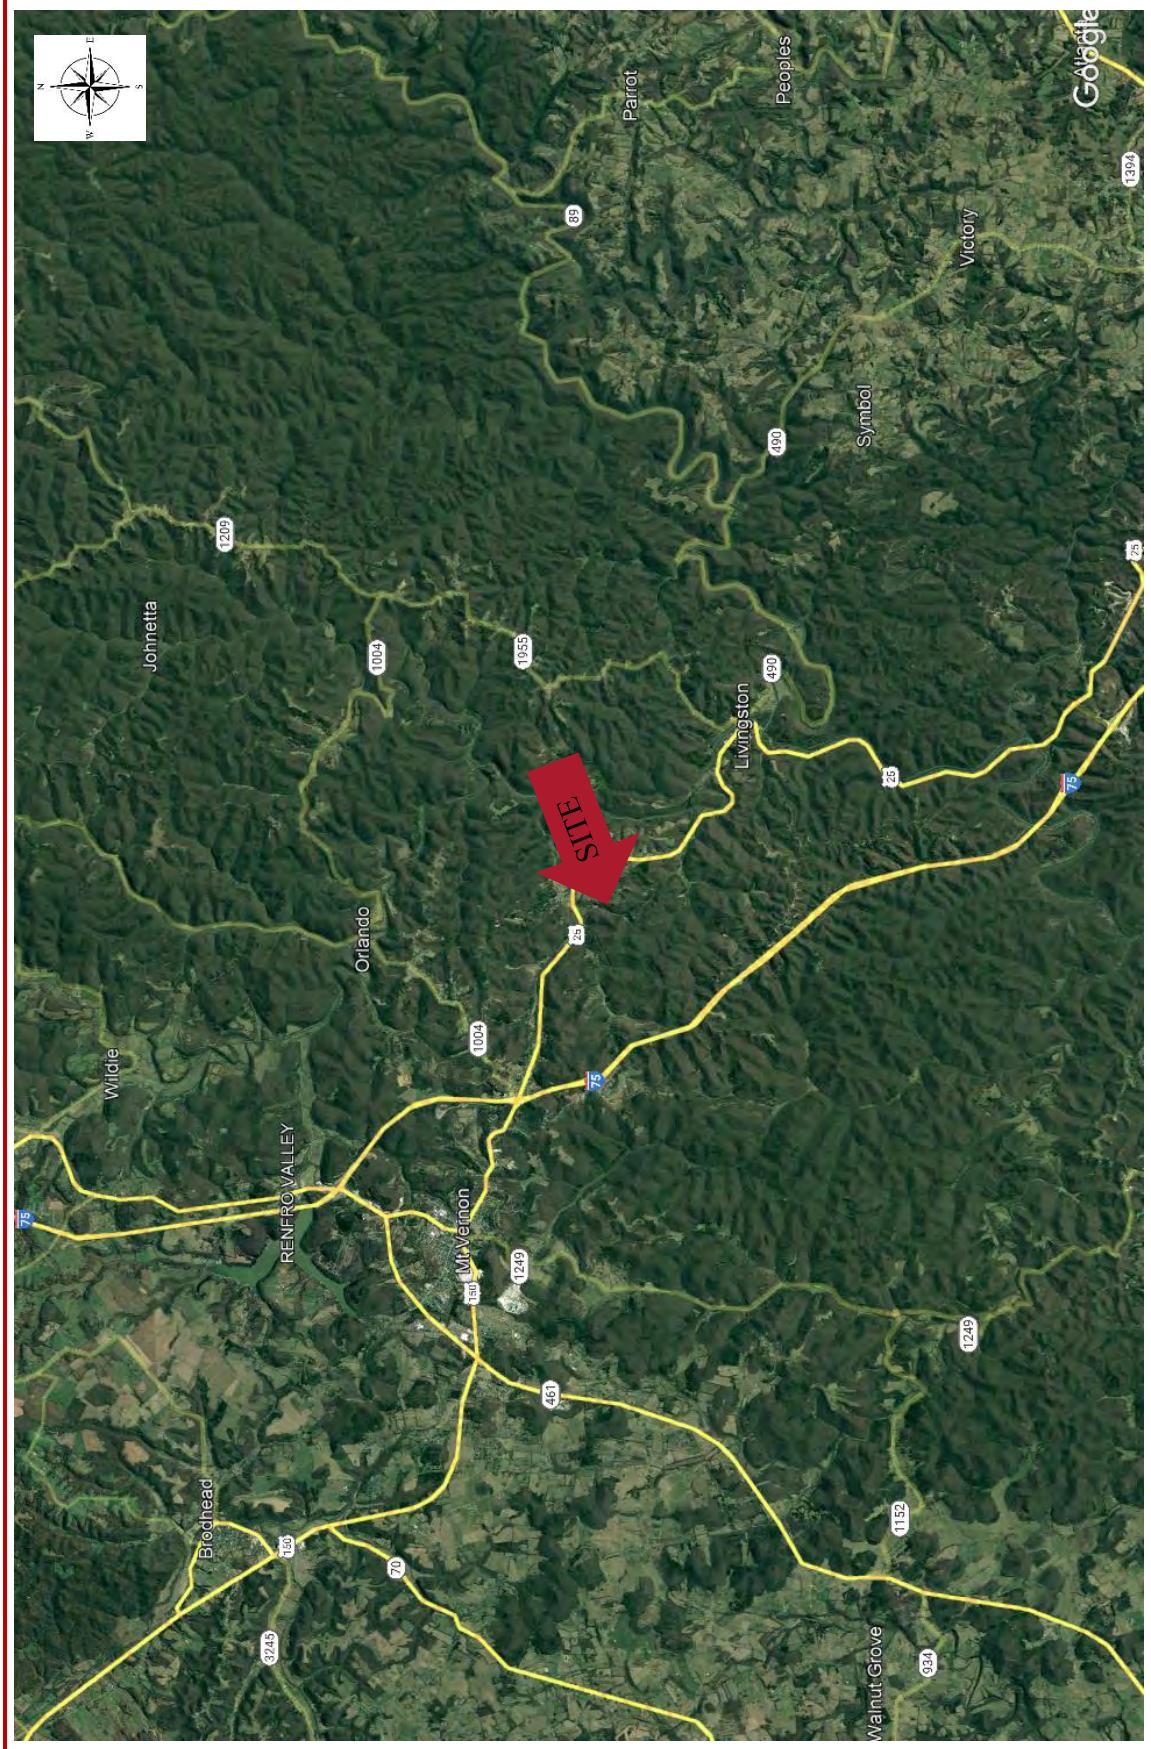

Engineered Tower Solutions, PLLC - 3227 Wellington Court - Raleigh, NC 27615
(919) 782-2710

BORING LOCATION PLAN
MT VERNON EAST (721772)
Job Number: 23121213

September 13, 2023



Engineered Tower Solutions, PLLC - 3227 Wellington Court - Raleigh, NC 27615
(919) 782-2710

SITE PHOTO

September 13, 2023

MT VERNON EAST (721772)

Job Number: 23121213



APPENDIX B
SOIL TEST BORING



BORING NUMBER B-1

PAGE 1 OF 1

CLIENT EBI Consulting
PROJECT NUMBER 23121213
DATE 9/8/2023
DRILLING METHOD Hollow Stem Auger (HSA) and Rock Coring
DRILLING EQUIPMENT CME 45
LOGGED BY J. Varela
NOTES

PROJECT NAME MT VERNON EAST (721772)

PROJECT LOCATION Frosty Hollow Rd, Mt. Vernon, KY 40456

COORDINATES 37.325717, -84.257992

GROUND WATER LEVELS:

AT TIME OF DRILLING --- Not Encountered

AT END OF DRILLING --- Not Encountered

AFTER DRILLING --- Not Encountered

DEPTH (ft)	GRAPHIC LOG	MATERIAL DESCRIPTION	SAMPLE TYPE NUMBER	RECOVERY % (RQD)	BLOW COUNTS (N VALUE)
0		<u>SANDY LEAN CLAY (CL)</u> , red and tan, moist, stiff.	SS 1		7-5-6 (11)
5		<u>SANDY LEAN CLAY (CL)</u> , red and tan, moist, very stiff to hard.	SS 2		9-15-14 (29)
9.0			SS 3		9-26-20 (46)
9.0			SS 4		8-17-23 (40)
10		<u>SILTSTONE</u> , moderately weathered and fractured. Auger Refusal at 9.0 feet.	RC 1	98 (15)	
15		<u>SANDSTONE</u> , moderately weathered and fractured.	RC 2	95 (45)	

Bottom of borehole at 19.0 feet.

DIRECTIONS TO THE SITE

FROM: 205 EAST MAIN STREET, MOUNT VERNON, KY 40456; HEAD EAST ON KY-1326 / EAST MAIN STREET TOWARD SPRING STREET, 0.3 MILE, KEEP STRAIGHT TO GET ONTO US-150 EAST / US-25 SOUTH / SOUTH WILDERNESS DRIVE, 4.5 MILE, TURN RIGHT ONTO PINE HILL CIRCLE, 0.1 MILE, TAKE A SHARP LEFT ONTO FROSTY HOLLOW ROAD, 0.4 MILE, ARRIVE AT 321 FROSTY HOLLOW ROAD, MOUNT VERNON, KY 40456

LAB ARCHITECTS, (248) 705-9212

This instrument prepared by:

David L. Ginter

After recording please return to:

TAG Towers LLC

Attention: David L. Ginter

Attention: Real Estate Department

108 Forbes Court

Richmond, Kentucky 40475

Memorandum of Land Lease Agreement

Site Name: Mt. Vernon East

Site I.D.: KY-2004

This Memorandum of Land Lease Agreement provides record notice of that Land Lease Agreement dated JULY 7th 2023 ("Agreement") by and between CLYDE RAYMOND COLLINS AND MAGDALENE COLLINS, husband and wife (the "Owner") and TAG Towers LLC, a Delaware limited liability company ("Lessee"), the terms and conditions of which are incorporated herein by reference.

Such Agreement provides in part that Owner leases to Lessee a portion of that land and property located in the Commonwealth of Kentucky, County of Rockcastle, commonly known as Parcel 074-00-002, Map Number 073SW-00-016.02, legally described in that document recorded in Deed Book 247, Page 341 in the Office of the County Clerk, Rockcastle County, Kentucky and located at 321 Frosty Hollow Road, Mt. Vernon, Kentucky and more particularly described on Exhibit A, together with non-exclusive easements for ingress, egress, regress, access and utilities, for an initial term of five (5) years, commencing on the date of the Agreement, which term is subject to ten (10) additional five (5) year extension periods by Lessee.

Further, the Agreement further grants to Lessee a right of first refusal, as more particularly set forth therein, to purchase or acquire, by easement, assignment or otherwise, the Owners interest in the Agreement or the real property subject to the terms of the Agreement.

**THE REMAINDER OF THIS PAGE IS INTENTIONALLY BLANK
SIGNATURE PAGES FOLLOW**

IN WITNESS WHEREOF, the parties have executed the Memorandum as of the day and year first above written.

OWNER: CLYDE RAYMOND COLLINS AND MAGDALENE COLLINS, husband and wife

Name: Clyde R. Collins

Title: Clyde Raymond Collins

Date: 6/15/23

Name: Magdalene Collins

Title: Magdalene Collins

Date: 6/15/23

OWNER ACKNOWLEDGMENT:

COMMONWEALTH OF KENTUCKY

COUNTY OF Rockcastle

The foregoing instrument was acknowledged before me this 15th day of June, 2023 by Clyde Raymond Collins and Magdalene Collins, husband and wife, who, being duly authorized to execute this instrument, so executed the instrument as his/her voluntary act and deed. He/She/They is/are personally known to me or has produced Drivers License as identification.

My Commission Number: KYN1P36133

Wanda Coffey
Notary Public

My Commission Expires: 9/7/25

Wanda Coffey
Printed Name



Wanda Coffey

LESSEE: TAG Towers LLC, a Delaware limited liability company

By:

Name: David L. Ginter, President
Title: President
Date: 7/7/23

LESSEE ACKNOWLEDGMENT:

COMMONWEALTH OF KENTUCKY
COUNTY OF MADISON

The foregoing instrument was acknowledged before me this 7 day of July, 2023, by David L. Ginter, the President of TAG Towers LLC, a Delaware limited liability company (Lessee), for and on behalf of the company. He is personally known to me or has produced _____ as identification.

My Commission Number: 11282

Richard L Pennington
Notary Public

My Commission Expires: July 23 2024

Richard L Pennington
Printed Name

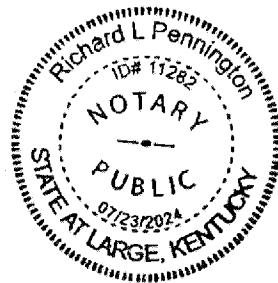


EXHIBIT A
Site Agreement - Site Description – Permitted Exceptions

Site Agreement - Site Description – Permitted Exceptions

Site Name: Mt. Vernon East **Site I.D.:** KY-2004

That land and property located in the Commonwealth of Kentucky, County of Rockcastle, commonly known as Parcel 074-00-002, Map Number 073SW-00-016.02, legally described in that document recorded in Deed Book 247, Page 341 in the Office of the County Clerk, Rockcastle County, Kentucky and located at 321 Frosty Hollow Road, Mt. Vernon, Kentucky

Site Sketch

Candidate: Rhonda Lunsford
Address: 321 Frosty Hollow Road Mt. Vernon, KY 40456
Lat / Long: 37 325833 . -84 258056
Zoning Jurisdiction: Rock Castle County KY Zoning Classification: None
Ordinance Dictated Setbacks: None
Airport: Mt. Vernon Outland Airport


(Drawing not to scale / Tower and compound lease area measurements and placement subject to adjustment)



STATE OF KENTUCKY
COUNTY OF ROCKCASTLE, Sct.
I, Danetta Ford Allen, Clerk of Rockcastle
County Court, do certify that the foregoing
LEASE was on 07/11/2023 lodged in my
office for record, and that it has been duly
recorded in my said office, together with this
and the certificate thereon endorsed.

Given under my hand.

Danetta Ford Allen, CLERK

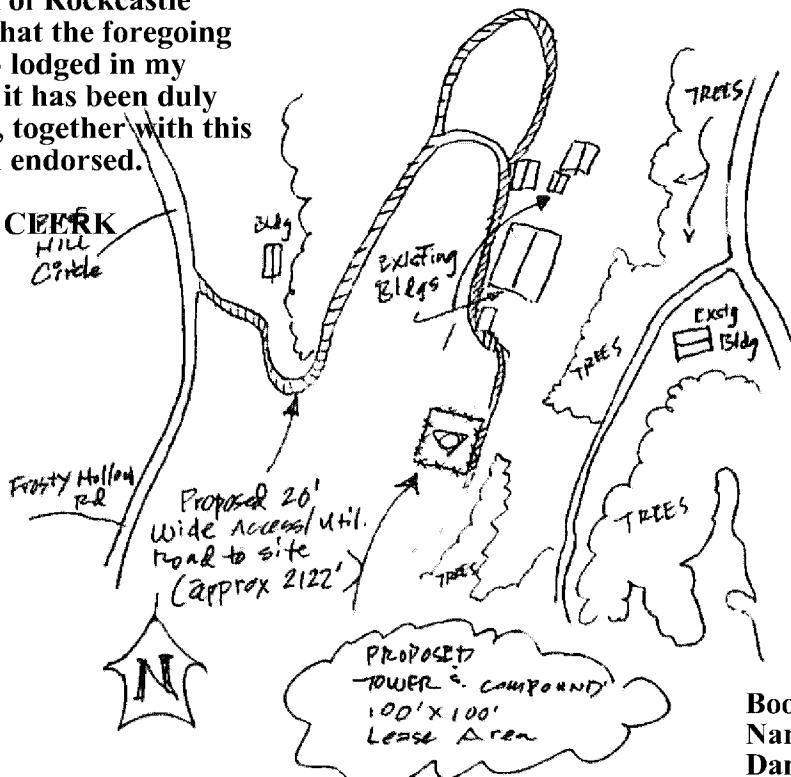

Raymond Lunsford Prop. Parcel

PID. no 074-00-002

site address - 321 Frosty Hollow Road Mt. Vernon, KY 40456

Book: 26 Pages: 29-32 (4)

Name: LEASE

Danetta Ford Allen
ROCKCASTLE COUNTY

07/11/2023



387435

Permitted Exceptions: None.

Mt. VERNON KY
NSB - VZW

Note: Owner and Lessee may, at Lessee's option, replace this Exhibit with an exhibit setting forth the legal description of the property on which the Site is located and/or a more detailed survey or drawing depicting the Site.

Parcel Number 074-00-002
 COLLINS CLYDE R & MAGDALINE
 317 FROSTY HOLLOW RD
 MT VERNON, KY 40456

 qPublic.net™ Rockcastle County, KY PVA

Layers Map Search Results Report Sales Search Sales List Sales Results Tax Estimator

Elizabeth Williams Search search...

Summary

Parcel Number	074-00-002
Account Number	4769
Location Address	CARDINAL HOLLOW 242
Description	69 ACRES
(Note: Not to be used on legal documents)	
Class	Farm
Tax District	00.00
Rate Per Thousand	8.278.0000

[View Map](#)

Owner

Primary Owner	COLLINS CLYDE R & MAGDALINE
	317 FROSTY HOLLOW RD
	MT VERNON, KY 40456

Land Characteristics

Valuation

Sale Information

Sale Date	Sale Price	Sale Type	Book-Page	Grantee	Grantor
6/1/1994	\$0	Partial Sales	154-282	COLLINS CLYDE R & MAGDALINE	ALLEN EBB

Parcel Number 073SW-00-016.02
 LUNSFORD RHONDA K
 321 FROSTY HOLLOW RD
 MT VERNON, KY 40456

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Layers Map Search Results Report Sales Search Sales List Sales Results Tax Estimator

Elizabeth Williams Search search...

Summary

Parcel Number	073SW-00-016.02
Account Number	2160
Location Address	FROSTY HOLLOW RD 321
Description	HOUSE & LOT
(Note: Not to be used on legal documents)	
Class	Residential
Tax District	00.00
Rate Per Thousand	8.278.0000

[View Map](#)

Owner

Primary Owner	LUNSFORD RHONDA K
	321 FROSTY HOLLOW RD
	MT VERNON, KY 40456

Land Characteristics

Valuation

Improvement Information

Sale Information

Sale Date	Sale Price	Sale Type	Book-Page	Grantee	Grantor
3/1/2014	\$0	Partial Sales	247-341	LUNSFORD RHONDA K.	STEVE LUNSFORD
3/1/2014	\$0	Partial Sales	-	STEVE LUNSFORD	STEVE LUNSFORD
3/1/2014	\$0	Partial Sales	-	STEVE LUNSFORD	STEVE LUNSFORD

Parcel Number 073SW-00-032.04

COLLINS CLYDE R & MAGDALENE
317 FROSTY HOLLOW RD
MT VERNON, KY 40456

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Elizabeth Williams Search search... 

Layers Map Search Results Report Sales Search Sales List Sales Results Tax Estimator

Summary

Parcel Number	073SW-00-032.04
Account Number	4770
Location Address	FROSTY HOLLOW RD @ PINE HIL 317
Description	10 ACRES & DW HOME <small>(Note: Not to be used on legal documents)</small>
Class	Farm
Tax District	00 00
Rate Per Thousand	8.278.0000

[View Map](#)

Owner

Primary Owner
COLLINS CLYDE R & MAGDALENE
317 FROSTY HOLLOW RD
MT VERNON, KY 40456

Land Characteristics

Valuation

Sale Information

Sale Date	Sale Price	Sale Type	Book-Page	Grantee	Grantor
3/1/1988	\$0	153-483		COLLINS CLYDE R & MAGDALENE	GEORGE & IRENE COLLINS

Recent Sales In Area

Sale date range:
From: 11/15/2020 To: 11/15/2023 

Information


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Parcel Number 073SW-00-016

[COLLINS CLYDE R](#)
317 FROSTY HOLLOW RD
MT VERNON, KY 40456

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Layers Map Search Results Report Sales Search Sales List Sales Results Tax Estimator

Summary

Parcel Number	073SW-00-016
Account Number	4781
Location Address	FROSTY HOLLOW RD @ PINE HIL 317
Description	10 ACRES & DW HOME <small>(Note: Not to be used on legal documents)</small>
Class	Farm
Tax District	00 00
Rate Per Thousand	8.278.0000

[View Map](#)

Owner

Primary Owner
COLLINS CLYDE R
317 FROSTY HOLLOW RD
MT VERNON, KY 40456

Land Characteristics

Valuation

Improvement Information

Sale Information

Sale Date	Sale Price	Sale Type	Book-Page	Grantee	Grantor
1/1/2000	\$0	—	—	COLLINS CLYDE R	—

Information


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Parcel Number 073SW-00-027
 COLLINS KENNETH B & TAWANA
 PO BOX 1907
 MT VERNON, KY 40456

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Layers Map Search Results Report Sales Search Sales List Sales Results Tax Estimator

Summary

Parcel Number	073SW-00-027
Account Number	4732
Location Address	5 WILDERNESS RD 5038
Description	20 ACRES & HOUSE <small>(Note: Not to be used on legal documents)</small>
Class	Farm
Tax District	00 00
Rate Per Thousand	8,278.0000

[View Map](#)

Owner

Primary Owner
 COLLINS KENNETH B & TAWANA
 PO BOX 1907
 MT VERNON, KY 40456

Land Characteristics

Valuation

Improvement Information

Sale Information

Sale Date	Sale Price	Sale Type	Book-Page	Grantee	Grantor
10/14/2022	\$210,000	Close Relative Sale	285-163	COLLINS KENNETH B & TAWANA	COLLINS ADAM
3/1/2010	\$72,000	Arms-Length Transaction	229-638	COLLINS ADAM	BURDINE KEVIN
10/1/2008	\$56,500	Arms-Length Transaction	-	BURDINE KEVIN	MILLER THOMAS A &

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Parcel Number 073SW-00-026
 MARTIN ALEX & MELISSA
 2744 JOHNSON RD
 LONDON, KY 40741

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Layers Map Search Results Report Sales Search Sales List Sales Results Tax Estimator

Summary

Parcel Number	073SW-00-026
Account Number	3582
Location Address	5 WILDERNESS RD 4912
Description	5 1/2 ACRES <small>(Note: Not to be used on legal documents)</small>
Class	Residential
Tax District	00 00
Rate Per Thousand	8,278.0000

[View Map](#)

Owner

Primary Owner
 MARTIN ALEX & MELISSA
 2744 JOHNSON RD
 LONDON, KY 40741


Land Characteristics

Valuation

Sale Information

Sale Date	Sale Price	Sale Type	Book-Page	Grantee	Grantor
3/22/2022	\$0	Close Relative Sale	285-242	MARTIN ALEX & MELISSA	MARTIN PATRICIA
11/10/2016	\$40,000	Multiple Parcels	250-408	MARTIN PATRICIA	BURDINE JACKIE & BARBARA
12/1/2011	\$20,000	Arms-Length Transaction	237-381	BURDINE JACKIE & BARBARA	LUCAS EDWARD W & DEBORAH
7/1/2004	\$92,000	Arms-Length Transaction	200-455	LUCAS EDWARD W & DEBORAH	BILL & HAZEL PARKER

Information

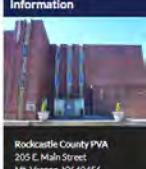

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Parcel Number 073SW-00-014
RICHARDSON PHYLLIS
174 FROSTY HOLLOW RD
MT VERNON, KY 40456

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Layers
Map
Search
Results
Report
Sales Search
Sales List
Sales Results
Tax Estimator

□ **Summary**

Parcel Number	073SW-00-014
Account Number	11488
Location Address	FROSTY HOLLOW RD 174
Description	LOT & MOBILE HOME
(Note: Not to be used on legal documents)	
Class	Residential
Tax District	00 00
Rate Per Thousand	8.278.0000

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□ **Information**



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□ **Owner**

Primary Owner
RICHARDSON PHYLLIS
174 FROSTY HOLLOW RD
MT VERNON, KY 40456

□ **Land Characteristics**

□ **Valuation**

□ **Improvement Information**

□ **Sale Information**

Sale Date	Sale Price	Sale Type	Book-Page	Grantee	Grantor	Columns
10/1/2005	\$5,800	Arms-Length Transaction	207-490	RICHARDSON PHYLLIS	VIRGIL BUSTLE	<input type="button" value="▼"/>

Parcel Number 073SW-00-014.02
HUNT CARLTON
P O BOX 3190
MT VERNON, KY 40456

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Layers
Map
Search
Results
Report
Sales Search
Sales List
Sales Results
Tax Estimator

□ **Summary**

Parcel Number	073SW-00-014.02
Account Number	2617
Location Address	FROSTY HOLLOW RD 0
Description	1 ACRE
(Note: Not to be used on legal documents)	
Class	Residential
Tax District	00 00
Rate Per Thousand	8.278.0000

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□ **Owner**

Primary Owner
HUNT CARLTON
P O BOX 3190
MT VERNON, KY 40456

□ **Land Characteristics**

□ **Valuation**

□ **Sale Information**

Sale Date	Sale Price	Sale Type	Book-Page	Grantee	Grantor	Columns
3/1/2006	\$1,000	Arms-Length Transaction	209-650	HUNT CARLTON	RENNER MACK & JIMMIE LOU	<input type="button" value="▼"/>
3/1/2006	\$1,000	Arms-Length Transaction	-	RENNER MACK & JIMMIE LOU	RENNER MACK & JIMMIE LOU	<input type="button" value="▼"/>
3/1/2006	\$1,000	Arms-Length Transaction	-	RENNER MACK & JIMMIE LOU	RENNER MACK & JIMMIE LOU	<input type="button" value="▼"/>
2/1/1988	\$0	-	-	RENNER MACK & JIMMIE LOU	STEVE MILBURN	<input type="button" value="▼"/>
2/1/1988	\$0	-	-	STEVE MILBURN	STEVE MILBURN	<input type="button" value="▼"/>

Parcel Number 073SW-00-014.01

HUNT CARLTON

P O BOX 3190

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Elizabeth Williams Search search...

Summary

Parcel Number	073SW-00-014.01
Account Number	2617
Location Address	FROSTY HOLLOW RD 230
Description	LOT
(Note: Not to be used on legal documents)	
Class	Residential
Tax District	00 00
Rate Per Thousand	8.278.0000

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Owner

Primary Owner	HUNT CARLTON
P O BOX 3190	
MT VERNON, KY 40456	

Land Characteristics

Valuation

Sale Information

Sale Date	Sale Price	Sale Type	Book-Page	Grantee	Grantor
3/1/2006	\$2,000	Arms-Length Transaction	209-650	HUNT CARLTON	RENNER MACK & JIMMIE LOU
3/1/2006	\$2,000	Arms-Length Transaction	-	RENNER MACK & JIMMIE LOU	RENNER MACK & JIMMIE LOU
3/1/2006	\$2,000	Arms-Length Transaction	-	RENNER MACK & JIMMIE LOU	RENNER MACK & JIMMIE LOU
1/1/2000	\$0	-	-	RENNER MACK & JIMMIE LOU	TOM RENNER
1/1/2000	\$0	-	-	TOM RENNER	TOM RENNER

Information



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Parcel Number 074-00-032.01

HUNT CARLTON

P O BOX 3190

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Elizabeth Williams Search search...

Summary

Parcel Number	074-00-032.01
Account Number	2617
Location Address	FROSTY HOLLOW RD 230
Description	8 ACRES S. HOUSE
(Note: Not to be used on legal documents)	
Class	Residential
Tax District	00 00
Rate Per Thousand	8,278.0000

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Owner

Primary Owner	HUNT CARLTON
P O BOX 3190	
MT VERNON, KY 40456	

Land Characteristics

Valuation

Improvement Information

Sale Information

Sale Date	Sale Price	Sale Type	Book-Page	Grantee	Grantor
3/1/2006	\$79,500	Arms-Length Transaction	209-650	HUNT CARLTON	RENNER MACK & JIMMIE LOU
3/1/2006	\$79,500	Arms-Length Transaction	-	RENNER MACK & JIMMIE LOU	RENNER MACK & JIMMIE LOU
3/1/2006	\$79,500	Arms-Length Transaction	-	RENNER MACK & JIMMIE LOU	RENNER MACK & JIMMIE LOU
11/1/1978	\$0	-	-	ERNEST CROMER	ERNEST CROMER
11/1/1978	\$0	-	-	ERNEST CROMER	ERNEST CROMER

Information



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Parcel Number 073SW-00-016.01

LAWS DAVID & REGINA

315 FROSTY HOLLOW RD

MT VERNON, KY 40456

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Layers Map Search Results Report Sales Search Sales List Sales Results Tax Estimator

Elizabeth Williams Search search...

Summary

Parcel Number	073SW-00-016.01
Account Number	1747
Location Address	FROSTY HOLLOW RD 315
Description	HOMESTEAD & LOT <small>(Note: Not to be used on legal documents)</small>
Class	Residential
Tax District	00.00
Rate Per Thousand	8.278.0000

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Owner

Primary Owner
LAWS DAVID & REGINA
315 FROSTY HOLLOW RD
MT VERNON, KY 40456

Land Characteristics

Valuation

Improvement Information

Sale Information

Sale Date	Sale Price	Sale Type	Book/Page	Grantee	Grantor
10/1/2014	\$92,000	Construction/Destruction	249-509	LAWS DAVID & REGINA	COLLINS DARRELL & CLOIA G
10/1/2014	\$92,000	Construction/Destruction	-	COLLINS DARRELL & CLOIA G	COLLINS DARRELL & CLOIA G
10/1/2014	\$92,000	Construction/Destruction	-	COLLINS DARRELL & CLOIA G	COLLINS DARRELL & CLOIA G
3/1/1999	\$1,000	Partial Sales	-	COLLINS DARRELL & CLOIA G	CLYDE & MAGDALENE
3/1/1999	\$1,000	Partial Sales	-	CLYDE & MAGDALENE	CLYDE & MAGDALENE

Information



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Parcel Number 073SW-00-015.01

CROMER THOMAS LEE

385 FROSTY HOLLOW RD

MT VERNON, KY 40456

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Elizabeth Williams Search search...

Summary

Parcel Number	073SW-00-015.01
Account Number	4593
Location Address	FROSTY HOLLOW RD 385
Description	LOT & MH <small>(Note: Not to be used on legal documents)</small>
Class	Residential
Tax District	00.00
Rate Per Thousand	8.278.0000

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Owner

Primary Owner
CROMER THOMAS LEE
385 FROSTY HOLLOW RD
MT VERNON, KY 40456

Land Characteristics

Valuation

Improvement Information

Sale Information

Sale Date	Sale Price	Sale Type	Book/Page	Grantee	Grantor
10/1/2013	\$1,500	Partial Sales	245-505	ESTILL & BETTY CROMER	ESTILL & BETTY CROMER
10/1/2013	\$1,500	Partial Sales	-	CROMER THOMAS LEE	ESTILL & BETTY CROMER

Information



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Parcel Number 074-00-030
BULLOCK LARRY & DONNA
639 FROSTY HOLLOW ROAD
MT VERNON, KY 40456

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Elizabeth Williams Search search...

Summary

Parcel Number	074-00-030
Account Number	8425
Location Address	FROSTY HOLLOW ROAD 603
Description	HOUSE & 17 ACRES
(Note: Not to be used on legal documents)	
Class	Farm
Tax District	00 00
Rate Per Thousand	8.278.000

[View Map](#)

Owner

Primary Owner
BULLOCK LARRY & DONNA
639 FROSTY HOLLOW ROAD
MT VERNON, KY 40456

Land Characteristics

Valuation

Improvement Information

Sale Information

Sale Date	Sale Price	Sale Type	Book-Page	Grantee	Grantor
10/28/2016	\$58,000	Partial Sales	258-134	BULLOCK LARRY & DONNA	GATLIFF DOROTHY HEIRS
	\$n		91-115	GATLIFF DOROTHY HEIRS	GATLIFF DOROTHY HEIRS

Information



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Parcel Number 074-00-028
BUSTLE VIRGIL HEIRS
C/O DONNA BULLOCK
639 FROSTY HOLLOW RD
MT VERNON, KY 40456

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Layers Map Search Results Report Sales Search Sales List Sales Results Tax Estimator

Elizabeth Williams Search search...

Summary

Parcel Number	074-00-028
Account Number	12397
Location Address	FROSTY HOLLOW RD 750
Description	24.5 ACRES & HOUSES
(Note: Not to be used on legal documents)	
Class	Farm
Tax District	00 00
Rate Per Thousand	8.278.000

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Owner

Primary Owner
BUSTLE VIRGIL HEIRS
C/O DONNA BULLOCK
639 FROSTY HOLLOW RD
MT VERNON, KY 40456

Land Characteristics

Valuation

Improvement Information

Sale Information

Sale Date	Sale Price	Sale Type	Book-Page	Grantee	Grantor
3/22/2023	\$0	Close Relative Sale	090-089	BUSTLE VIRGIL HEIRS	BUSTLE VIRGIL
4/4/1970	\$0		90-89	BUSTLE VIRGIL	PAYNE ROBERT LEE et ux

Information



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Parcel Number 074-00-023.03

COLLINS CLYDE RAYMOND &

MAGDALENE

317 FROSTY HOLLOW RD

MT VERNON, KY 40456

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Summary

Parcel Number	074-00-023.03
Account Number	4768
Location Address	FROSTY HOLLOW RD 0
Description	2 ACRES <small>(Note: Not to be used on legal documents)</small>
Class	Residential
Tax District	00.00
Rate Per Thousand	8.278.0000

[View Map](#)

Owner

Primary Owner
COLLINS CLYDE RAYMOND &
MAGDALENE
317 FROSTY HOLLOW RD
MT VERNON, KY 40456

Land Characteristics

Valuation

Sale Information

Sale Date	Sale Price	Sale Type	Book-Page	Grantee	Grantor
2/1/2006	\$2,500	Partial Sales	210-215	COLLINS CLYDE RAYMOND &	DONNIE & CAROLYN COLLINS
2/1/2006	\$2,500	Partial Sales	-	DONNIE & CAROLYN COLLINS	DONNIE & CAROLYN COLLINS
2/1/2006	\$2,500	Partial Sales	-	DONNIE & CAROLYN COLLINS	DONNIE & CAROLYN COLLINS

Information



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Parcel ID - 074-00-023

POYNTER DAVID & YOLANDA

6254 S WILDERNESS RD

MT VERNON, KY 40456

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Summary

Parcel Number	074-00-023 & ETC
Account Number	9508
Location Address	S WILDERNESS RD 6254
Description	HOUSE & 254 ACRES <small>(Note: Not to be used on legal documents)</small>
Class	Farm
Tax District	00.00
Rate Per Thousand	8,278.0000

Map Not Available

Owner

Primary Owner
POYNTER DAVID & YOLANDA
6254 S WILDERNESS RD
MT VERNON, KY 40456

Land Characteristics

Valuation

Improvement Information

Sale Information

Sale Date	Sale Price	Sale Type	Book-Page	Grantee	Grantor
7/1/2012	\$143,000	Multiple Parcels	240-270	POYNTER DAVID & YOLANDA	GOFORTH SCOTT
7/1/2006	\$0	Partial Sales	211-639	GOFORTH SCOTT	JAMES D GOFORTH

Information



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Parcel Number 073SW-00-037
COLLINS DONNIE & CAROLYN
324 CARDINAL HOLLOW RD
MT VERNON, KY 40456

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Layers Map Search Results Report Sales Search Sales List Sales Results Tax Estimator

Elizabeth Williams Search search...

Summary

Parcel Number	073SW-00-037
Account Number	5800
Location Address	CARDINAL HOLLOW RD 324
Description	HOUSE & LOT & 1 ACRE <small>(Note: Not to be used on legal documents)</small>
Class	Residential
Tax District	00 00
Rate Per Thousand	8,278.0000

[View Map](#)

Owner

Primary Owner
COLLINS DONNIE & CAROLYN
324 CARDINAL HOLLOW RD
MT VERNON, KY 40456

Land Characteristics

Valuation

Improvement Information

Sale Information

Sale Date	Sale Price	Sale Type	Book-Page	Grantee	Grantor
1/1/2000	\$900	Sliding Scale	182-215	COLLINS DONNIE & CAROLYN	GASTON SHIRLEY MARIE
1/1/2000	\$900	Sliding Scale	-	GASTON SHIRLEY MARIE	GASTON SHIRLEY MARIE
1/1/2000	\$900	Sliding Scale	-	GASTON SHIRLEY MARIE	GASTON SHIRLEY MARIE
9/1/1996	\$10,000	Close Relative Sale	-	GASTON SHIRLEY MARIE	FREWITT JUSTIN & A
9/1/1996	\$10,000	Close Relative Sale	-	FREWITT JUSTIN & A	FREWITT JUSTIN & A
1/1/1993	\$10,000	Other	-	EBB BEN & WILLA AL	EBB BEN & WILLA AL
1/1/1993	\$10,000	Other	-	FREWITT JUSTIN & A	EBB BEN & WILLA AL

Information



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Parcel Number 074-00-002.01
ROTH STEPHEN E & KIM D
241 CARDINAL HOLLOW ROAD
MT VERNON, KY 40456

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Layers Map Search Results Report Sales Search Sales List Sales Results Tax Estimator

Elizabeth Williams Search search...

Summary

Parcel Number	074-00-002.01
Account Number	4757
Location Address	CARDINAL HOLLOW RD 241
Description	HOUSE & 2.73 ACRES <small>(Note: Not to be used on legal documents)</small>
Class	Residential
Tax District	00 00
Rate Per Thousand	8,278.0000

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Owner

Primary Owner
ROTH STEPHEN E & KIM D
241 CARDINAL HOLLOW ROAD
MT VERNON, KY 40456

Land Characteristics

Valuation

Improvement Information

Sale Information

Sale Date	Sale Price	Sale Type	Book-Page	Grantee	Grantor
11/2/2020	\$225,500	Arms-Length Transaction	275-107	ROTH STEPHEN E & KIM D	WEAVER MITCHELL
7/12/2019	\$193,000	Arms-Length Transaction	269-480	WEAVER MITCHELL	COLLINS MICHAEL
7/1/2005	\$35,000	Expansion Sale	206-185	COLLINS MICHAEL	HENSLEY EDNA JOLEEN
1/1/1997	\$38,000	Close Relative Sale	-	HENSLEY EDNA JOLEEN	HENSLEY CHARLIE &
6/1/1995	\$20,000	Arms-Length Transaction	-	HENSLEY CHARLIE &	MOORE MAYBELLE S

Information



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Parcel Number 074-00-001
 OAKES KENNETH JR & DORINDA L
 234 CARDINAL HOLLOW RD
 MT VERNON, KY 40456

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Layers Map Search Results Report SalesSearch SalesList SalesResults TaxEstimator

Summary

Parcel Number	074-00-001
Account Number	9290
Location Address	CARDINAL HOLLOW 234
Description	2 ACRES & MOBILE HOME <small>(Note: Not to be used on legal documents.)</small>
Class	Residential
Tax District	0000
Rate Per Thousand	0.270000

[View Map](#)

Owner

Primary Owner:
 OAKES KENNETH JR & DORINDA L
 234 CARDINAL HOLLOW RD
 MT VERNON, KY 40456

Land Characteristics

Valuation

Improvement Information

Sale Information

Sale Date	Sale Price	Sale Type	Book-Page	Grantee	Grantor
4/1/2008	\$31,000	Arms-Length Transaction	221-118	OAKES KENNETH JR & DORINDA L	COLLINS DONALD & CAROLYN
4/1/2008	\$31,000	Arms-Length Transaction	221-118	COLLINS DONALD & CAROLYN	COLLINS DONALD & CAROLYN
2/1/1987	\$0	-	-	COLLINS DONALD & CAROLYN	RATHEL COLLINS

Information



Rockcastle County PVA
 205 E. Main Street
 Mt. Vernon, KY 40456
 Mon-Fri 8:00 a.m. - 4:00 p.m.

PVA
 Kathy Robinson
 606-256-4194

Announcements

How to use the Beacon site - [View Demo Videos](#)

Parcel Number 074-00-002.03
 ALLEN HAYES & TERRY GOFF
 230 CARDINAL HOLLOW RD
 MT VERNON, KY 40456

qPubli Elizabeth Bentz Williams (ewilliams@clarkquinnlaw.com) is signed in

Layers Map Search Results Report SalesSearch SalesList SalesResults TaxEstimator

Summary

Parcel Number	074-00-002.03
Account Number	4100
Location Address	CARDINAL HOLLOW 230
Description	LOT & MOBILE HOME <small>(Note: Not to be used on legal documents.)</small>
Class	Residential
Tax District	0000
Rate Per Thousand	8.278.0000

[View Map](#)

Owner

Primary Owner:
 ALLEN HAYES & TERRY GOFF
 230 CARDINAL HOLLOW RD
 MT VERNON, KY 40456

Land Characteristics


Valuation

Improvement Information

Sale Information

Sale Date	Sale Price	Sale Type	Book-Page	Grantee	Grantor
6/3/1994	\$0	-	154-439	ALLEN HAYES & TERRY GOFF	allen ebb

Information

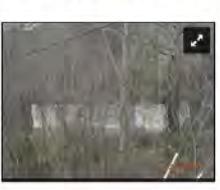

Rockcastle County PVA
 205 E. Main Street
 Mt. Vernon, KY 40456
 Mon-Fri 8:00 a.m. - 4:00 p.m.

PVA
 Kathy Robinson
 606-256-4194

Announcements

How to use the Beacon site - [View Demo Videos](#)

Parcel Number 073SW-00-032.03

COLLINS ADAM G

170 CARDINAL HOLLOW RD

MT VERNON, KY 40456

 qPublic.net™ Rockcastle County, KY PVA

Layers Map Search Results Report Sales Search Sales List Sales Results Tax Estimator

Elizabeth Williams Search search...

Summary

Parcel Number	073SW-00-032.03
Account Number	4731
Location Address	CARDINAL HOLLOW RD 170
Description	3 ACRES <small>(Note: Not to be used on legal documents)</small>
Class	Residential
Tax District	00.00
Rate Per Thousand	8,278.0000

[View Map](#)

Owner

Primary Owner
COLLINS ADAM G
170 CARDINAL HOLLOW RD
MT VERNON, KY 40456


Land Characteristics

Valuation

Sale Information

Sale Date	Sale Price	Sale Type	Book-Page	Grantee	Grantor
7/1/2005	\$7,500	Arms-Length Transaction	206-272	COLLINS ADAM G	WARF PAULINE
6/1/1987	\$0	-	-	WARF PAULINE	GEORGE COLLINS

Information

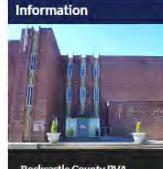

Rockcastle County PVA
205 E. Main Street
Mt. Vernon, KY 40456
Mon-Fri 8:00 a.m. - 4:00 p.m.

PVA
Kathy Robinson
606-256-4194

Announcements

How to use the Beacon site - view [Demo Videos](#)

Parcel Number 073SW-00-031 ETC

COLLINS PATRICIA A & CLIFFORD

REVOCABLE TRUST

5216 S WILDERNESS RD

MT VERNON, KY 40456

 qPublic.net™ Rockcastle County, KY PVA

Layers Map Search Results Report Sales Search Sales List Sales Results Tax Estimator

Elizabeth Williams Search search...

Summary

Parcel Number	073SW-00-031 ETC
Account Number	4754
Location Address	S WILDERNESS RD 5216
Description	HOUSE & 8.5 ACRES <small>(Note: Not to be used on legal documents)</small>
Class	Residential
Tax District	00.00
Rate Per Thousand	8,278.0000

Map Not Available

Owner

Primary Owner
COLLINS PATRICIA A & CLIFFORD
REVOCABLE TRUST
5216 S WILDERNESS RD
MT VERNON, KY 40456

Land Characteristics

Valuation

Improvement Information

Sale Information

Sale Date	Sale Price	Sale Type	Book-Page	Grantee	Grantor
11/1/2008	\$0	-	224-370	COLLINS PATRICIA A & CLIFFORD	COLLINS CLIFFORD & PATRICIA

Information



Rockcastle County PVA
205 E. Main Street
Mt. Vernon, KY 40456
Mon-Fri 8:00 a.m. - 4:00 p.m.

PVA
Kathy Robinson
606-256-4194

Announcements

How to use the Beacon site - view [Demo Videos](#)



Russell L. Brown
Attorney at Law
rbrown@clarkquinnlaw.com

320 N. Meridian St., Ste. 1100
Indianapolis, IN 46204
(317) 637-1321 main
(317) 687-2344 fax


November 17, 2023

**Notice of Proposed Construction of
Wireless Communications Facility
Site Name: Mt Vernon East**

Celco Partnership, d/b/a Verizon Wireless and TAG Towers, LLC is filing an application with the Kentucky Public Service Commission ("PSC") to construct a new wireless communications facility on a site located at 321 Frosty Hollow Road, Mt. Vernon, KY 40456, (North Latitude: (37° 19' 32.58, West Longitude 84° 15' 28.77"). The proposed facility will include a 300-foot tall antenna tower, plus a 4-foot lightning arrestor and related ground facilities. This facility is needed to provide improved coverage for wireless communications in the area.

This notice is being sent to you because the County Property Valuation Administrator's records indicate that you may own property that is within a 500' radius of the proposed tower site or contiguous to the property on which the tower is to be constructed. You have a right to submit testimony to the Kentucky Public Service Commission ("PSC"), either in writing or to request intervention in the PSC's proceedings on the application. You may contact the PSC for additional information concerning this matter at: Kentucky Public Service Commission, Executive Director, 211 Sower Boulevard, P.O. Box 615, Frankfort, Kentucky 40602. Please refer to docket number 2023-00368 in any correspondence sent in connection with this matter.

We have attached a map showing the site location for the proposed tower. Applicant's radio frequency engineers assisted in selecting the proposed site for the facility, and they have determined it is the proper location and elevation needed to provide quality service to wireless customers in the area. Please feel free to contact us at 317-637-1321 if you have any comments or questions about this proposal.

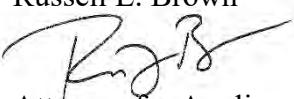Sincerely,
Russell L. Brown

Attorney for Applicant
RLB/mnw
enclosure



VICINITY MAP



LOCATION MAP

Aerial Location Map



ClarkQuinn

Clark, Quinn, Moses, Scott & Grahn, LLP



9589 0710 5270 1623 2614 62

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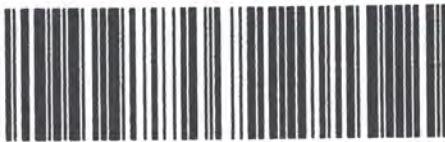


US POSTAGE™ PITNEY BOWES

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02 7H
0006035028 \$ 008.53⁰
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LUNSFORD RHONDA K
321 FROSTY HOLLOW RD
MT VERNON, KY 40456

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Clark, Quinn, Moses, Scott & Grahn, LLP



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PO BOX 1907
MT VERNON, KY 40456

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LONDON, KY 40741

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RICHARDSON PHYLLIS
174 FROSTY HOLLOW RD
MT VERNON, KY 40456

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Clark, Quinn, Moses, Scott & Grahn, LLP

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9589 0710 5270 1623 2615 23

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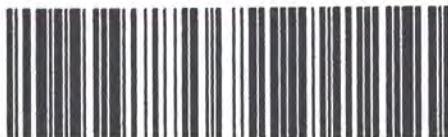


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HUNT CARLTON
P O BOX 3190
MT VERNON, KY 40456

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LAWS DAVID & REGINA
315 FROSTY HOLLOW RD
MT VERNON, KY 40456

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CROMER THOMAS LEE
385 FROSTY HOLLOW RD
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Clark, Quinn, Moses, Scott & Grahn, LLP

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BULLOCK LARRY & DONNA
639 FROSTY HOLLOW ROAD
MT VERNON, KY 40456

CERTIFIED MAIL**ClarkQuinn**
Clark, Quinn, Moses, Scott & Grahn, LLP

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BUSTLE VIRGIL HEIRS
C/O DONNA BULLOCK
639 FROSTY HOLLOW RD
MT VERNON, KY 40456

CERTIFIED MAIL**ClarkQuinn**
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MAGDALENE
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MT VERNON, KY 40456

ClarkQuinn
Clark, Quinn, Moses, Scott & Grahn, LLP

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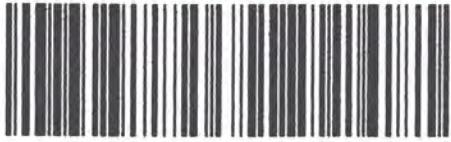


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POYNTER DAVID & YOLANDA
6254 S WILDERNESS RD
MT VERNON, KY 40456

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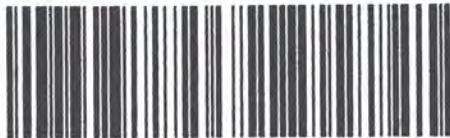


US POSTAGE IM|PITNEY BOWES

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COLLINS DONNIE & CAROLYN
324 CARDINAL HOLLOW RD
MT VERNON, KY 40456

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ROTH STEPHEN E & KIM D
241 CARDINAL HOLLOW ROAD
MT VERNON, KY 40456

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OAKES KENNETH JR & DORINDA L
234 CARDINAL HOLLOW RD
MT VERNON, KY 40456

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9589 0710 5270 1623 2616 22

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ZIP 46204 \$ 008.53⁰
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ALLEN HAYES & TERRY GOFF
230 CARDINAL HOLLOW RD
MT VERNON, KY 40456

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170 CARDINAL HOLLOW RD
MT VERNON, KY 40456

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Clark, Quinn, Moses, Scott & Grahn, LLP



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COLLINS PATRICIA A & CLIFFORD
REVOCABLE TRUST
5216 S WILDERNESS RD
MT VERNON, KY 40456

SENDER: COMPLETE THIS SECTION

- Complete items 1, 2, and 3.
- Print your name and address on the reverse so that we can return the card to you.
- Attach this card to the back of the mailpiece, or on the front if space permits.

1. Article Addressed to:

LUNSFORD RHONDA K
321 FROSTY HOLLOW RD
MT VERNON, KY 40456



9590 9402 8463 3186 7621 43

2. Article Number (Transfer from service label)

9589 0710 5270 1623 2614 79

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Domestic Return Receipt

COMPLETE THIS SECTION ON DELIVERY**A. Signature**

X Magdalene Collins Agent Addressee

B. Received by (Printed Name)

Magdalene Collins C. Date of Deliver

11-24-23

D. Is delivery address different from item 1? Yes
If YES, enter delivery address below: No

3. Service Type

- Adult Signature
- Adult Signature Restricted Delivery
- Certified Mail®
- Certified Mail Restricted Delivery
- Collect on Delivery
- Collect on Delivery Restricted Delivery

- Priority Mail Express®
- Registered Mail™
- Registered Mail Restricted Delivery
- Signature Confirmation
- Signature Confirmation Restricted Delivery

SENDER: COMPLETE THIS SECTION

- Complete items 1, 2, and 3.
- Print your name and address on the reverse so that we can return the card to you.
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1. Article Addressed to:

COLLINS CLYDE R & MAGDALINE
317 FROSTY HOLLOW RD
MT VERNON, KY 40456



9590 9402 8463 3186 7621 50

2. Article Number (Transfer from service label)

9589 0710 5270 1623 2614 62

PS Form 3811, July 2020 PSN 7530-02-000-9053

COMPLETE THIS SECTION ON DELIVERY**A. Signature**

X Magdalene Collins Agent Addressee

B. Received by (Printed Name)

Magdalene Collins C. Date of Deliver

11-24-23

D. Is delivery address different from item 1? Yes
If YES, enter delivery address below: No

3. Service Type

- Adult Signature
- Adult Signature Restricted Delivery
- Certified Mail®
- Certified Mail Restricted Delivery
- Collect on Delivery
- Collect on Delivery Restricted Delivery

- Priority Mail Express®
- Registered Mail™
- Registered Mail Restricted Delivery
- Signature Confirmation
- Signature Confirmation Restricted Delivery

SENDER: COMPLETE THIS SECTION

- Complete items 1, 2, and 3.
- Print your name and address on the reverse so that we can return the card to you.
- Attach this card to the back of the mailpiece, or on the front if space permits.

1. Article Addressed to:

COLLINS CLYDE R
317 FROSTY HOLLOW RD
MT VERNON, KY 40456



9590 9402 8463 3186 7621 36

2. Article Number (Transfer from service label)

9589 0710 5270 1623 2614 86

PS Form 3811, July 2020 PSN 7530-02-000-9053

COMPLETE THIS SECTION ON DELIVERY**A. Signature**

X Magdalene Collins Agent Addressee

B. Received by (Printed Name)

Magdalene Collins C. Date of Deliver

11-24-23

D. Is delivery address different from item 1? Yes
If YES, enter delivery address below: No

3. Service Type

- Adult Signature
- Adult Signature Restricted Delivery
- Certified Mail®
- Certified Mail Restricted Delivery
- Collect on Delivery
- Collect on Delivery Restricted Delivery

- Priority Mail Express®
- Registered Mail™
- Registered Mail Restricted Delivery
- Signature Confirmation
- Signature Confirmation Restricted Delivery

Insured Mail**Mail Restricted Delivery****00**

Domestic Return Receipt

SENDER: COMPLETE THIS SECTION

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1. Article Addressed to:

COLLINS CLYDE RAYMOND &
MAGDALENE
317 FROSTY HOLLOW RD
MT VERNON, KY 40456



9590 9402 8463 3186 7620 44

2. Article Number (Transfer from service label)

9589 0710 5270 1623 2615 78

COMPLETE THIS SECTION ON DELIVERY

A. Signature

X Magdalene Collins Agent Addressee

B. Received by (Printed Name)

Magdalene Collins C. Date of Deliver

D. Is delivery address different from item 1? Yes
If YES, enter delivery address below: No

3. Service Type

- Priority Mail Express®
- Adult Signature
- Registered Mail™
- Adult Signature Restricted Delivery
- Registered Mail Restricted Delivery
- Certified Mail®
- Certified Mail Restricted Delivery
- Collect on Delivery
- Collect on Delivery Restricted Delivery
- Mail
- Signature Confirmation¹
- Mail Restricted Delivery
- Signature Confirmation Restricted Delivery
- OO

PS Form 3811, July 2020 PSN 7530-02-000-9053

Domestic Return Receipt

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- Print your name and address on the reverse so that we can return the card to you.
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1. Article Addressed to:

COLLINS PATRICIA A & CLIFFORD
REVOCABLE TRUST
5216 S WILDERNESS RD
MT VERNON, KY 40456



9590 9402 8463 3186 7619 79

2. Article Number (Transfer from service label)

9589 0710 5270 1623 2616 46

COMPLETE THIS SECTION ON DELIVERY

A. Signature

X Patricia Collins Agent Addressee

B. Received by (Printed Name)

C. Date of Deliver

D. Is delivery address different from item 1? Yes
If YES, enter delivery address below: No

3. Service Type

- Priority Mail Express®
- Adult Signature
- Registered Mail™
- Adult Signature Restricted Delivery
- Registered Mail Restricted Delivery
- Certified Mail®
- Certified Mail Restricted Delivery
- Collect on Delivery
- Collect on Delivery Restricted Delivery
- Insured Mail
- Signature Confirmation¹
- Signature Confirmation Restricted Delivery
- OO

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1. Article Addressed to:

POYNTER DAVID & YOLANDA
6254 S WILDERNESS RD
MT VERNON, KY 40456



9590 9402 8463 3186 7620 37

2. Article Number (Transfer from service label)

9589 0710 5270 1623 2615 85

COMPLETE THIS SECTION ON DELIVERY

A. Signature

X yola Agent Addressee

B. Received by

D. Is delivery address different from item 1? Yes
If YES, enter delivery address below: No

3. Service Type

- Priority Mail Express®
- Adult Signature
- Registered Mail™
- Adult Signature Restricted Delivery
- Registered Mail Restricted Delivery
- Certified Mail®
- Certified Mail Restricted Delivery
- Collect on Delivery
- Collect on Delivery Restricted Delivery
- Mail
- Signature Confirmation¹
- Signature Confirmation Restricted Delivery
- OO

PS Form 3811, July 2020 PSN 7530-02-000-9053

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SENDER: COMPLETE THIS SECTION

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- Print your name and address on the reverse so that we can return the card to you.
- Attach this card to the back of the mailpiece, or on the front if space permits.

1. Article Addressed to:

ROTH STEPHEN E & KIM D
241 CARDINAL HOLLOW ROAD
MT VERNON, KY 40456



9590 9402 8463 3186 7620 13

2. Article Number (Transfer from service label)

9589 0710 5270 1623 2616 08

- 3. Service Type**
- | | |
|--|---|
| <input type="checkbox"/> Adult Signature | <input type="checkbox"/> Priority Mail Express® |
| <input type="checkbox"/> Adult Signature Restricted Delivery | <input type="checkbox"/> Registered Mail™ |
| <input checked="" type="checkbox"/> Certified Mail® | <input type="checkbox"/> Registered Mail Restricted Delivery |
| <input type="checkbox"/> Certified Mail Restricted Delivery | <input type="checkbox"/> Signature Confirmation¹ |
| <input type="checkbox"/> Collect on Delivery | <input type="checkbox"/> Signature Confirmation Restricted Delivery |
| <input type="checkbox"/> Collect on Delivery Restricted Delivery | |

Mail
Mail Restricted Delivery
(00)

PS Form 3811, July 2020 PSN 7530-02-000-9053

Domestic Return Receipt

SENDER: COMPLETE THIS SECTION

- Complete items 1, 2, and 3.
- Print your name and address on the reverse so that we can return the card to you.
- Attach this card to the back of the mailpiece, or on the front if space permits.

1. Article Addressed to:

COLLINS DONNIE & CAROLYN
324 CARDINAL HOLLOW RD
MT VERNON, KY 40456



9590 9402 8463 3186 7620 20

2. Article Number (Transfer from service label)

9589 0710 5270 1623 2615 92

- 3. Service Type**
- | | |
|--|---|
| <input type="checkbox"/> Adult Signature | <input type="checkbox"/> Priority Mail Express® |
| <input type="checkbox"/> Adult Signature Restricted Delivery | <input type="checkbox"/> Registered Mail™ |
| <input checked="" type="checkbox"/> Certified Mail® | <input type="checkbox"/> Registered Mail Restricted Delivery |
| <input type="checkbox"/> Certified Mail Restricted Delivery | <input type="checkbox"/> Signature Confirmation¹ |
| <input type="checkbox"/> Collect on Delivery | <input type="checkbox"/> Signature Confirmation Restricted Delivery |
| <input type="checkbox"/> Collect on Delivery Restricted Delivery | |

Mail
Mail Restricted Delivery
(00)

PS Form 3811, July 2020 PSN 7530-02-000-9053

Domestic Return Receipt

SENDER: COMPLETE THIS SECTION

- Complete items 1, 2, and 3.
- Print your name and address on the reverse so that we can return the card to you.
- Attach this card to the back of the mailpiece, or on the front if space permits.

1. Article Addressed to:

COLLINS A. MING
170 CARDINAL HOLLOW RD
MT VERNON, KY 40456



9590 9402 8463 3186 7619 86

2. Article Number (Transfer from service label)

9589 0710 5270 1623 2616 39

- 3. Service Type**
- | | |
|--|---|
| <input type="checkbox"/> Adult Signature | <input type="checkbox"/> Priority Mail Express® |
| <input type="checkbox"/> Adult Signature Restricted Delivery | <input type="checkbox"/> Registered Mail™ |
| <input checked="" type="checkbox"/> Certified Mail® | <input type="checkbox"/> Registered Mail Restricted Delivery |
| <input type="checkbox"/> Certified Mail Restricted Delivery | <input type="checkbox"/> Signature Confirmation¹ |
| <input type="checkbox"/> Collect on Delivery | <input type="checkbox"/> Signature Confirmation Restricted Delivery |
| <input type="checkbox"/> Collect on Delivery Restricted Delivery | |

Mail
Mail Restricted Delivery
(00)

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- Print your name and address on the reverse so that we can return the card to you.
- Attach this card to the back of the mailpiece, or on the front if space permits.

1. Article Addressed to:

BULLOCK LARRY & DONNA
639 FROSTY HOLLOW ROAD
MT VERNON, KY 40456



9590 9402 8463 3186 7620 68

2. Article Number (Transfer from service label)

9589 0710 5270 1623 2615 54

Mail Restricted Delivery
(0)

PS Form 3811, July 2020 PSN 7530-02-000-9053

Domestic Return Receipt

COMPLETE THIS SECTION ON DELIVERY

A. Signature

- Agent
 Addressee

B. Received by (Printed Name)

C. Date of Deliver

D. Is delivery address different from item 1? Yes
If YES, enter delivery address below: No

SENDER: COMPLETE THIS SECTION

- Complete items 1, 2, and 3.
- Print your name and address on the reverse so that we can return the card to you.
- Attach this card to the back of the mailpiece, or on the front if space permits.

1. Article Addressed to:

BUSTLE VIRGIL HEIRS
C/O DONNA BULLOCK
639 FROSTY HOLLOW RD
MT VERNON, KY 40456



9590 9402 8463 3186 7620 51

2. Article Number (Transfer from service label)

9589 0710 5270 1623 2615 61

Mail Restricted Delivery
(0)

PS Form 3811, July 2020 PSN 7530-02-000-9053

Domestic Return Receipt

COMPLETE THIS SECTION ON DELIVERY

A. Signature

- Agent
 Addressee

B. Received by (Printed Name)

C. Date of Deliver

D. Is delivery address different from item 1? Yes
If YES, enter delivery address below: No

SENDER: COMPLETE THIS SECTION

- Complete items 1, 2, and 3.
- Print your name and address on the reverse so that we can return the card to you.
- Attach this card to the back of the mailpiece, or on the front if space permits.

1. Article Addressed to:

OAKES KENNETH JR & DORINDA L
234 CARDINAL HOLLOW RD
MT VERNON, KY 40456



9590 9402 8463 3186 7620 06

2. Article Number (Transfer from service label)

9589 0710 5270 1623 2616 15

Mail Restricted Delivery
(0)

PS Form 3811, July 2020 PSN 7530-02-000-9053

Domestic Return Receipt

3. Service Type
- Priority Mail Express®
 Registered Mail™
 Registered Mail Restrict Delivery
 Certified Mail®
 Certified Mail Restricted Delivery
 Collect on Delivery
 Collect on Delivery Restricted Delivery
 Insured Mail
- Signature Confirmation®
 Signature Confirmation Restricted Delivery

SENDER: COMPLETE THIS SECTION

- Complete items 1, 2, and 3.
- Print your name and address on the reverse so that we can return the card to you.
- Attach this card to the back of the mailpiece, or on the front if space permits.

1. Article Addressed to:

MARIA ALEX & MELISSA
2744 JOHNSON RD
LONDON, KY 40741



9590 9402 8463 3186 7621 12

2. Article Number (Transfer from service label)

9589 0710 5270 1623 2615 09

COMPLETE THIS SECTION ON DELIVERY**A. Signature** X Agent
 Addressee**B. Received by (Printed Name)****C. Date of Deliver****D. Is delivery address different from item 1?** Yes
If YES, enter delivery address below: No**3. Service Type**

- Adult Signature
 - Adult Signature Restricted Delivery
 - Certified Mail®
 - Certified Mail Restricted Delivery
 - Collect on Delivery
 - Collect on Delivery Restricted Delivery
- Mail
Mail Restricted Delivery
0)
- Priority Mail Express®
 - Registered Mail™
 - Registered Mail Restricted Delivery
 - Signature Confirmation
 - Signature Confirmation Restricted Delivery

PS Form 3811, July 2020 PSN 7530-02-000-9053

Domestic Return Receipt

SENDER: COMPLETE THIS SECTION

- Complete items 1, 2, and 3.
- Print your name and address on the reverse so that we can return the card to you.
- Attach this card to the back of the mailpiece, or on the front if space permits.

1. Article Addressed to:

COLLINS KENNETH B & TAWANA
PO BOX 1907
MT VERNON, ~~NY~~ 105456



9590 9402 8463 3186 7621 29

2. Article Number (Transfer from service label)

9589 0710 5270 1623 2614 93

COMPLETE THIS SECTION ON DELIVERY**A. Signature**
 Agent Addressee**B. Received by (Printed Name)****C. Date of Delivery**D. Is delivery address different from item 1? Yes
If YES, enter delivery address below: No**3. Service Type**

- Priority Mail Express®
- Registered Mail™
- Registered Mail Restricted Delivery
- Certified Mail®
- Certified Mail Restricted Delivery
- Collect on Delivery
- Collect on Delivery Restricted Delivery
- Signature Confirmation™
- Signature Confirmation Restricted Delivery

PS Form 3811, July 2020 PSN 7530-02-000-9053

Domestic Return Receipt



Russell L. Brown
Attorney at Law
rbrown@clarkquinnlaw.com

320 N. Meridian St., Ste. 1100
Indianapolis, IN 46204
(317) 637-1321 main
(317) 687-2344 fax


December 11, 2023

**Notice of Proposed Construction of
Wireless Communications Facility
Site Name: Mt Vernon East**

Celco Partnership, d/b/a Verizon Wireless and TAG Towers, LLC is filing an application with the Kentucky Public Service Commission ("PSC") to construct a new wireless communications facility on a site located at 321 Frosty Hollow Road, Mt. Vernon, KY 40456, (North Latitude: (37° 19' 32.58, West Longitude 84° 15' 28.77"). The proposed facility will include a 300-foot tall antenna tower, plus a 4-foot lightning arrestor and related ground facilities. This facility is needed to provide improved coverage for wireless communications in the area.

This notice is being sent to you because the County Property Valuation Administrator's records indicate that you may own property that is within a 500' radius of the proposed tower site or contiguous to the property on which the tower is to be constructed. You have a right to submit testimony to the Kentucky Public Service Commission ("PSC"), either in writing or to request intervention in the PSC's proceedings on the application. You may contact the PSC for additional information concerning this matter at: Kentucky Public Service Commission, Executive Director, 211 Sower Boulevard, P.O. Box 615, Frankfort, Kentucky 40602. Please refer to docket number 2023-00368 in any correspondence sent in connection with this matter.

We have attached a map showing the site location for the proposed tower. Applicant's radio frequency engineers assisted in selecting the proposed site for the facility, and they have determined it is the proper location and elevation needed to provide quality service to wireless customers in the area. Please feel free to contact us at 317-637-1321 if you have any comments or questions about this proposal.

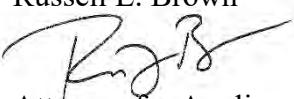Sincerely,
Russell L. Brown

Attorney for Applicant
RLB/mnw
enclosure



VICINITY MAP



LOCATION MAP

Aerial Location Map



CERTIFIED MAIL**ClarkQuinn**
Clark, Quinn, Moses, Scott & Grahn, LLP

9589 0710 5270 1623 2608 54

FIRST- CLASS



US POSTAGE IMIPITNEY BOWES

ZIP 46204
02 7H
0006035028 \$ 008.53⁰
DEC 11 2023

RICHARDSON PHYLLIS
174 FROSTY HOLLOW RD
MT VERNON, KY 40456

CERTIFIED MAIL®**ClarkQuinn**
Clark, Quinn, Moses, Scott & Grahn, LLP

9589 0710 5270 1623 2608 47

FIRST- CLASS

US POSTAGE IMIPITNEY BOWES
ZIP 46204
02 7H
0006035028 \$ 008.53⁰
DEC 11 2023

CROMER THOMAS LEE
385 FROSTY HOLLOW RD
MT VERNON, KY 40456

CERTIFIED MAIL®**ClarkQuinn**
Clark, Quinn, Moses, Scott & Grahn, LLP

9589 0710 5270 1623 2608 30

FIRST- CLASS

US POSTAGE IMIPITNEY BOWES
ZIP 46204
02 7H
0006035028 \$ 008.53⁰
DEC 11 2023

ALLEN HAYES & TERRY GOFF
230 CARDINAL HOLLOW RD
MT VERNON, KY 40456

SENDER: COMPLETE THIS SECTION

- Complete items 1, 2, and 3.
- Print your name and address on the reverse so that we can return the card to you.
- Attach this card to the back of the mailpiece, or on the front if space permits.

1. Article Addressed to:

CROMER THOMAS LEE
385 FROSTY HOLLOW RD
MT VERNON, KY 40456



9590 9402 8463 3186 7623 27

2. Article Number (Transfer from service label)

9589 0710 5270 1623 2608 47

PS Form 3811, July 2020 PSN 7530-02-000-9053

Domestic Return Receipt

COMPLETE THIS SECTION ON DELIVERY

A. Signature

564

 Agent Addressee

B. Received by (Printed Name)

564

C. Date of Delivery

12/14/20

D. Is delivery address different from item 1? Yes
If YES, enter delivery address below: No**SENDER: COMPLETE THIS SECTION**

- Complete items 1, 2, and 3.
- Print your name and address on the reverse so that we can return the card to you.
- Attach this card to the back of the mailpiece, or on the front if space permits.

1. Article Addressed to:

RICHARDSON PHYLLIS
174 FROSTY HOLLOW RD
MT VERNON, KY 40456



9590 9402 8463 3186 7623 10

2. Article Number (Transfer from service label)

9589 0710 5270 1623 2608 54

PS Form 3811, July 2020 PSN 7530-02-000-9053

COMPLETE THIS SECTION ON DELIVERY

A. Signature

564

 Agent Addressee

B. Received by (Printed Name)

564

C. Date of Delivery

12/14/20

D. Is delivery address different from item 1? Yes
If YES, enter delivery address below: No**3. Service Type**

- Priority Mail Express®
- Registered Mail™
- Registered Mail Restricted Delivery
- Certified Mail®
- Certified Mail Restricted Delivery
- Collect on Delivery
- Collect on Delivery Restricted Delivery
- Insured Mail
- Mail Restricted Delivery (00)
- Signature Confirmation™
- Signature Confirmation Restricted Delivery

Domestic Return Receipt

USPS Tracking®

Tracking Number:

[Remove X](#)

9589071052701623260830

[Copy](#)

[Add to Informed Delivery \(<https://informeddelivery.usps.com/>\)](#)

Latest Update

Your package is moving within the USPS network and is on track to be delivered to its final destination. It is currently in transit to the next facility.

Get More Out of USPS Tracking:

[USPS Tracking Plus®](#)

Feedback

Moving Through Network

In Transit to Next Facility

January 1, 2024

Arrived at USPS Regional Facility

LOUISVILLE KY DISTRIBUTION CENTER
December 26, 2023, 11:49 am

[See All Tracking History](#)

[What Do USPS Tracking Statuses Mean? \(<https://faq.usps.com/s/article/Where-is-my-package>\)](#)

[Text & Email Updates](#) 

[USPS Tracking Plus®](#) 

[Product Information](#) 

[See Less ^](#)

[Track Another Package](#)

Need More Help?

Contact USPS Tracking support for further assistance.

[FAQs](#)



Russell L. Brown
Attorney at Law
rbrown@clarkquinnlaw.com

320 N. Meridian St., Ste. 1100
Indianapolis, IN 46204
(317) 637-1321 main
(317) 687-2344 fax

November 17, 2023

Via Certified Mail, Return Receipt Requested

Hon. Howell Holbrook Jr.
Rockcastle County Judge/Executive
PO Box 755
205 East Main Street
Mount Vernon, KY 40456

RE: Notice of Proposal to Construct Wireless Communications Facility
Kentucky Public Service Commission Docket No. 2023-00368
Site Name: Mount Vernon East


Dear Judge Holbrook:

Cellco Partnership, d/b/a Verizon Wireless and TAG Towers, LLC is filing an application with the Kentucky Public Service Commission ("PSC") to construct a new wireless communications facility on a site located at 321 Frosty Hollow Road, Mt. Vernon, KY 40456, (North Latitude: (37° 19' 32.58, West Longitude 84° 15' 28.77"). The proposed facility will include a 300-foot tall antenna tower, plus a 4-foot lightning arrestor and related ground facilities. This facility is needed to provide improved coverage for wireless communications in the area.

You have a right to submit comments to the PSC or to request intervention in the PSC's proceedings on the application. You may contact the PSC at: Executive Director, Public Service Commission, 211 Sower Boulevard, P.O. Box 615, Frankfort, Kentucky 40602. Please refer to docket number 2023-00368 in any correspondence sent in connection with this matter.

We have attached a map showing the site location for the proposed tower. Verizon Wireless' radio frequency engineers assisted in selecting the proposed site for the facility, and they have determined it is the proper location and elevation needed to provide quality service to wireless customers in the area. Please feel free to contact us with any comments or questions you may have.

Sincerely,
Russell L. Brown

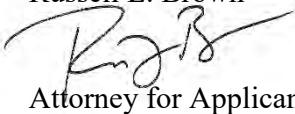

Attorney for Applicant



VICINITY MAP



LOCATION MAP

Aerial Location Map



CERTIFIED MAIL®

ClarkQuinn
Clark, Quinn, Moses, Scott & Grahn, LLP



9589 0710 5270 1623 2609 39

FIRST-CLASS



US POSTAGE™ PITNEY BOWES



ZIP 46204
02 7H
0006035028 \$ 008.53⁰
NOV 17 2023

Hon. Howell Holbrook Jr.
Rockcastle County Judge/Executive
PO Box 755
205 East Main Street
Mount Vernon, KY 40456

USPS Tracking®

Tracking Number:

[Remove X](#)

9589071052701623260939

[Copy](#)

[Add to Informed Delivery \(<https://informeddelivery.usps.com/>\)](#)

Latest Update

Your package is moving within the USPS network and is on track to be delivered to its final destination. It is currently in transit to the next facility.

Get More Out of USPS Tracking:

[USPS Tracking Plus®](#)

Feedback

Delivered

Out for Delivery

Preparing for Delivery

Moving Through Network

 **In Transit to Next Facility**

November 24, 2023

 **Arrived at USPS Regional Facility**

LEXINGTON KY DISTRIBUTION CENTER

November 20, 2023, 9:44 am

 [See All Tracking History](#)

[What Do USPS Tracking Statuses Mean? \(<https://faq.usps.com/s/article/Where-is-my-package>\)](#)

Text & Email Updates



USPS Tracking Plus®**Product Information****See Less ^**[Track Another Package](#)**Need More Help?**

Contact USPS Tracking support for further assistance.

[FAQs](#)



Russell L. Brown
Attorney at Law
rbrown@clarkquinnlaw.com

320 N. Meridian St., Ste. 1100
Indianapolis, IN 46204
(317) 637-1321 main
(317) 687-2344 fax

December 11, 2023

Via Certified Mail, Return Receipt Requested
9589 0710 5270 1623 2608 61

Hon. Howell Holbrook Jr.
Rockcastle County Judge/Executive
PO Box 755
205 East Main Street
Mount Vernon, KY 40456


RE: Notice of Proposal to Construct Wireless Communications Facility
Kentucky Public Service Commission Docket No. 2023-00368
Site Name: Mount Vernon East

Dear Judge Holbrook:

Cellco Partnership, d/b/a Verizon Wireless and TAG Towers, LLC is filing an application with the Kentucky Public Service Commission ("PSC") to construct a new wireless communications facility on a site located at 321 Frosty Hollow Road, Mt. Vernon, KY 40456, (North Latitude: (37° 19' 32.58, West Longitude 84° 15' 28.77"). The proposed facility will include a 300-foot tall antenna tower, plus a 4-foot lightning arrestor and related ground facilities. This facility is needed to provide improved coverage for wireless communications in the area.

You have a right to submit comments to the PSC or to request intervention in the PSC's proceedings on the application. You may contact the PSC at: Executive Director, Public Service Commission, 211 Sower Boulevard, P.O. Box 615, Frankfort, Kentucky 40602. Please refer to docket number 2023-00368 in any correspondence sent in connection with this matter.

We have attached a map showing the site location for the proposed tower. Verizon Wireless' radio frequency engineers assisted in selecting the proposed site for the facility, and they have determined it is the proper location and elevation needed to provide quality service to wireless customers in the area. Please feel free to contact us with any comments or questions you may have.

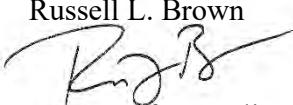Sincerely,
Russell L. Brown

Attorney for Applicant

SENDER: COMPLETE THIS SECTION

- Complete items 1, 2, and 3.
- Print your name and address on the reverse so that we can return the card to you.
- Attach this card to the back of the mailpiece, or on the front if space permits.

1. Article Addressed to:

Hon. Howell Holbrook Jr.
 Rockcastle County Judge/Executive
 PO Box 755
 205 East Main Street
 Mount Vernon, KY 40456



9590 9402 8463 3186 7624 71

2. Article Number (Transfer from service label)

9589 0710 5270 1623 2608 61

COMPLETE THIS SECTION ON DELIVERY

A. Signature

Maurice Holbrook

Agent
 Addressee

B. Received by (Printed Name)

C. Date of Delivery

D. Is delivery address different from item 1? Yes
 If YES, enter delivery address below: No

3. Service Type

- | | |
|--|--|
| <input type="checkbox"/> Adult Signature | <input type="checkbox"/> Priority Mail Express® |
| <input type="checkbox"/> Adult Signature Restricted Delivery | <input type="checkbox"/> Registered Mail™ |
| <input checked="" type="checkbox"/> Certified Mail® | <input type="checkbox"/> Registered Mail Restricted Delivery |
| <input type="checkbox"/> Certified Mail Restricted Delivery | <input type="checkbox"/> Signature Confirmation™ |
| <input type="checkbox"/> Collect on Delivery | <input type="checkbox"/> Signature Confirmation |
| <input type="checkbox"/> Collect on Delivery Restricted Delivery | <input type="checkbox"/> Restricted Delivery |
| <input type="checkbox"/> Insured Mail | |
| <input type="checkbox"/> Mail Restricted Delivery | |
| <input type="checkbox"/> OO | |

PS Form 3811, July 2020 PSN 7530-02-000-9053

Domestic Return Receipt

SITE NAME: MT. VERNON EAST NOTICE SIGNS

The signs are at least (2) feet by four (4) feet in size, of durable material, with the text printed in black letters at least one (1) inch in height against a white background, except for the word "**tower**," which is at least four (4) inches in height.

TowerCo and Cellco Partnership, d/b/a Verizon Wireless proposes to construct a telecommunications **tower** on this site. If you have questions, please contact Clark, Quinn, Moses, Scott & Grahn, LLP, 320 N. Meridian Street, Indianapolis, IN 46204; 317-637-1321, or the Executive Director, Public Service Commission, 211 Sower Boulevard, PO Box 615, Frankfort, Kentucky 40602. Please refer to docket number 2023-00368 in your correspondence.

TowerCo and Cellco Partnership, d/b/a Verizon Wireless proposes to construct a telecommunications **tower** on this site. If you have questions, please contact Clark, Quinn, Moses, Scott & Grahn, LLP, 320 N. Meridian Street, Indianapolis, IN 46204; 317-637-1321, or the Executive Director, Public Service Commission, 211 Sower Boulevard, PO Box 615, Frankfort, Kentucky 40602. Please refer to docket number 2023-00368 in your correspondence.

Robert B. Scott
Charles R. Grahn
Frank D. Otte*
John "Bart" Herriman
William W. Gooden**
Michael P. Maxwell
Russell L. Brown***
Jennifer F. Perry
Keith L. Beall
N. Davey Neal
Travis W. Cohron
Maggie L. Sadler
Kristin A. McIlwain
Olivia A. Hess

VIA EMAIL: mvsignal@windstream.net

Mt Vernon Signal
115 W. Main Street,
Mt Vernon, KY 40456

Land Use Consultant
Elizabeth Bentz Williams, AICP

RE: Legal Notice Advertisement
Site Name: Mt. Vernon

*Also admitted in Montana
†Also admitted in Kentucky
**
Registered Civil Mediator

To Whom It May Concern,


Please publish the following legal notice advertisement in the next available edition of the Mt Vernon Signal Publication:

NOTICE

Celco Partnership, d/b/a Verizon Wireless and TAG Towers, LLC are filing an application with the Kentucky Public Service Commission ("PSC") to construct a new wireless communications facility on a site located at 321 Frosty Hollow Road, Mt. Vernon, KY 40456, (North Latitude: (37° 19' 32.58, West Longitude 84° 15' 28.77"). The proposed facility will include a 300-foot tall antenna tower, plus a 4-foot lightning arrestor and related ground facilities. You have a right to submit comments to the PSC or to request intervention in the PSC's proceedings on the application. You may contact the PSC at: Executive Director, Public Service Commission, 211 Sower Boulevard, P.O. Box 615, Frankfort, Kentucky 40602. Please refer to docket number 2023-00368 in any correspondence sent in connection with this matter.

After this advertisement has been published, please forward a tearsheet copy, affidavit of publication, and invoice to Clark, Quinn, Moses, Scott & Grahn, LLC, 320 N. Meridian Street, Indianapolis, IN 46204 or by email to ebw@clarkquinnlaw.com. Please call me on my cell with any questions at 317-902-2187 if you have any questions. Thank you for your assistance.

Sincerely,

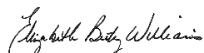

Elizabeth Bentz Williams, AICP

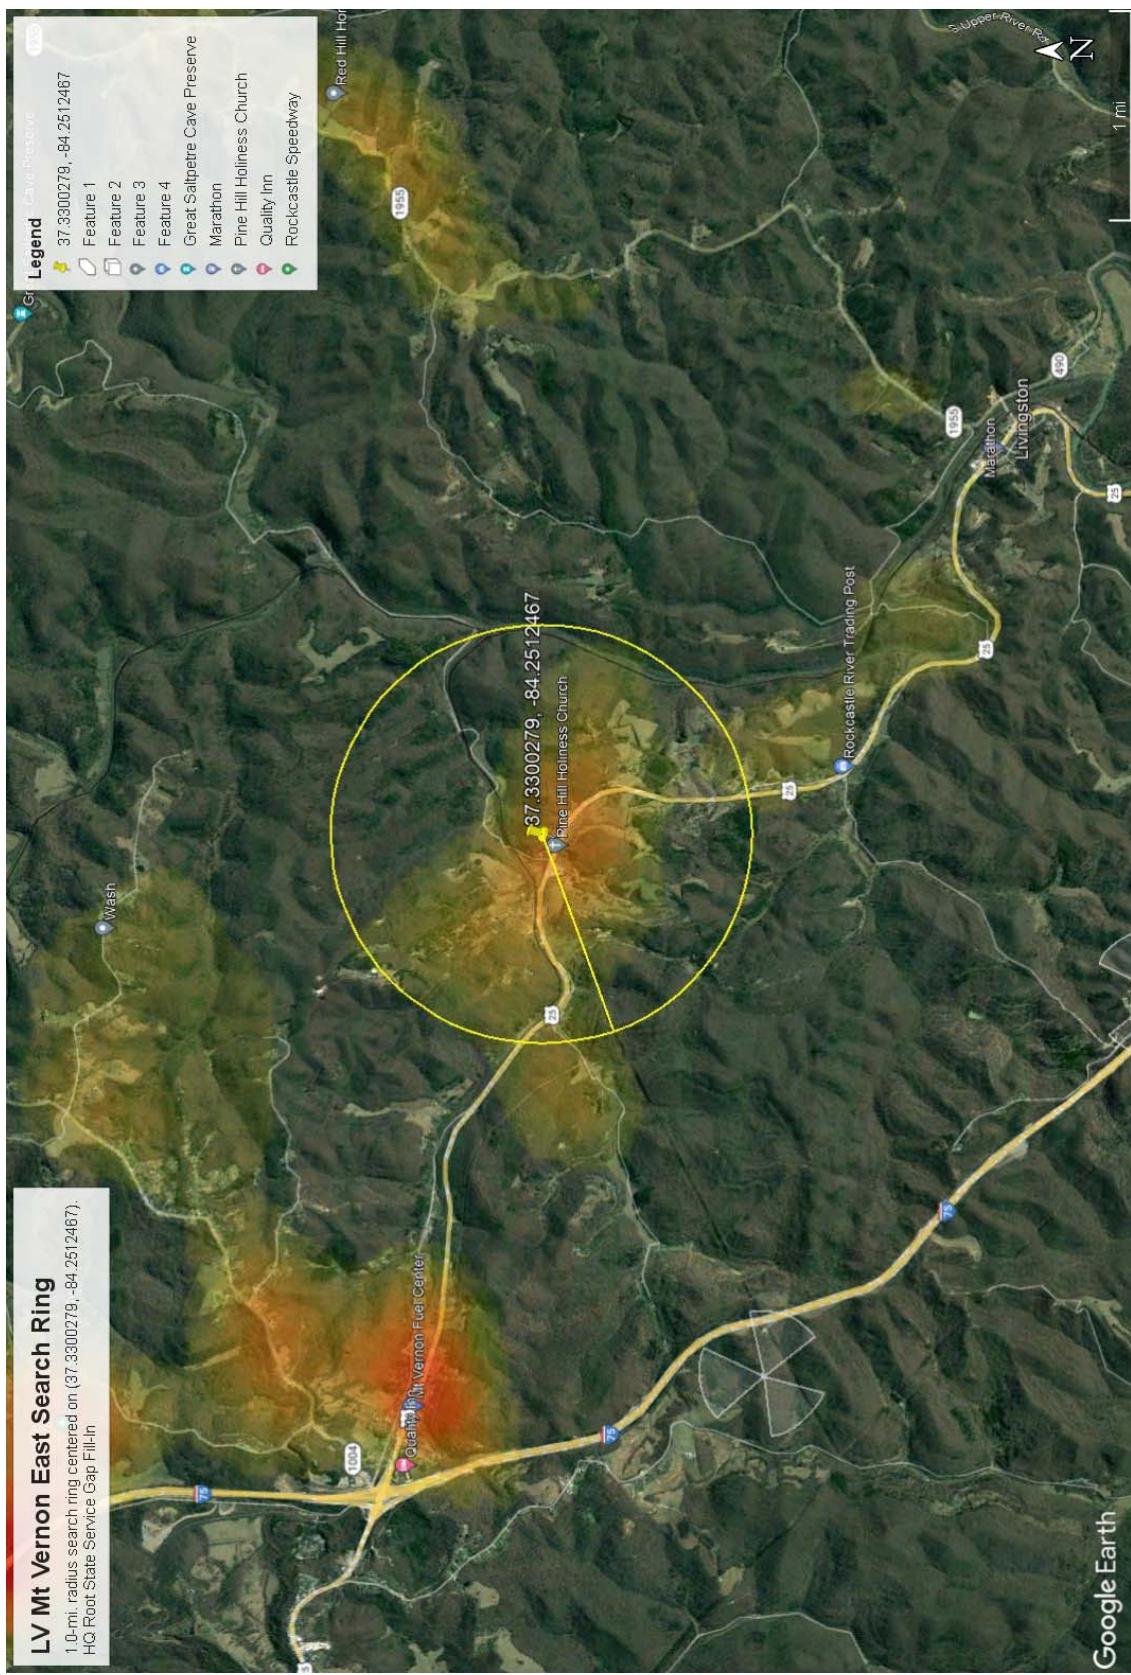


Figure 1: Search ring.



Monday, October 30th, 2023

RE: Proposed Verizon Wireless Communications Facility

Site Name: **LV MT VERNON EAST**.

Type of Tower: *300' Self-support (Lattice) Tower.*

Location: 321 Frosty Hollow Road, Mt. Vernon, KY. 40456.

To Whom It May Concern:

As the manager of radio frequency engineering for Verizon Wireless, I am providing this letter to state the need for a Verizon Wireless site called **LV MT VERNON EAST** based on the analysis completed by my team.

The **LV MT VERNON EAST** site is proposed with the below objectives:

1. Offload 4G/5G traffic from busy sites.
2. Improve 4G/5G throughput to existing heavy data users.
3. Improve 4G/5G network reliability.

Currently the area is experiencing high demand for wireless high-speed data. Growth forecasts have triggered the need for an additional site in the area. The tower is needed to provide all Verizon customers in the area with the best experience on their 5G/4G wireless devices.

Raw Land — Design plans for a new tower would provide a height of **300'**. The new structure height was decided upon to best cover the offload area and interact with the existing Verizon sites. If we are limited to a structure less than the proposed height, another tower would be needed in the vicinity in the near future. In addition, building a structure that is too short can cause existing taller sites to shoot over the proposed site and building a site that is too tall can cause the proposed site to shoot over existing sites. Both situations create a poor experience from a user perspective. The new structure will be placed near the center of the area with high traffic demand and offload the surrounding sites greatly. The new tower design meets stated objectives.

Verizon Wireless cares about the communities as well as the environment and prefers to collocate on existing structures when available. It can be noticed from any map that Verizon Wireless is currently collocated on many existing structures in the area. We prefer collocation due to reduced construction costs, faster deployment, and environment protection. However, Verizon Wireless was **unable to find a suitable structure within 2 miles** of the center of demand area to collocate the proposed **LV MT VERNON EAST** site.



Verizon Wireless design engineers establish search area criteria in order to effectively meet coverage objectives as well as offload existing Verizon cell sites. When met, the criterion also reduces the need for a new site to cover the area in the immediate future. Each cellular site covers a limited area, depending on site configuration and the surrounding terrain. Cell sites are built in an interconnected network; which means each cell site must be located so that their respective coverage areas are contiguous. This provides uninterrupted communications throughout the coverage area.

Since collocation is generally the most cost-effective means for prompt deployment of new facilities, Verizon Wireless makes every effort to investigate the feasibility for using existing towers or other tall structures for collocation when designing a new site or system expansion. However, collocation on an existing tower or tall structure is not always feasible due to location of existing cell sites. Cell sites are placed in a way so they provide smooth hand off to each other and are placed at some distance from each other to eliminate too much overlap. Too much overlap may result in a waste of resources and raise a system capacity overload concern.

This cell site has been designed, and shall be constructed and operated in a manner that satisfies regulations and requirements of all applicable governmental agencies that have been charged with regulating tower specifications, operation, construction, and placement, including the FAA and FCC.

Sincerely,

Kerwin Masten
Sr RF Manager.

verizon[®]


STATE OF INDIANA

COUNTY OF Hamilton

Subscribed and sworn to before me this 30th day of Oct., 2023.

Notary Public

Signature

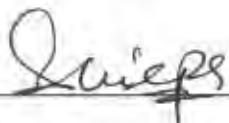

Printed

SHILPA ARYA

County of Residence Hamilton

My Commission expires: 12 - 30 - 2028

SHILPA ARYA NOTARY PUBLIC - SEAL STATE OF INDIANA COMMISSION NUMBER NP0730733 MY COMMISSION EXPIRES DEC. 30, 2028



Wednesday, October 25th, 2023.

RE: **LV MT VERNON EAST** Zoning Plots

Site Name: **LV MT VERNON EAST**

To Whom It May Concern:

This map is not a guarantee of coverage and may contain areas with no service. This map reflects a depiction of predicted and approximate wireless coverage of the network and is intended to provide a relative comparison of coverage. The depictions of coverage do not guarantee service availability as there are many factors that can influence coverage and service availability. These factors vary from location to location and change over time. The coverage areas may include locations with limited or no coverage. Even within a coverage area shown, there are many factors, including but not limited to, usage volumes, service, outage, and customer's equipment, and terrain, proximity to buildings, foliage, and weather that may impact service.


The proposed site is needed to offload capacity from existing sites. This map reflects the predicted coverage area that will be offloaded from existing sites and transferred to the proposed site.

A handwritten signature in black ink, appearing to read "Gordon Snyder".

Gordon Snyder

Sr. RF Engineer, Verizon Wireless

PRE: LV MT VERNON EAST

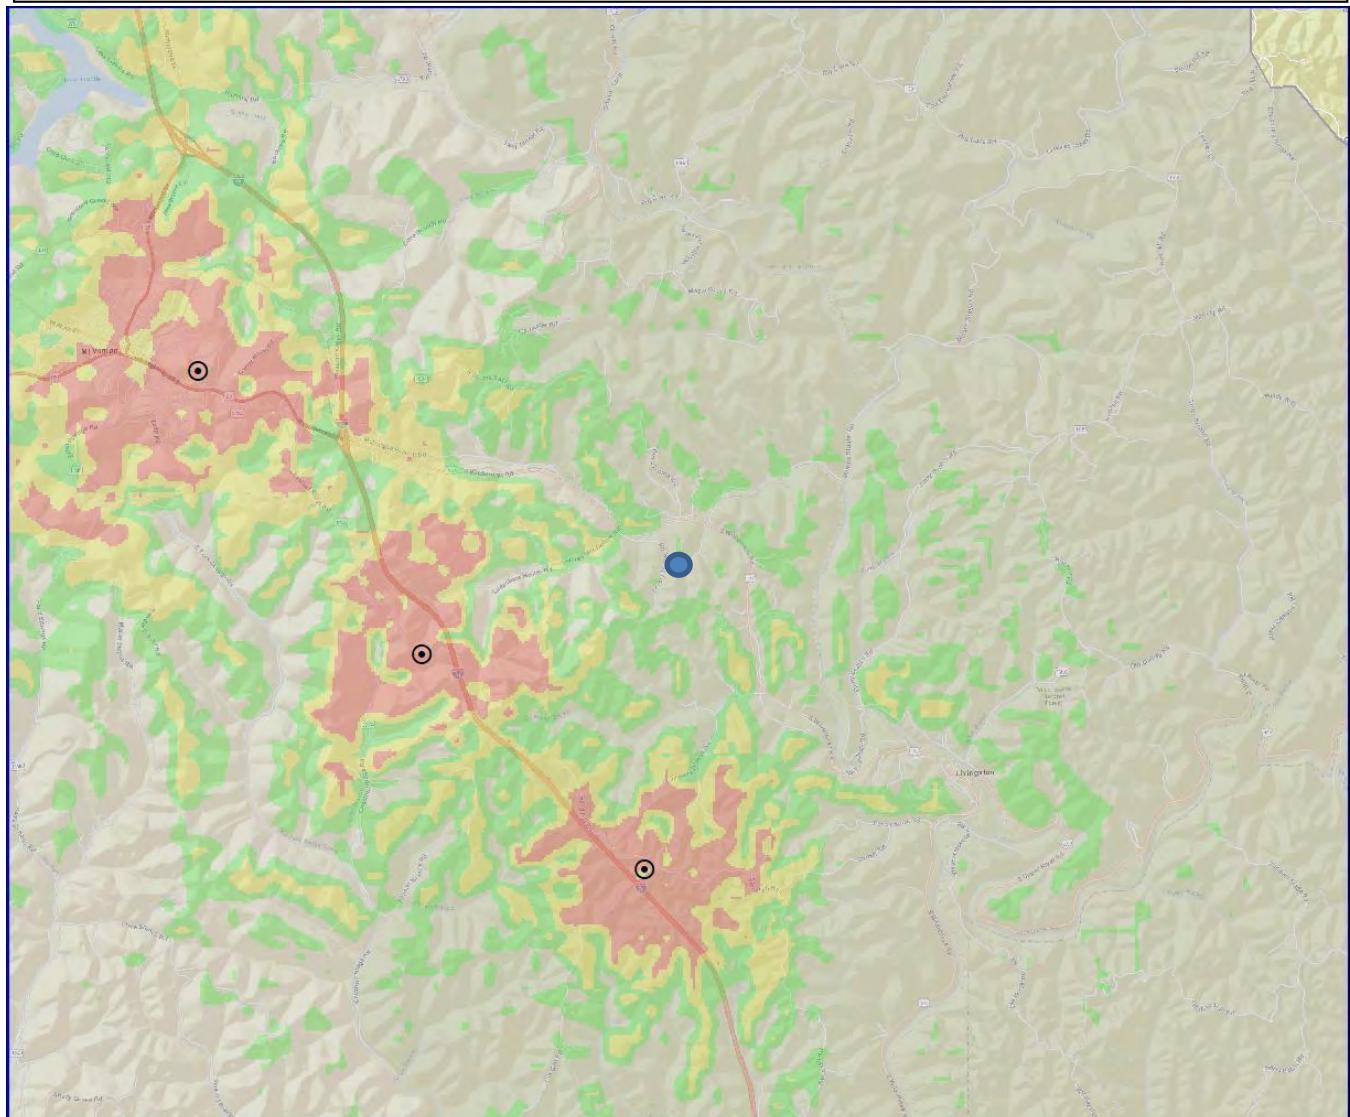**LTE RSRP Coverage**

- Best
- Better
- Good

Legend:

Existing Verizon Site



Proposed Verizon Site




Future Verizon Site



County Border



POST: LV MT VERNON EAST

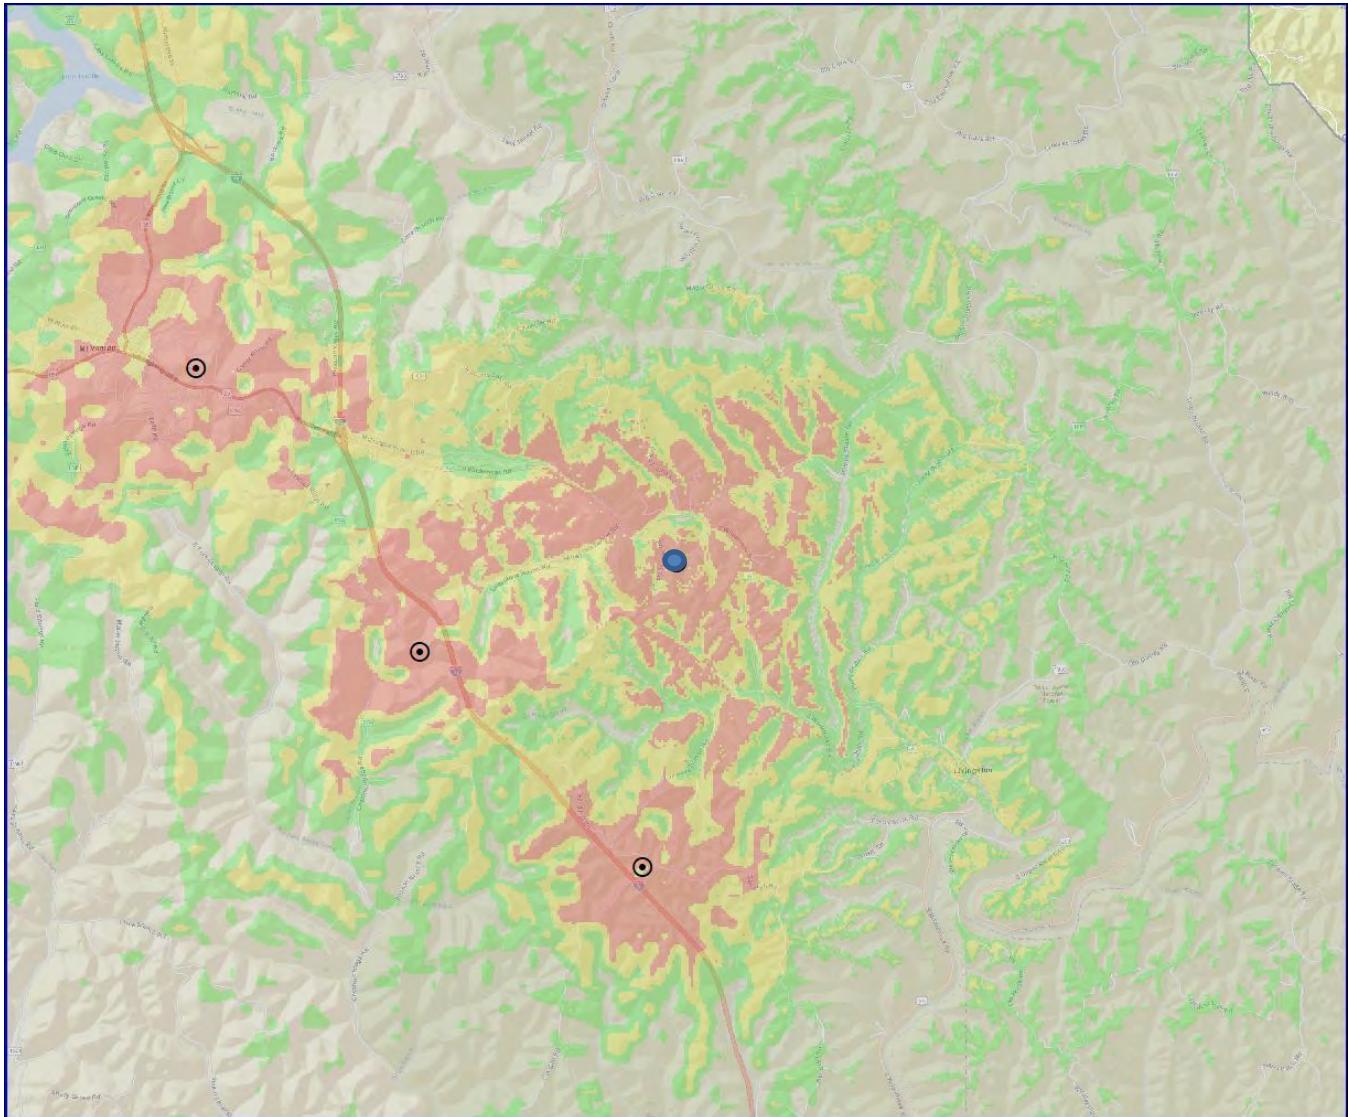**LTE RSRP Coverage**

- Best
- Better
- Good

Legend:

Existing Verizon Sites



Proposed Verizon Site



Future Verizon Site



County Border



Exhibit S
List of Qualified Professionals

Frank L. Sellinger
Professional Land Surveyor
Kentucky License 3282
FSTAN
1012 S. 4th Street, Suite 101
Louisville, KY 40203

Dmitriy V. Albul
Professional Engineer
Kentucky License 25093
Albul Engineering
3840 E. Robinson Rd.
Amherst, NY 14223

Peter Lichomski
Professional Architect
Kentucky License 7530
LAB Architects
49030 Pontiac Trail, Suite 100
Wixom, Michigan 48393

Frederic Geoffrey Bost
Professional Engineer
Kentucky License 28817
Engineered Tower Solutions, PLLC
3227 Wellington Court
Raleigh, NC 27615

Allen Schneider
Professional Engineer
Kentucky License 37506
ROHN
1 Fairholm Avenue
Peoria, IL 61603

Larry Rhoads
Construction Manager
Verizon Wireless
2421 Holloway Road
Louisville, KY 40299


Kerwin Masten
RF Engineer
Verizon Wireless
2421 Holloway Road
Louisville, KY 40299

Gordon Snyder
RF Engineer
Verizon Wireless
2421 Holloway Road
Louisville, KY 40299

STATE OF INDIANA)
) SS:
COUNTY OF MARION)

**AFFIDAVIT OF CERTIFICATION
COMMONWEALTH OF KENTUCKY
PUBLIC SERVICE COMMISSION**


I Russell L. Brown, attorney for Celco Partnership, d/b/a Verizon Wireless do hereby certify that as the person supervising the preparation of this application that the all statements and information contained herein are true and accurate to the best of that person's knowledge, information, and belief formed after a reasonable inquiry for all information within this application.

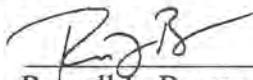

Russell L. Brown
Attorney, for Celco Partnership, d/b/a Verizon Wireless

STATE OF INDIANA,
COUNTY OF MARION, SS:

Subscribed and sworn to before me this 4th day of January, 2024.

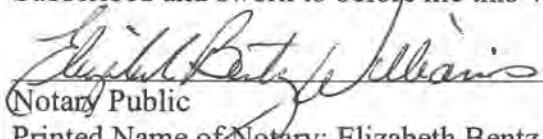
Notary Public

Printed Name of Notary: Elizabeth Bentz Williams
My commission expires: November 18, 2028
My County of Residence: Marion
Commission #: 0639620

