

SONG SPARROW SOLAR BALLARD COUNTY, KENTUCKY KENTUCKY SITING BOARD REVIEW SET CONCEPTUAL SITE PLAN

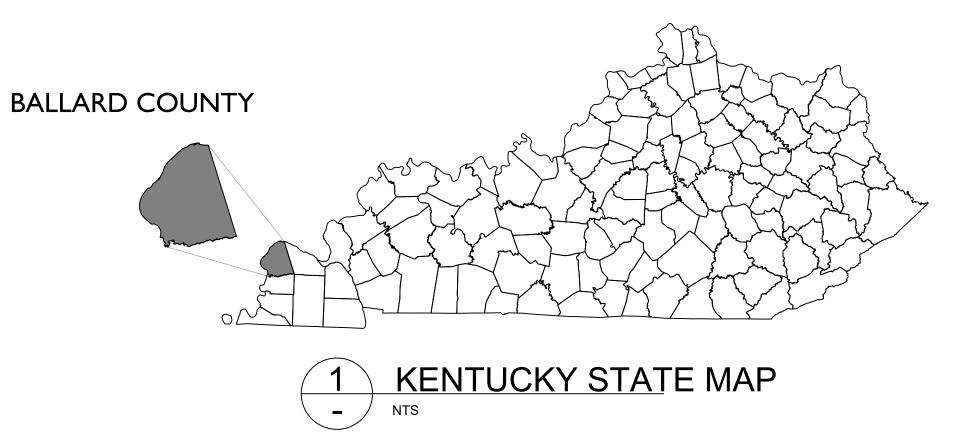


PROJECT SITE INFORMATION

SITE ADDRESS	ТВД	
COUNTY PARCEL NUMBER	VARIOUS	
GPS COORDINATES	UNER THE PRIME BOTH WITH CONTROL THE CO	
	37.017164°, -88.912536°	
SITE ELEVATION	440 FEET AMSL	
UTILITY NAME	LOUISVILLE GAS & ELECTRIC	
UTILITY ADDRESS	TBD	
UTILITY CONTACT INFORMATION	TBD	
DEVELOPER NAME	SONG SPARROW SOLAR, LLC	
DEVELOPER ADDRESS	100 CALIFORNIA STREET SUITE 400	
	SAN FRANCISCO, CA 94111	
DEVELOPER CONTACT	EVAN GOOD	
SYSTEM AC RATING AT POI (MW)	104.00	
SYSTEM STC DC RATING (MW)	143.98	
MODULE COUNT	246116	
QUANTITY OF INVERTERS	27	
QUANTITY OF TRANSFORMERS	27	
PROJECT ZONING	TBD	
OCCUPIED STRUCTURE BUFFER	250 FEET	
NON-PARTICIPATING PARCEL LINE	100 FEET	
PRIMARY ROADS	50 FEET	
SECONDARY ROADS	25 FEET	
PROJECT AREA	669 ACRES	
ROAD LENGTH	38529 FEET	

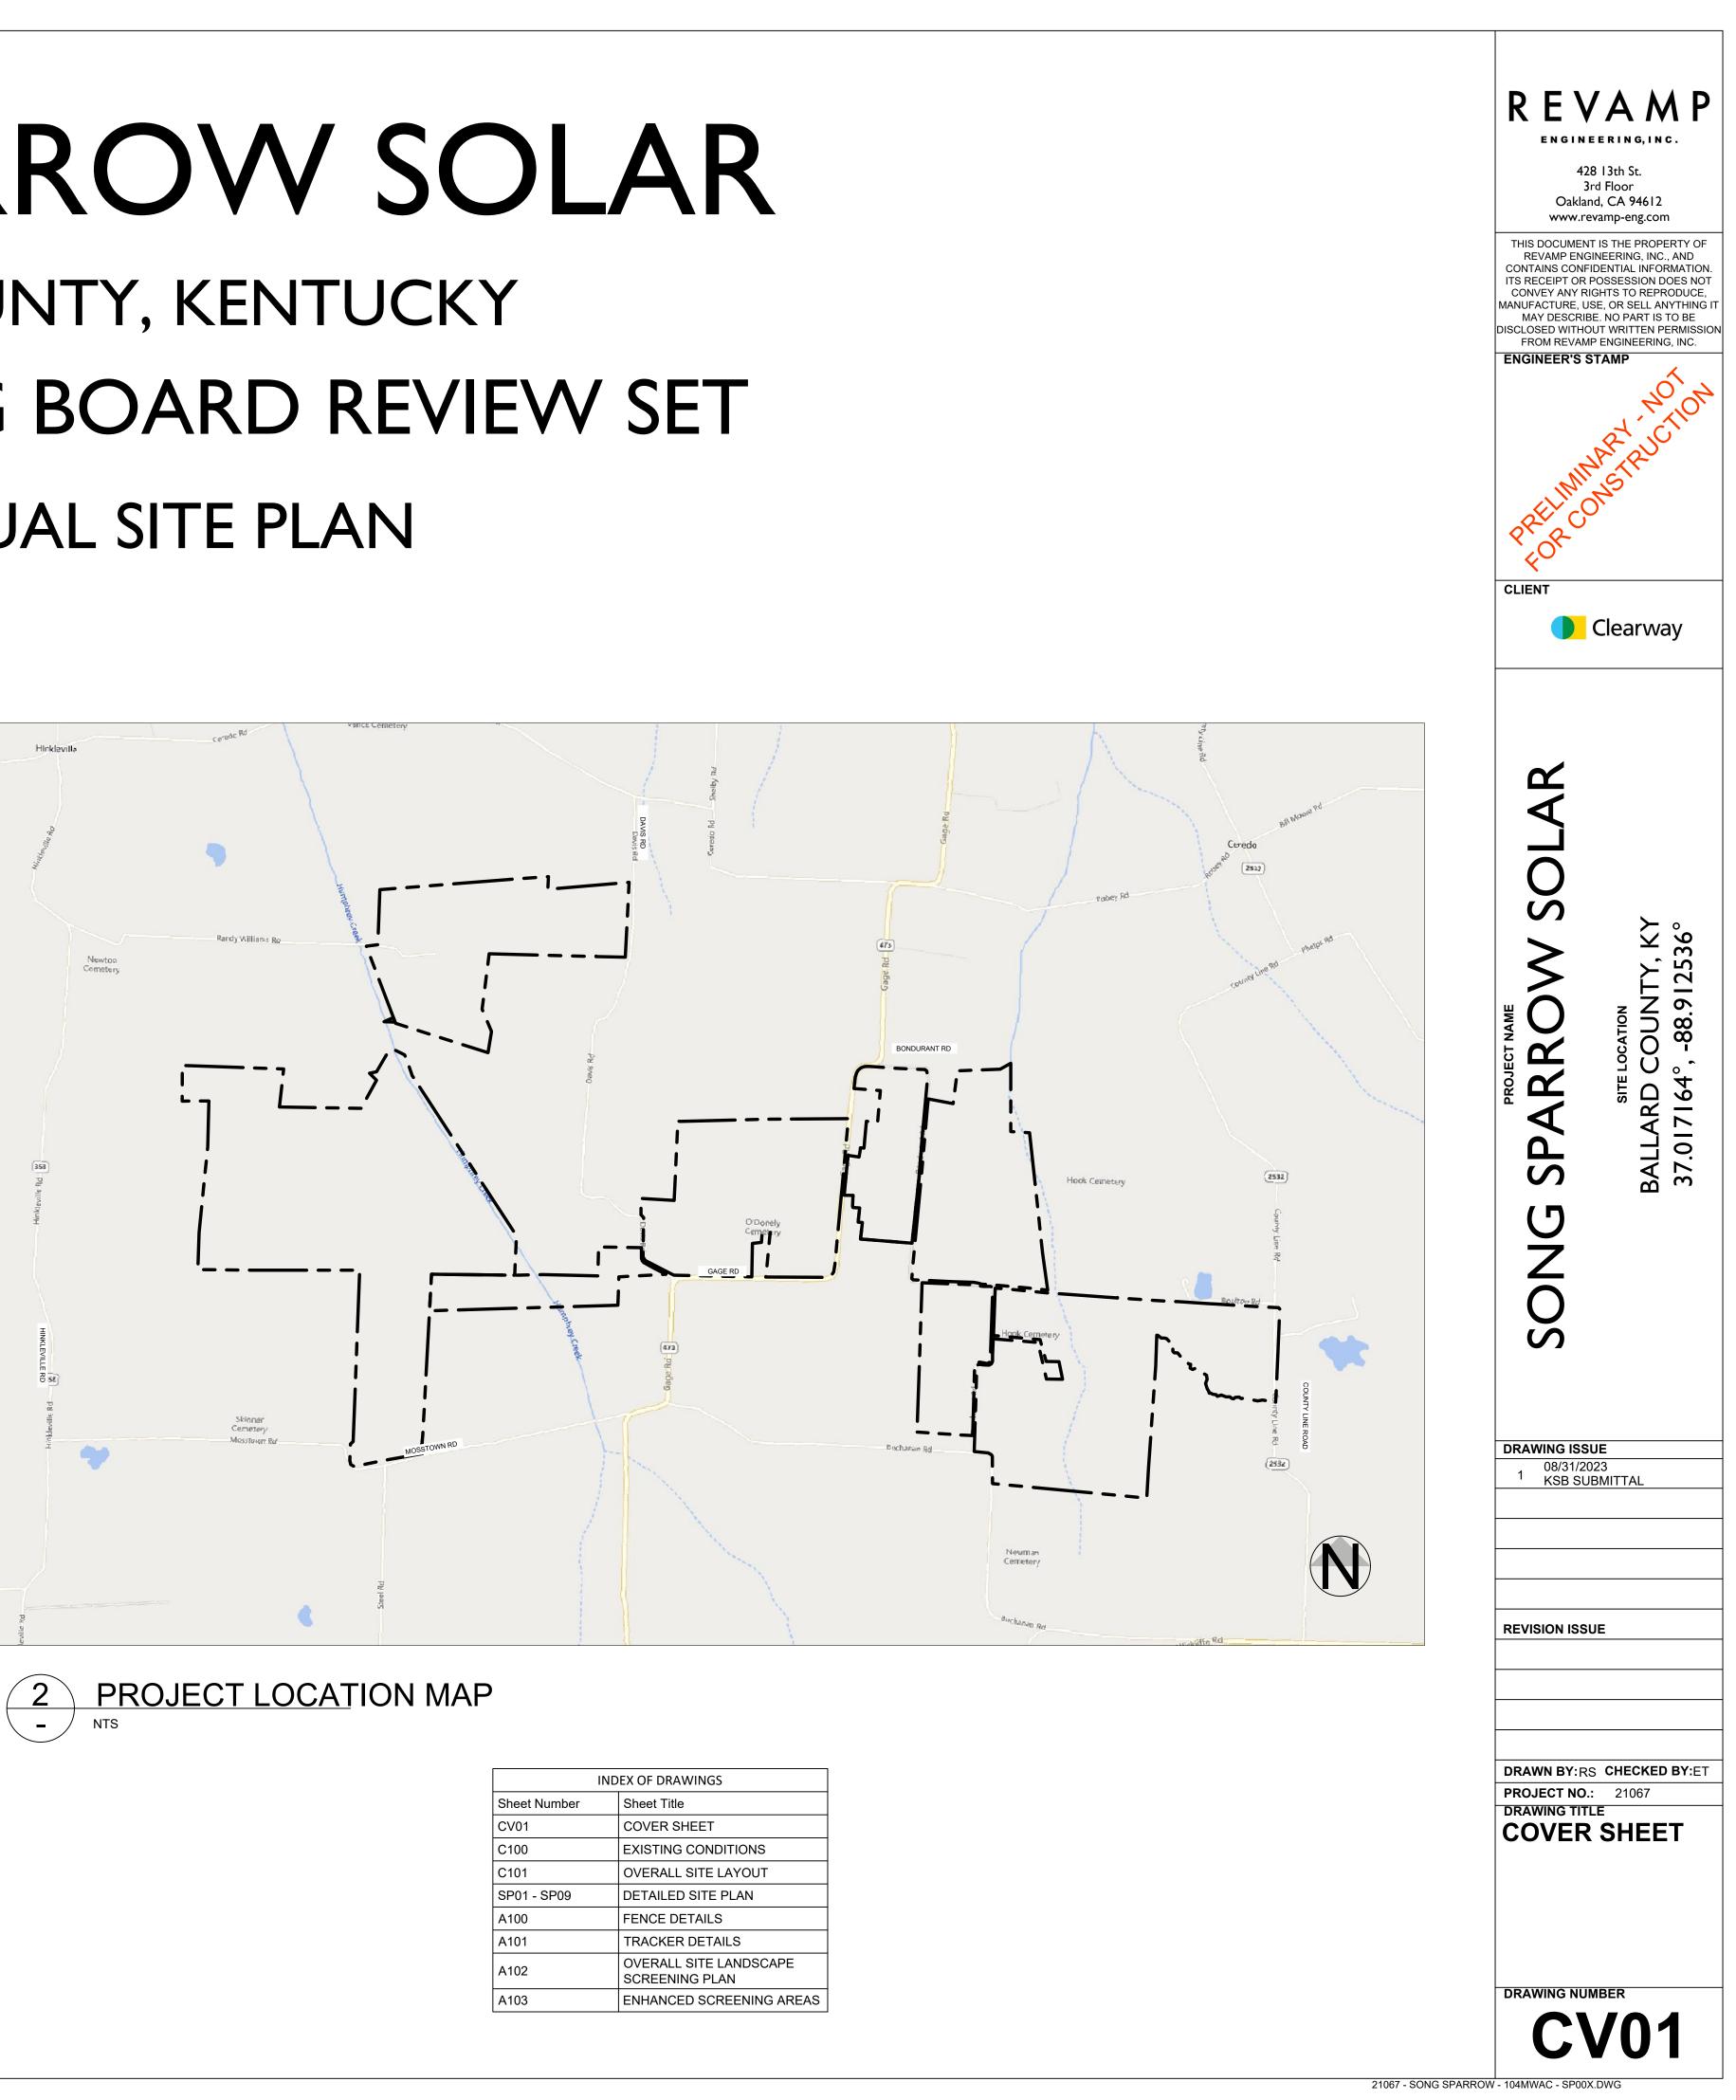



	IND	EX OF DRAWINGS
Sheet N	Number	Sheet Title
CV01		COVER SHEET
C100		EXISTING CONDITIONS
C101		OVERALL SITE LAYOUT
SP01 -	SP09	DETAILED SITE PLAN
A100		FENCE DETAILS
A101		TRACKER DETAILS
A102		OVERALL SITE LANDSCAPE SCREENING PLAN
A103		ENHANCED SCREENING AR

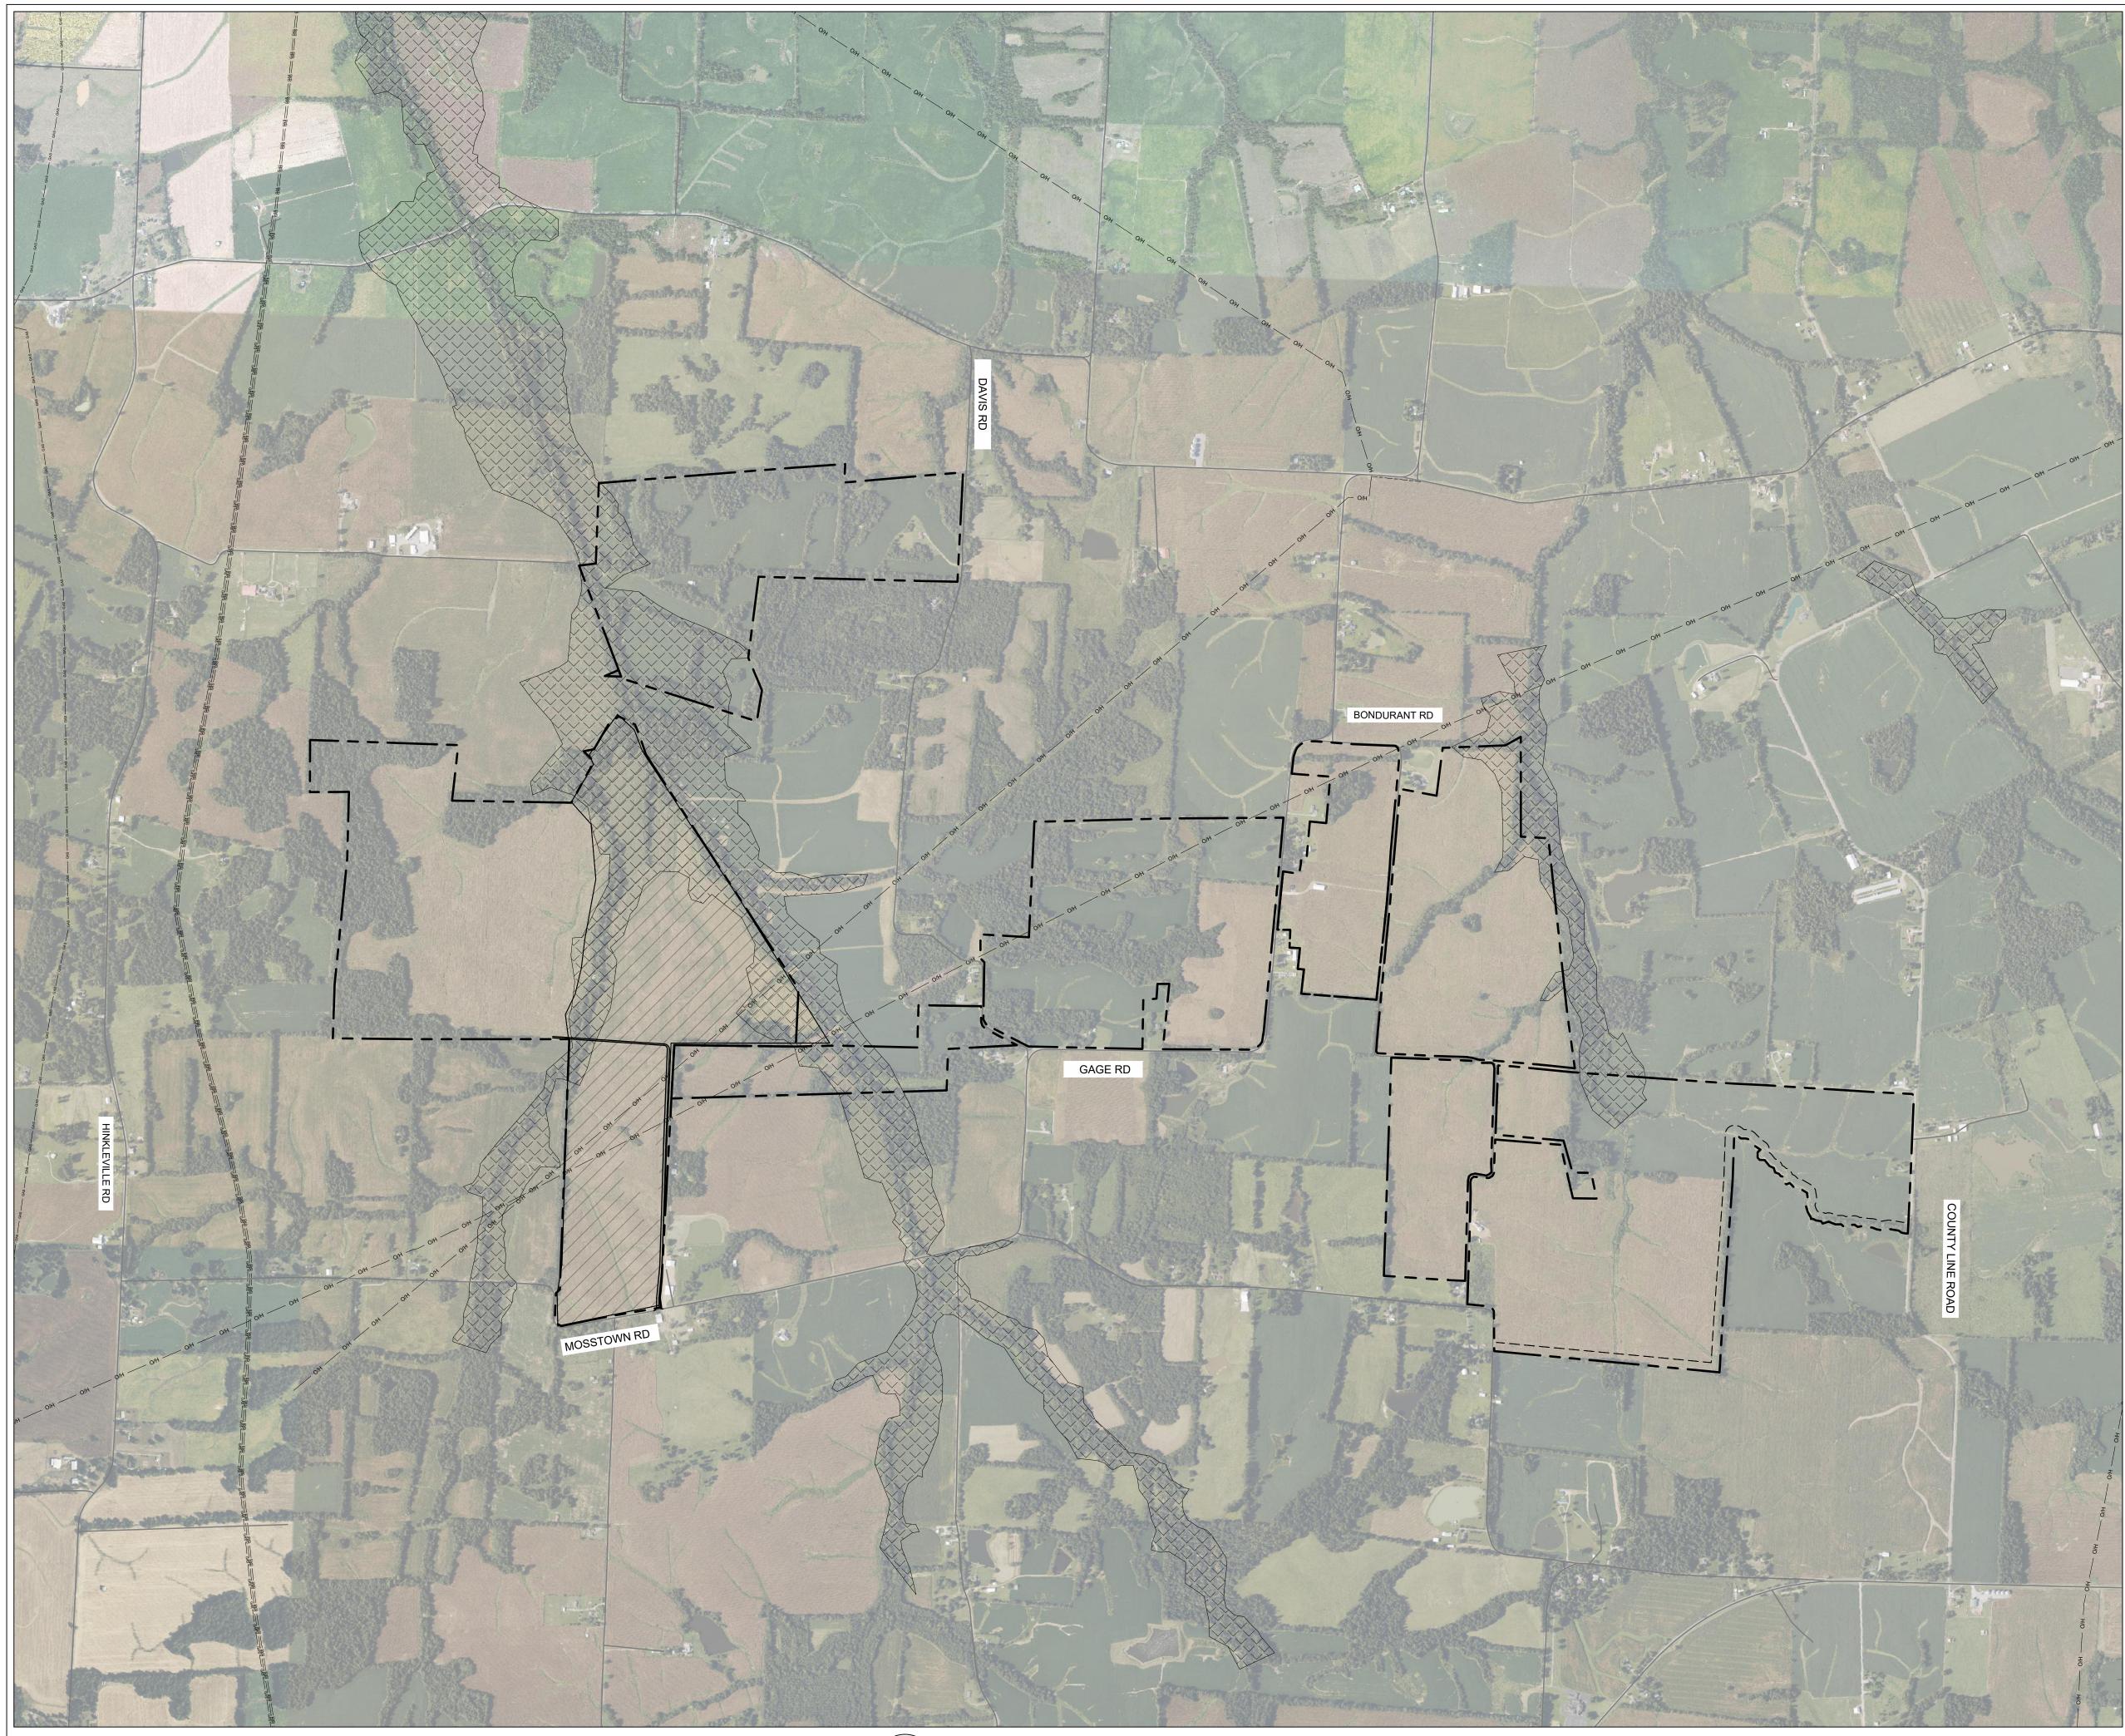

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EXISTING CONDITIONS 1" = 900' 0' 450' 900' 1800'

RE			
Oa	428 13th 3rd Floo akland, CA w.revamp-	St. or 94612	•
THIS DOCUI REVAMP CONTAINS C ITS RECEIPT CONVEY AN MANUFACTUR MAY DES DISCLOSED W FROM RE	MENT IS TH ENGINEER ONFIDENTI OR POSSE IY RIGHTS IY RIGHTS IY RIGHTS IY RIGHTS IY RIGHTS IY RIGHTS IN CONTRACTOR IN CONTRACTOR INCLUE IN CONTRACTOR IN CONTR	E PROPEI ING, INC., AL INFORI SSION DO TO REPRO SELL AN' PART IS T LITTEN PE NEERING	AND MATION. DES NOT DDUCE, /THING IT O BE RMISSION , INC.
	MAR	RUC	joh -
	Cle	arwa	у
SONG SPARROW SOLAR	SITE LOCATION	BALLARD COUNTY, KY	37.017164°, -88.912536°
1 1	ISSUE 1/2023 SUBMIT	ΓAL	
REVISION	ISSUE		
DRAWN BY PROJECT DRAWING EXIST CONE	NO.: 2 TITLE	1067	BY:ET
	NUMBER		


LEGEND

----- PROPERTY LINE

GAS GAS GAS LINE

EXISTING ROAD

FEMA FLOOD ZONE A

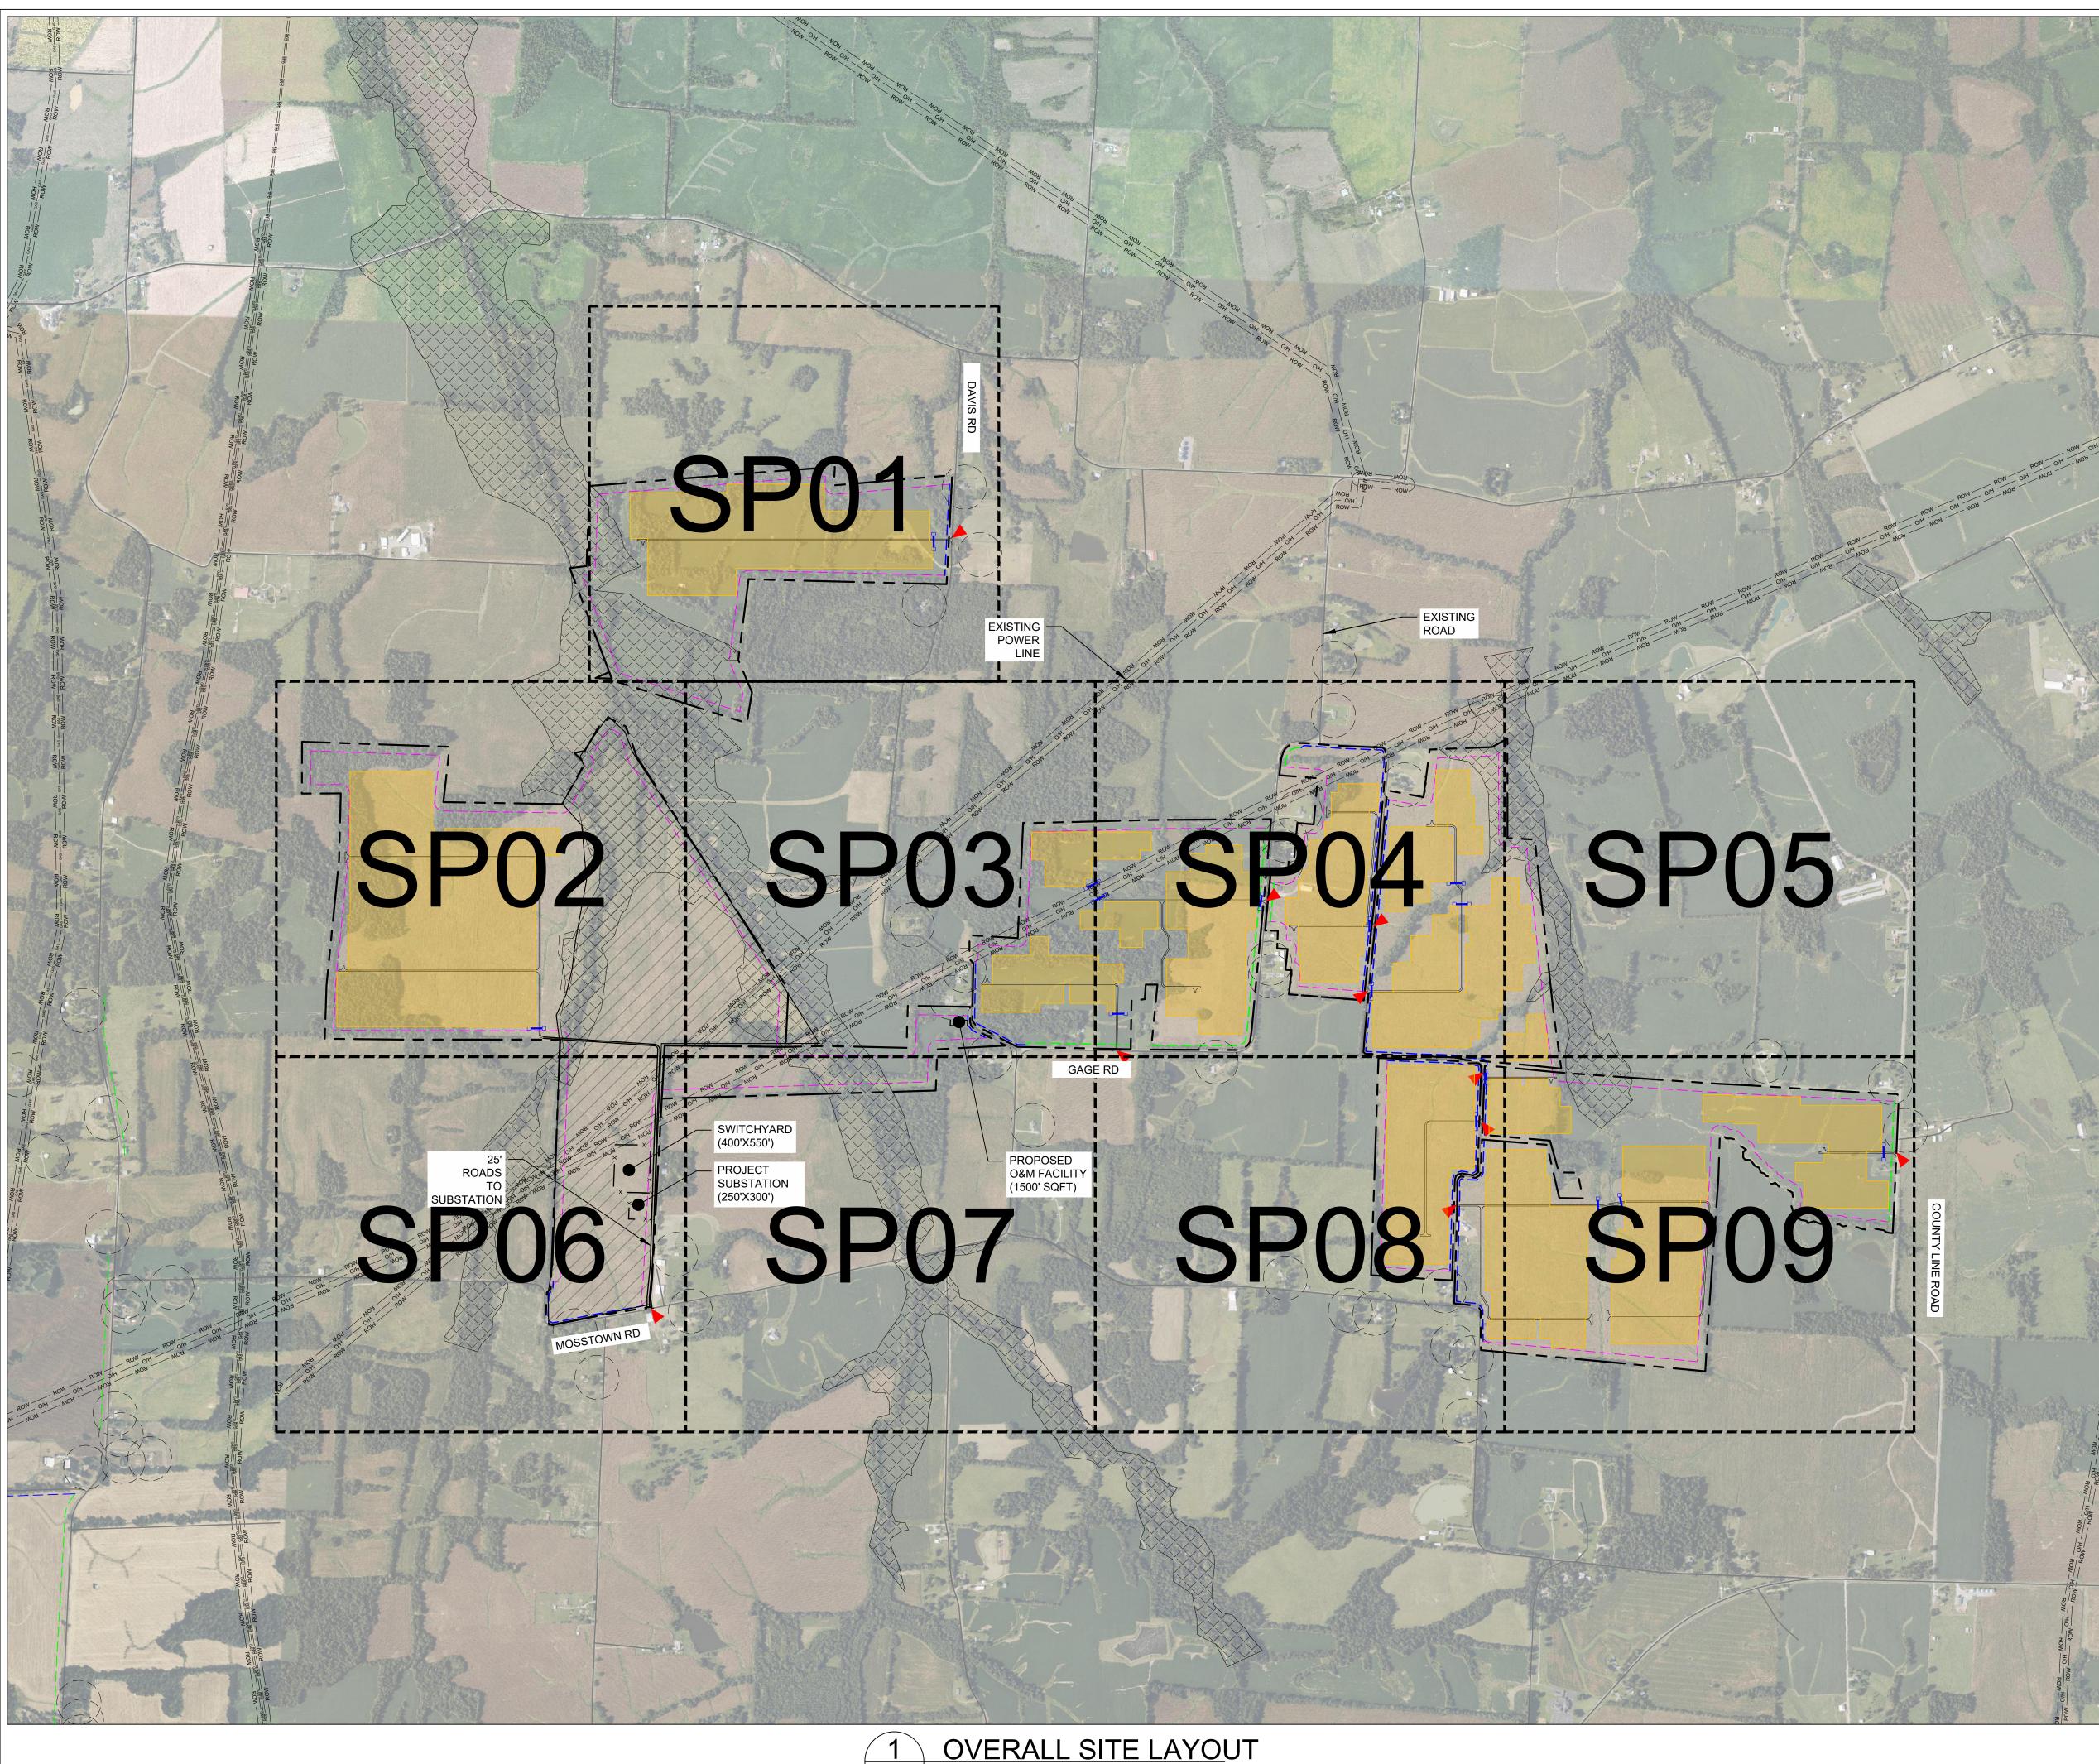

1" = 900'

0' 450' 900'

1800'

SHEET NOTES:

<u>LEGEND</u>

— x — x — FENCE LINE

GAS GAS GAS LINE

---- SETBACK

----- RIGHT OF WAY

XXXXXX

PROPERTY LINE

PROPOSED ROAD

EXISTING ROAD

----- O/H ----- EXISTING OVERHEAD ELECTRICAL

---- 25' SECONDARY ROAD SETBACK

50' PRIMARY ROAD SETBACK

PROPERTY LINE SETBACK

EXCLUSION AREA

GATE

SITE ACCESS

FEMA FLOOD ZONE A

SOLAR PANEL AREAS

100' NON-PARTICIPATING LANDOWNER

- LOCATIONS SHOWN ARE FOR GENERAL GUIDANCE ONLY. SLOPES OF THE SITE ARE NOT DEPICTED AND LOCATIONS MUST BE VERIFIED ON SITE BEFORE INSTALLATION.
- FINAL STRING SIZING TO BE CONFIRMED BY ENGINEER-OF-RECORD.
 CROSSING LOCATIONS INDICATE APPROXIMATE ROAD AND DC CROSSINGS AT EXISTING FEATURES. MV COLLECTION CROSSINGS ARE TBD AFTER MV COLLECTION LAYOUT. ALL CROSSINGS TO BE FINALIZED BY ENGINEER OF RECORD.
- 4. SITE IS IN FEMA FLOOD ZONE A AND X.





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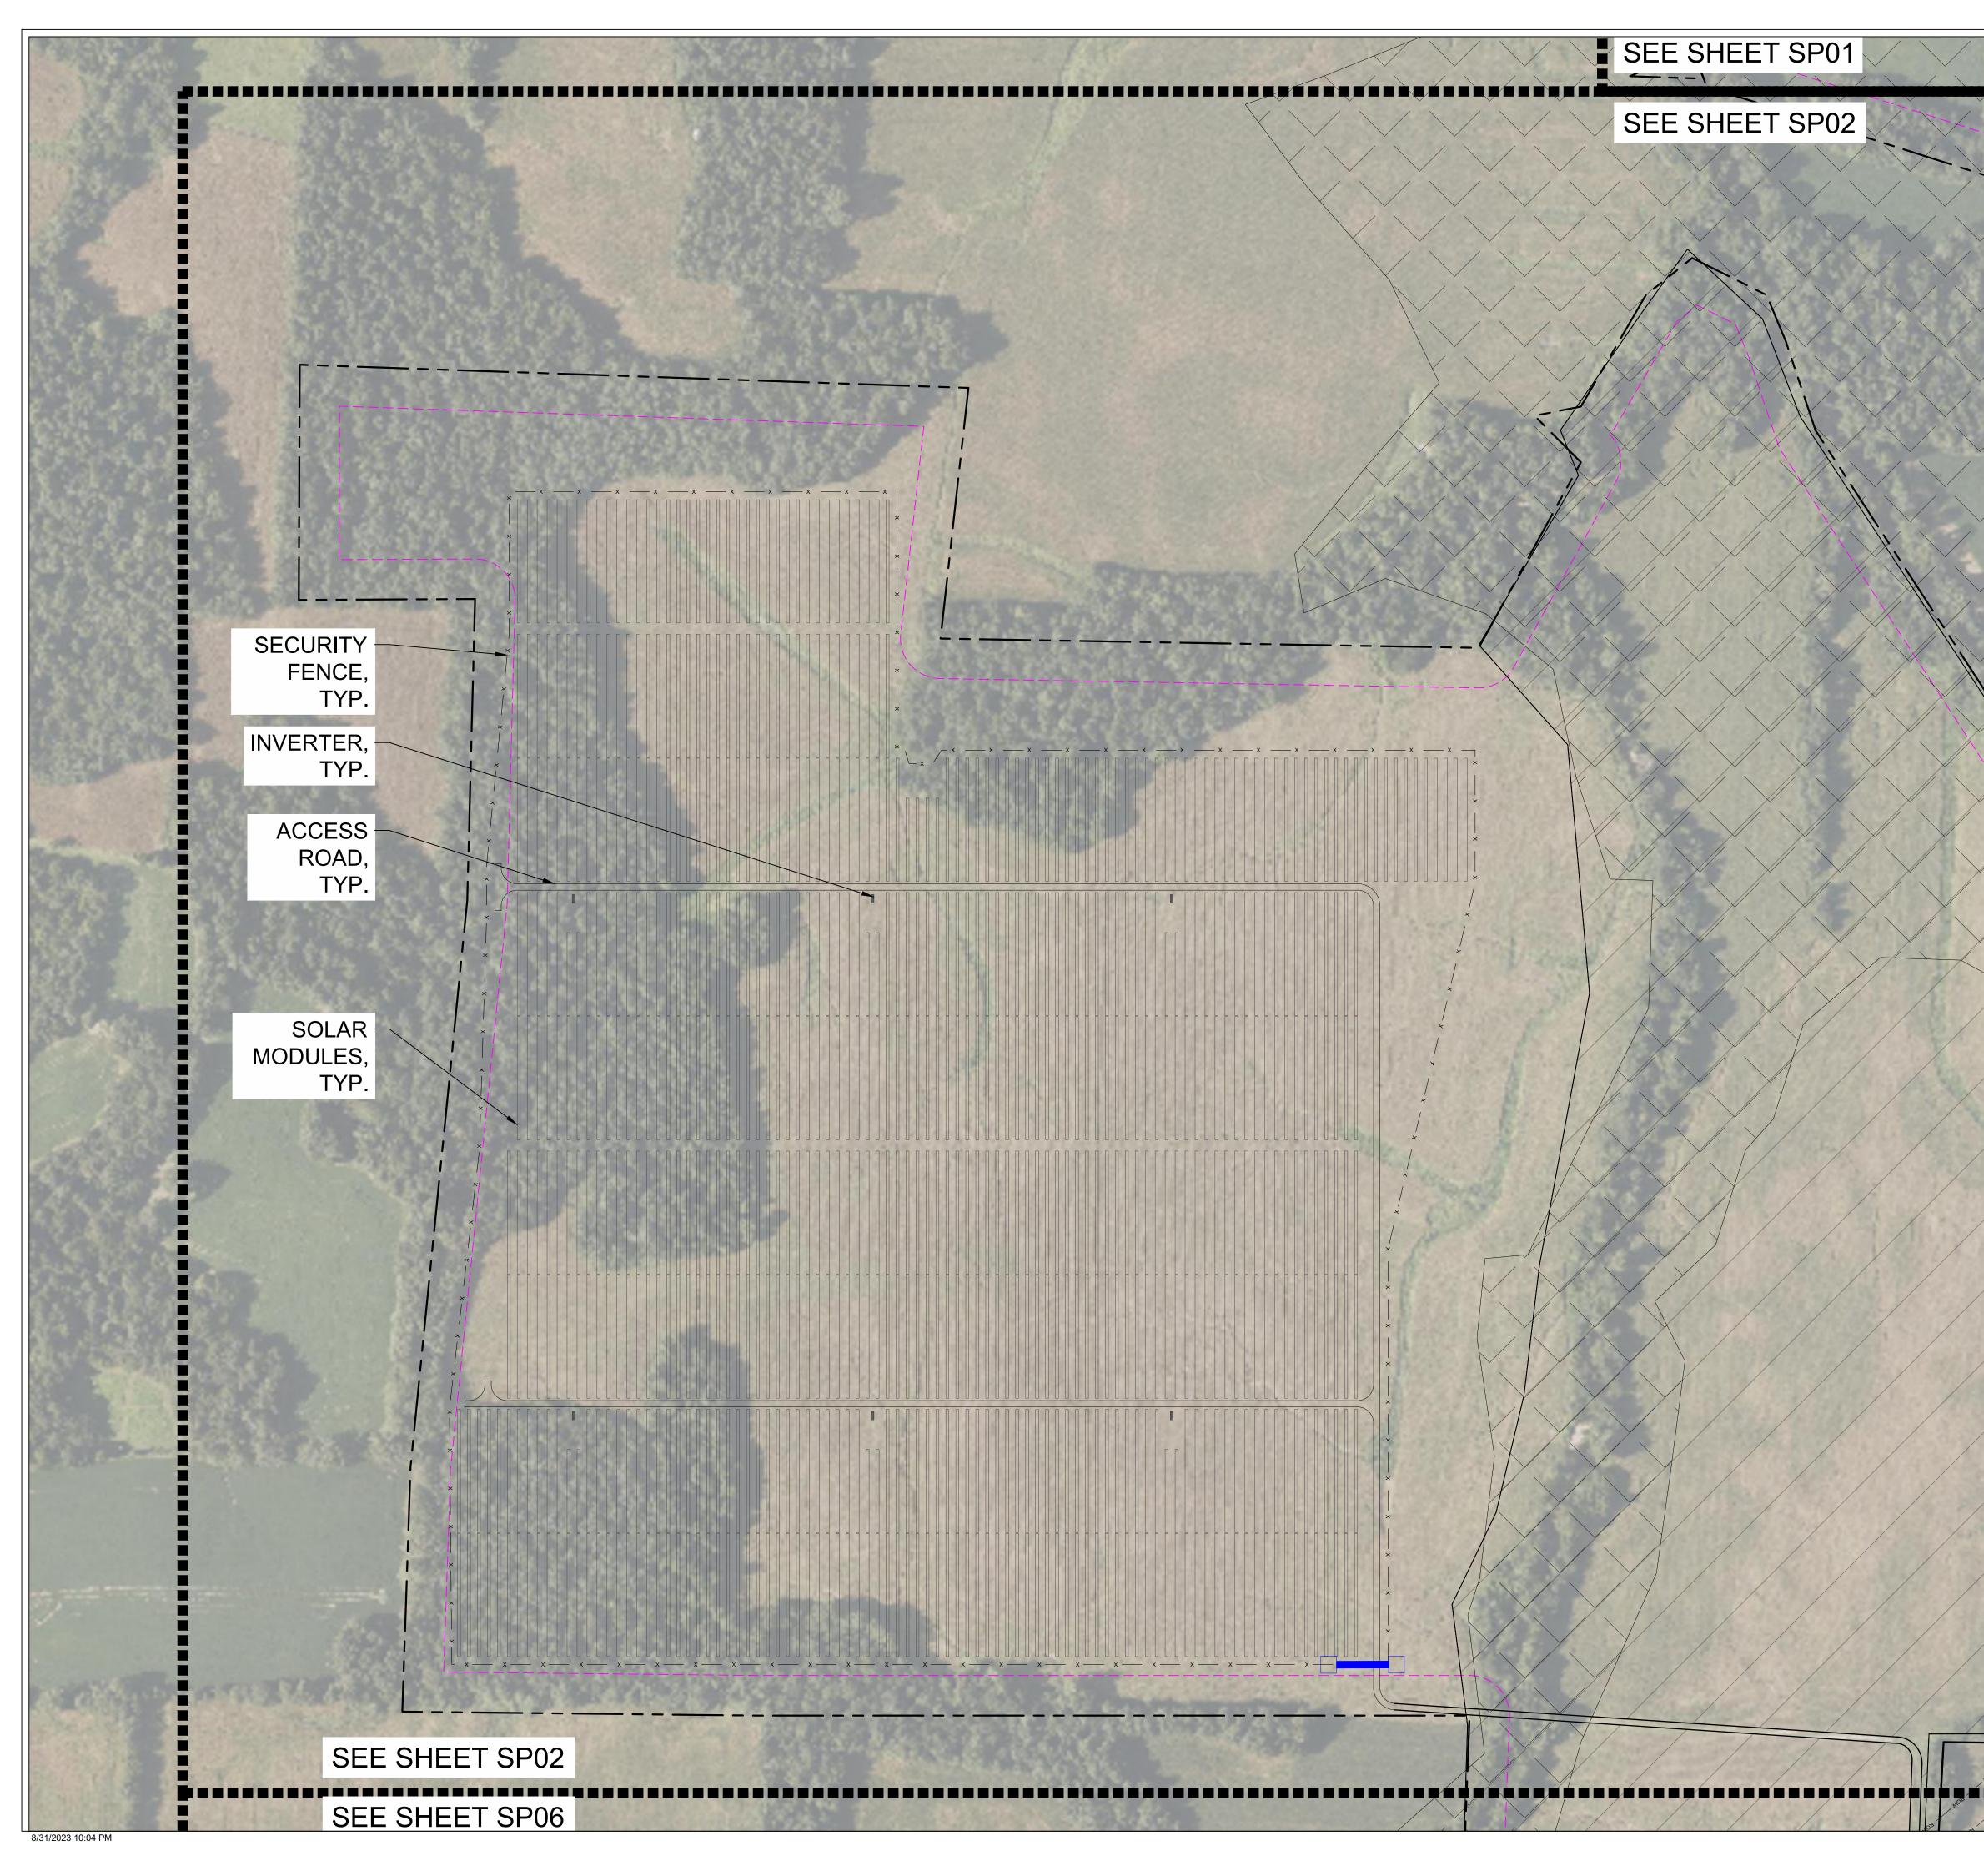








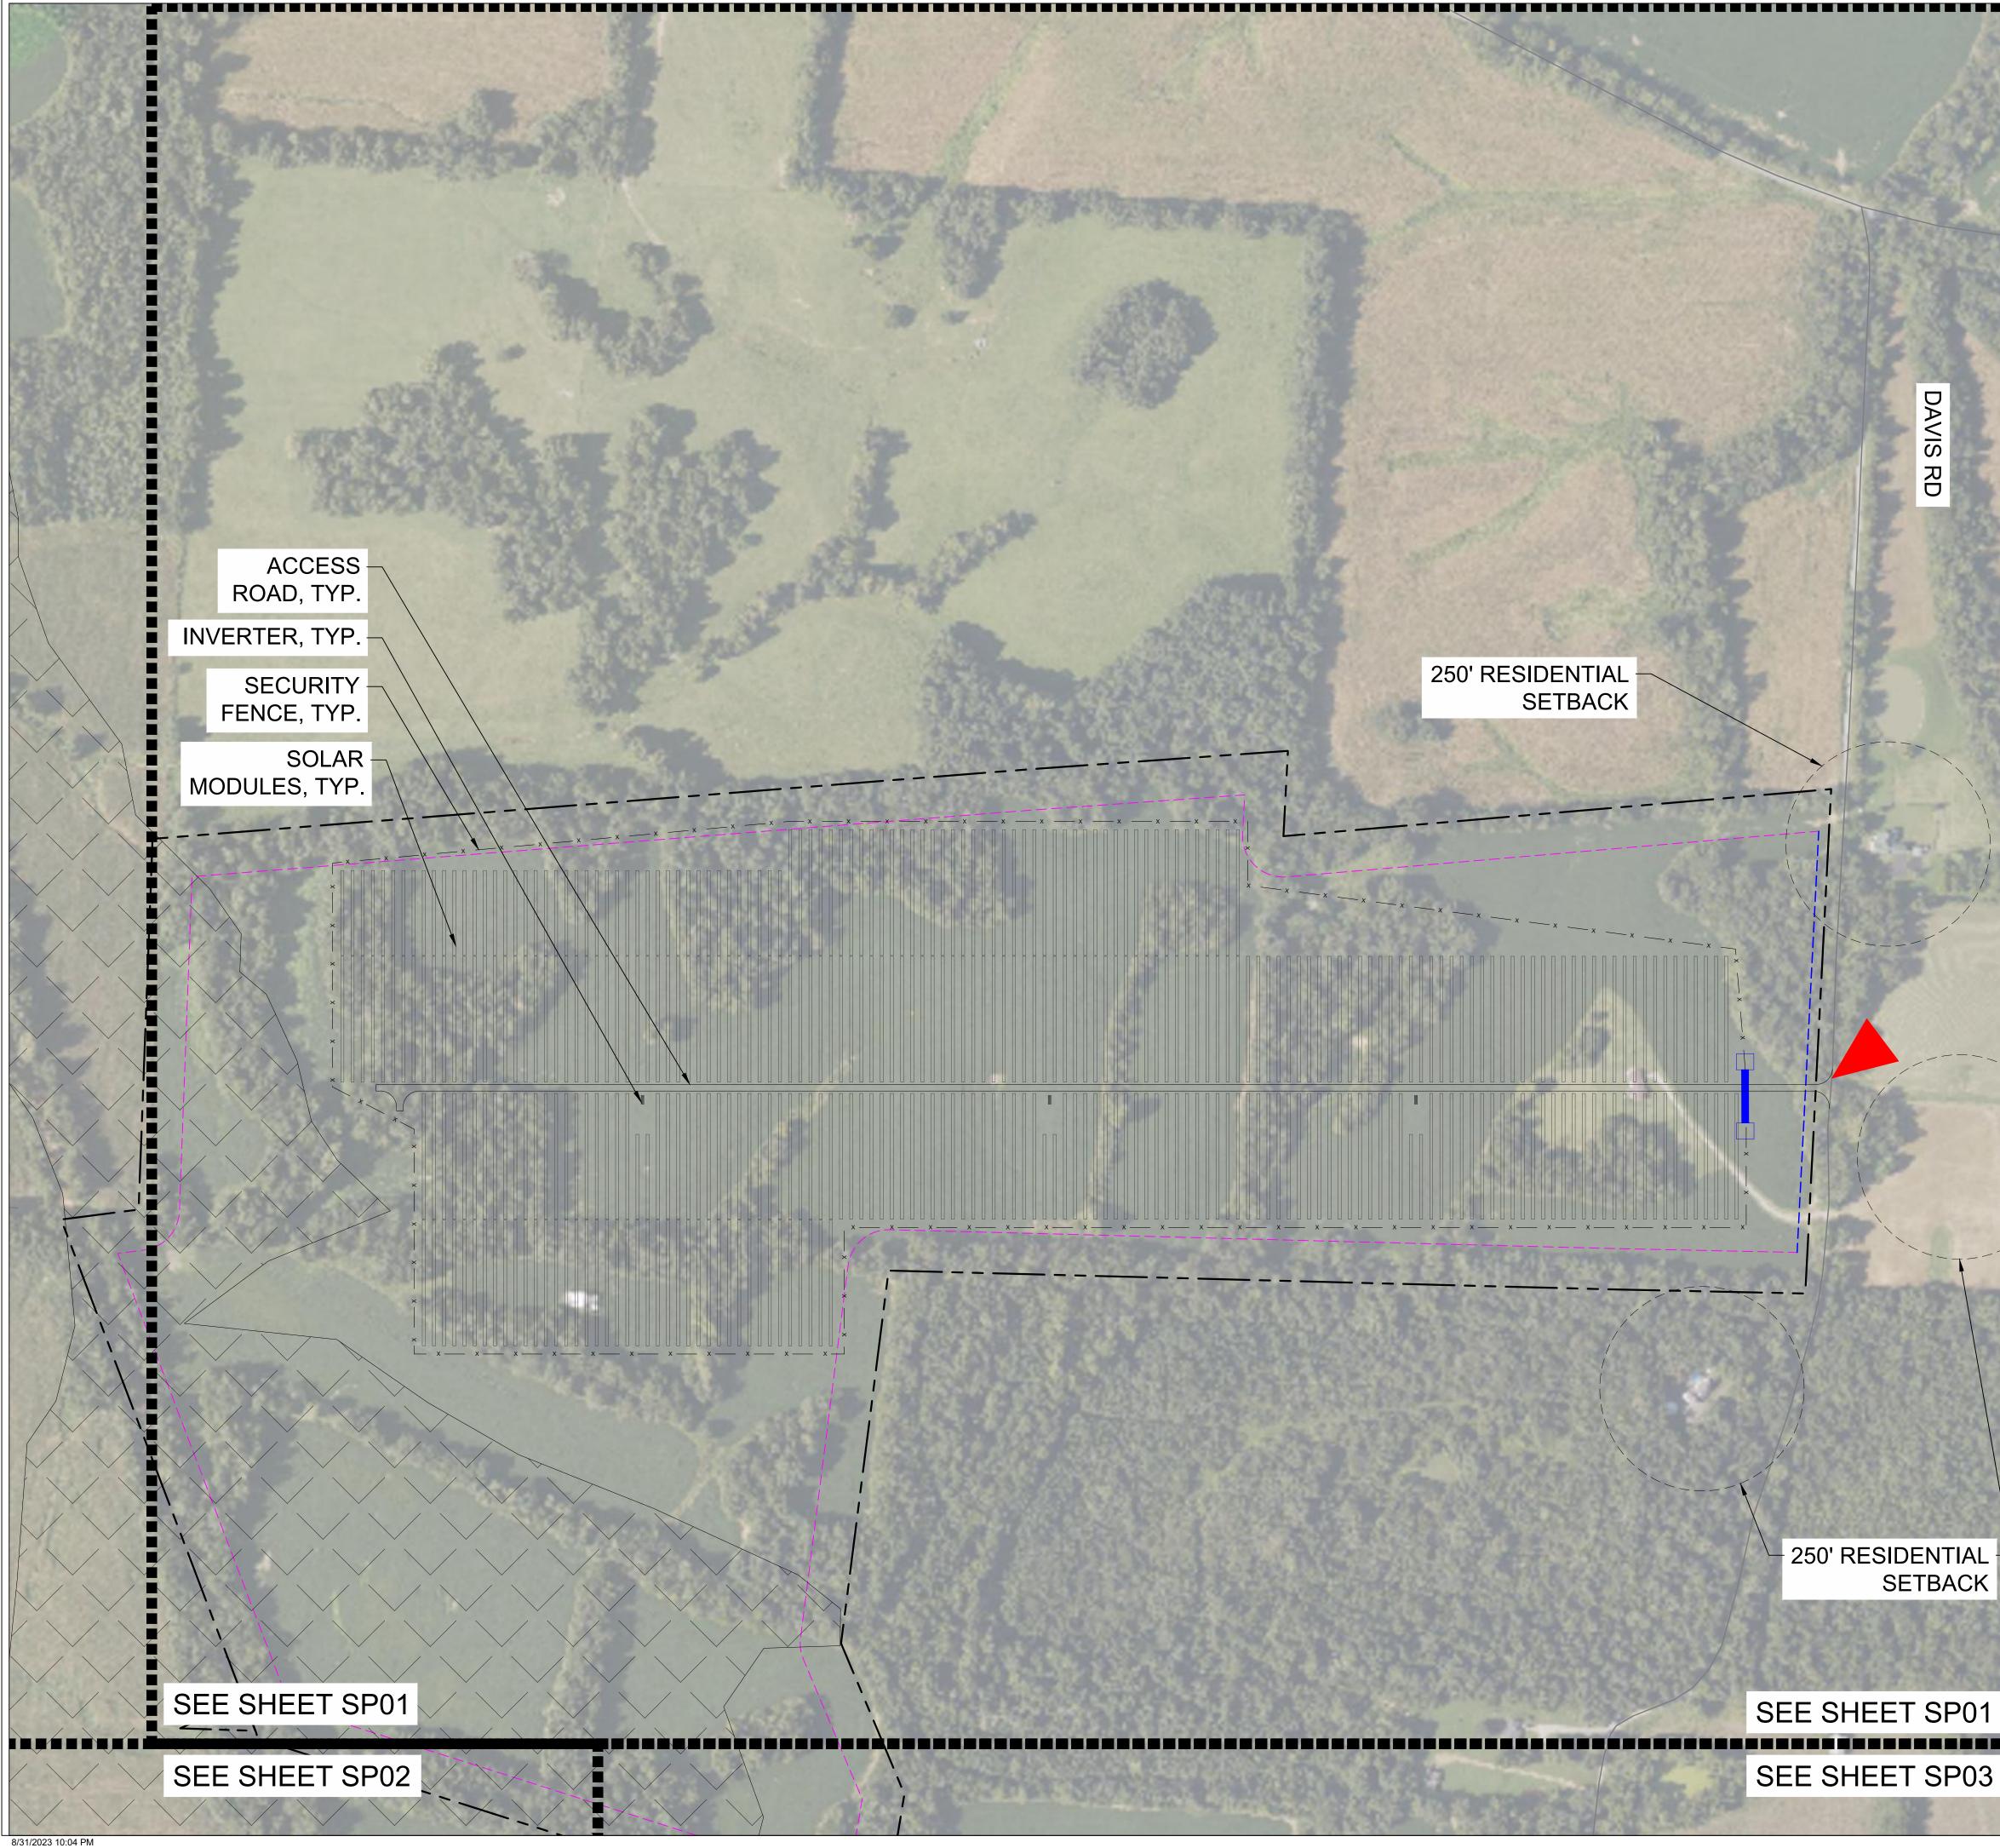



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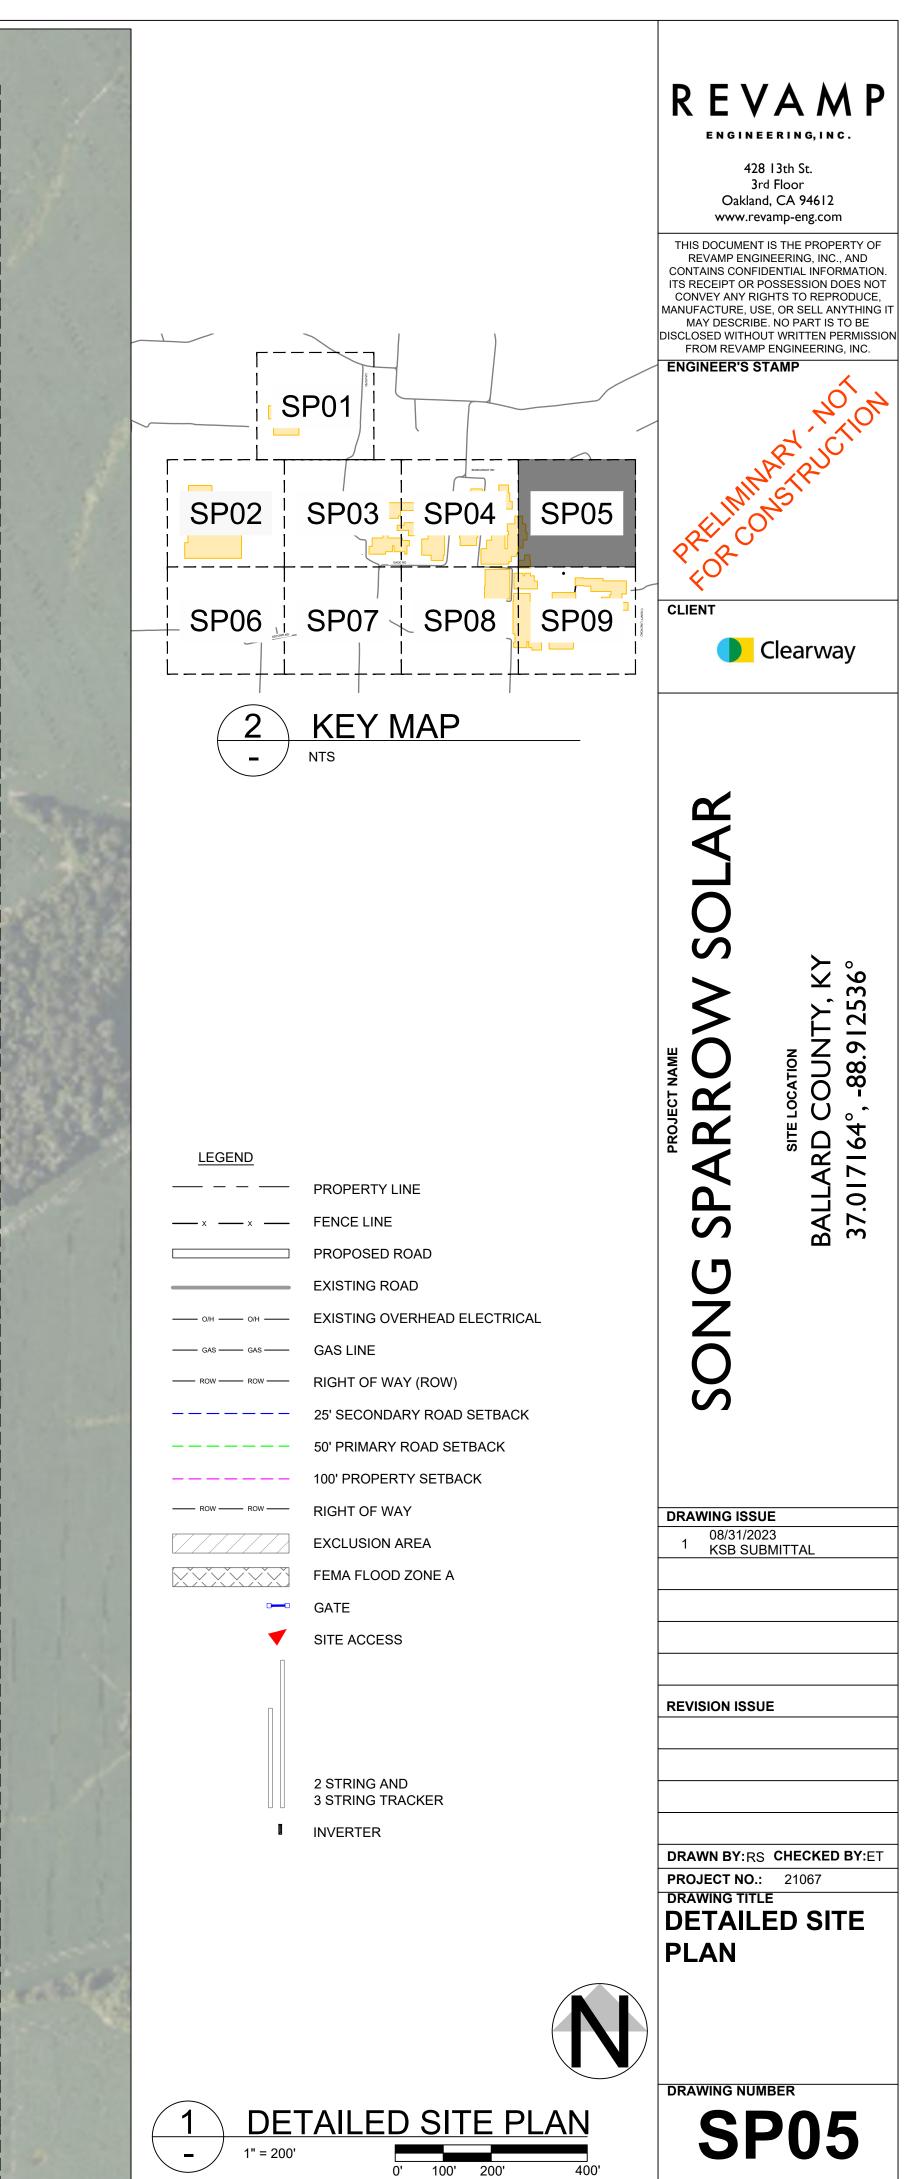


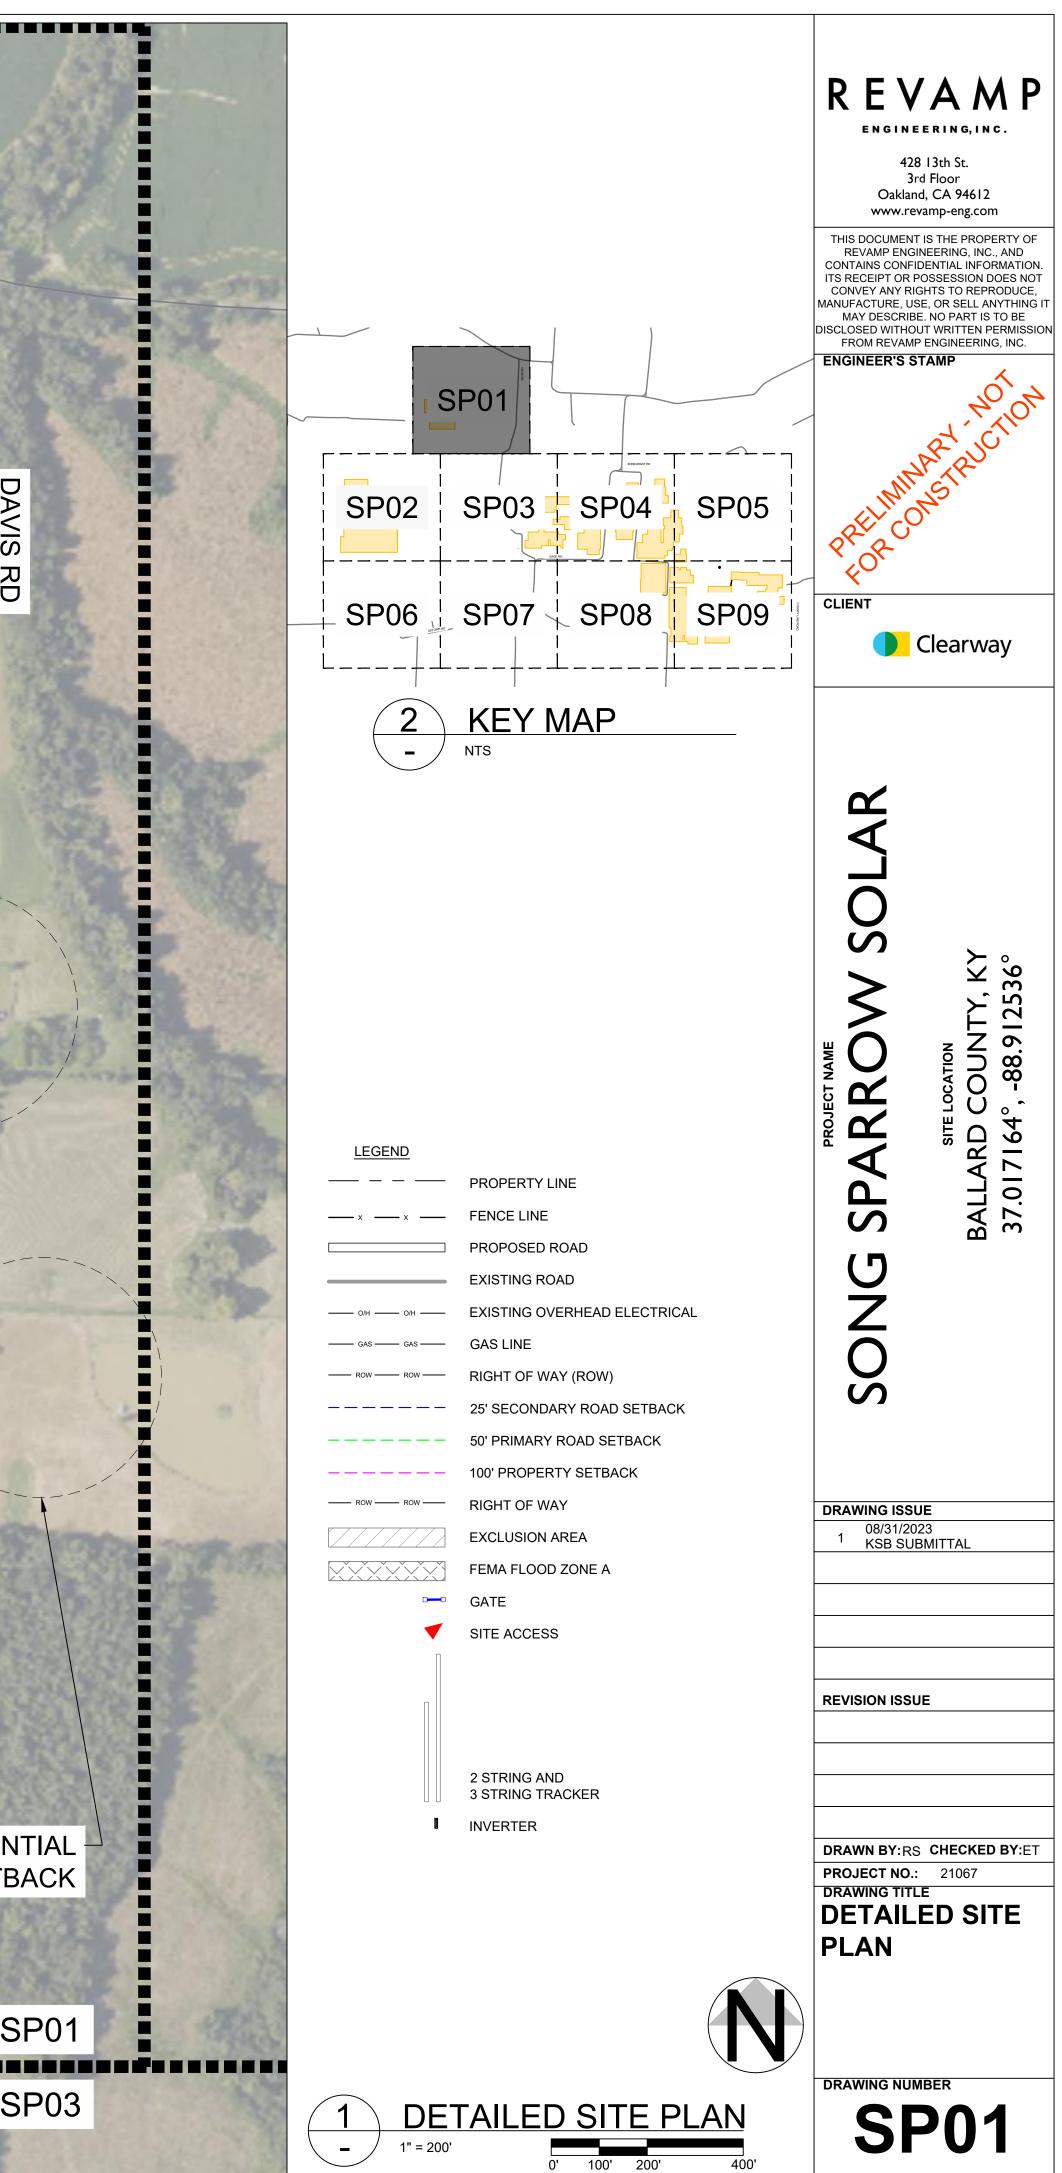

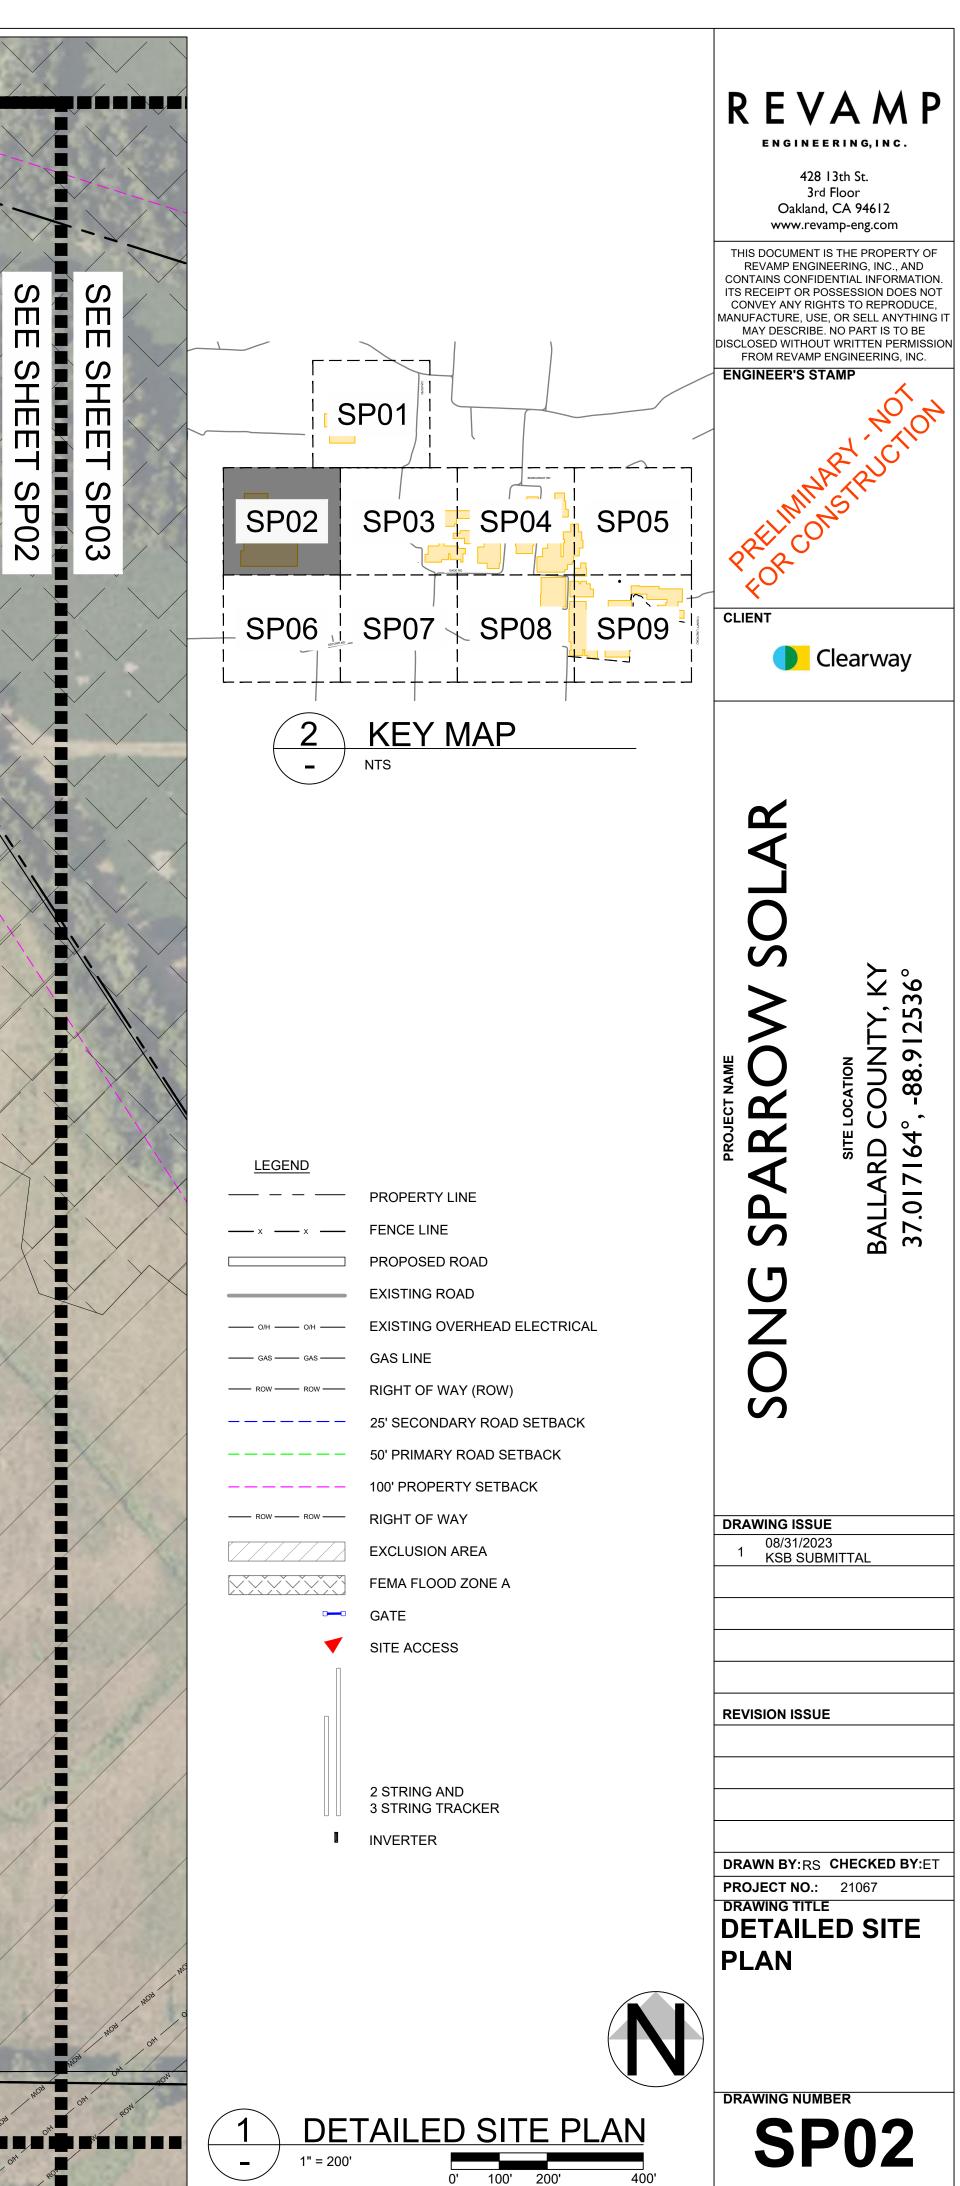


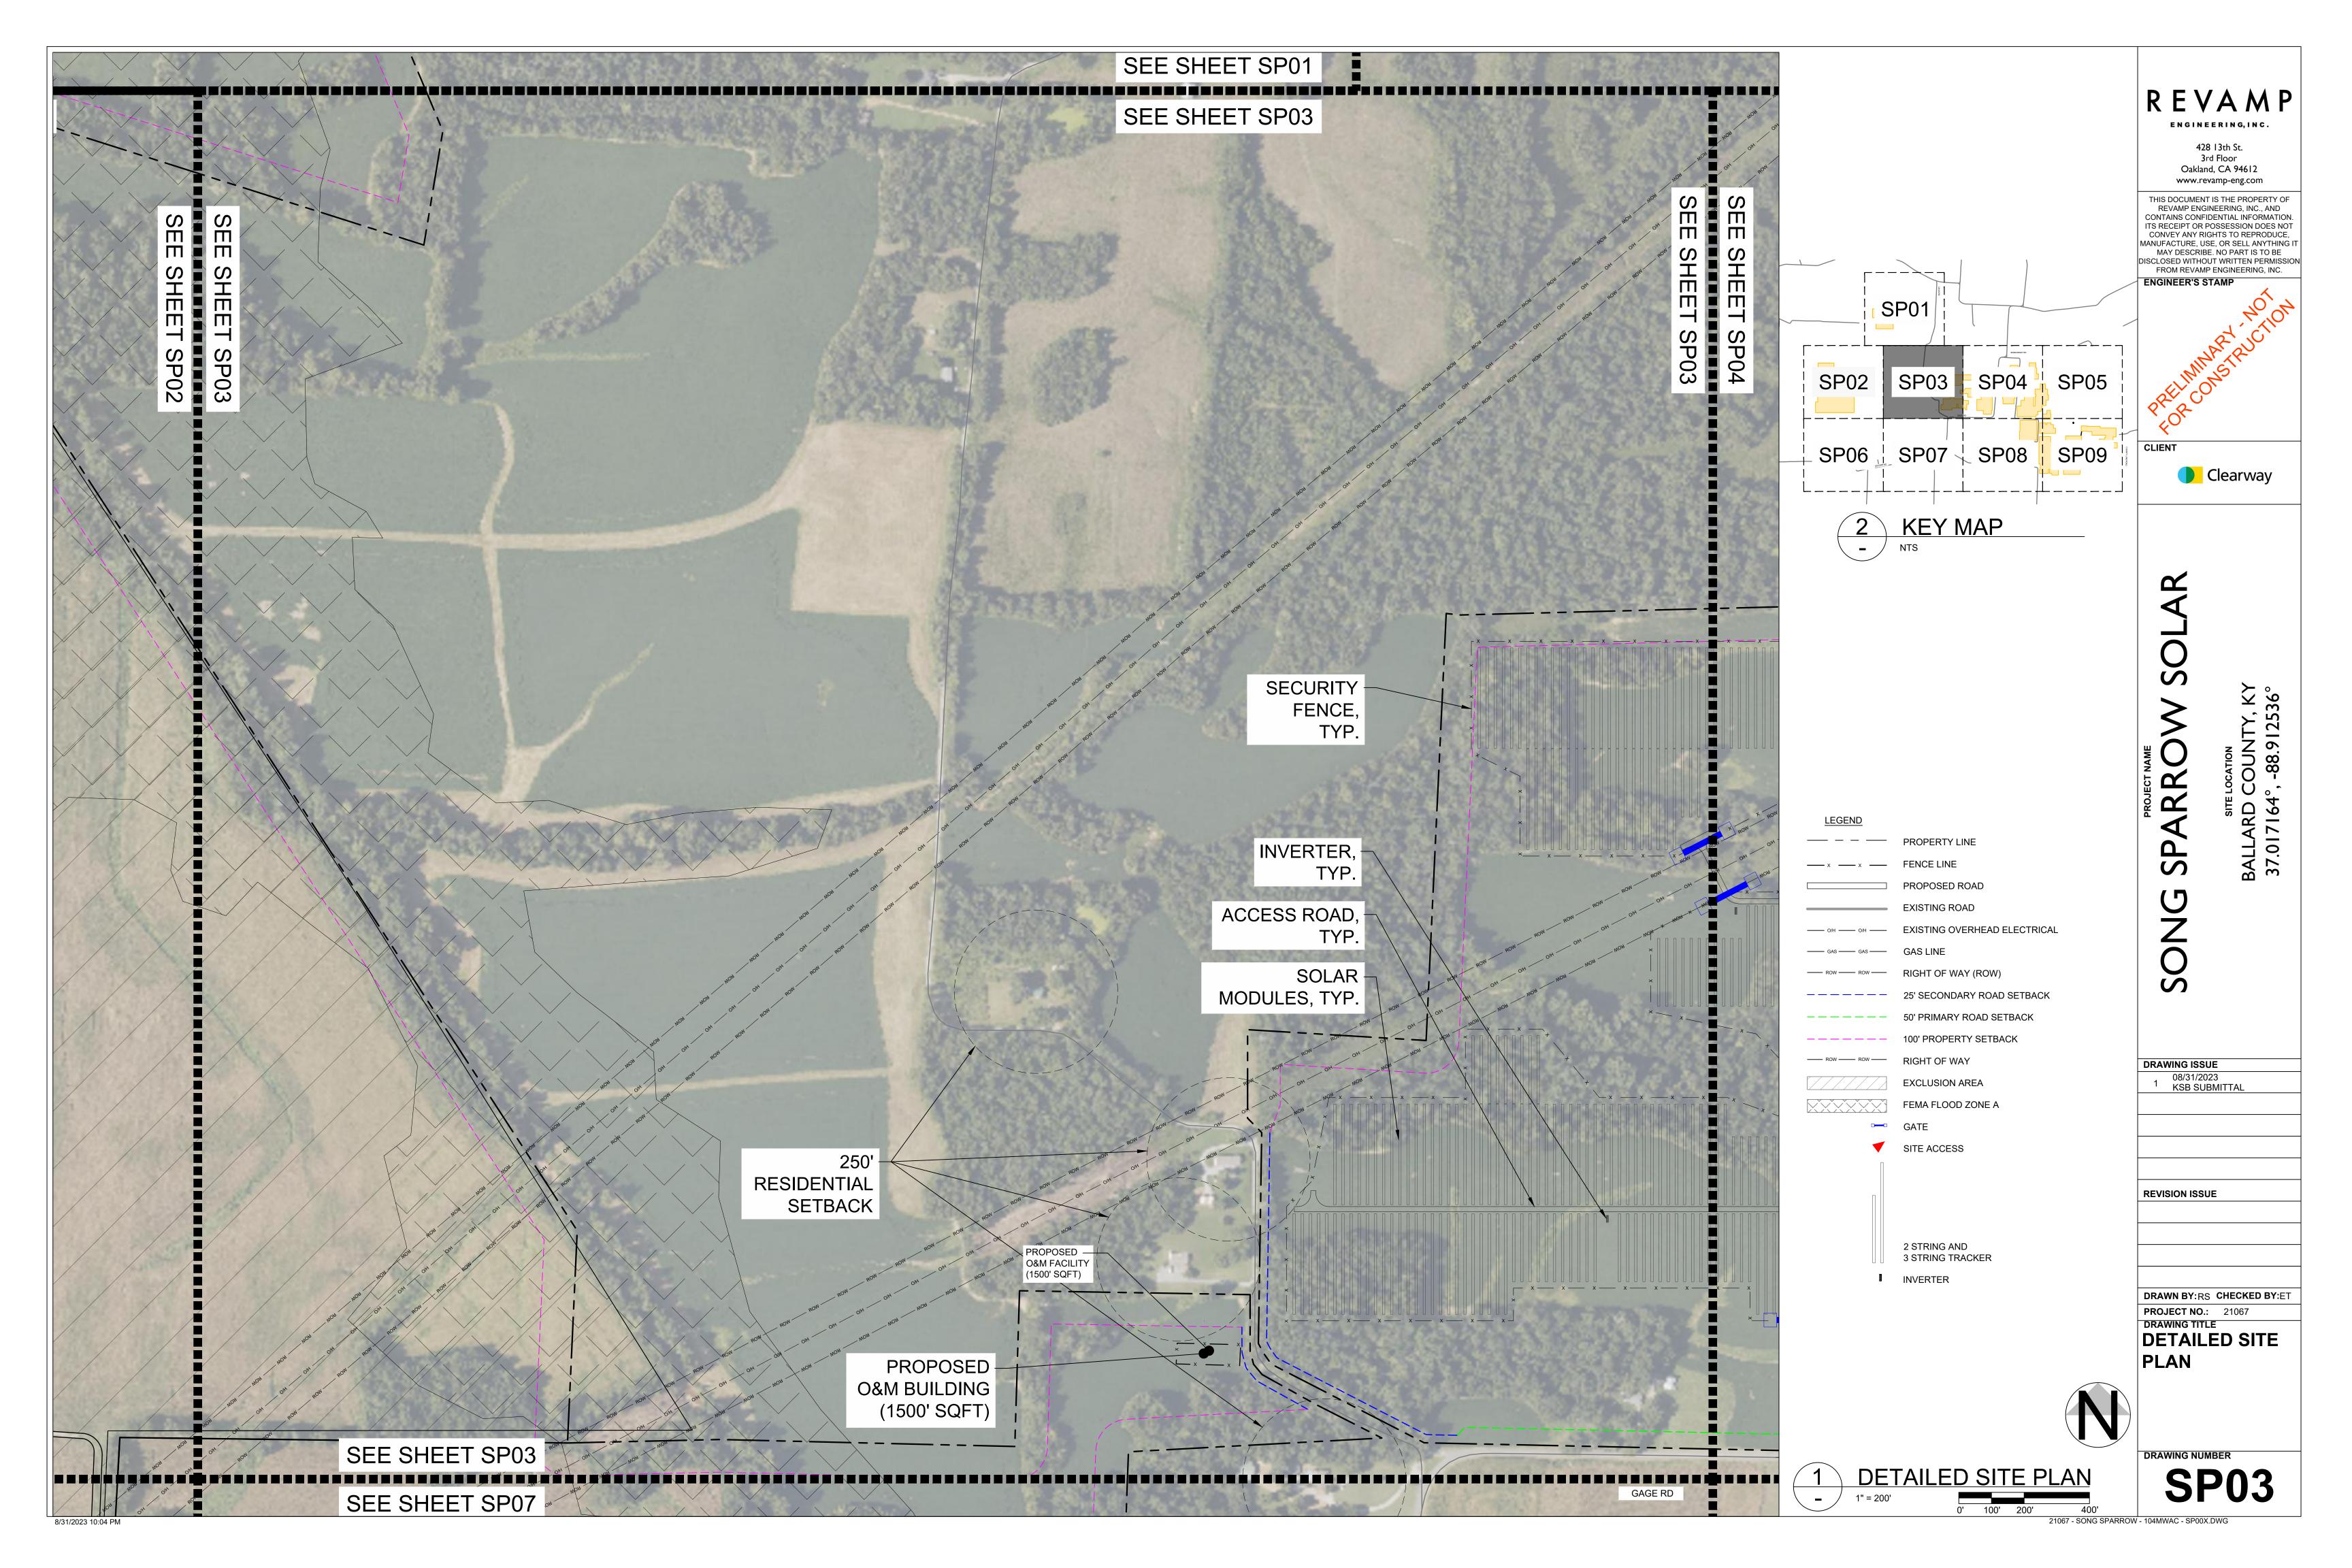


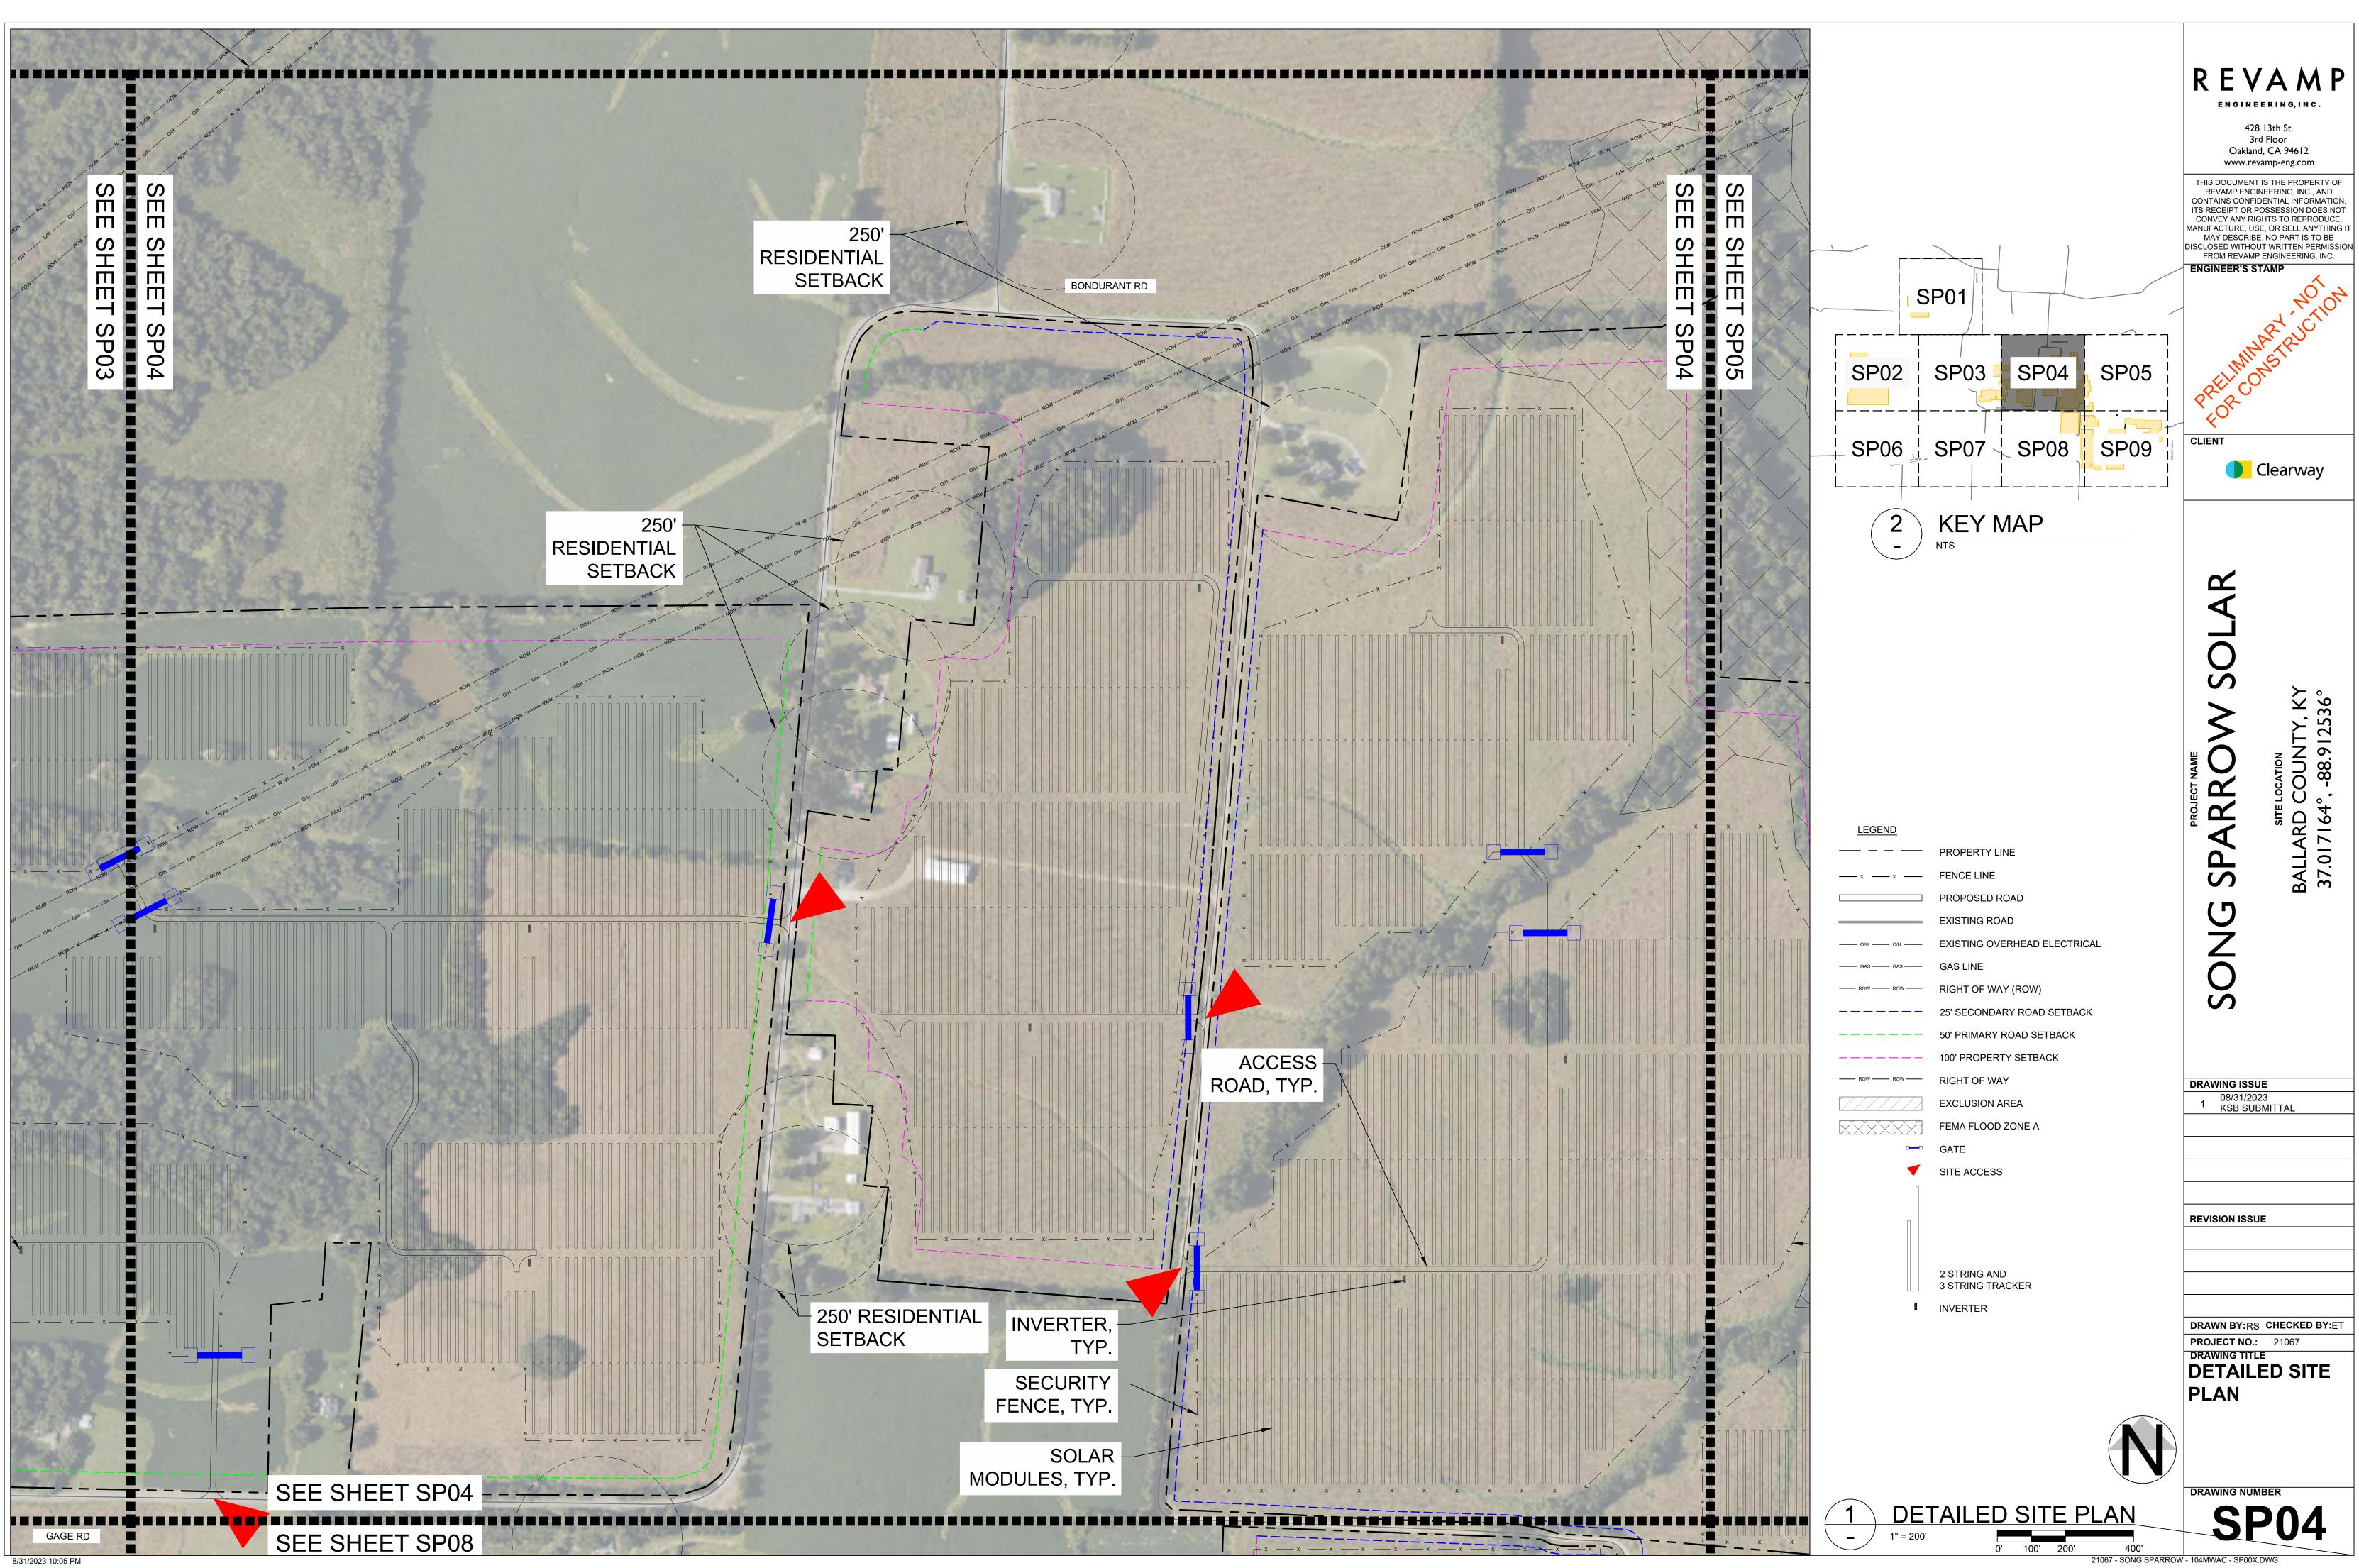


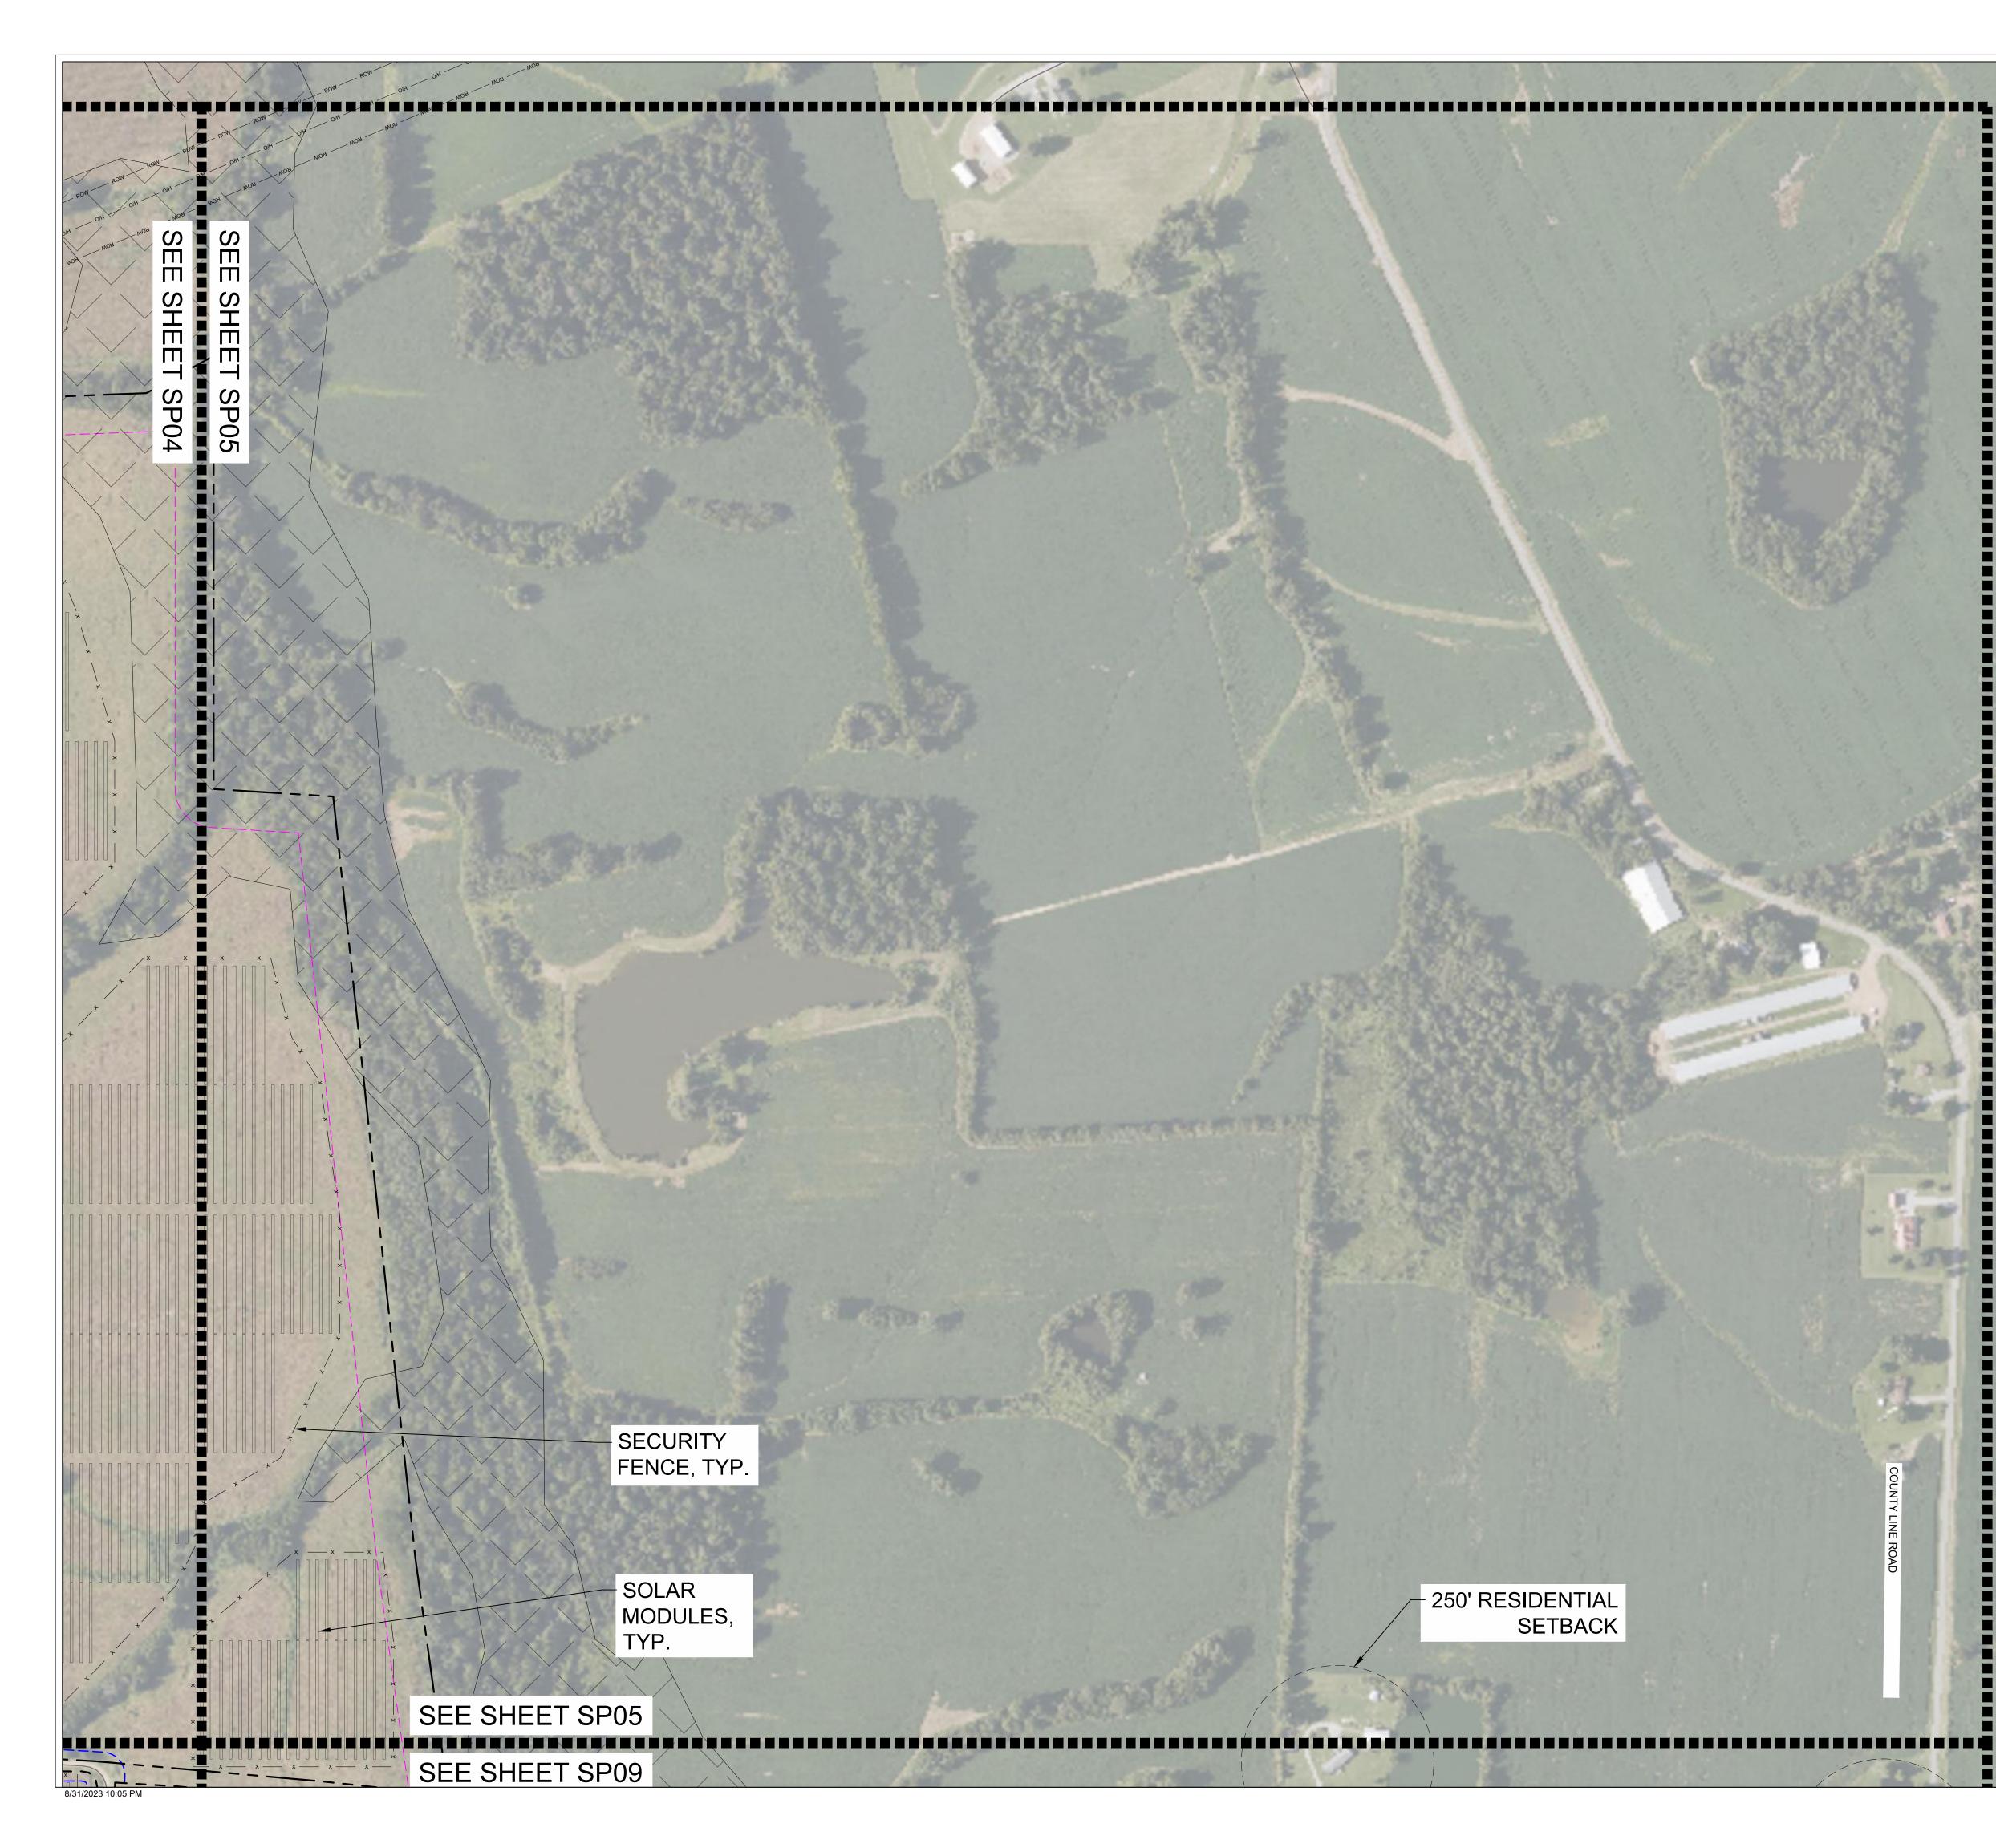





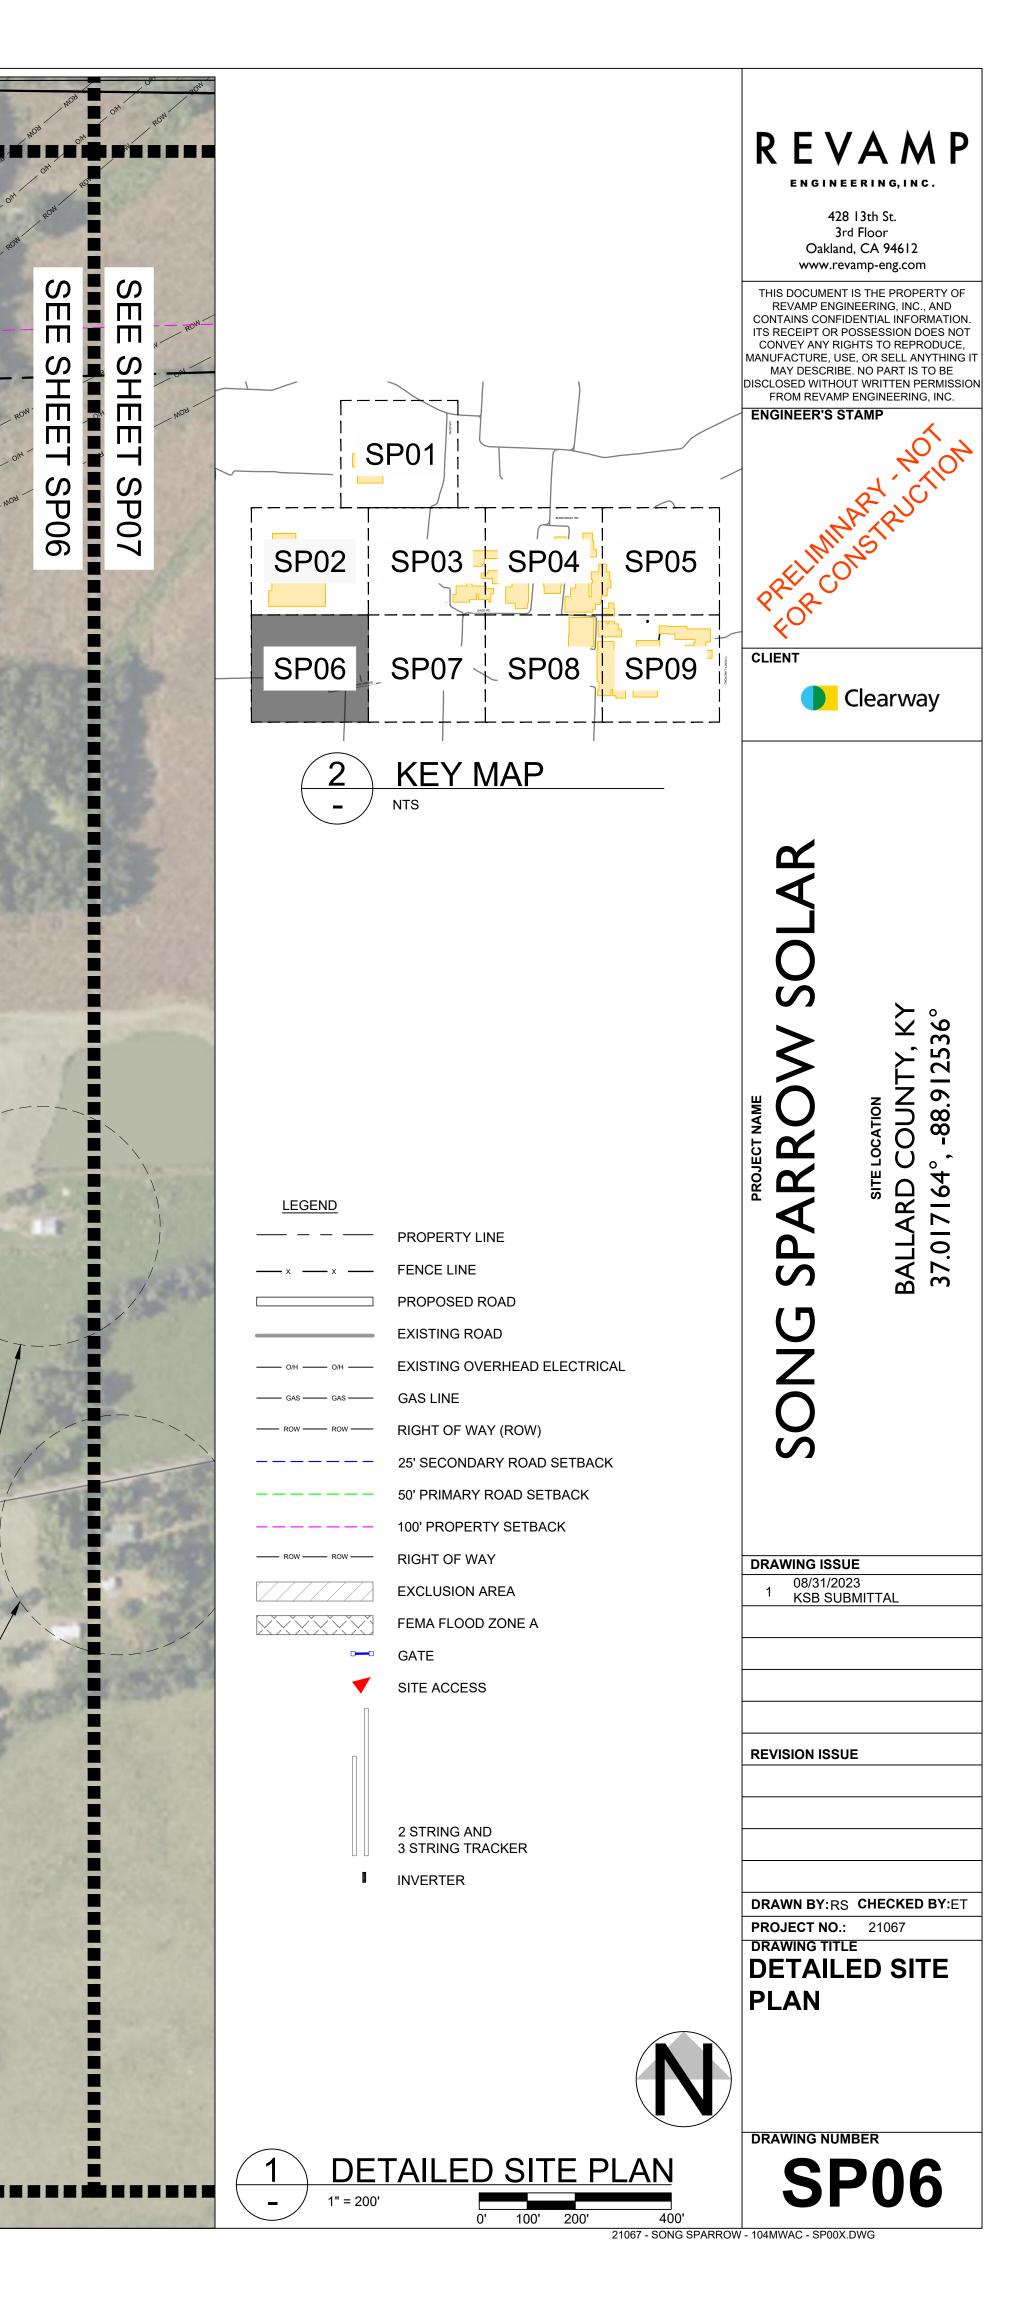


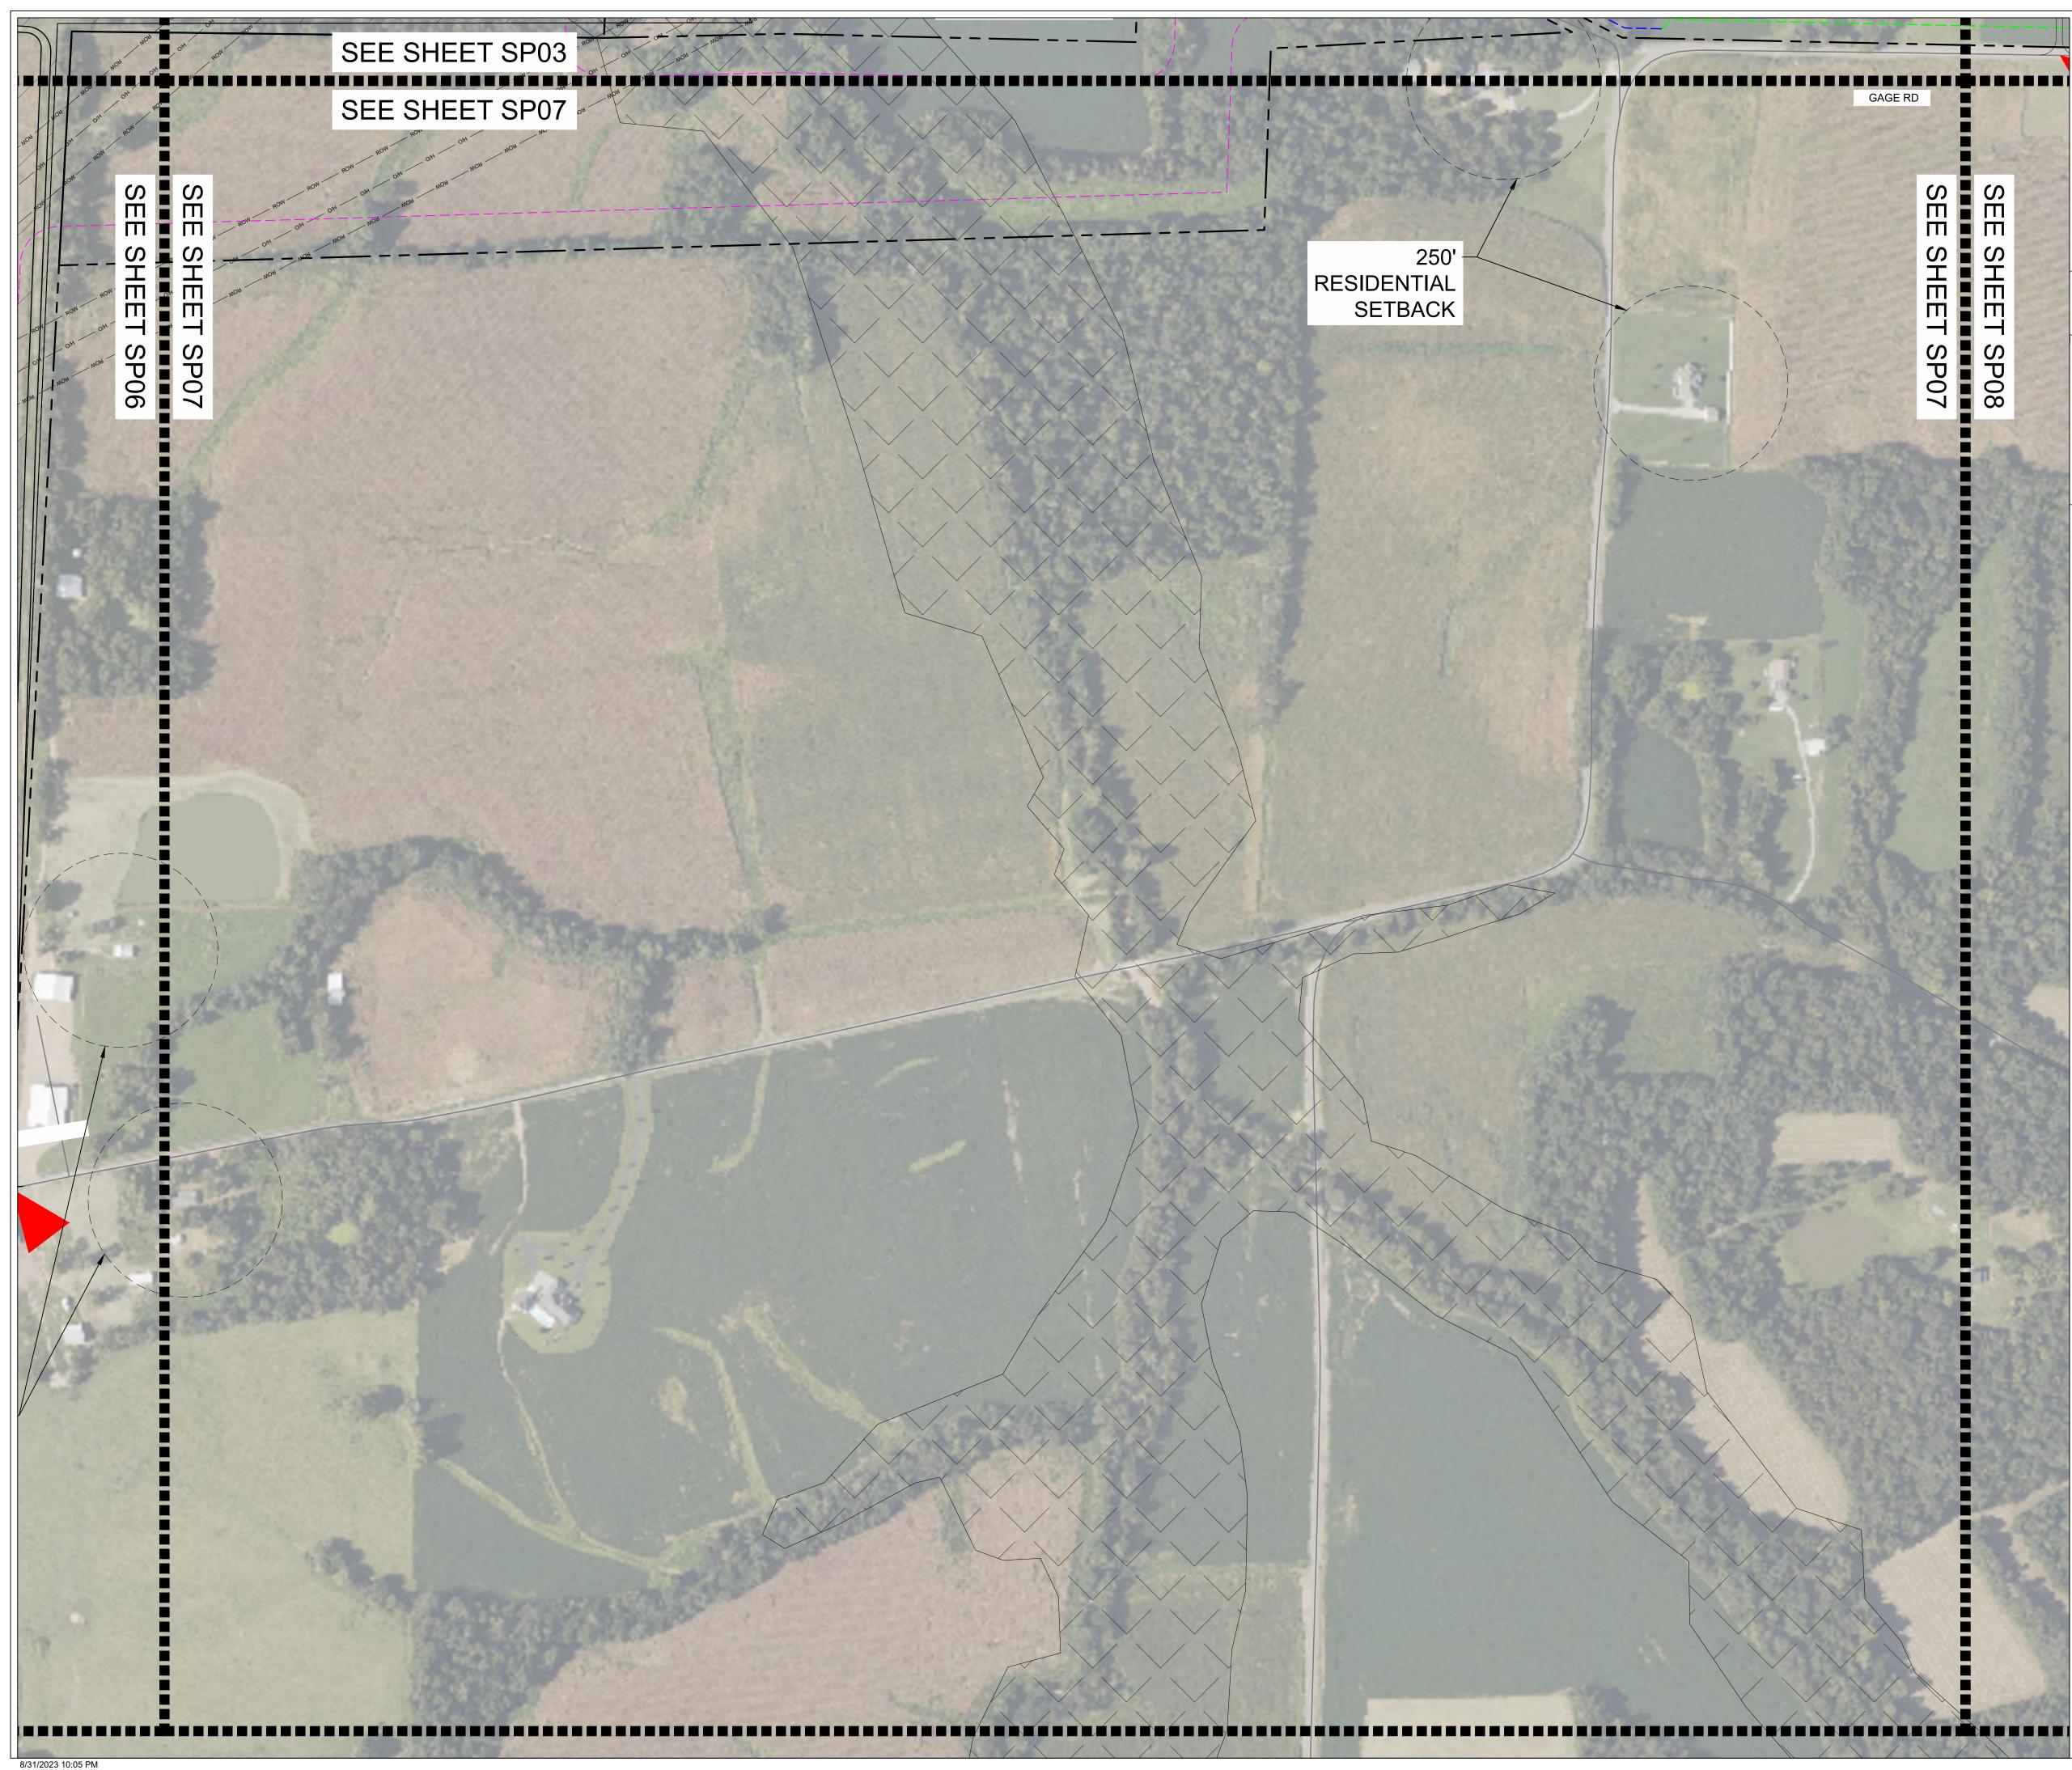

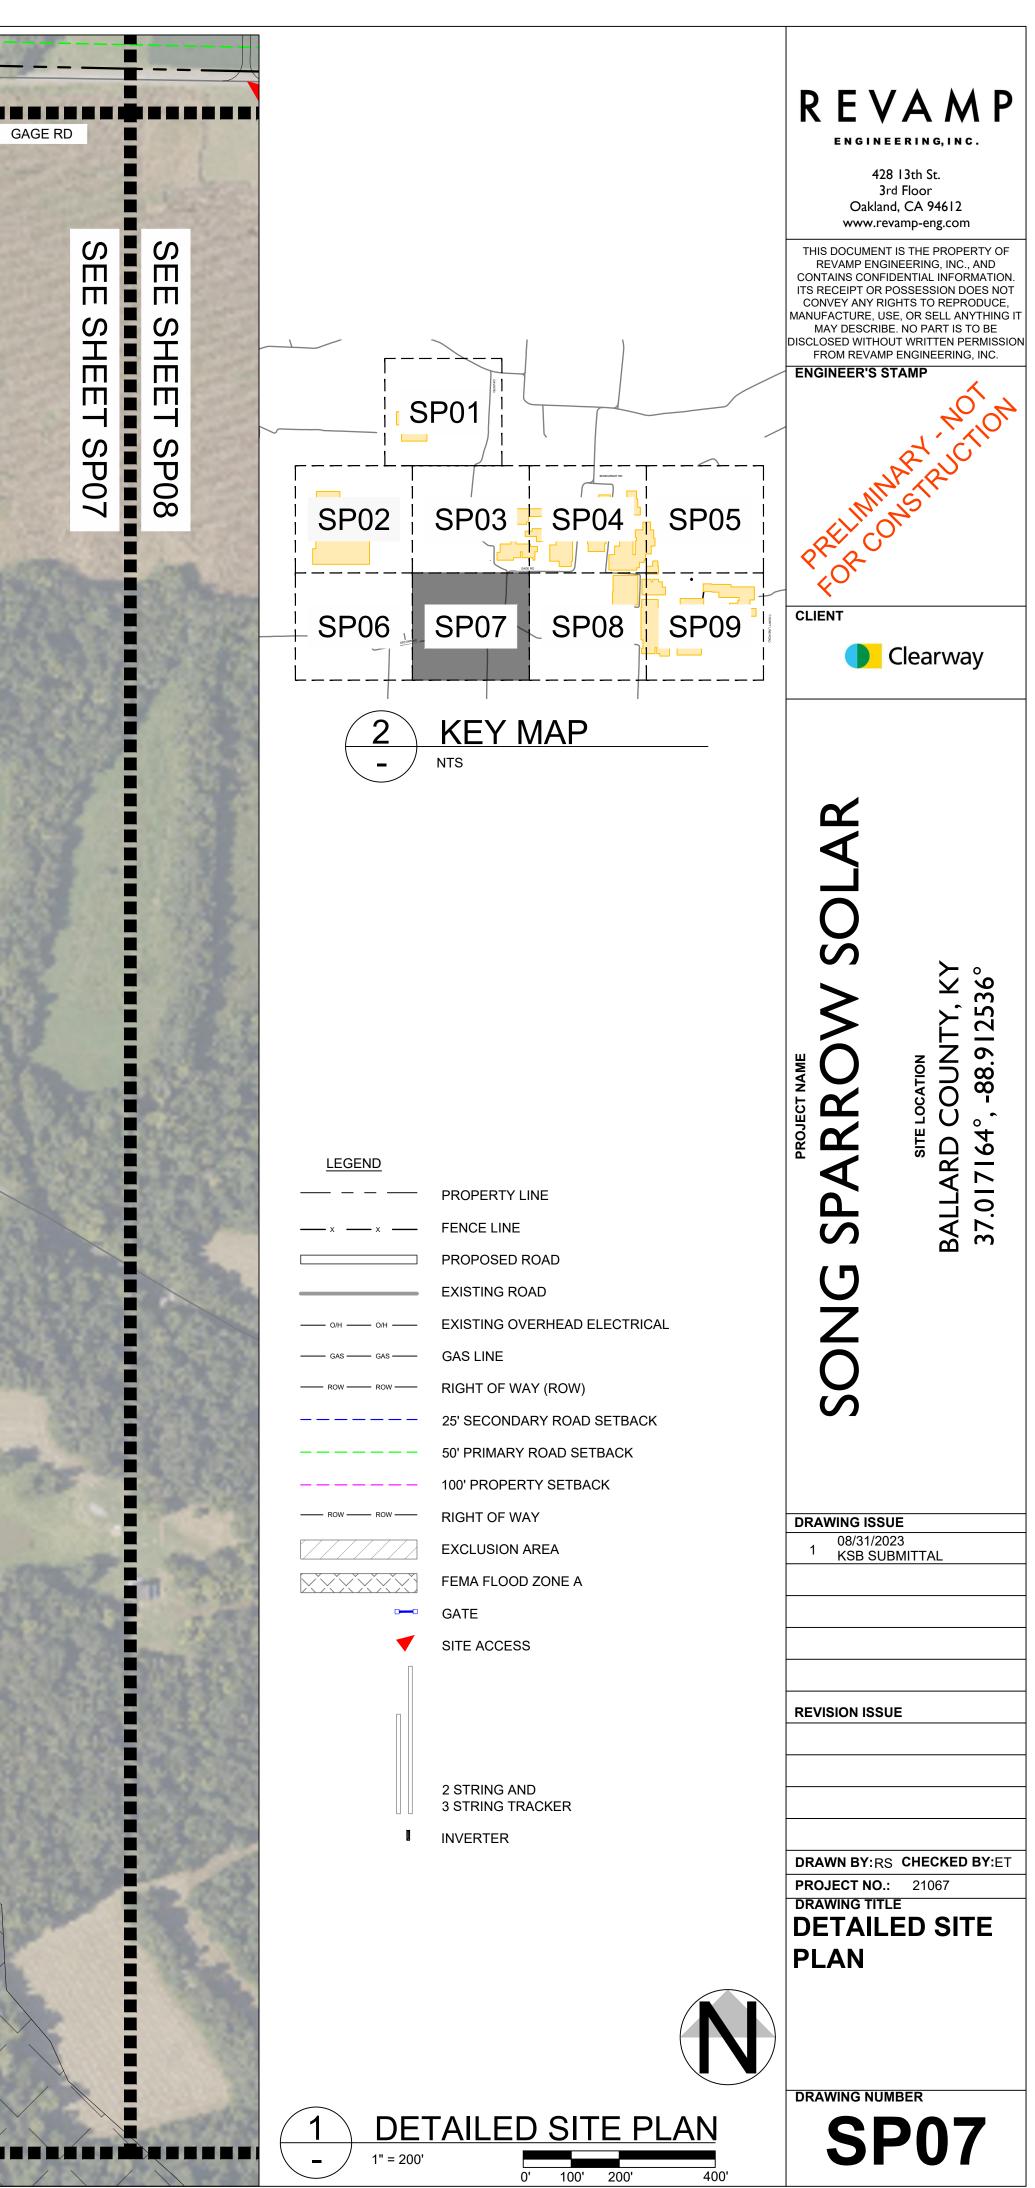


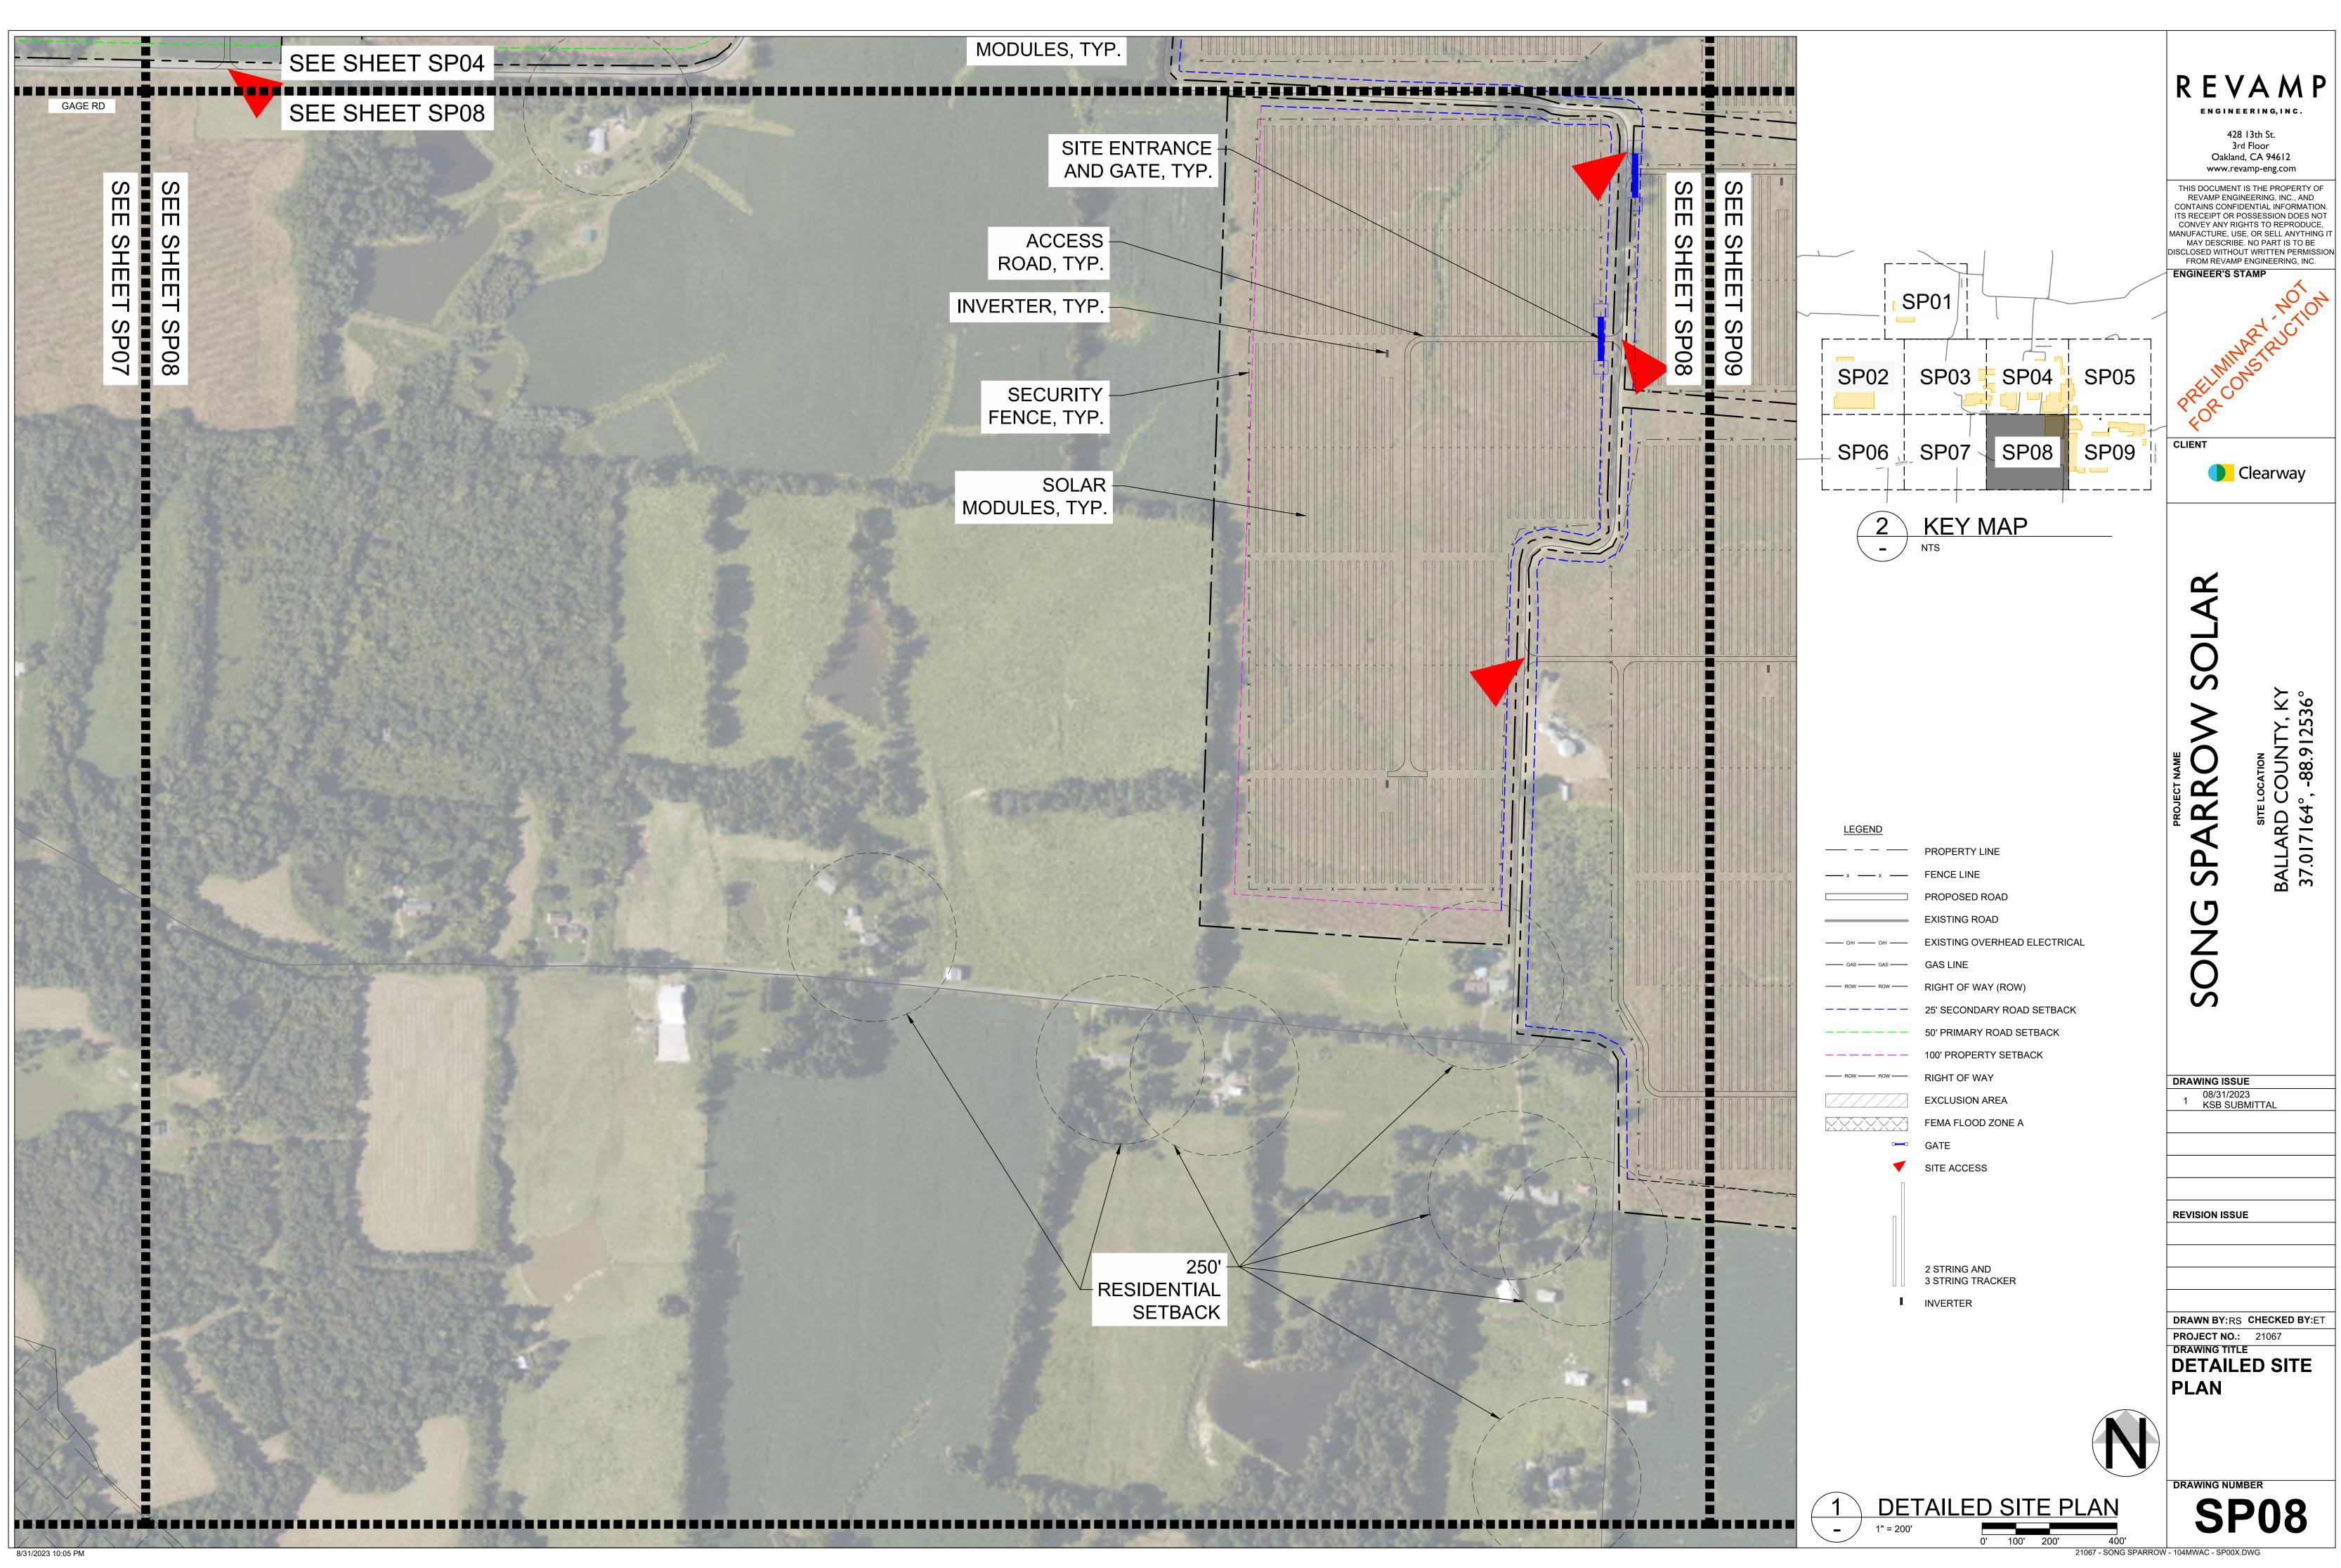

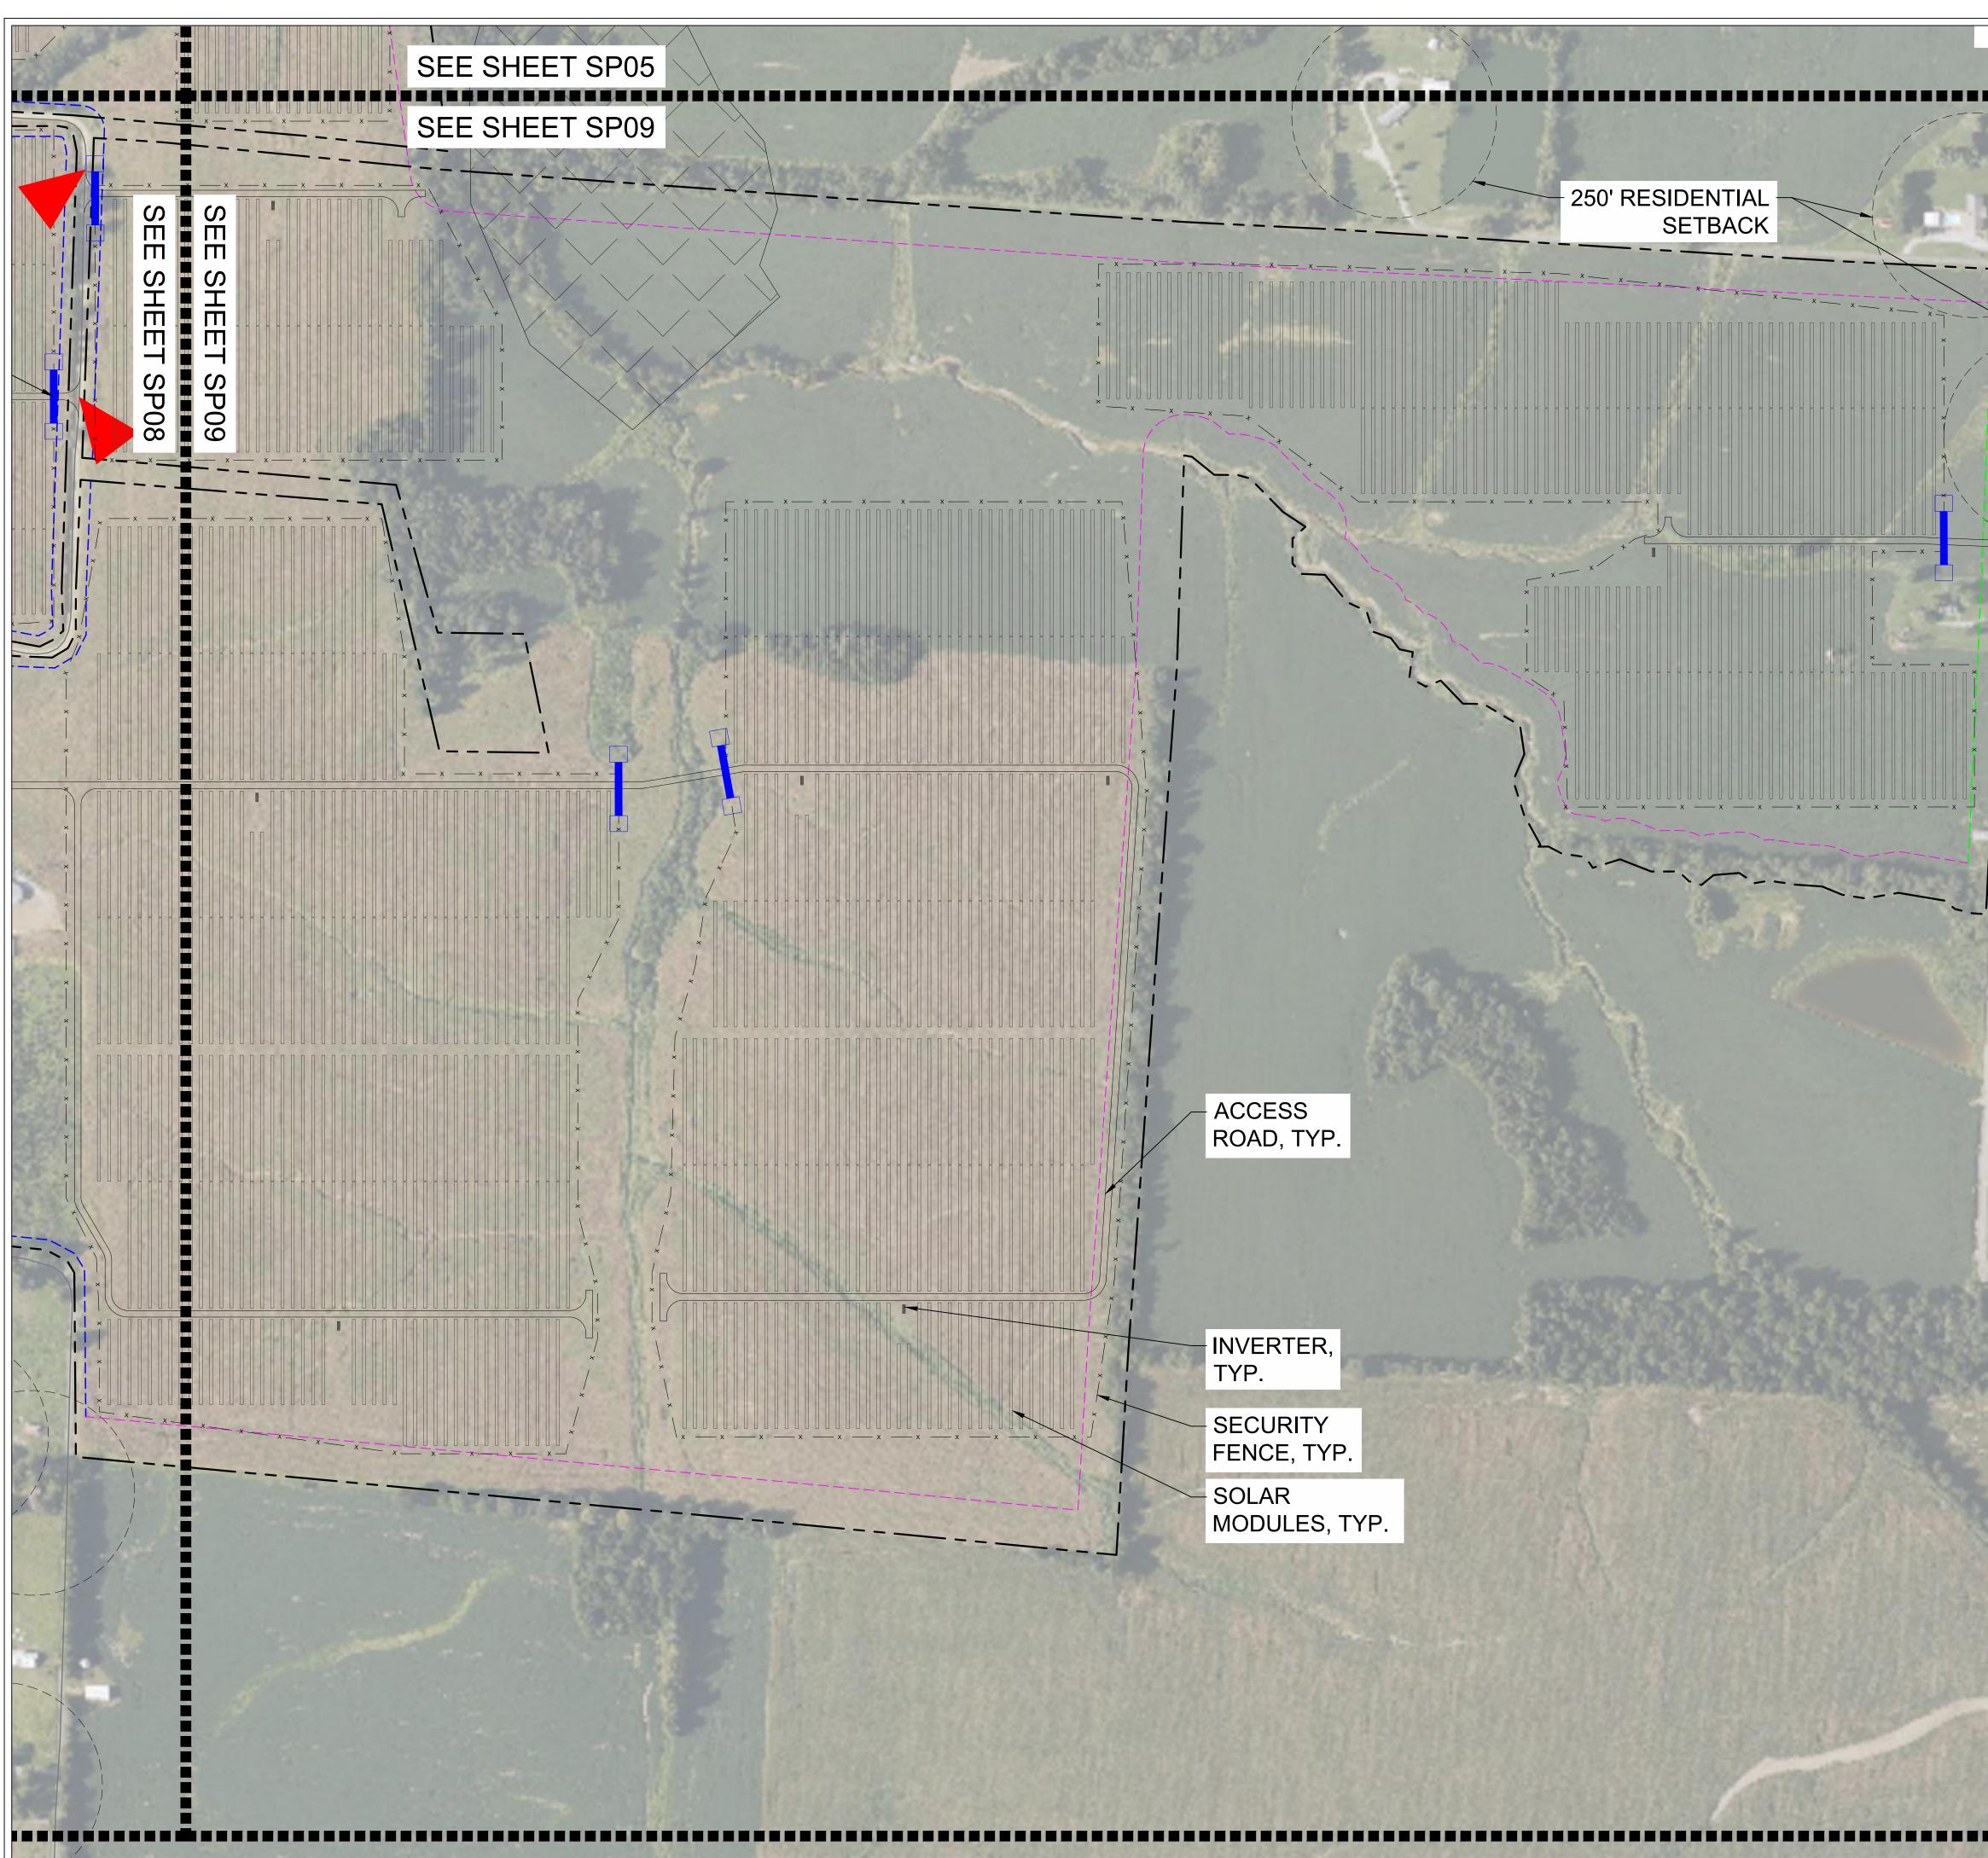

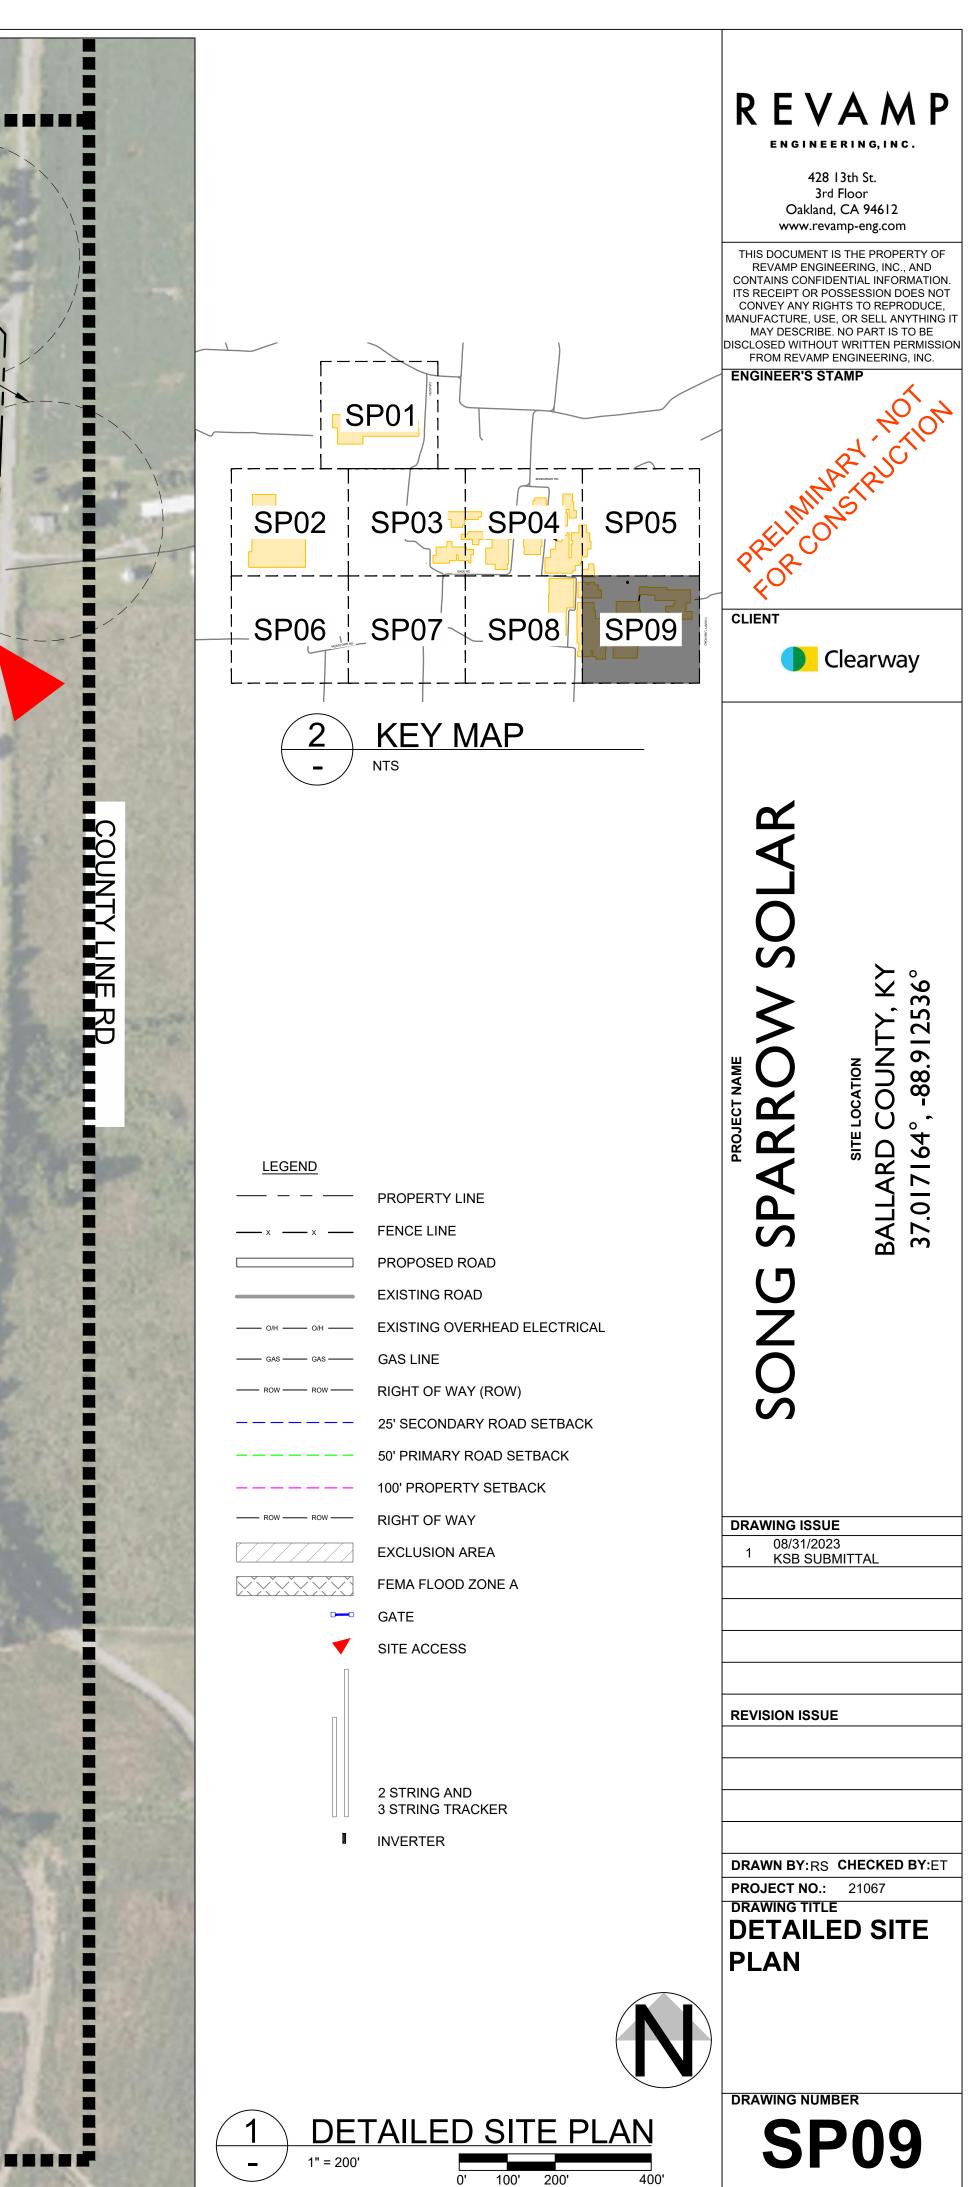

All -

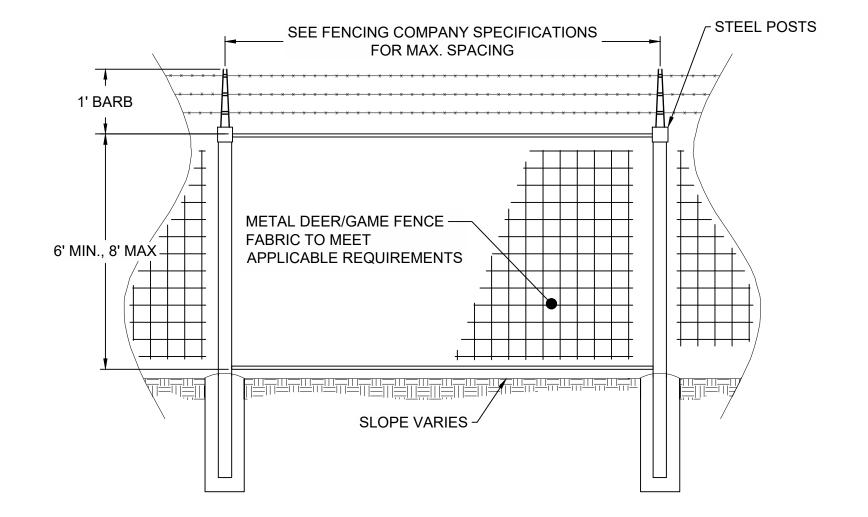

NOTES:


- SECURE SIDE.

SECURITY FENCE DETAIL (DEER/GAME FENCE) SCALE : N.T.S

1. FENCE SHALL BE GROUNDED IN ACCORDANCE WITH APPLICABLE CODES. 2. WIRE TIES, RAILS, POSTS, AND BRACES SHALL BE CONSTRUCTED ON THE SECURE SIDE OF THE FENCE ALLIGMENT. FENCE FABRIC SHALL BE ON THE OPPOSITE SIDE OF THE


3. THIS DETAIL SHOWS GENERAL FENCE CRITERIA. THE DETAILED DESIGN AND STRUCTURAL ANALYSIS SHALL BE A DELEGATED DESIGN TO MEET THE REQUIRED DESIGN LIFE, CORROSION, WIND, GROUNDING, ETC. SIGNED AND SEALED CALCULATIONS AND SHOP DRAWING SUBMITTALS SHALL BE SUBMITTED FOR REVIEW AND APPROVAL BY THE CIVIL AND STRUCTURAL ENGINEERS AND PROJECTS OWNER REPRESENTATIVE.

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DRAWING TITLE
FENCE DETAILS DRAWING NUMBER A100 21067 - SONG SPARROW - 104MWAC - SP00X.DWG

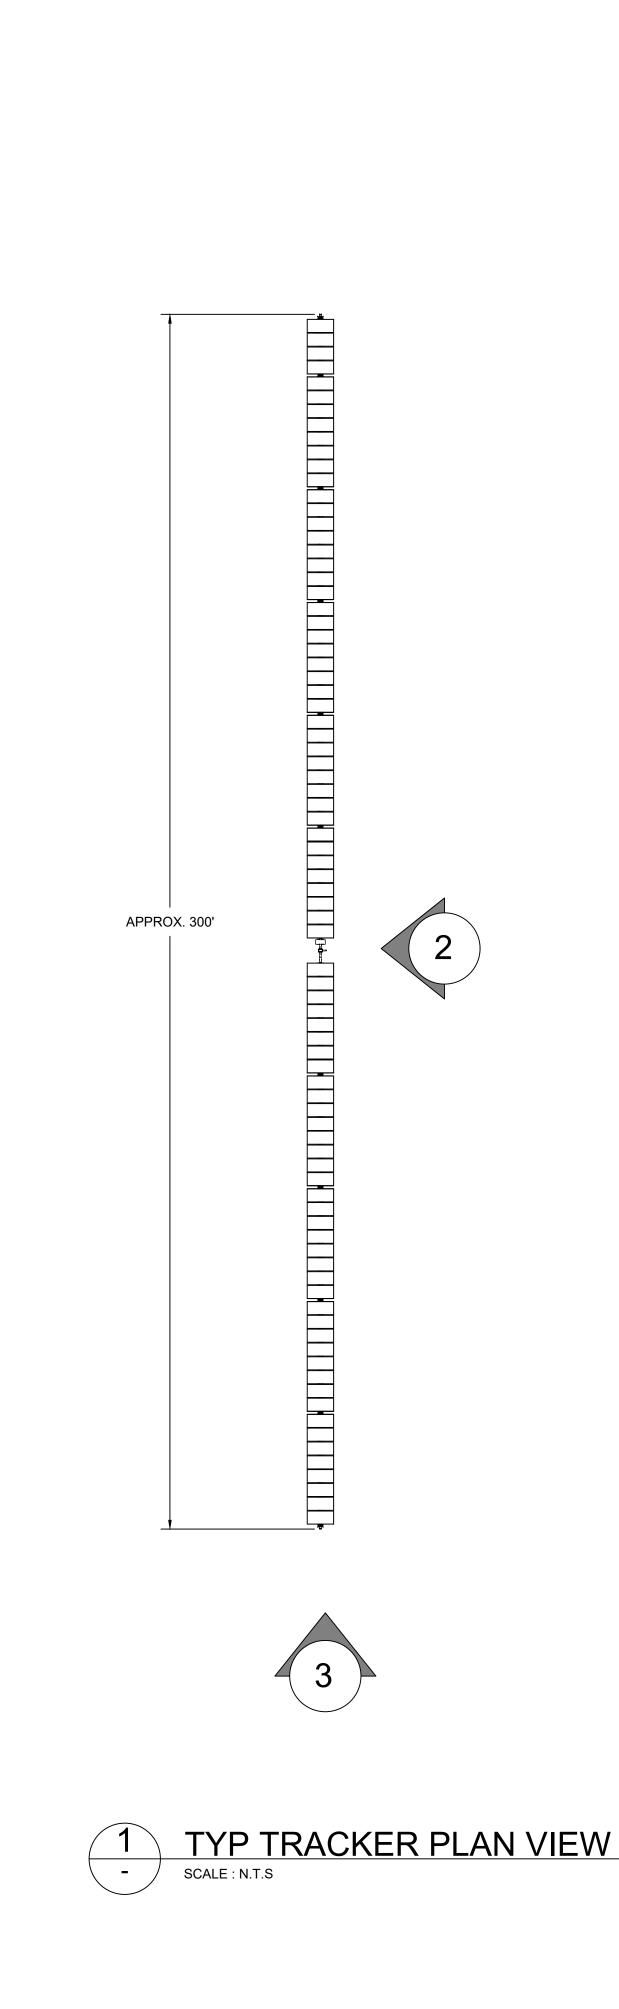


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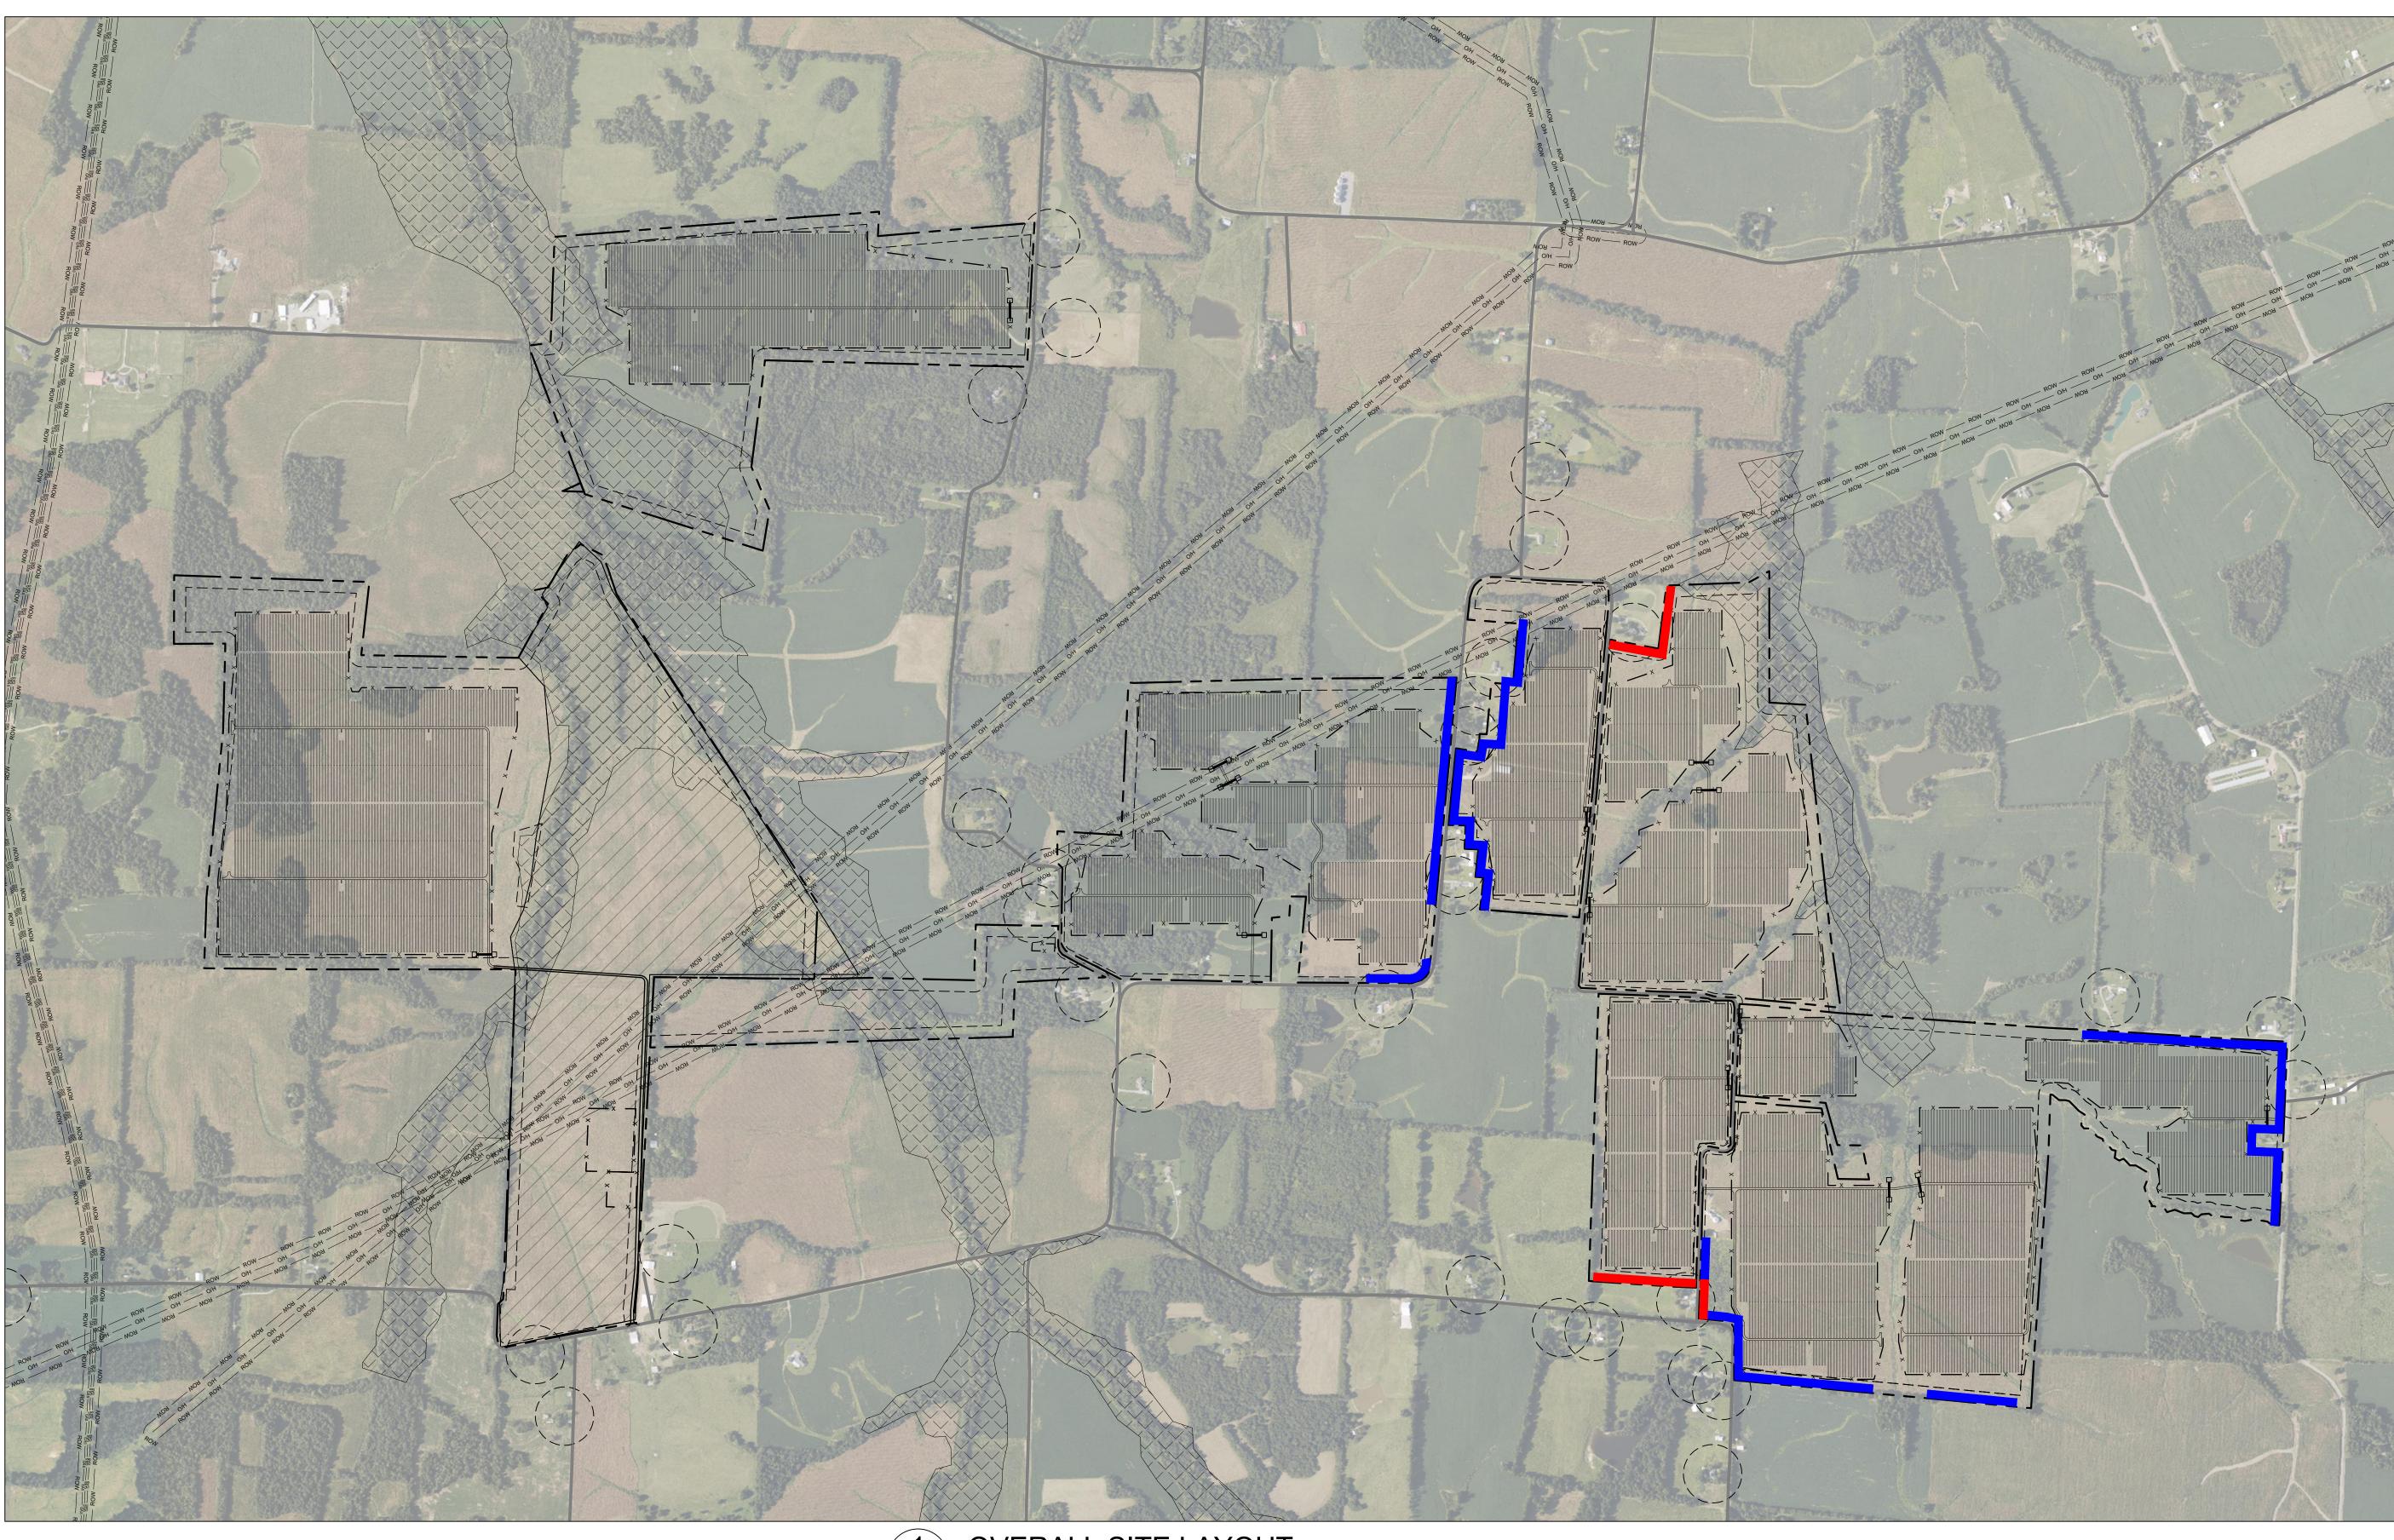


– GRADE

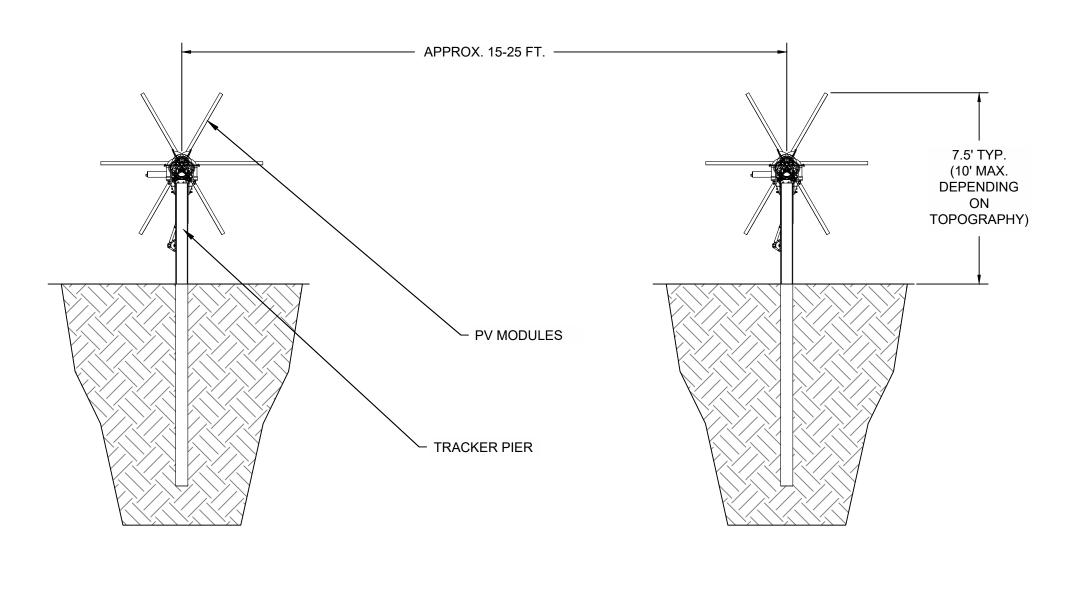LANDSCAPE SCREEN LEGEND

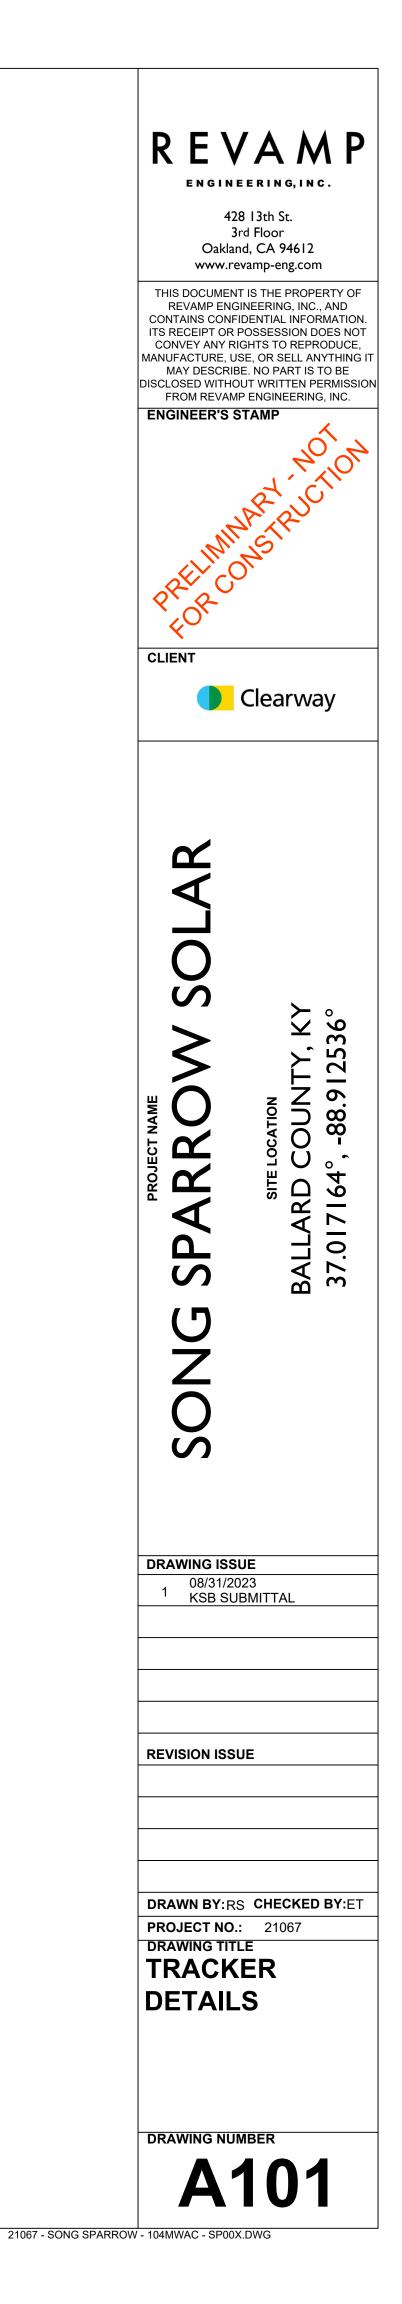


BUFFER SCREEN TYPE 'A'BUFFER SCREEN TYPE 'B'




OVERALL SITE LAYOUT 1" = 700' 0' 350' 700' 1400'

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GENERAL NOTES THAT APPLY TO ALL BUFFERS

- EXISTING VEGETATION WITHIN LANDSCAPE BUFFER AREAS SHALL REMAIN TO THE EXTENT POSSIBLE.
- QUANTITIES AND PLACEMENT OF PLANTS SHOWN ARE SCHEMATIC AND MAY VARY DEPENDING ON ACTUAL FIELD CONDITIONS. QUANTITIES SHOWN ARE PER EACH 100 LINEAR FEET OF AREA PROPOSED OR FRACTION THEREOF.
- IT IS NOT THE INTENT THAT THE SHRUBS PROPOSED FOR SCREENING SHALL BE SMALL GROWING OR BE SUBJECT TO ROUTINE PRUNING. INSTEAD, IT IS THE INTENT THAT ALL SHRUBS BE ALLOWED TO GROW AND MATURE NATURALLY, FORMING DENSE THICKETS OR MASSES FOR EFFECTIVE SCREENING PURPOSES.
- ADJUSTMENTS IN LOCATIONS AND PLANT MATERIALS SELECTIONS ARE SUBJECT TO THE EXISTING UTILITY EASEMENTS AS APPLICABLE. PLANTS SELECTIONS AND LOCATIONS PROPOSED WITHIN UTILITY EASEMENTS MUST BE APPROVED BY THE OWNING UTILITY.

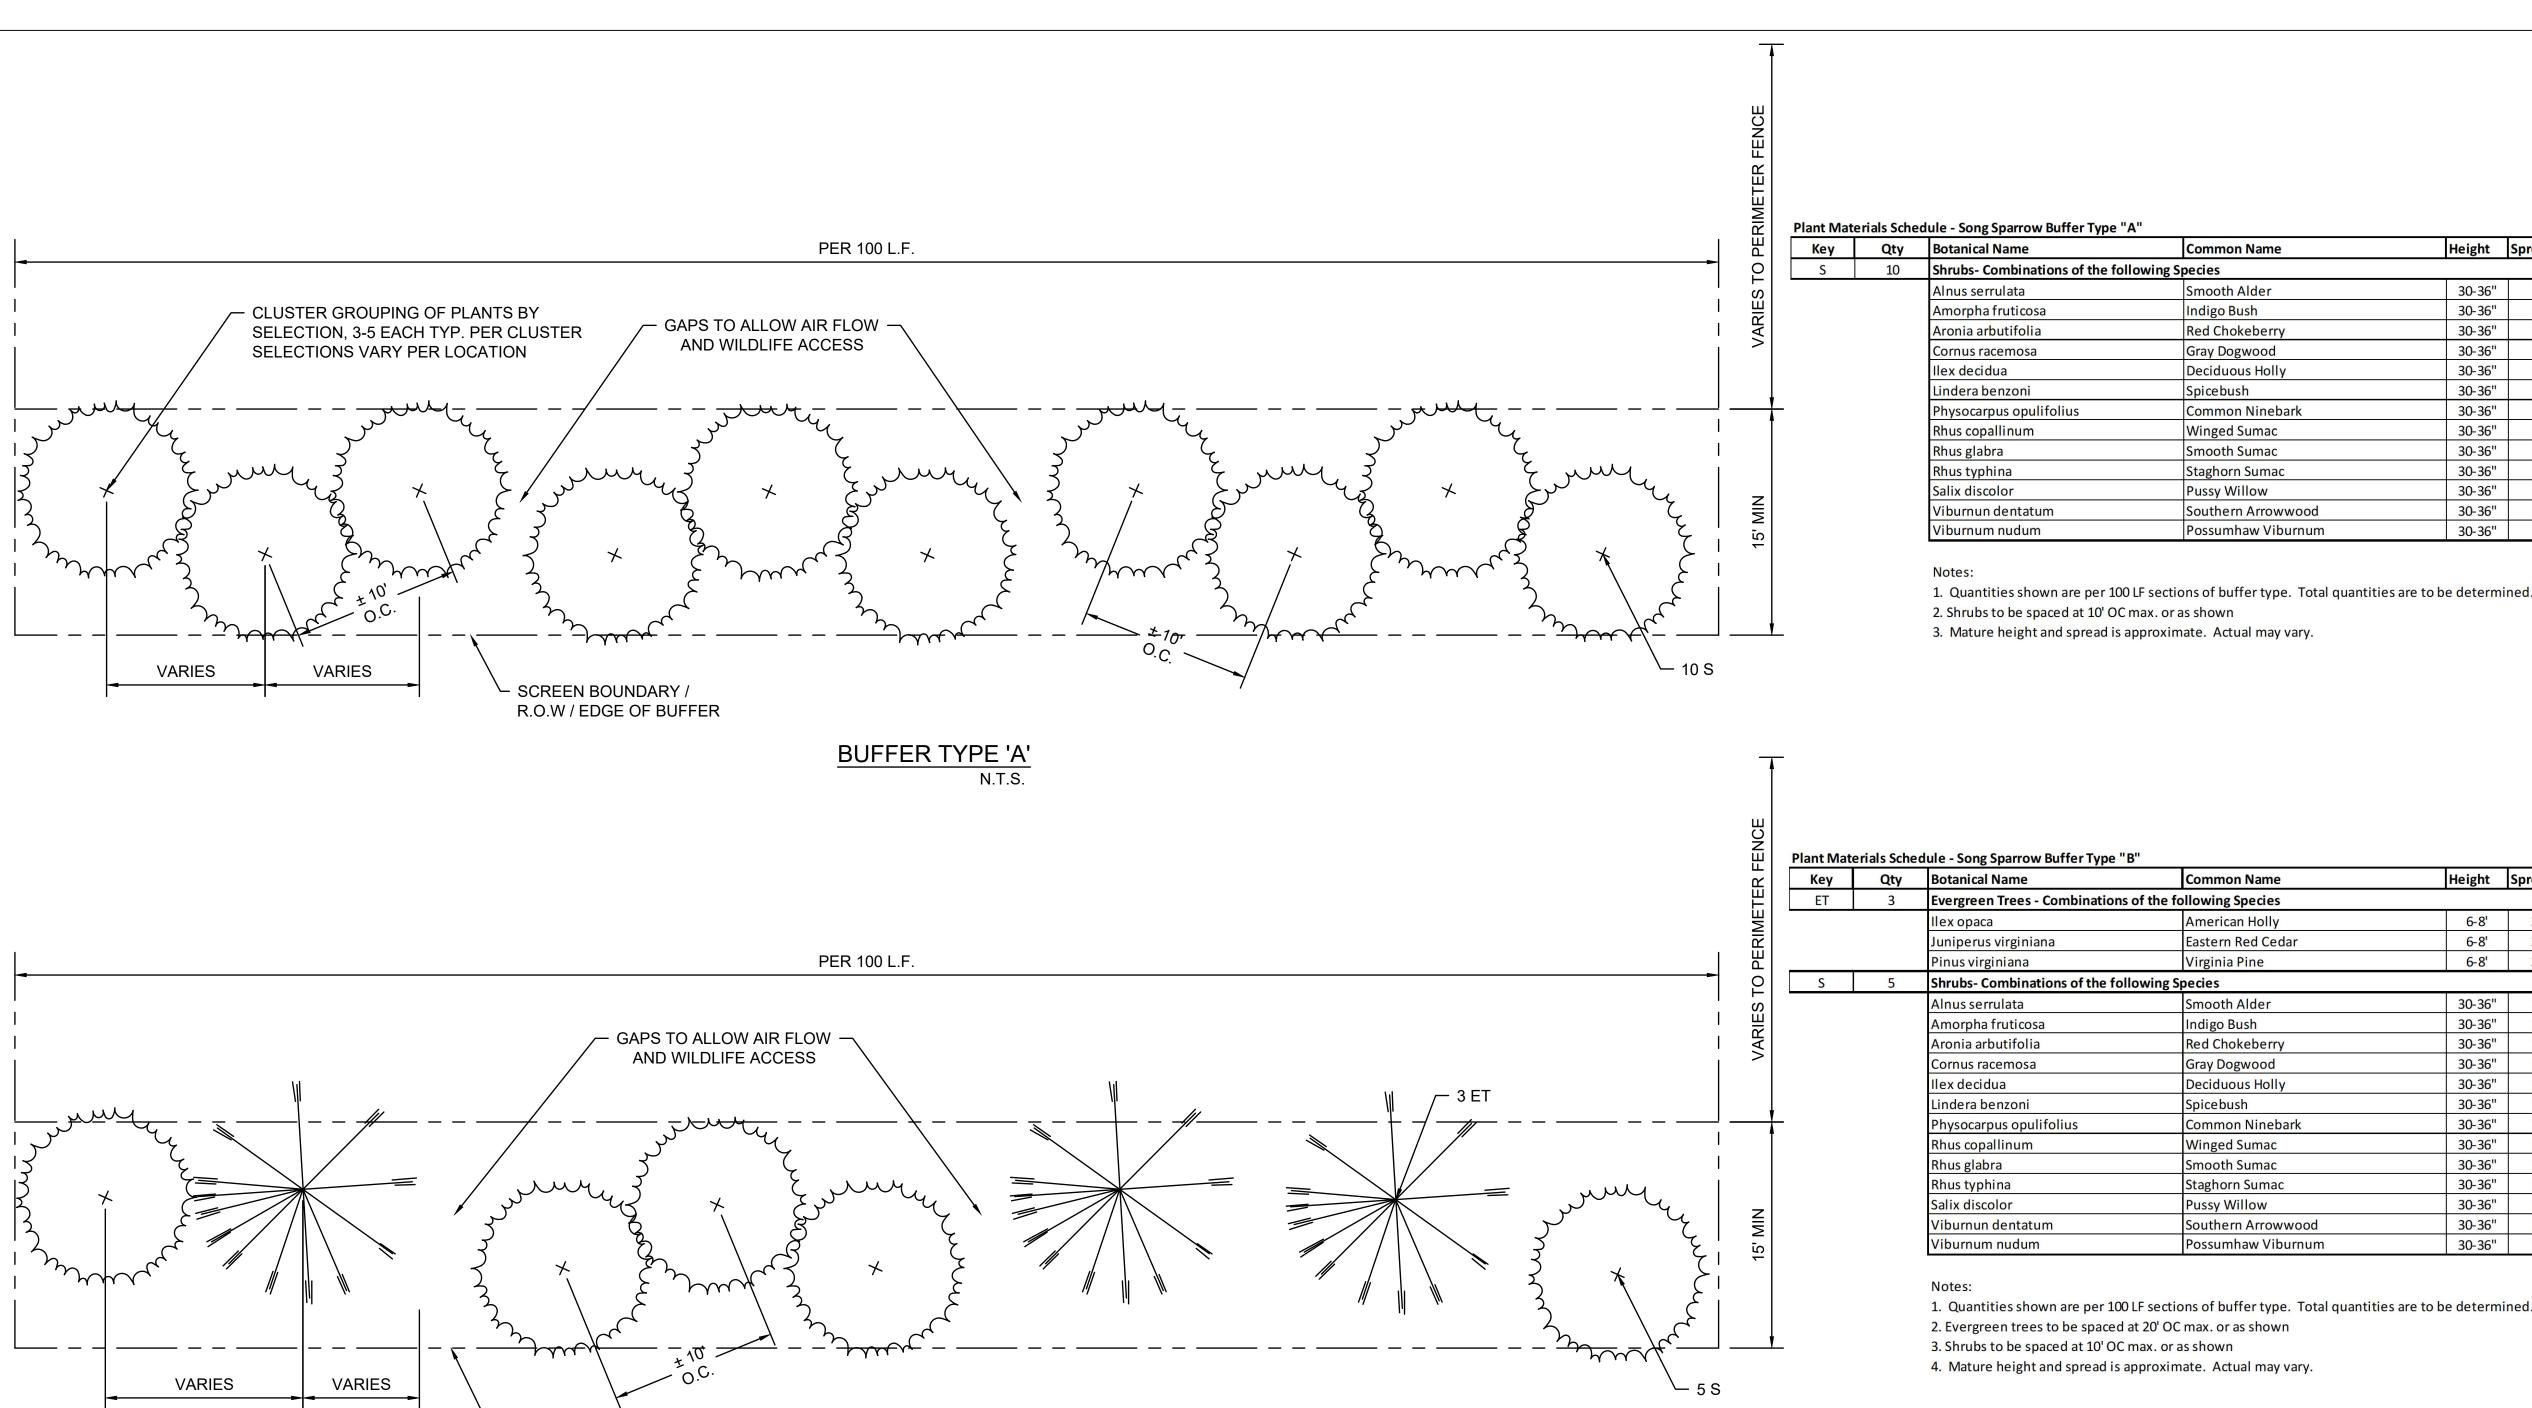SCREENING DESCRIPTION LANDSCAPE BUFFER "A"

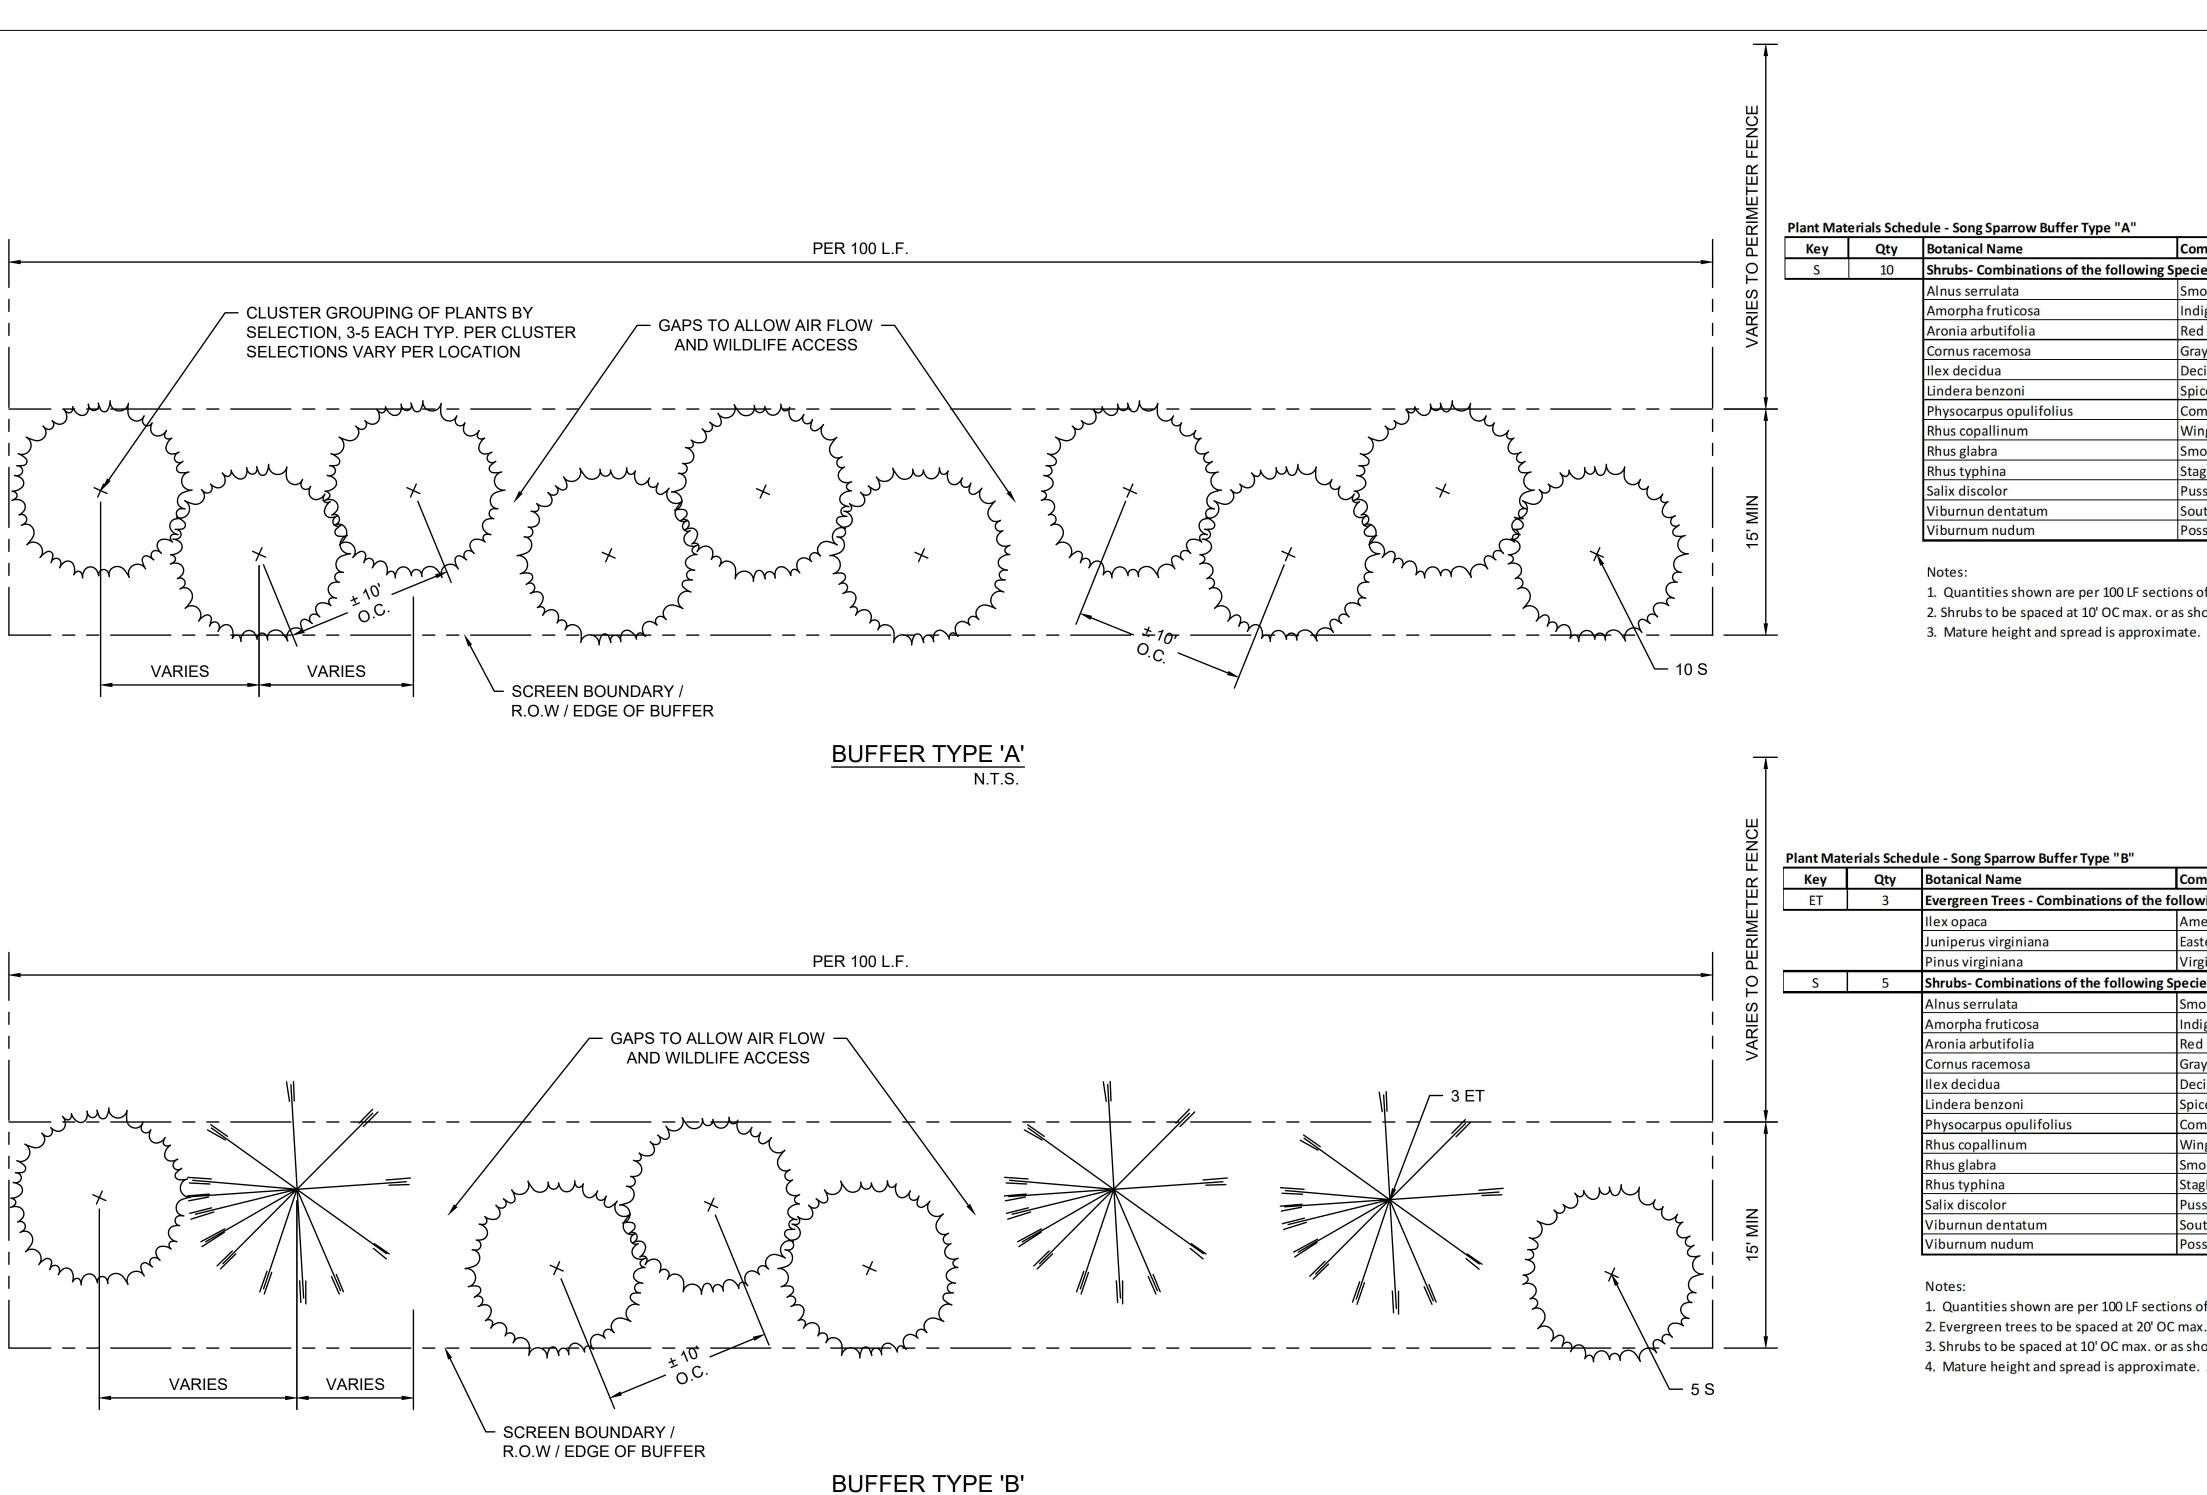LANDSCAPE BUFFER "A" PROPOSES A STAGGERED OFFSET ROW OF LARGE SHRUBS IN VARYING COMBINATIONS TO CREATE A NATURALIZED NATIVE BUFFER. THIS BUFFER UTILIZES 10 LARGE GROWING SHRUBS PER EACH 100-FOOT SEGMENT. PLANTS SHALL BE PLACED TO MAXIMIZE SCREENING EFFECTIVENESS AND TO KEEP SHADOWS FROM MATURE GROWTH FROM ENCROACHING ONTO THE SOLAR PANELS, REDUCING THEIR EFFICIENCY. SPACE IS ALLOTTED TO ALLOW FOR AIR FLOW AND WILDLIFE MOVEMENT. SHRUBS SHALL BE PLACED IN GROUPS OF MINIMUM 3, MAXIMUM 5 OF EACH TYPE PROPOSED. SPECIES SELECTION SHALL VARY FOR MAXIMUM DIVERSITY.

SCREENING DESCRIPTION LANDSCAPE BUFFER "B"

LANDSCAPE BUFFER "B" PROPOSES A COMBINATION OF 3 EVERGREEN TREES AND 5 LARGE SHRUBS PER EACH 100-FOOT SEGMENT. PLANTS SHALL BE PLACED TO MAXIMIZE SCREENING EFFECTIVENESS AND TO KEEP SHADOWS FROM MATURE GROWTH FROM ENCROACHING ONTO THE SOLAR PANELS, REDUCING THEIR EFFICIENCY. SPACE IS ALLOTTED TO ALLOW FOR AIR FLOW AND WILDLIFE MOVEMENT. SHRUBS SHALL BE PLACED IN GROUPS, MAXIMUM 3. TREES SHALL BE RANDOMLY PLACED IN GROUPS OF 3 PER EACH 100-FOOT SEGMENT. TREE TYPES SHALL VARY BETWEEN SEGMENTS. SHRUB SPECIES SELECTION SHALL VARY FOR MAXIMUM DIVERSITY. ACTUAL PLANT SELECTION MAY VARY DEPENDING ON EXISTING OVERHEAD AND UNDERGROUND UTILITIES PRESENT.

N.T.S.

nmon Name	Height	Spread	Mature Height / Spread
es			
ooth Alder	30-36"	18"	10-15' / 10-15'
igo Bush	30-36"	18"	4-15' / 6-15'
d Chokeberry	30-36"	18"	6-12'/3-6'
y Dogwood	30-36"	18"	10-27' / 10-15'
ciduous Holly	30-36"	18"	6-10' / 6-10'
cebush	30-36"	18"	8-15' / 6-15'
nmon Ninebark	30-36"	18"	5-8' / 6-10'
nged Sumac	30-36"	18"	7-15' / 10-20'
ooth Sumac	30-36"	18"	9-15' / 9-15'
ghorn Sumac	30-36"	18"	8-25' / 8-25'
ssy Willow	30-36"	18"	10-20' / 8-12'
ithern Arrowwood	30-36"	18"	5-12' / 6-10'
sumhaw Viburnum	30-36"	18"	5-12' / 5-12'

Height Spread Mature Height / Spread Common Name 6-8' 3-4' 15-35' / 20-35' American Holly 6-8' 3-4' 15-25' / 10-15' Eastern Red Cedar 6-8' 3-4' 20-30' / 25-35' Virginia Pine Smooth Alder 30-36" 18" 10-15' / 10-15' 30-36" 18" 4-15' / 6-15' ndigo Bush Red Chokeberry 30-36" 18" 6-12' / 3-6' 30-36" 18" 10-27' / 10-15' Gray Dogwood **Deciduous Holly** 30-36" 18" 6-10' / 6-10' 30-36" 18" 8-15' / 6-15' Spicebush Common Ninebark 30-36" 18" 5-8'/6-10' 30-36" 18" 7-15' / 10-20' Winged Sumac Smooth Sumac 30-36" 18" 9-15' / 9-15' 30-36" 18" 8-25' / 8-25' Staghorn Sumac 30-36" 18" 10-20' / 8-12' Pussy Willow 30-36" 18" 5-12' / 6-10' Southern Arrowwood 30-36" 18" 5-12' / 5-12' Possumhaw Viburnum

1. Quantities shown are per 100 LF sections of buffer type. Total quantities are to be determined.

