CONTRACT No. 2 - 50,000 GALLON GROUND STORAGE TANK WATER SYSTEM IMPROVEMENTS

for the


GARRAD COUNTY WATER ASSOCIATION

Lancaster, Kentucky

BILL C. DOOLIN - PRESIDENT
BILL OLIVER - VICE-PRESIDENT
JENNY LYNN WHITTAKER - TREASURER
SEAN SMITH - GENERAL MANAGER
ROBERT BALLARD
GARY CLARK
FELIX REYNOLDS

BOARD OF DIRECTORS:

JUNE 2022

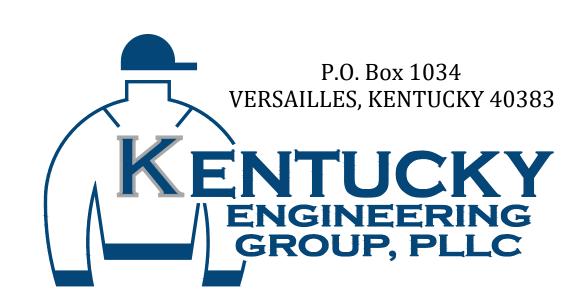

- CONTRACTOR SHALL CONTACT ALL UTILITY COMPANIES AND THE ENGINEER TWO WORKING DAYS (MINIMUM) BEFORE
- CONTRACTOR SHALL BE RESPONSIBLE FOR MAINTENANCE OF TRAFFIC IN ACCORDANCE WITH CITY, COUNTY AND
- THE CONTRACTOR SHALL MAINTAIN A CURRENT SET OF CONSTRUCTION PLANS ON THE JOB SITE DURING ALL PHASES
- EXISTING UTILITIES, ESPECIALLY GAS LINES AND OIL LINES, MAY BE CATHODICALLY PROTECTED. THEREFORE, DUCTILE IRON PIPE, FITTINGS, GATE VALVES, AND/OR BOXES LAID WITHIN 100' OF LINES WITH CATHODIC PROTECTION SHALL BE WRAPPED IN POLYETHYLENE ENCASEMENT. MATERIALS AND INSTALLATION SHALL MEET THE REOUIREMENTS OF AWWA'S LATEST REVISION.
- ALL CONSTRUCTION AND INSTALLATION OF MATERIALS BEING USED SHALL BE IN CONFORMANCE WITH THE PLANS AND SPECIFICATIONS. SUBSTITUTIONS AND DEVIATION SHALL BE PERMITTED ONLY WHEN WRITTEN APPROVAL HAS
- SHOP DRAWINGS OF ALL MATERIALS BEING USED SHALL BE SUBMITTED TO THE ENGINEER FOR APPROVAL PRIOR TO
- EXISTING UTILITIES HAVE BEEN SHOWN IN THEIR <u>APPROXIMATE LOCATION</u>. CONTRACTOR SHALL BE RESPONSIBLE FOR LOCATING ALL UTILITIES. THE CONTRACTOR SHALL COORDINATE WITH A REPRESENTATIVE WHEN WORKING NEAR EXISTING UTILITIES.
- THE CONTRACTOR SHALL PROTECT ALL UTILITIES AND OTHER IMPROVEMENTS SHOWN ON THESE PLANS AND ALL OTHER UTILITIES AND OTHER IMPROVEMENTS NOT SHOWN. THE CONTRACTOR SHALL ASSUME ALL RESPONSIBILITY FOR REPAIRS OF UTILITIES AND OTHER IMPROVEMENTS DAMAGED DURING CONSTRUCTION.
- UNLESS OTHERWISE NOTED, A SEPARATE BID ITEM HAS NOT BEEN ESTABLISHED FOR FITTINGS. THE FITTINGS INCLUDED BUT NOT LIMITED TO ARE: TEES, BENDS, PLUGS, REDUCERS, CROSSES, COUPLINGS, ETC. CONTRACTORS SHALL INCLUDE THE COST OF THESE ITEMS IN THE BID PRICE FOR THE PIPE.
- CONTRACTOR SHALL BE RESPONSIBLE FOR THE TEMPORARY REMOVAL/RELOCATION OF TRAILERS, BUILDINGS, FENCES, TREES, SHRUBS, ETC. AND REPLACEMENT OF SAID ITEMS AFTER CONSTRUCTION ACTIVITIES.
- CONTRACTOR IS TO COORDINATE WITH THE PROPERTY OWNERS AS TO WHETHER OR NOT TEMPORARY FENCING IS REQUIRED AND CONSTRUCT IF NECESSARY.
- ALL PIPING SHALL HAVE 30" MINIMUM COVER, UNLESS OTHERWISE NOTED.
- WHERE UNSTABLE MATERIAL IS ENCOUNTERED OR WHERE THE DEPTH OF EXCAVATION IN EARTH EXCEEDS FIVE (5) FEET, THE SIDES OF THE TRENCH OR EXCAVATION SHALL BE SUPPORTED BY SUBSTANTIAL SHEETING, BRACING, SHORING OR THE TRENCH SIDES SLOPED. SLOPING THE SIDES OF THE DITCH WILL NOT NOT BE PERMITTED IN STREETS, ROADS, NARROW RIGHTS-OF-WAY OR OTHER CONSTRICTED AREAS UNLESS OTHER WISE SPECIFIED. THE STANDARDS OF THE FEDERAL OCCUPATIONAL SAFETY AND HEALTH ACT AND THE KENTUCKY LABOR CABINET SHALL
- ALL EXCAVATION IS UNCLASSIFIED. COMPENSATION FOR ALL EXCAVATION SHALL BE INCLUDED IN LUMP SUM BID.
- REGRADE OF SITE SHALL BE SUCH THAT DRAINAGE IS AWAY FROM ALL STRUCTURES.
- BACKFILL AROUND ALL STRUCTURES SHALL BE SUFFICIENTLY COMPACTED TO PRECLUDE SETTLEMENT AND PONDING OF WATER AROUND STRUCTURES AND GRADED TO DIVERT RUNOFF AWAY FROM THE STRUCTURES.
- DIMENSIONS, DETAILS AND REINFORCEMENT MAY VARY WITH MANUFACTURER'S RECOMMENDATIONS. CONTRACTOR SHALL OBTAIN AND MAINTAIN ON SITE, APPROVED SHOP DRAWINGS PRIOR TO BEGINNING CONSTRUCTION.
- ALL VALVES & HYDRANTS SHALL BE LOCATED AT THE BACKSIDE OF THE DITCHLINE, UNLESS OTHERWISE NOTED.
- FINAL LOCATION OF SERVICES, VALVES, & HYDRANT ORIENTATION ARE TO BE FIELD LOCATED DURING CONSTRUCTION & APPROVED BY THE ENGINEER.
- AT THE CONTRACTORS OPTION, CLASS 350 DUCTILE IRON PIPE MAY BE SUSTITUTED FOR ANY PIPE PARTICULARLY
- NO PAY ITEM FOR EXTRA TRENCH DEPTH HAS BEEN SET UP. CONTRACTOR SHALL INCLUDE THE COST OF THE
- ROCK SOUNDINGS WERE NOT PERFORMED BY THE ENGINEER, THE CONTRACTOR SHALL TAKE APPROPRIATE ACTION TO DETERMINE SUBSURFACE CONDITIONS.
- CONTRACTOR TO DIG/EXPOSE EXISTING WATER MAIN FAR ENOUGH AHEAD OF NEW WATER MAIN CONSTRUCTION TO AVOID DAMAGE TO EXISTING WATER MAIN AND/OR INTERRUPTION OF EXISTING CUSTOMER SERVICES.
- ALL NEW SERVICE LINE FROM THE NEW MAIN TO THE SETTERS SHALL BE CLASS 250 3/4" PE CTS TUBING UNLESS
- THE MAXIMUM ALLOWABLE LENGTH OF SERVICE LINE FROM THE WATER MAIN TO THE CUSTOMER'S METER SERVICE SHALL BE AS FOLLOWS:

ERVICE LINE DIAMETER	MAXIMUM LENGTH
3/4 INCH	100 FEET
1 INCH	150 FEET
1-1/2 INCH	200 FEET
2 INCH	250 FEET

- CONNECTIONS TO EXISTING DISTRIBUTION SYSTEM SHALL BE MADE AS FOLLOWS:
 - A. CONNECT TO EXISTING (SIZE) W.M. (WET TAP) CONTRACTOR SHALL PROVIDE, FURNISH AND INSTALL ALL FITTINGS, VALVES AND APPURTENANCES TO CONNECT THE PROPOSED WATER MAIN TO THE EXISTING WATER MAIN UNDER PRESSURE.
 - B. CONNECT TO EXISTING (SIZE) W.M. CONTRACTOR SHALL PROVIDE, FURNISH AND INSTALL ALL FITTINGS AND APPURTENANCES TO CONNECT THE PROPOSED WATER MAIN TO THE EXISTING WATER MAIN. VALVES ARE A
- NO BLASTING WILL BE PERMITTED ON THIS PROJECT
- GRIP RINGS SHALL BE INSTALLED ON ALL FITTINGS
- ALL NEW METERS SHALL BE 5/8" X 3/4"

SHOWN DIFFERENTLY ON THE PLANS

• WHEN POSSIBLE, CONTRACTOR SHALL FREEBORE ALL BITUMINOUS AND/OR CONCRETE DRIVEWAYS. FREEBORING AND/ OR OPEN CUTTING DRIVEWAYS SHALL BE INCLUDED IN THE BID PRICE FOR THE PIPE.

GENERAL NOTES (CONTINUED)

- NEW LINE AND EXISTING LINES MUST REMAIN IN SERVICE UNTIL ALL METERS ASSEMBLED HAVE BEEN REPLACED AND RECONNECTED TO THE NEW LINE
- NO METERS CAN BE RECONNECTED TO THE NEW WATER MAIN UNTIL TESTING, STERILIZATION AND SAMPLING HAS BEEN SUCCESSFULLY COMPLETED
- COPIES OF ALL BACTIE RESULTS MUST BE PROVIDED TO THE ENGINEER PRIOR TO RECONNECTS OF ANY
- A NO. 12 AWG INSULATED COPPER LOCATOR WIRE SHALL BE PLACED IN THE TRENCH SIX INCHES ABOVE ALL PLASTIC LINES. THE INSULATION SHALL BE BLUE FOR WATER. THE WIRE SHALL BE LOOPED INTO ALL VALVE BOXES W/ ENOUGH SLACK TO ALLOW ACCESS TO THE LOOPS.
- THE CONTRACTOR SHALL BE RESPONSIBLE FOR ANY PLUMBING PERMITS NECESSARY TO RELOCATE OR RECONNECT ANY CUSTOMERS METER SERVICE OR SERVICE LINE. THE CONTRACTOR SHALL OBTAIN ALL PERMITS, PAY ALL FEES AND EMPLOY THE NECESSARY LICENSED PLUMBER.

FINAL CLEANUP AND RESTORATION

UNLESS SPECIFICALLY APPROVED BY THE OWNER AND ENGINEER, CLEANUP OF DISTURBED AREAS SHALL BE KEPT CURRENT WITH CONSTRUCTION AND RESTORATION EFFORTS BY THE CONTRACTOR INITIATED NO LONGER THAN SEVEN (7) DAYS AFTER THE TRENCH EXCAVATION WORK HAS STARTED. ALL EXCAVATED MATERIAL NOT REQUIRED FOR BACKFILLING OF THE TRENCH AND ANY LARGE ROCKS, STONES OR DEBRIS SHALL BE REMOVED FROM THE SITE, AND SHALL NOT BE A BURDEN TO THE PROPERTY OWNER(S) AND/OR ADJACENT PROPERTIES. THE CONTRACTOR MAY WINDROW OR TRACK-IN THE EXCAVATED MATERIAL OVER THE TRENCH PRIOR TO FINAL CLEANUP TO ALLOW FOR AND TO ASSIST IN THE INITIAL SETTLEMENT OF THE TRENCH. ALL DISTURBED AREAS MUST BE SEEDED AT LEAST WITH A TEMPORARY SEED MIX IF FOR SOME REASON THE AREA CANNOT BE PERMANENTLY SEEDED WITHIN TWO (2) WEEKS.

DEPARTMENT OF HIGHWAYS - GENERAL NOTES

- ALL EFFECTED KYTC DITCHLINES SHALL REMAIN FREE OF EXCESS SILT OR EROSION AND CONSTRUCTED TO THE NORMAL TYPICAL SECTION OF THE ROADWAY WITH A MINIMUM DEPTH OF 18 INCHES FROM THE
- ALL NECESSARY STEPS SHALL BE TAKEN TO PREVENT EROSION OR SILTATION OF THE PUBLIC RIGHT-OF-WAY, ADJOINING PROPERTY AND WATERWAYS.
- ALL VALVES TO BE FLUSH W/ EXISTING GRADE.
- ALL WATER LINE LOCATED WITHIN STATE HIGHWAY R.O.W. SHALL BE CONSTRUCTED OUT AND AROUND THE END OF ALL EXISTING CULVERTS AND HEADWALLS.
- UNDERGROUND UTILITIES INSTALLED INSIDE STATE RIGHT-OF-WAY SHALL BE LOCATED WITHIN 3-5 FEET FROM THE EDGE OF THE RIGHT-OF-WAY UNLESS OTHERWISE SHOWN ON THE PLANS.
- UNDERGROUND UTILITIES SHOWN MORE THAN 5 FEET FROM THE EDGE OF THE RIGHT-OF-WAY SHALL BE INSTALLED WITH A MINIMUM DEPTH OF COVER OF 42 INCHES WITH PRIOR APPROVAL ON A CASE BY CASE
- UNDERGROUND UTILITIES CROSSING ANY ENTRANCE OR CROSSROAD PAVED WITH CONCRETE OR ASPHALT SURFACE INSIDE STATE RIGHT-OF-WAY SHALL BE INSTALLED BY BORING UNLESS. WRITTEN PERMITTION TO OPEN CUT IS OBTAINED FROM THE PROPERTY OWNER AND APPROVED BY THE KYTC DISTRICT PERMITS
- UNDERGROUND UTILITIES SHALL NOT BE INSTALLED IN EMBANKMENT FILLS OR BETWEEN EDGE OF PAVEMENT AND DITCHLINE UNLESS SPECIFICALLY NOTED ON PERMITTED PLANS.
- FIRE HYDRANTS OR UTILITY SERVICE BOXES SHALL BE LOCATED WITHIN 2 FEET FROM THE EDGE OF RIGHT-OF-WAY LINE. OR OFF RIGHT-OF-WAY.

INDEX OF DRAWINGS

SHT. NO. **DESCRIPTION:** COVER

LOCATION MAP, LEGEND, UTILITIES, AND INDEX OF DRAWINGS 50,000 GALLON GROUND STORAGE TANK SITE PLAN

50,000 GALLON GROUND STORAGE TANK ENLARGED SITE PLANS

4-6 STANDARD DETAILS

SHEET LOCATION MAP TANK 50.000 GAL

LEGEND

OWNER

EXISTING	PROPOSED	DESCRIPTION
PVC	PVC	POLYVINYL CHLORIDE
DIP	DIP	DUCTILE IRON PIPE
WM	WM	WATER MAIN
Ŷ		HYDRANT ASSEMBLY
P	•	FLUSHING/BLOWOFF ASSEMBLY
\triangle		AIR RELEASE VALVE (ARV)
\otimes	\otimes	GATE VALVE (GV)
		WATER MAIN (WM)
(======)		SPECIAL CROSSING OR CASING PIF
	(TO BE ABANDONED)	WATER MAIN TO BE ABANDONED
R/W		RIGHT-OF-WAY LINE
		CENTERLINE
		PROPERTY LINE

EASEMENT ACQUIRED

UTILITIES

BUD - Before You Dig 1-800-752-6007 or DIAL 811

IN ACCORDANCE WITH KENTUCKY STATE LAW, ANY ACTIVITY THAT RESULTS IN MOVEMENT, PLACEMENT, BORING, PROBING OR DIGGING IN OR ON THE GROUND SHALL CONTACT THE ONE CALL CENTER FOR UNDERGROUND UTILITY

WATER ASSOCIATION

GARRARD COUNTY WATER ASSOCIATION

PHONE: 859-792-4501 FAX: 859-792-1671

SHEET LOCATION MAP, LEGEND, UTILITIES and


19014-02

IT IS A VIOLATION OF LAW FOR ANY PERSON TO ALTER THIS DRAWING WITHOUT WRITTEN PERMISSION FROM KENTUCKY ENGINEERING GROUP. PLLC AND ACTING UNDER THE DIRECTION OF A LICENSED ENGINEER.

THIS DRAWING WAS PREPARED AT THE SCALE INDICATED. INACCURACIES IN THE STATED SCALE MAY BE INTRODUCED WHEN DRAWINGS ARE REPRODUCED BY ANY MEANS, USE THE GRAPHIC SCALE BAR IN THE DRAWING OR TITLE BLOCK TO DETERMINE THE ACTUAL SCALE.

•	DATE	REVISIONS	BY	

DATE:	JUNE, 2022	
PROJECT MGR:	RCC	
DRAWN BY:	JAB	
CHECKED BY:	RCC	
SCALE:	AS NOTED	
022 © Kentucky Engineering Group, PLLC		

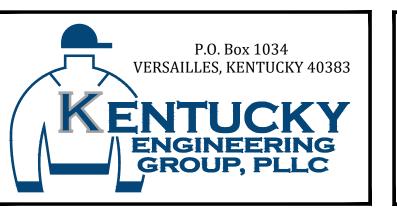

CONTRACT No. 2 -50,000 GALLON GROUND STORAGE TANK WATER SYSTEM IMPROVEMENTS

OWNER

GARRARD COUNTY WATER ASSOCIATION Garrard County, Kentucky

INDEX OF DRAWINGS




IT IS A VIOLATION OF LAW FOR ANY PERSON TO ALTER
THIS DRAWING WITHOUT WRITTEN PERMISSION FROM
KENTUCKY ENGINEERING GROUP, PLLC AND ACTING
UNDER THE DIRECTION OF A LICENSED ENGINEER.

THIS DRAWING WAS PREPARED AT THE SCALE INDICATED. INACCURACIES IN THE STATED SCALE MAY BE INTRODUCED WHEN DRAWINGS ARE REPRODUCED BY ANY MEANS. USE THE GRAPHIC SCALE BAR IN THE DRAWING OR TITLE BLOCK TO DETERMINE THE ACTUAL SCALE.

NO.	DATE	REVISIONS	BY

DATE:	JUNE, 2022
PROJECT MGR:	RCC
DRAWN BY:	JAB
CHECKED BY:	RCC
SCALE:	AS NOTED
2022 © Kentucky Engi	neering Group, PLI

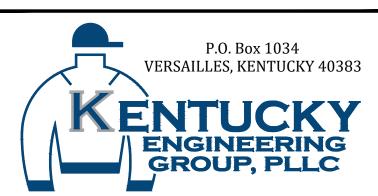


CONTRACT No. 2 -50,000 GALLON
GROUND STORAGE TANK
WATER SYSTEM IMPROVEMENTS

GARRARD COUNTY WATER ASSOCIATION
Garrard County, Kentucky

50,000 GALLON GROUND STORAGE TANK SITE PLAN PROJECT NO. 19014-02

SHEET NO.

2

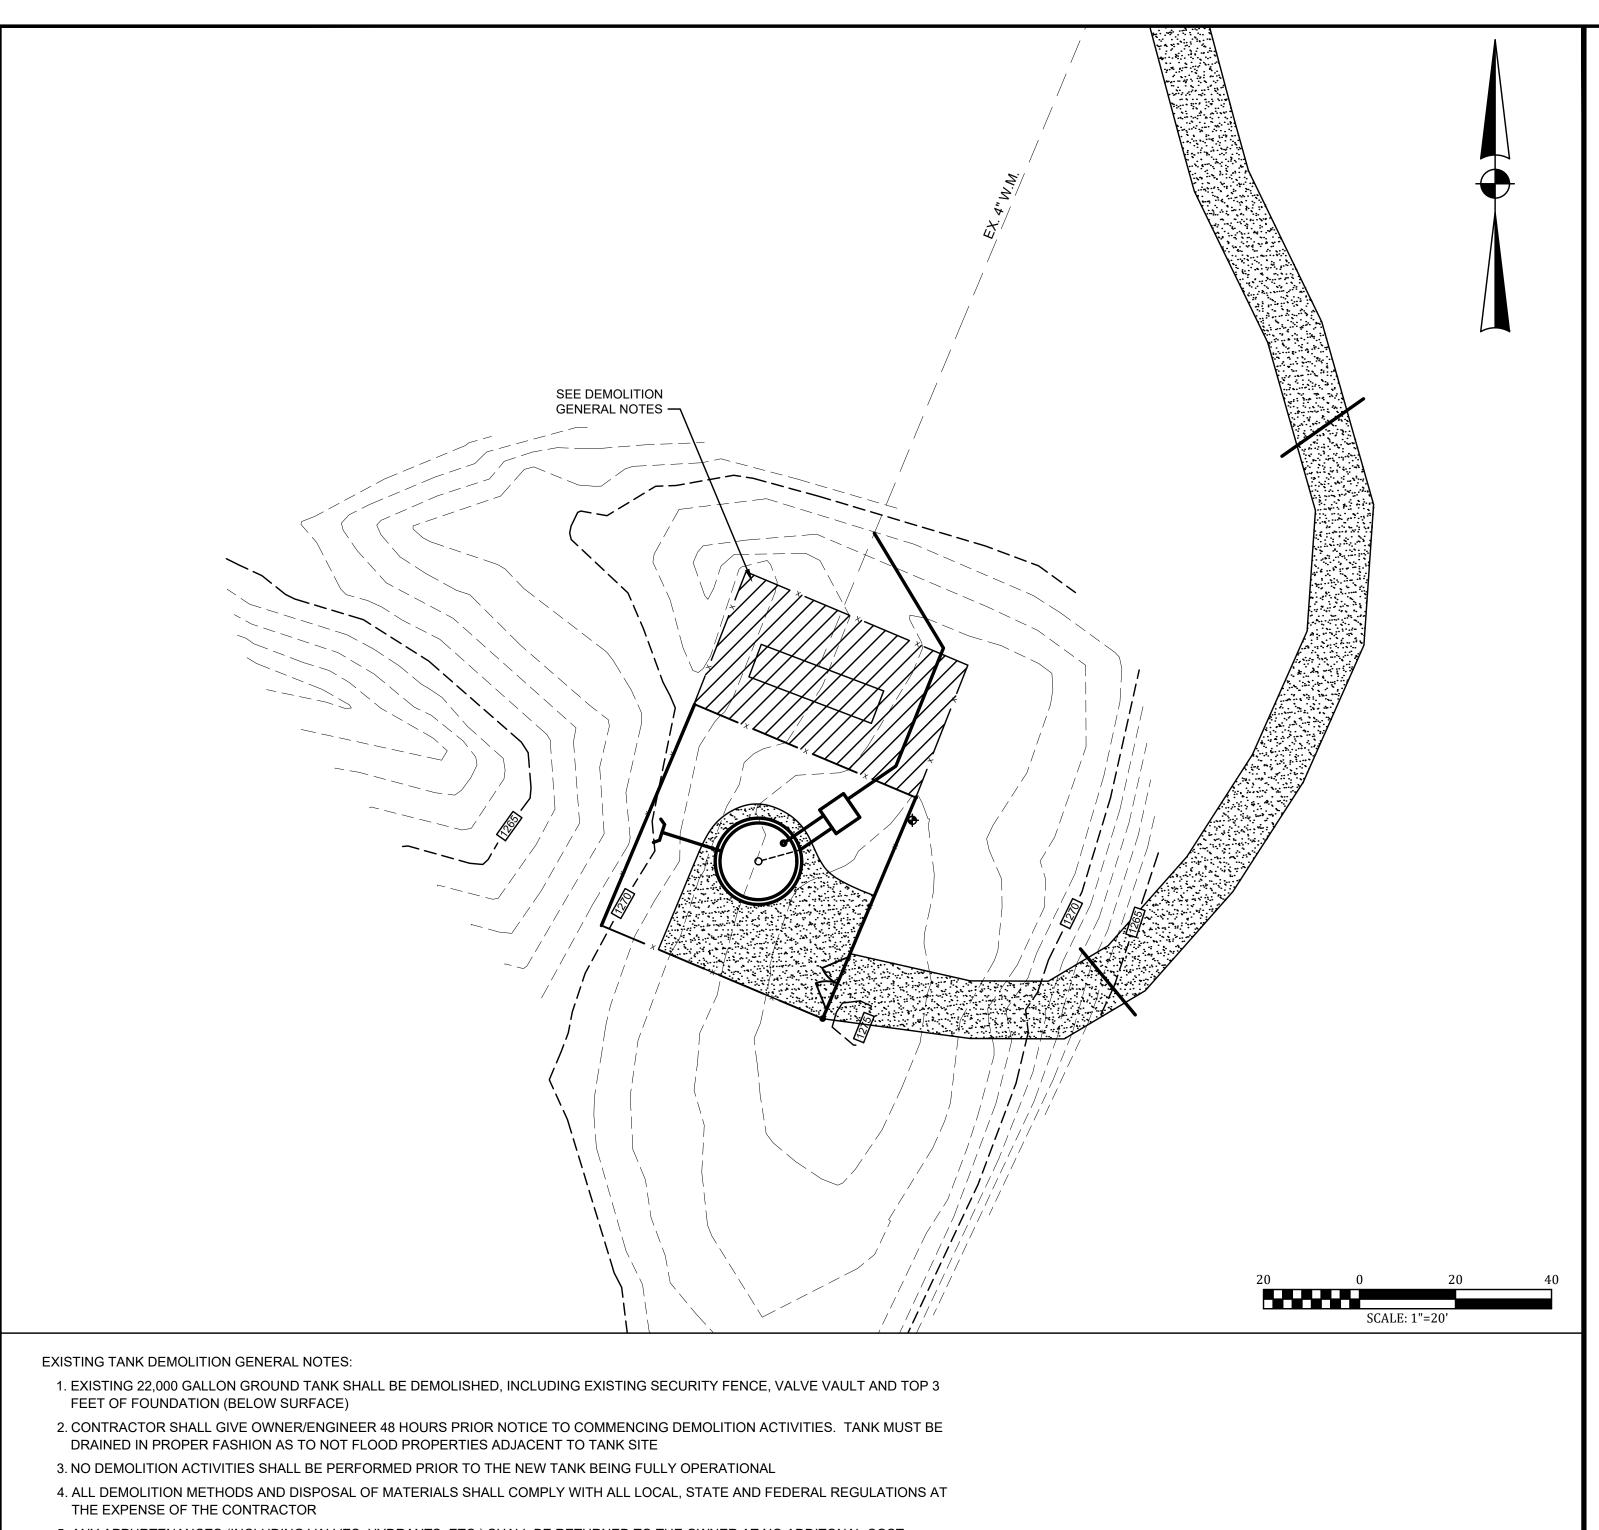

NO. DATE REVISIONS THIS DRAWING WITHOUT WRITTEN PERMISSION FROM KENTUCKY ENGINEERING GROUP, PLLC AND ACTING THIS DRAWING WAS PREPARED AT THE SCALE INDICATED. INACCURACIES IN THE STATED SCALE MAY BE INTRODUCED WHEN DRAWINGS ARE REPRODUCED BY ANY MEANS. USE THE GRAPHIC SCALE BAR IN THE

DATE:	JUNE, 2022			
PROJECT MGR:	RCC			
DRAWN BY:	JAB			
CHECKED BY:	RCC			
SCALE: AS NOTED				
2022 © Kentucky Engineering Group, PLL				



CONTRACT No. 2 -50,000 GALLON GROUND STORAGE TANK WATER SYSTEM IMPROVEMENTS

GARRARD COUNTY WATER ASSOCIATION Garrard County, Kentucky

50,000 GALLON GROUND STORAGE TANK ENLARGED SITE PLANS

19014-02

○ REFERENCE NOTES:

6. CHAIN LINK SECURITY FENCE (SEE DETAIL, SHEET 5)

1. 50,000 GALLON GROUND STORAGE TANK

2. VALVE VAULT (SEE DETAIL, SHEET 5)

5. OVERFLOW (SEE DETAIL, SHEET 5)

7. DOUBLE 6' GATES (SEE DETAIL, SHEET 5)

8. ACCESS ROAD (SEE DETAIL, SHEET 5)

4. CONNECT TO EX. 4" W.M.

9. 12" CROSS DRAIN (TYP.)

3. 4" DIP


SEE DEMOLITION GENERAL NOTES -5. ANY APPURTENANCES (INCLUDING VALVES, HYDRANTS, ETC.) SHALL BE RETURNED TO THE OWNER AT NO ADDITONAL COST 6. REGRADE THE ENTIRE SITE TO PROVIDE POSITIVE DRAINAGE AND RESEED AND MULCH WITH STRAW THE ENTIRE SITE IN ACCORDANCE WITH THE SPECIFICATIONS NEW TANK GENERAL NOTES: 1. TANK CONTRACTOR TO SUBMIT FOR APPROVAL THE STRUCTURAL DESIGN PLANS AND CALCULATIONS FOR THE TANK AND FOUNDATION. PLANS TO BE STAMPED AND SIGNED BY A REGISTERED STRUCTURAL ENGINEER LICENSED IN THE STATE OF KY. 2. TANK CONTRACTOR TO INSTALL CONDUIT AND SUPPPORT BRACKETS FOR ANTENNA 3. ACCESSORIES SHOWN ON ELEVATION DRAWING ARE ROTATED FOR CLARITY 4. ALL HANDRAILS, PLATFORM LANDINGS, WALKWAYS, LADDERS AND SAFETY CLIMB DEVICES SHALL CONFORM WITH CURRENT OSHA STANDARDS 5. STERILIZE TANK IN ACCORDANCE WITH AWWA C652-92 6. FOUNDATION DESIGN AND ANY SUBSEQUENT GEOTECHNICAL REPORT WILL BE THE RESPONSIBILITY OF THE TANK CONTRACTOR, INCLUDING THE SITE CLASS COEFFICIENT FOR SEISMIC DESIGN PER THE KENTUCKY BUILDING CODE 7. FOUNDATION CONSTRUCTION SHALL COMPLY WITH CURRENT (LATEST EDITION) AWWA STANDARDS D100-96, ACI 318-95 AND ACI 301-96 8. CONCRETE COMPRESSIVE STRENGTH SHALL BE 4,000 PSI @ 28 DAYS 9. SEE GEOTECHNICAL REPORT FOR SUBSURFACE INFORMATION AND RECOMMENDATIONS 10. CONTRACTOR SHALL PROVIDE SITE GRADING AS REQUIRED TO PROVIDE POSITIVE DRAINAGE AWAY FROM THE NEW WATER SURVEY CONTROL POINT 11. SEE ADDITIONAL NOTES ON SHEET 2 RELATED TO THE ACCESS ROAD DRAINAGE AND ENTRANCE. PNT NO. NORTHING EASTING ELEVATION 3712304.7106 5318468.7931 1274.14

IT IS A VIOLATION OF LAW FOR ANY PERSON TO ALTER UNDER THE DIRECTION OF A LICENSED ENGINEER.

ACTUAL SCALE.

DRAWING OR TITLE BLOCK TO DETERMINE THE

NO.	DATE	REVISIONS	ВХ

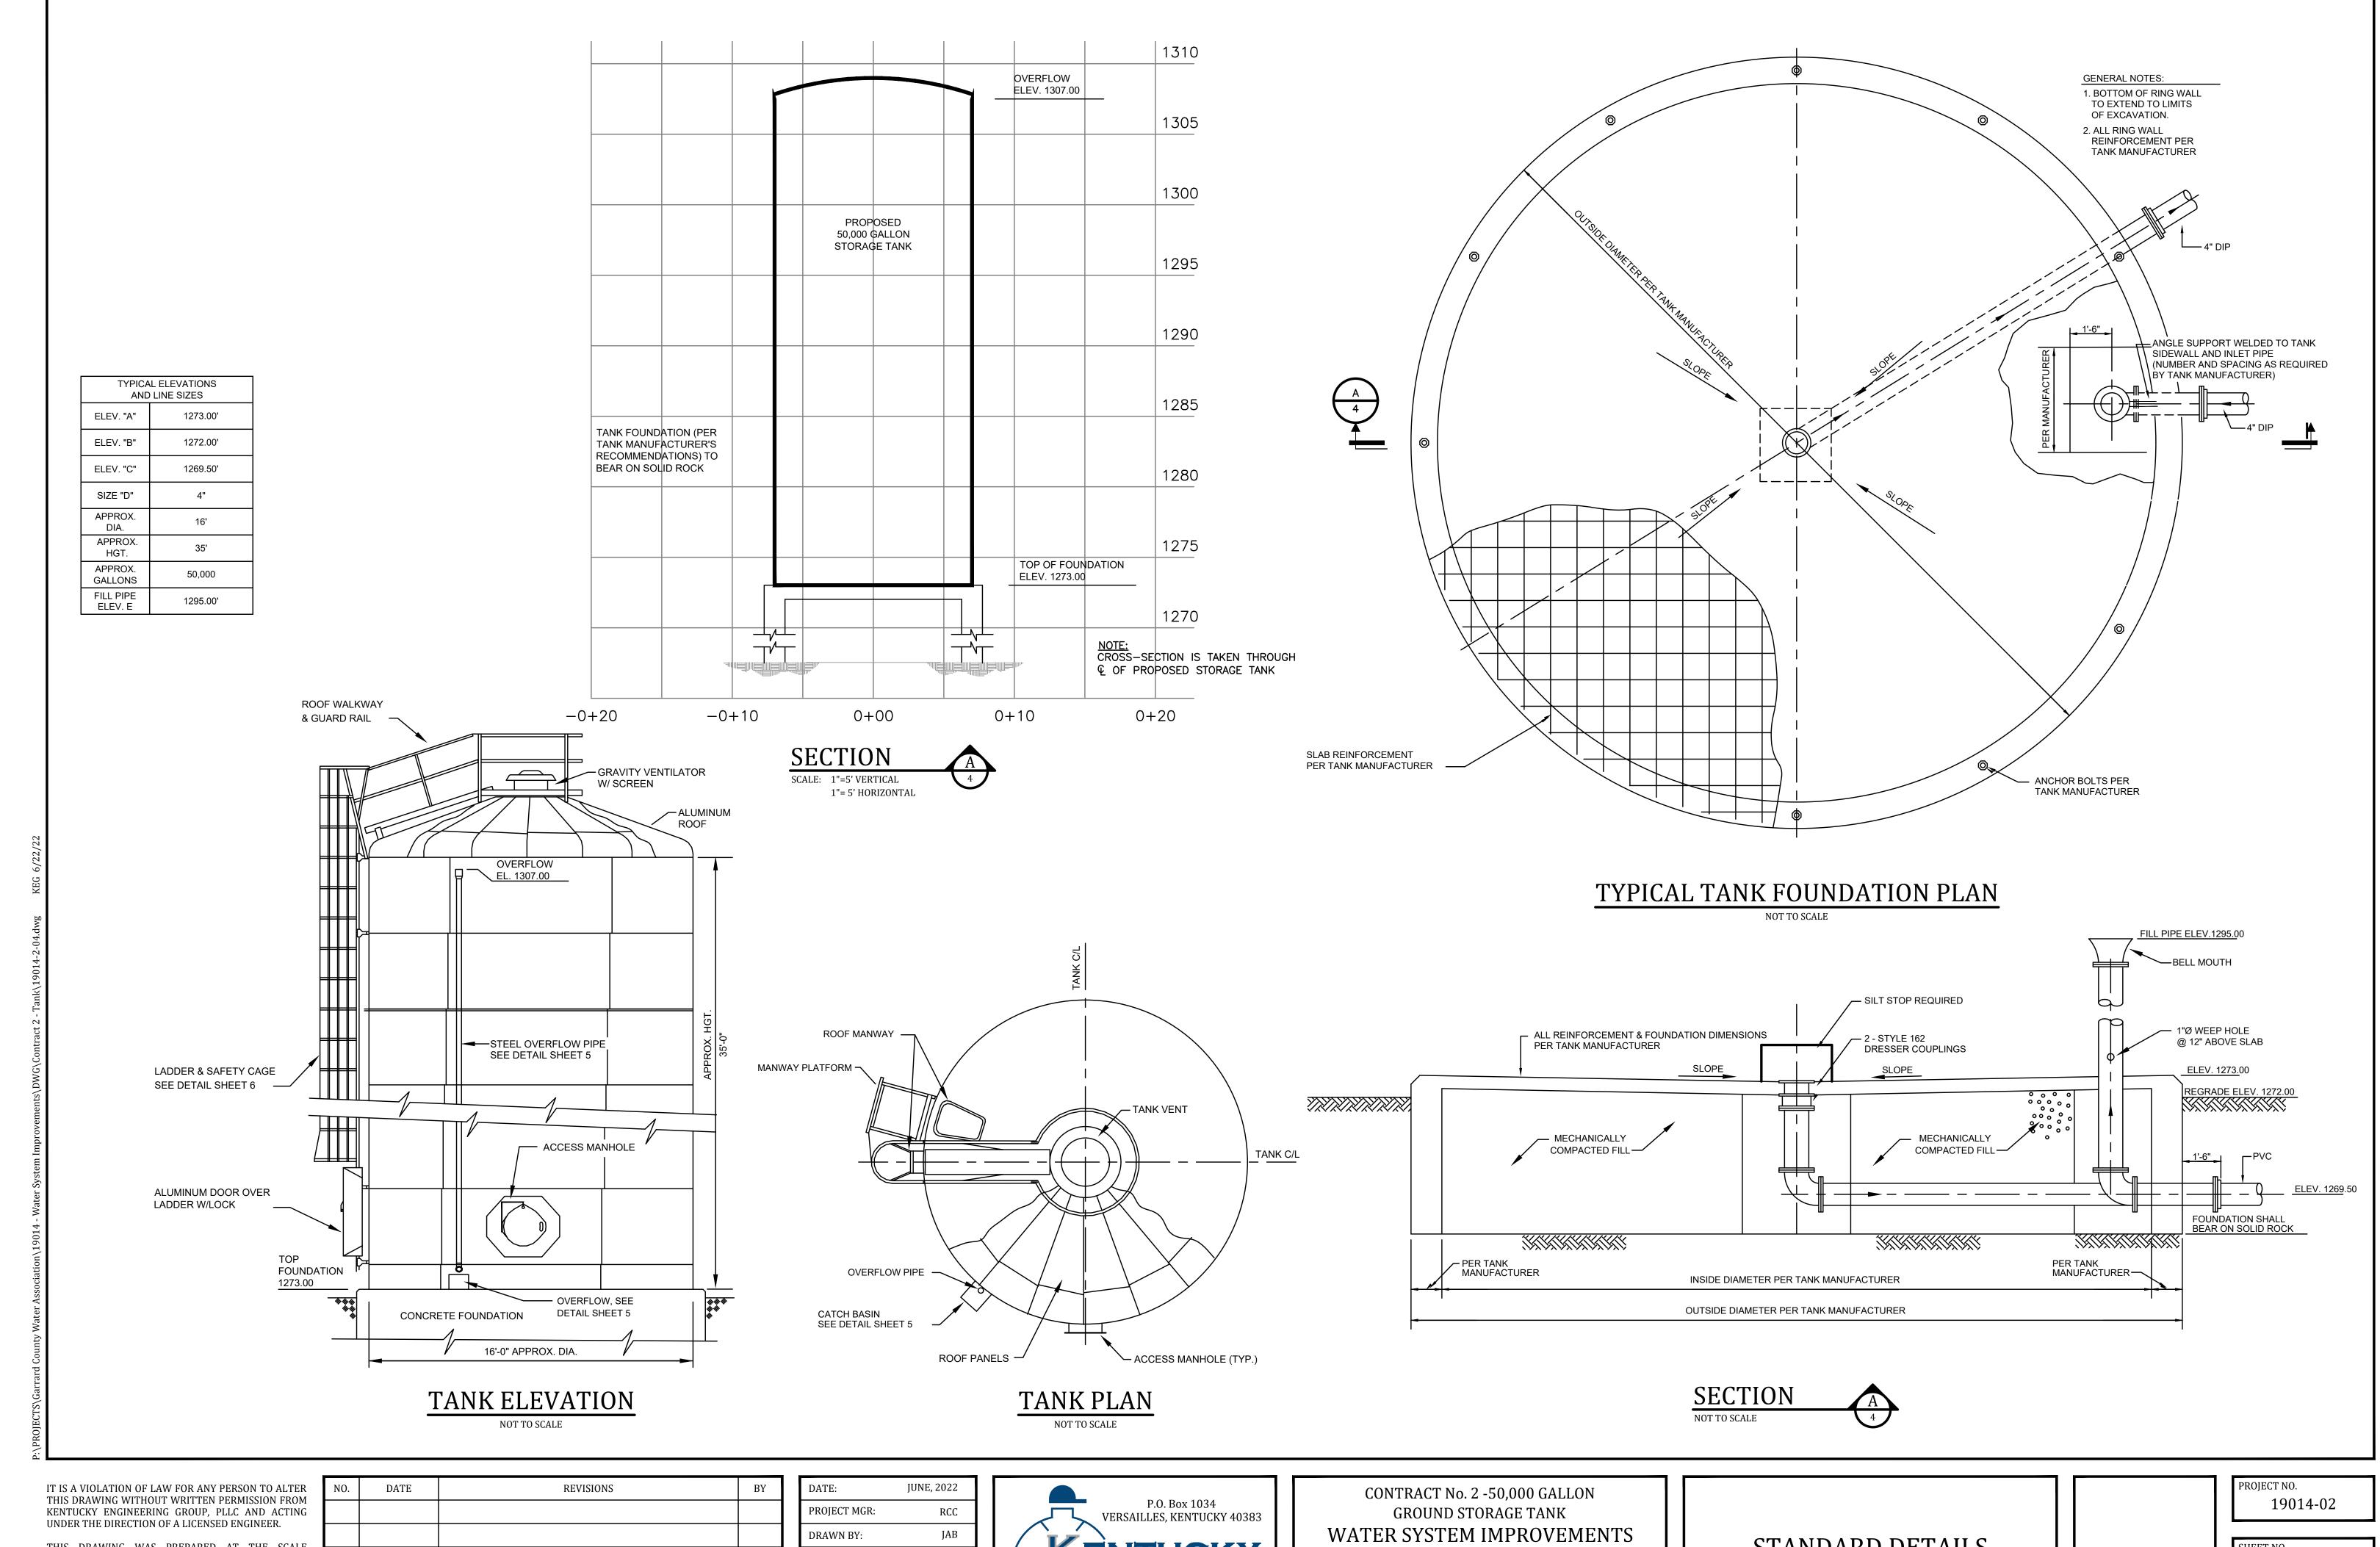

THIS DRAWING WAS PREPARED AT THE SCALE INDICATED. INACCURACIES IN THE STATED SCALE MAY BE INTRODUCED WHEN DRAWINGS ARE REPRODUCED BY ANY MEANS. USE THE GRAPHIC SCALE BAR IN THE DRAWING OR TITLE BLOCK TO DETERMINE THE ACTUAL SCALE.

NO.	DATE	KEVISIONS	DI


DATE:	JUNE, 2022				
PROJECT MGR:	RCC				
DRAWN BY:	JAB				
CHECKED BY:	RCC				
SCALE:	AS NOTED				
2022 © Kentucky Engineering Group, PL					




GARRARD COUNTY WATER ASSOCIATION
Garrard County, Kentucky


STANDARD DETAILS

o. 4

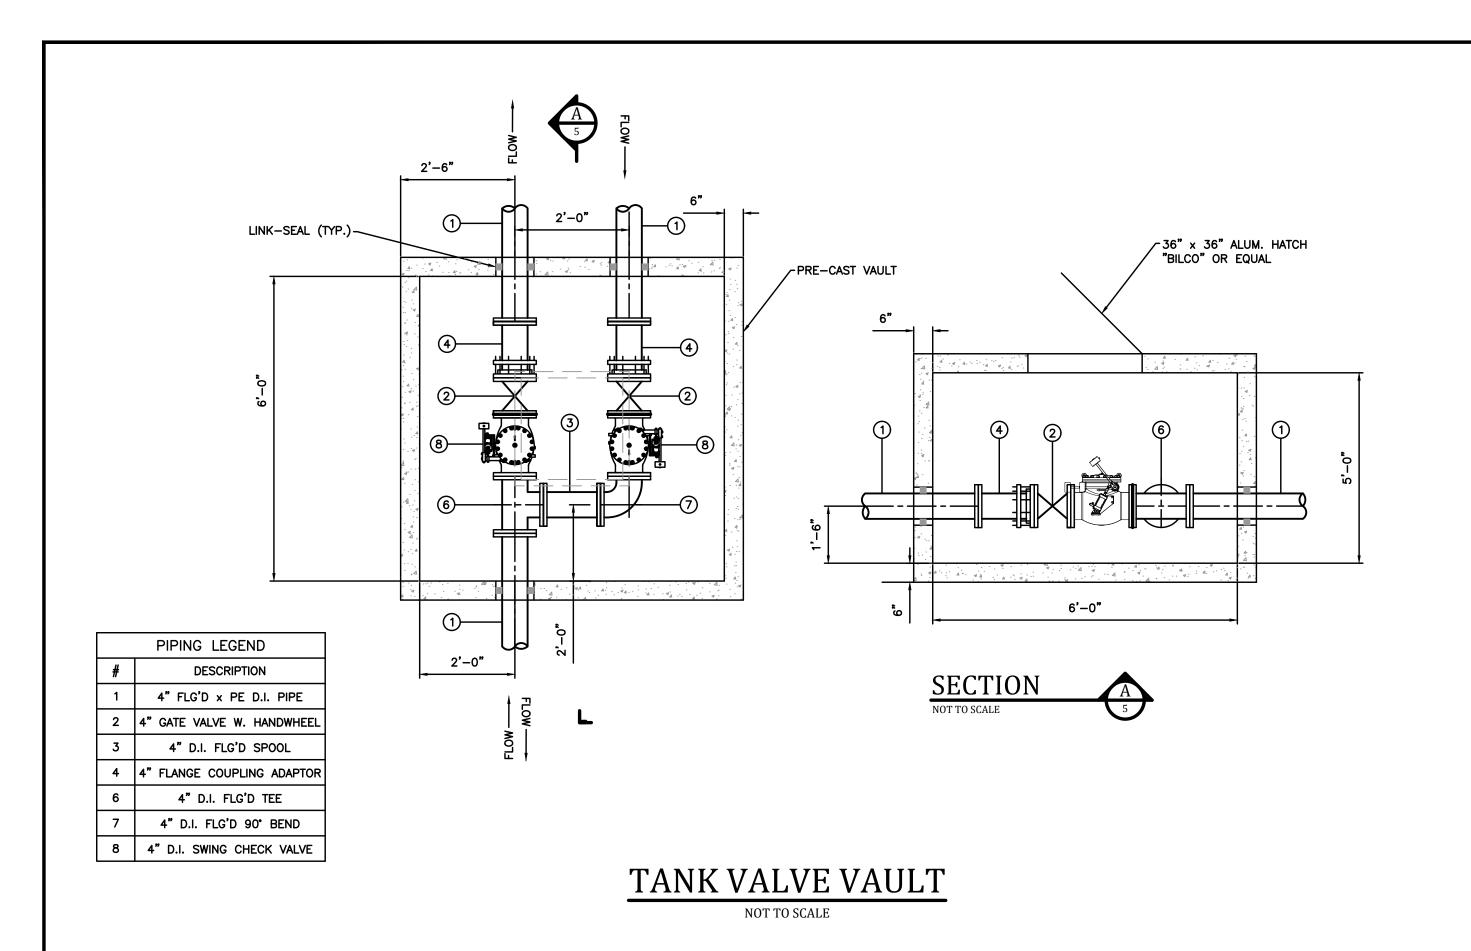

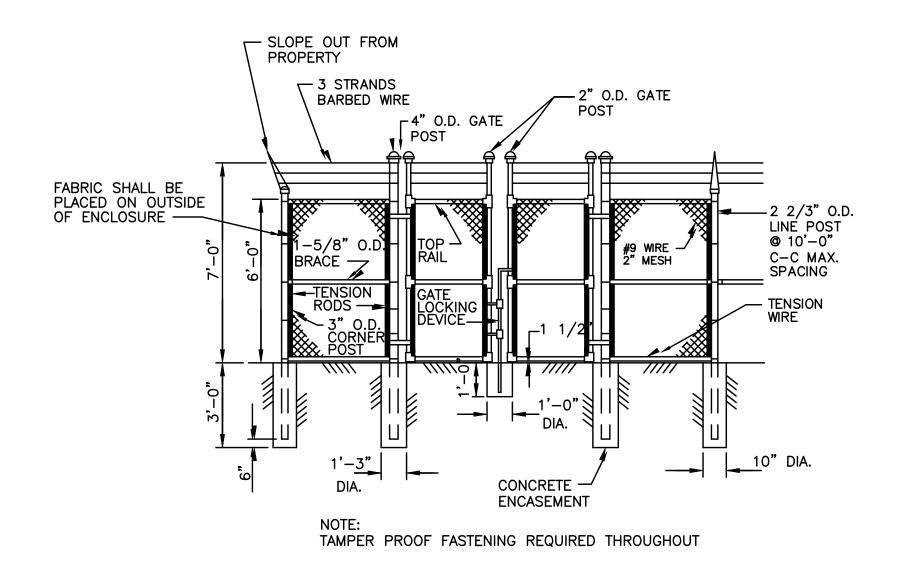


CHAIN LINK FENCE W/SWINGING GATES

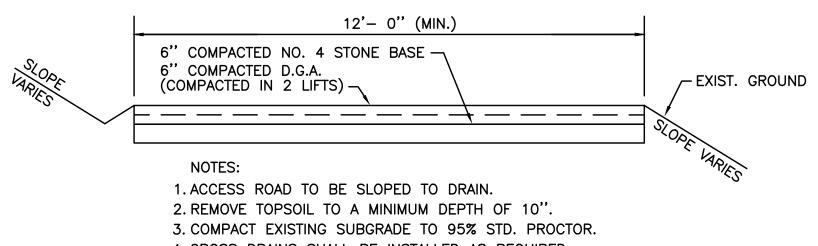

4. CROSS DRAINS SHALL BE INSTALLED AS REQUIRED.

TANK ACCESS ROAD and PARKING AREA

NOT TO SCALE

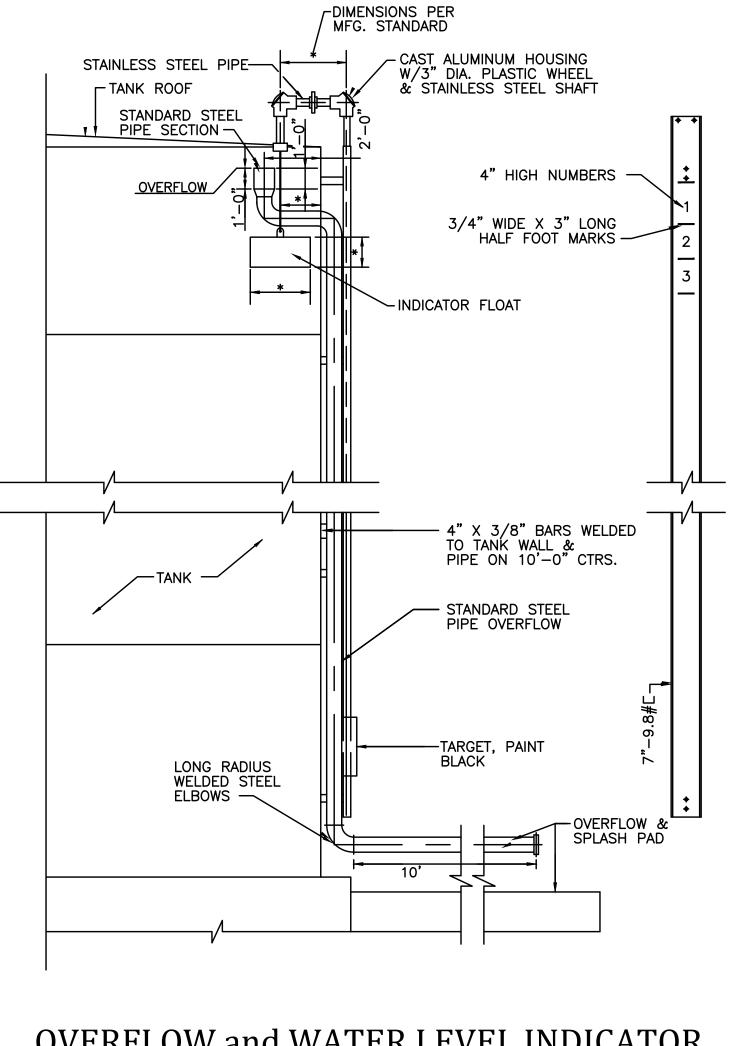


OVERFLOW and WATER LEVEL INDICATOR

NOT TO SCALE


PIPE				DIME	NCIONC			CLASS	REINF
DIA. OR SHAF		DIMENSIONS					CONC	STEEL	
EQUIV. DIA.	9	С	Е	F	Ш	W	Т	CY	Lbs.
PER SITE PLAN	\circ	1'-9"	2'-6"	2'-3"	3'-6"	4'-0"	2"	0.58	7

NOTES

- 1. DIMENSIONS AND QUANTITIES ARE BASED ON CONCRETE PIPE AND WILL VARY INSIGNIFICANTLY FOR CORRUGATED METAL PIPE.
- 2. REINFORCING STEEL: MINIMUM GRADE 40, BARS EVENLY SPACED.
- 3. $6 NO. 4 \times 12$ INCH DOWEL BARS.
- 4. 2 NO. 4 x (E DIMENSION MINUS 4 INCHES). 5. SLOPES SHALL BE WARPED TO FIT HEADWALL WHEN PIPE IS SKEWED AND/OR NORMAL SLOPE VARIES FROM 1:2.
- 6. VOLUME DISPLACED BY PIPE COMPUTED USING INSIDE DIAMETER OF PIPE.
- 7. WING ANGLES AND/OR DIMENSIONS MAY BE ALTERED DURING CONSTRUCTION TO ACCOMMODATE FLOW OF WATER.
- 8. APRON BETWEEN WINGS SHALL BE SLOPED IN DIRECTION OF FLOW EQUAL TO SLOPE OF PIPE. FRONT FACE OF HEADWALL SHALL REMAIN VERTICAL. 9. HEADWALLS ARE FOR CIRCULAR, ARCH, AND HORIZONTAL ELLIPTICAL 12" TO 27" EQUIVALENT PIPE SIZES. SEE CURRENT STD. DWG. RDI-001, FOR NON-CIRCULAR PIPE EQUIVALENT SIZES.
- 10. ALL DIMENSIONS ARE IN INCHES UNLESS SHOWN OTHERWISE. 11. FINAL LOCATION OF HEADWALL TO BE FIELD LOCATED FOR EACH TANK SITE FOR POSITIVE DRAINING.

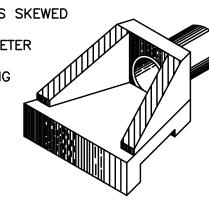

ISOMETRIC VIEW

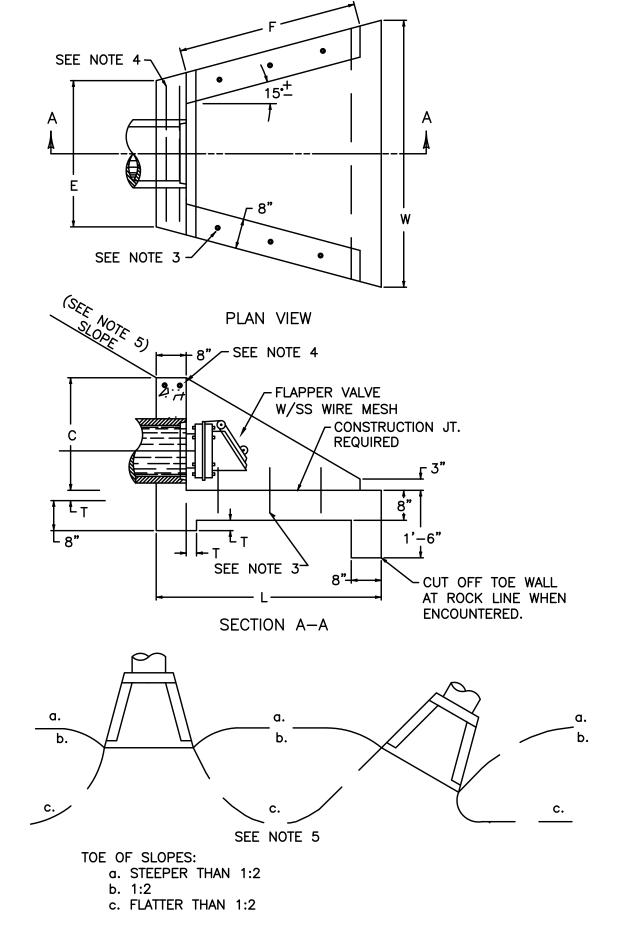

TANK DRAIN and HEADWALL DETAIL


NOT TO SCALE

IT IS A VIOLATION OF LAW FOR ANY PERSON TO ALTER THIS DRAWING WITHOUT WRITTEN PERMISSION FROM KENTUCKY ENGINEERING GROUP, PLLC AND ACTING UNDER THE DIRECTION OF A LICENSED ENGINEER.

THIS DRAWING WAS PREPARED AT THE SCALE INDICATED. INACCURACIES IN THE STATED SCALE MAY BE INTRODUCED WHEN DRAWINGS ARE REPRODUCED BY ANY MEANS. USE THE GRAPHIC SCALE BAR IN THE DRAWING OR TITLE BLOCK TO DETERMINE THE ACTUAL SCALE.

NO.	DATE	REVISIONS	BY	

DATE:	JUNE, 2022	
PROJECT MGR:	RCC	
DRAWN BY:	JAB	
CHECKED BY:	RCC	
SCALE:	AS NOTED	
2022 © Kentucky Engineering Group, PLLC		

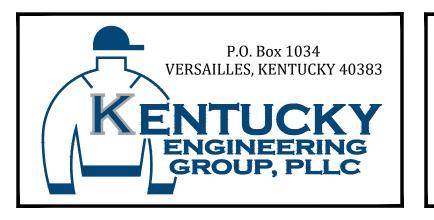


CONTRACT No. 2 -50,000 GALLON GROUND STORAGE TANK WATER SYSTEM IMPROVEMENTS

GARRARD COUNTY WATER ASSOCIATION Garrard County, Kentucky

STANDARD DETAILS

19014-02

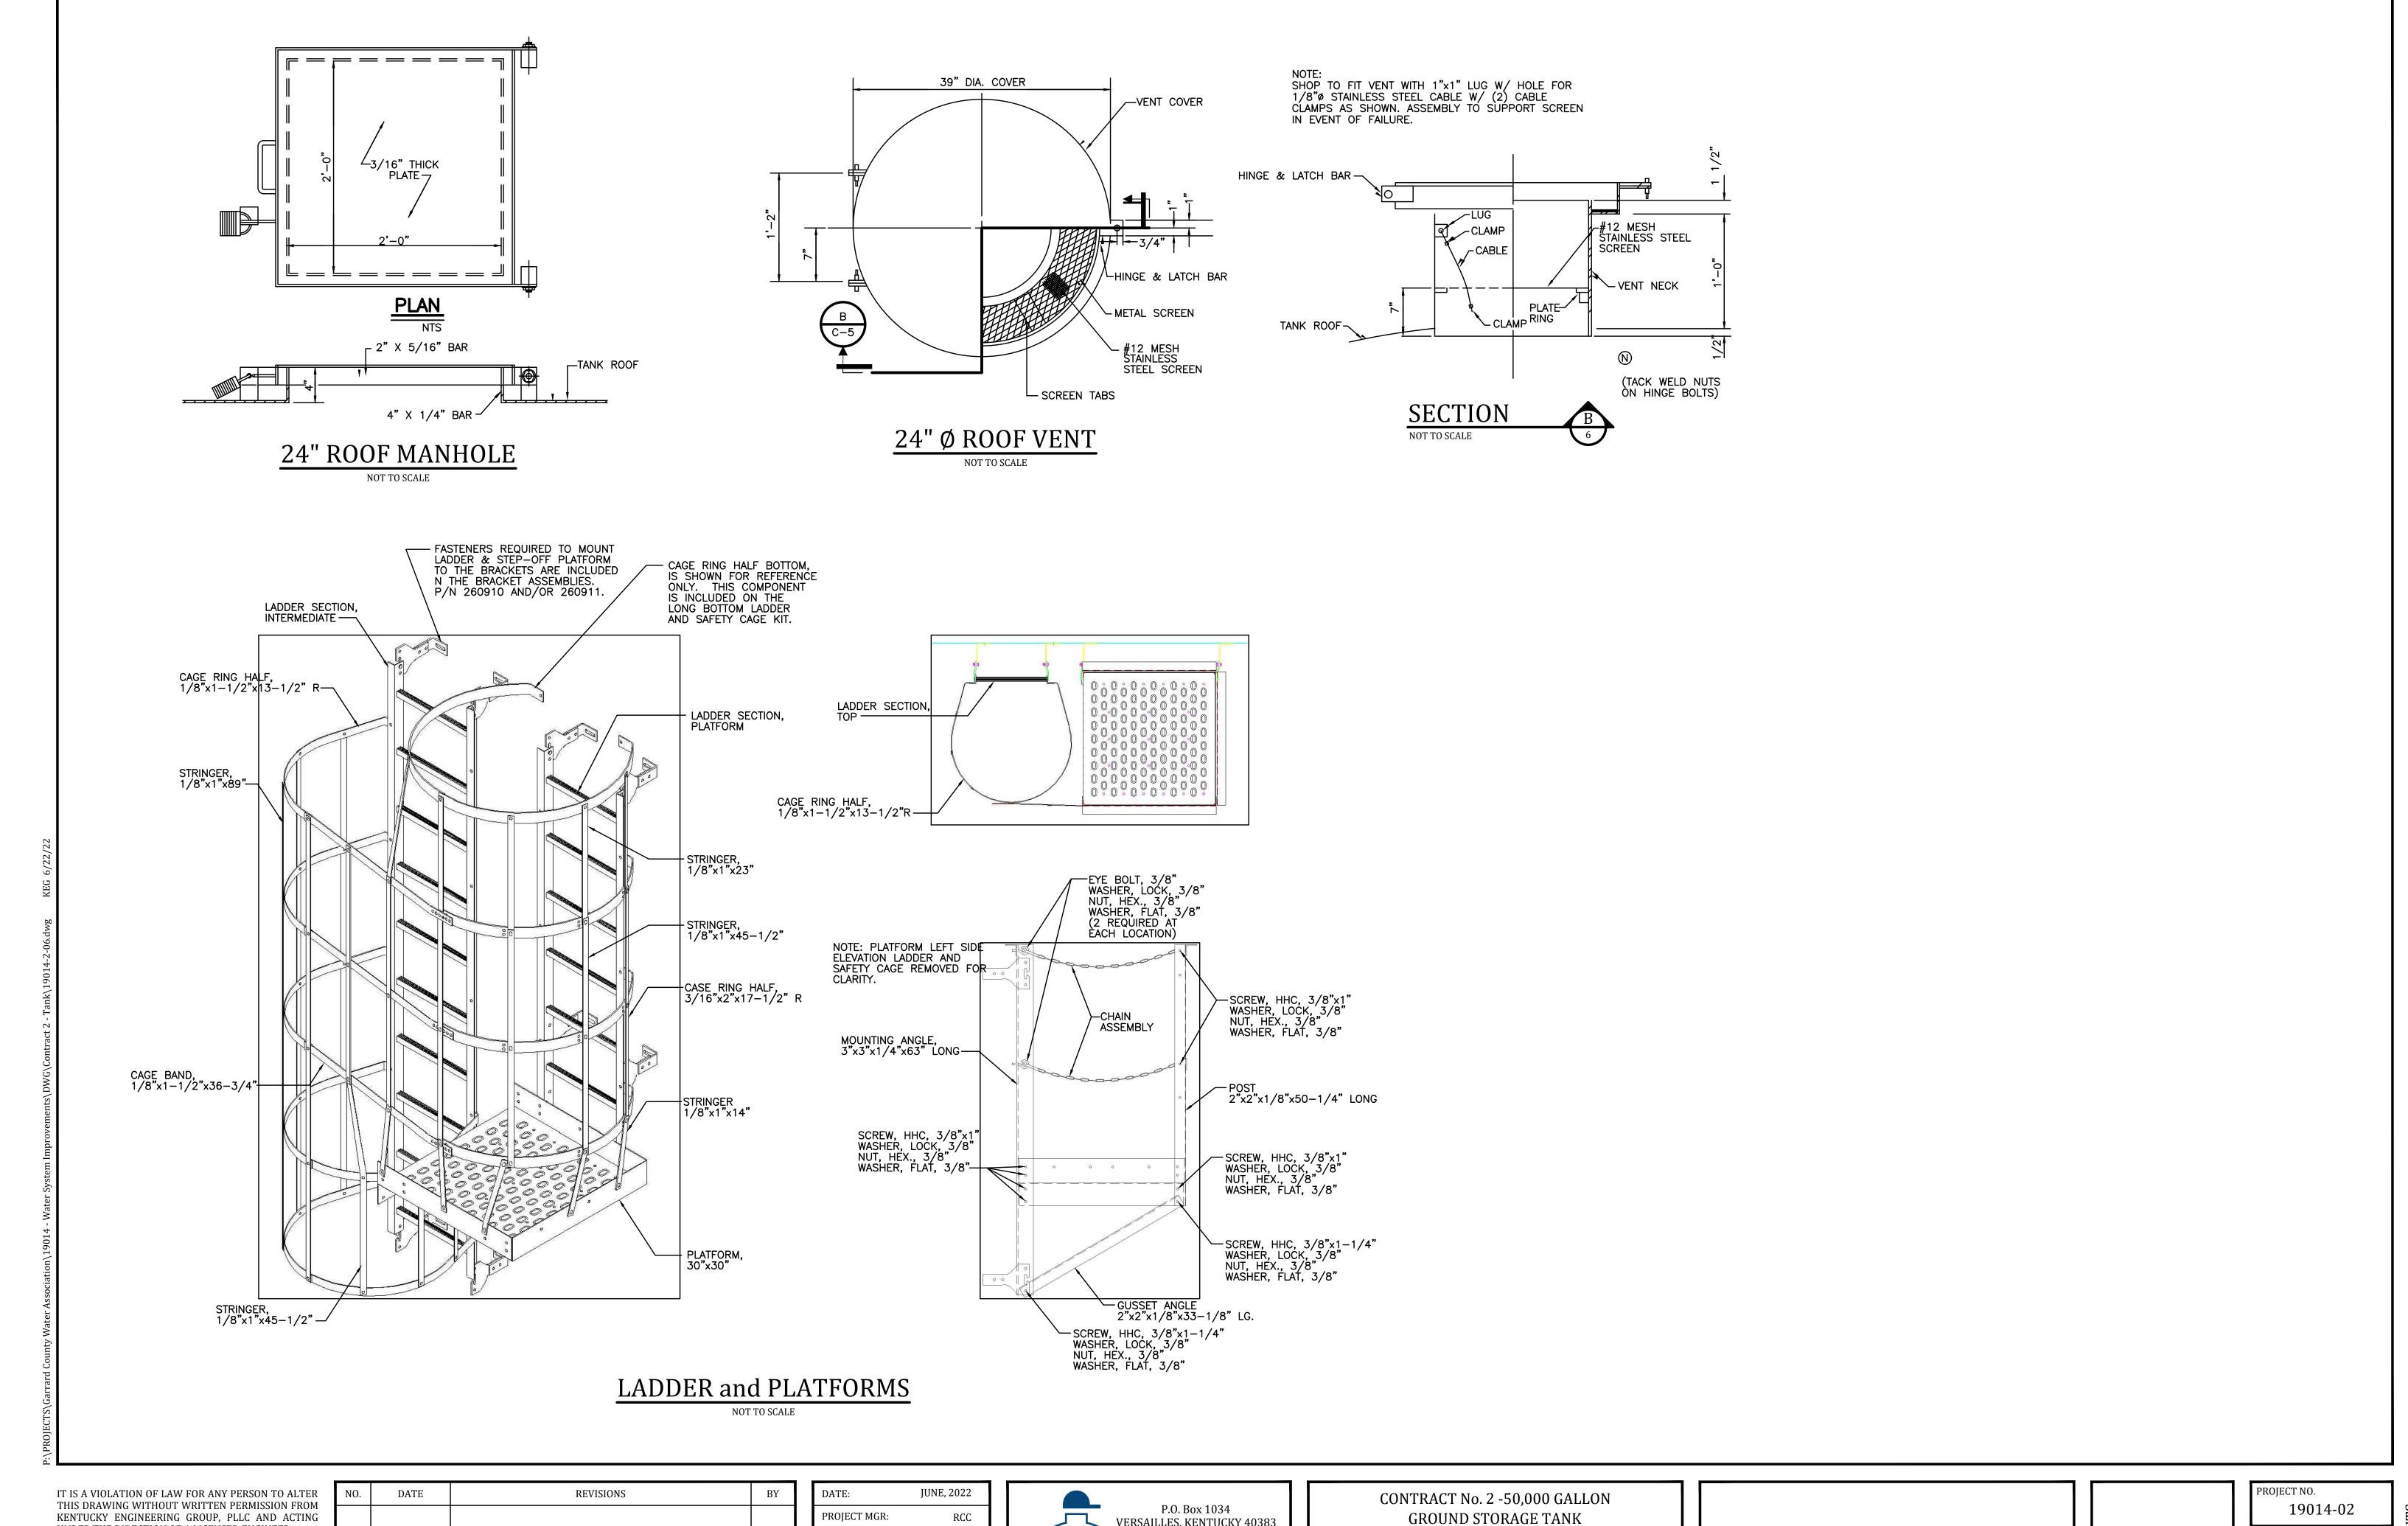


UNDER THE DIRECTION OF A LICENSED ENGINEER.

THIS DRAWING WAS PREPARED AT THE SCALE INDICATED. INACCURACIES IN THE STATED SCALE MAY BE INTRODUCED WHEN DRAWINGS ARE REPRODUCED BY ANY MEANS. USE THE GRAPHIC SCALE BAR IN THE DRAWING OR TITLE BLOCK TO DETERMINE THE ACTUAL SCALE.

NO.	DATE	REVISIONS	BY	

DAT	`E:	JUNE, 2022
PRO	JECT MGR:	RCC
DRA	AWN BY:	JAB
СНЕ	CKED BY:	RCC
SCA	LE:	AS NOTED
2022	© Kentucky Engin	eering Group, PLLC

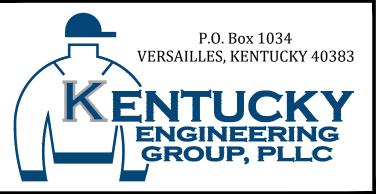

WATER SYSTEM IMPROVEMENTS

GARRARD COUNTY WATER ASSOCIATION Garrard County, Kentucky

STANDARD DETAILS