
SANITARY SEWER COLLECTION SYSTEM EXPANSION HWY 701 PUMP STATION - CHANGE ORDER # 2 CONTRACT NO. 39

LOCATION

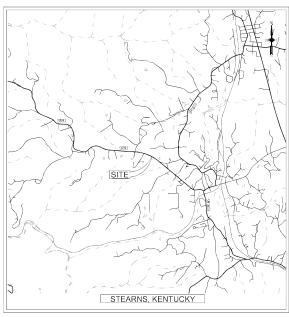

SCALE: 1"=1000"


BOARD OF COMMISSIONERS

RANDY KIDD, CHAIRMAN MAYNARD NEW DOUG SEXTON COY TAYLOR RAYMOND TAYLOR STEPHEN WHITAKER, SUPERINTENDENT Prepared For:

MARCH 2022

McCREARY COUNTY WATER DISTRICT 456 N. HWY 27

WHITLEY CITY, KENTUCKY 42653

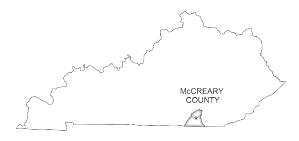




INDEX OF DRAWINGS

1	COVER
	33721
2	GENERAL NOTES, ABBREVIATIONS, LEGEND AND UTILITIES
64-65	LINE STN-15 PROFILE
103	HWY 701 PS SITE PLAN
104	

LOCATION

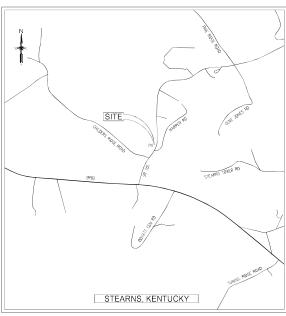

SCALE: 1"=500'





GENERAL NOTES

- EXISTING UTILITY LOCATIONS ARE APPROXIMATE ("=50". IT IS THE CONTRACTOR'S RESPONSIBILITY TO NOTE'S UTILITY COMPANIES AND VERBY UTILITY LOCATIONS PRIOR TO CONSTRUCTION. THE COMMER AND THE NOT RESPONSIBLE FOR DAMAGES TO EXISTING UTILITIES THAT AUGUST OCCUR DURING CONSTRUCTION.
- THE CONTRACTOR SHALL BE RESPONSIBLE FOR COORDINATING THE LOCATION OF THE EXISTING UNDERGROUND UTILITIES BY CALLING BUD (BEFORE YOU DIG). 800-752-8007.
- ANY ADJUSTMENTS OF RELOCATIONS OF EXISTING WATER AND GAS UTILITIES, DISTRIBUTION LINES ANY AUGO PERSON OF THE RECOGNITION OF ENGINE WATER AND ONE OILLIES, OPERMODITOR (THE OF SERVICE LINES SHALL BE REPORTED BY OTHERS THE CONTRACTOR SHALL TARK SPECIAL CASE TO PROTECT ENSINES OILLIES TO MEET TO MINUS ENSINES PRACTICABLE. THE CONTRACTOR SHALL CORDINATE WORN WITH THE OWNER AND ENGINEER OF SHAPPING OF SOURCE THE CONTRACTOR SHALL NOTEY THE OWNER AND ENGINEER OF DAYS IN ADVANCE OF ANY MORE WHICH PROJECTS DESTRICT OF THE TENT OF SHAPPING SHAPPING
- ANY UNSUITABLE SUBGRADE MATERIAL ENCOUNTERED SHOULD BE REMOVED AND REPLACED WITH PROPERLY COMPACTED ENGINEERED FILL AT THE CONTRACTORS EXPENSE.
- COMBINATION AIR RELEASE VALVES SHALL BE PLACED AT HIGH POINTS IN FORCE MAINS 1"=50". LOCATIONS ARE APPROXIMATE.
- ALL NON-PAYED DISTURBED AREAS SHALL BE REVISIONATED AFTER MORK IN THE IMMEDIATE MICHAY HAS REPU COMPLETED IN ACCORDANCE WITH THE SPECIFICATIONS. REVISIONATION SHALL BE COMPLETED NO LATER THAN TITO (2) MEERS FOLLOWING COMPLETION OF MORK IN THE IMMEDIATE MONTY.
- EXCAVATION IS UNCLASSIFIED; NO SEPARATE PAYMENT SHALL BE MADE FOR ROCK REMOVAL. BIDDERS ARE ENCOURAGED TO EXCAVATE TEST HOLES WITH COORDINATION OF THE OWNER. NO BLASTING WILL BE ALLOWED.
- THE CONTRACTOR SHALL MAINTAIN CONTINUOUS ACCESS TO ALL COMMERCIAL ESTABLISHMENTS AND RESIDENTIAL DWELLINGS.
- FOR EROSION CONTROL PURPOSES, THE CONTRACTOR SHALL STOCKPILE EXCAVATED TRENCH MATERIAL ON THE UPHILL SIDE (OPPOSITE OF STREAM) OF EXPOSED TRENCH.
- ALL NEW MANHOLES SHALL INCLUDE FLOW CHANNELS WITH DEPTHS EQUAL TO THE DIAMETER OF THE SEWER PIPE.
- 13. ALL MANHOLES ARE 4' DIAMETER UNLESS OTHERWISE NOTED.
- CONTRACTOR IS RESPONSIBLE FOR TEMPORARY FACILITIES TO MAINTAIN SEWER SERVICE. NO BYPASSES SHALL BE ALLONED. CONTRACTOR SHALL SUBWIT A CONSTRUCTION PHASING PLAN TO INCLUDE MAINTAINING EXISTING SERVICE.
- NEW SANITARY SEWERS WILL NOT BE ACCEPTED UNTIL ALL TESTING REQUIRED BY THE CONTRACT DOCUMENTS ARE CONDUCTED.
- MANHOLE RIMS SHALL BE SET TO SPECIFIED GRADES, BUT IN NO CASE BELOW SURROUNDING GROUND.
- ALL FORCE MAINS SHALL BE MARKED BY USING DETECTABLE MOLAR SEWER LINE TAPE APPROVED BY THE ENGINEER. (18" BELOW FINAL GRADE).
- BENCHMARKS/CONTROL POINTS ARE SHOWN ON EACH SITE PLAIR. THE CONTRACTOR SHALL USE THESE POINTS FOR LAYOUT OF THE PROPOSED WORK.
- ELEVATIONS SHOWN ARE BASED ON FEET ABOVE MEAN SEA LEVEL, FROM OPS NADRS. THE CONTRACTOR SHALL HIGHEY THE ENGINEER IMMEDIATELY OF ANY DIFFERENCES IN FELD CONCITIONS AND THE MAPPING.
- NO SEPARATE PAY ITEM HAS BEEN ESTABLISHED FOR HITMOS AND NO DETERMINATION OF THE MANAGE OF HITMOS REQUIRED ON THE JOB HAS BEEN MADE. THE COMPRECTOR, DURING THE BOOMON PHASE, PAUL DETERMINE THE HUMBER OF "FITTINGS REQUIRED ON THE JOB HAVE OF THE JOB HAVE ON THE CONTRACT WITH PRICE OF IT OF PRESE ONLY THE JOB HAVE WALLT.
- SLIT CHECKS/FENCES SHALL RE PROVIDED TO PREVENT SEDMENT RUNOFF FROM ENTERING THE CREEK. SLIT CHECKS SHALL BE INSTALLED PER THE SPECIFICATIONS.
- 22. CONTRACTOR SHALL BISSIRE THAT ALL NEW AND REPAYED AREAS ALLOW THE FOLLOWING.

 -SLOPE DIRECTS RAINFALL TO CATTH BASING OR DRASS AREAS.

 -SLOPE DIRECTS RAINFALL MAY FROM ALL STRUCTURES.

 -PAYERIENT AND BACKFILL IS PLACED IN A MAINER WHICH PROHEITS PONDING.
- CONTRACTOR SHALL REPAIR OR REPLACE AREAS OF ROADS, DRIVEWAYS, OR SIDEWALKS DAMAGED DURING CONSTRUCTION.
- 24. ALL FITTINGS 4" AND LARGER SHALL BE DUCTILE IRON RESTRAINED JOINT.
- ALL FORCE MAINS SHALL BE MARKED BY USING DETECTABLE MYLAR WATER LINE TAPE AND COPPER TRACER WIRE APPROVED BY THE ENGINEER. (A MINIMUM OF 18" BELOW FINAL GRADE).
- SETIO TANK AND HOURING TANK LOCATIONS OF SHOW) ARE APPROPRIATE CONTRACTOR SHALL CEPT CONTRACT TANKS AND SETIM OF LEGISLE FROM THE SET OTHER COLOMATION. IF THIS CAN SET LEGISLE TO SET OTHER COLOMATION. IF AND LEGISLE LEGISLE ARE AND TO SE DIMESTALL OBEY OWNER THAN 3 OF COMES! THEN THE CONTRACTOR IS RESPONSIBLE TO BRIDGE HIS FROM THE CONTRACTOR IS RESPONSIBLE TO BRIDGE HIS FOR DECEMBER AND TO DESIGNATE THE WORLD THE CONTRACTOR IS RESPONSIBLE TO BRIDGE HIS FOR TO DESIGNATE THE WORLD THE CONTRACTOR IS TO THE DEMORET PRIOR TO DESIGNATE THE WORLD THE STATE OF THE PRIOR TO THE DEMORET PRIOR TO DESIGNATE THE WORLD THE STATE OF THE PRIOR THE PRIOR THE THE STATE OF THE STATE
- LATERAL SEMER (INES SHALL BE 4-INCH PVC 35 UNIESS NOTED OTHERWISE. LINES SHALL MAINTAIN A UNIFORM SOPE OF A MINIMUM OF 18. CLEANOUTS (CO) SHALL BE INSTALLED AT ALL HORIZOTHAL AND SEMENCE MANAGES IN OPERIOD AND SHALL BE INSTALLED AT RUNS SUCH THAT THE MAXIMUM DISTANCE BETWEEN CLEANOUTS IS 200 FEET.

- 28. EFFORTS HAVE BEEN MADE TO INDICATE THE MOST ACCURATE LOCATIONS OF EXISTING STRUCTURES, PIENC, AND UTILITIES. THE CONTRACTOR SHALL BECOME FAMILIAR MITH THE SITE, AND NOTIFY THE ENGINEER OF ANY DISCREPANCES ENCOUNTERED BEFORE RECOGNING CONSTRUCTION OPERATIONS. SITE PIPING DIMENSIONS ARE GIVEN TO SHOW THE ENGINEER'S INTENT AND TO AID THE CONTRACTOR IN PIPE INSTALLATION.
- 29. DIMENSIONS OF EXISTING STRUCTURES AND/OR SIZE RESTRICTIONS ARE APPROXIMATE. ALL RECESSARY DIMENSIONS AND ELEVATIONS OF ENTING STRUCTURES AND TOCOMERNITY SHALL BE VEHICLE OF THE CONTRACTOR IN THE FILED PRIOR TO CONSTRUCTION OFERSTIONS.
- 30. CONTRACTOR SHALL MAINTAIN ACCESS TO EXISTING FACILITIES DURING CONSTRUCTION. 31. CONSTRUCTION SHALL BE IN COMPLIANCE WITH ALL APPLICABLE PERMIT REQUIREMENTS.
- 32. PRING NOCATED OVI SITE PLANCS IS TO AN EXTENT SCHEMATIC IN NATURE, PROPOSED NOSK NOCATED AUGUST REQUIRE SHETING TO ANDE CONFLICT WITH EVET PRING, CHILITES, ALL PRINGS PER NOT HOWN IN THE CONTRACTOR SHALL PROVIDE ALL PRINGS PECUACION FROM THINGS PECUACION TO TRANSITION OVER NEW AND EVIST.
- 33. IT IS THE CONTRACTOR RESPONSIBILITY TO DETERMINE THE PRESENT OF UNDERGROUND UTILITIES INCLUDING THEIR LOCATION(S) AND ELEVATION(S).
- THE CONTRACTOR SHALL BE RESPONSIBLE FOR ANY AND ALL MODIFICATIONS TO EXISTING PIPMIG REQUIRED TO ACCOMMODATE NEW CONSTRUCTION.
- 35. ALL PIPING SHALL BE TESTED IN ACCORDANCE WITH THE SPECIFICATIONS.
- Sequencing of construction shall be coordinated with utility personnel and the engineer to ensure existing facilities remain in service during construction.
- THE CONTRACTOR SHALL BE RESPONSIBLE FOR VERFICATION/COCREINATION/LOCATION/SIZE OF ALL PENETRATIONS AND OPENINGS (WITH ALL TRADES AND MANUFACTURER(S).
- ANY SHADED NOTE DESCRIBING AN OBJECT OF DIRECTION THE CONTRACTOR SHALL BE UNDERSTOOD ON NOT APPLY TO THIS WORK. ALL PROPOSED WORK AND NOTES WILL BE SHOWN IN DAFKER TEXT AND LINE TYPES.
- UNLESS NOTED OTHERWISE, ALL EQUIPMENT AND MATERIALS TO BE REMOVED SHALL REMAIN PROPERTY OF THE OWNER.
- 40. ALL WALL PENETRATIONS FOR PIPING SHALL CONFORM TO THE STANDARD DETAILS AS REQUIRED BY THE CONTRACT DRAWINGS & SPECIFICATIONS UNLESS OTHERWISE NOTED.
- GENERALLY, NO PIPE SUPPORTS HAVE BEEN SHOWN. HOWEVER ALL PHIPING, INSIDE AND OUTSIDE, SHALL BE ADEQUATELY SUPPORTED SO AS NOT TO PRODUCE UNDUE STRAIN OR MERATINO IN PIPE JUNISTO OR EQUIPMENT. SEE SPECIFICATIONS.
- THE CONFIDENCE OF THE PROJECT AND THE SPECIFICATION OF THESE PARTITIES FROM BE EXPOSURE TO HEARTH AND AREIT HAZAROS. IT IS THE CONFIDENCES SERVICEBILITY TO CORPLAY WITH A PROJECT SETTER A MEDITAL OF SECTION SERVICED BY INTO MINES TO PREPARED AND IMPLIENTING A SITE PROJECT SPECIFIC HEARTH AND SHETTY FOR THE CONFIDENCES SERVICES, SHE OFFICE THE SHEET WITH AND SHETTY FAIL SHEAL ADMISSIONED THE HEARTH AND SHETTY FAIL SHEAL ADMISSIONED THE HEARTH A FAIL WITH SHEAL SHEALTH AND SHETTY FAIL SHEAL ADMISSIONED THE HEARTH AND SHETTY FAILS SHEAL A COPY OF THE CONFIDENCES SITE PROJECT SHEETING HEALTH AND SHETTY FAILS SHALL SEE ANALOGIC FOR SHEAL AT THE PROJECT SHEETING HEALTH AND SHETTY FAILS SHALL SEE

ABBREVIATIONS

AV — AIR/VACUUM VALVE	
B BOTTOM	
B BOTTOM C.I. CAST IRON	
© CENTERLINE	
CMP - CORRUGATED METAL PIPE	
CO CLEAN OUT	
CONC. CONCRETE	
CONC. CONCRETE CONST. CONSTRUCT	
OPP - CORRUGATED PLASTIC PIPE	
D DRAIN	
DIA, Ø DIAMETER	
D.I. DUCTILE IRON	
D.L.P. DUCTILE IRON PIPE	
DIST. — DISTURBED	
EL , ELEV. ELEVATION EOP EDGE OF PAVEMENT	
EDGE OF PAVEMENT	
EX., EXIST. — EXISTING	
FH FIRE HYDRANT	
FLHFLUSHING HYDRANT	
FM FORCE MAIN	
F.V. — FIELD VERIFY	
FC FLUSHING CONNECTION	
GAL. GALLON	
GL GAS LINE	
GM GAS METER	
GS GAS SERVICE LINE	
GV GATE VALVE	
HDPE HIGH-DENSITY	
POLYETHYLENE	
I.E. INVERT ELEVATION	
INV. INVERT	
KDOH KENTUCKY DEPARTMENT	
OF HGHWAYS	
LA LATERAL ASSEMBLY	

MAXIMUM MECHANICAL JOINT MINIMUM OUTSIDE DIAMETER POLYETHYLENE 990P ----PROPOSED

PVC POLYVINYL CHLORIDE RCP REINFORCED CONC. PIPE RED REDUCER REINF. REINFORCE(D) - SEPTIC TANK

T.B.A. TO BE ABANDONED T.B.R. TO BE REMOVED T.R. TO REMAIN TYP. TYPICAL TYP. TYPICAL U.N.O. UNLESS NOTED OTHERWISE VERT. VERTICAL WATER LINE WLM ------ WATER UNE MARKER MM WATER METER WS WATER SERVICE LINE UE UNDERGROUND ELECTRIC (08) — DIRECTIONAL BORE

LEGEND

EXISTING FEATURES	PROPOSED FEATURES
	PROP. WATER LINES
	PROP. ROADS
	PROP. STORM SEWER PIPE
EX. ROADS	x
—SS——SS——SS——EX, SANITARY SEWER	PROP. INTERMEDIATE CONTOURS
	PROP. INDEX CONTOURS
EX. STORM SEWER PIPE	
xx EX. FENCES	
EX. INTERMEDIATE CONTOURS	
EX. INDEX CONTOURS	

EX. GAS METER MICV FX GAS VALVE EX. WATER METER ● W/ FX WATER VALVE THE EX. FIRE HYDRANT (AV) EX. AIR /VACUUM VALVE

BENCHWARKS/CONTROL POINTS

EX. SANITARY SEWER MANHOLE

●□□ EX. CLEANOUT

EX. TREES

EX. POWER POLES

→ EX. GUY WIPES

- - - EX. STREAMS

EX. HEADWALLS

UTILITIES

CALL BEFORE YOU DICK

GAS: CITIPOWER 37 COURTHOUSE SQUARE WHITLEY CITY, KY 42653 MR. BILL WEBB PHONE: (608) 376-8373

TELEPHONE: HIGHLAND TELEPHONE CO-OP 26 CRIT KING ROAD WHITLEY CITY, KENTUCKY 42653 PHONE (606) 376-5311

FIBER OPTIC: AT&T 131 AMESBURY AVE. MIDCLESBORO, KENTUCKY 41965 MR. ODELL KEENE PHONE (606) 248-7243

POWER: SCUTH KENTICKY RECC 51 CENTERS AVENUE WHITLEY CITY, KY 42653 PHONE (800) 264-5112

WATER:
McCREARY COUNTY WATER DISTRICT
456 N. HWY 27
WHILEY CITY, KENTUCKY 42653
MR. STEPHEN WHITAKER
PHONE: 606-376-2540

CABLE:
SPECTRUM
SO26 SQUITH HIGHWAY 27
SQUERSET, KENTUCKY 42501
MR. DARRELL NAVE
OFFICE (606) 678—9215, EXT. 404
CELL: (606) 271—2501

SANITARY SEWER: MCCREARY COUNTY WATER DISTRICT 456 N. HWY 27 WHITLEY CITY, KENTUCKY 42653 MR. STEPHEN WHITAKER PHONE: 606-376-2540



ECLIPSE

McCREARY COUNTY
WATER DISTRICT
456 N. HWY 27
WHITLEY CITY, KENTUCKY 42653

L NOTES, ABBREVIATIONS, GEND AND UTILITIES R COLLECTION SYSTEM EXPANSION E ONE - CONTRACT No. 39

SHEET NUMBER


SANITARY



50 ARR WBD ARR ARR ARR 2020 MCCREARY COUNTY
WATER DISTRICT
456 N. HWY 27
WHITLEY CITY, KENTUCKY 42683 SANITARY SEWER COLLECTION SYSTEM EXPANSION PHASE ONE - CONTRACT No. 39





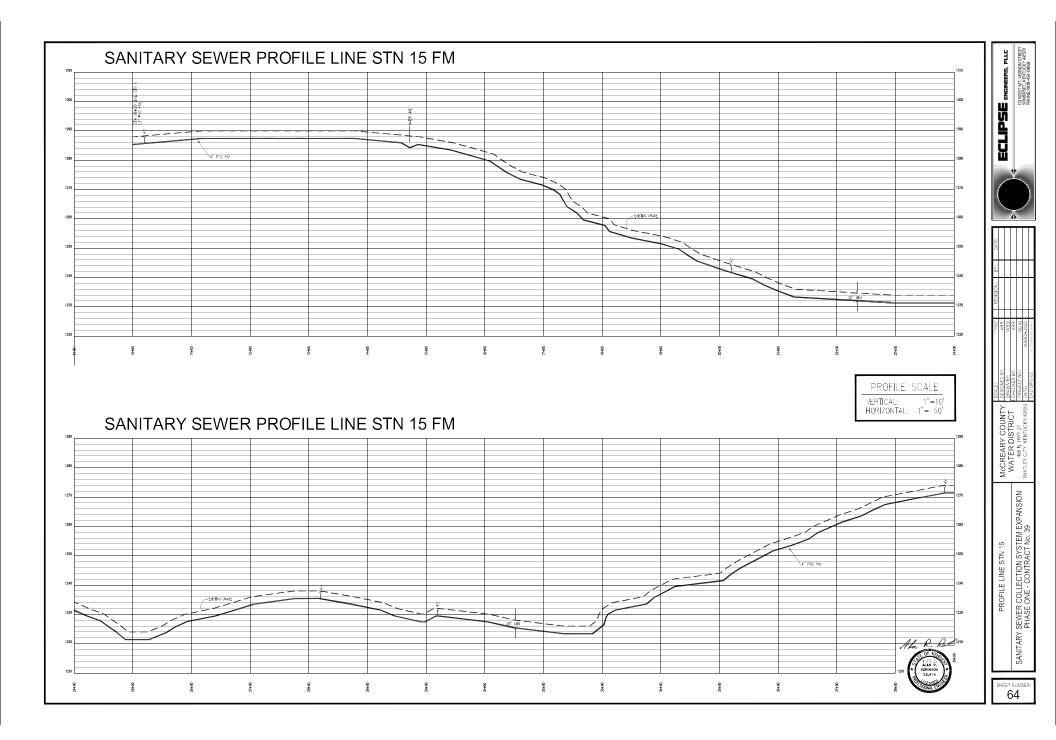


SANITARY SEWER PROFILE LINE STN 15 FM SANITARY SEWER PRO


PROFILE SCALE

VERTICAL: 1"=10'
HORIZONTAL: 1"= 50'

PROFILE LINE STN 17 FM

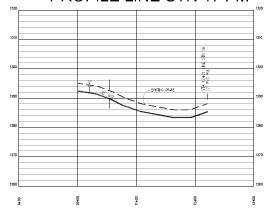


SANITARY SEWER PROFILE LINE STN 18 FM

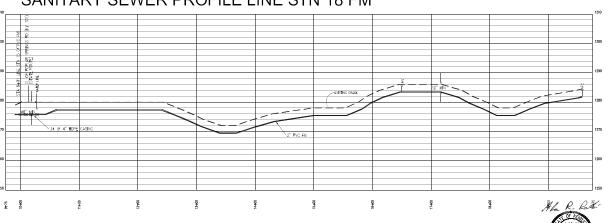

PROFILE LINE STN 15, STN 17, AND STN 18
SANITARY SEWER COLLECTION SYSTEM EXPANSION
PHASE ONE - CONTRACT No. 39

SHEET NUMBER:

McCreary County
Water District
456 N. HWY 27
WHITLEY CITY, KENTUCKY 42653

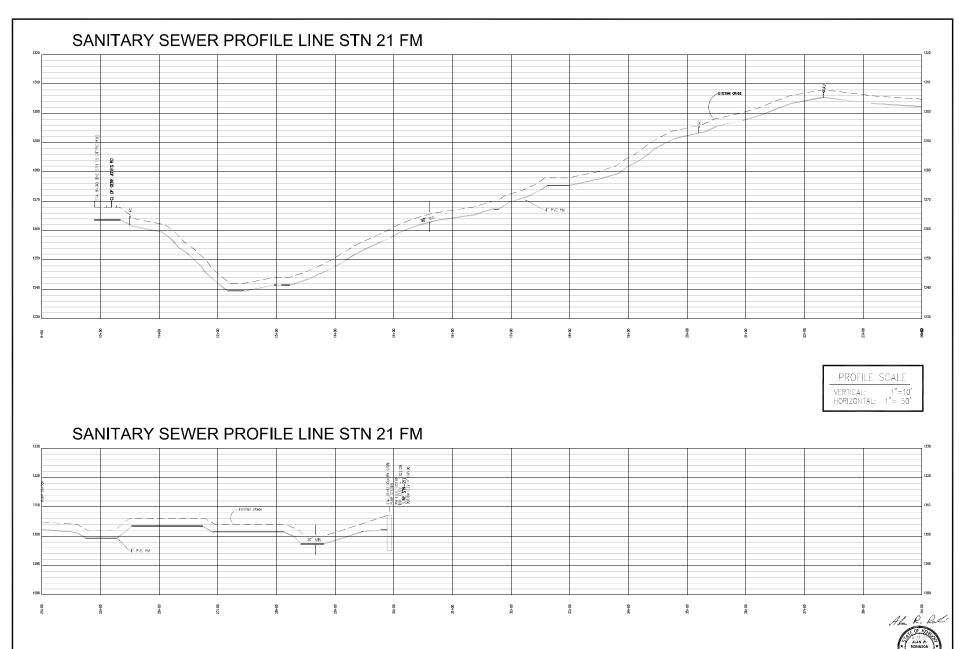


McCREARY COUNTY
WATER DISTRICT
456 N. HWY 27
WHITLEY GITY, KENTUCKY 42683

SANITARY SEWER COLLECTION SYSTEM EXPANSION PHASE ONE - CONTRACT No. 39 PROFILE LINE STN 21

SHEET NUMBER:



SHEET NUMBER:

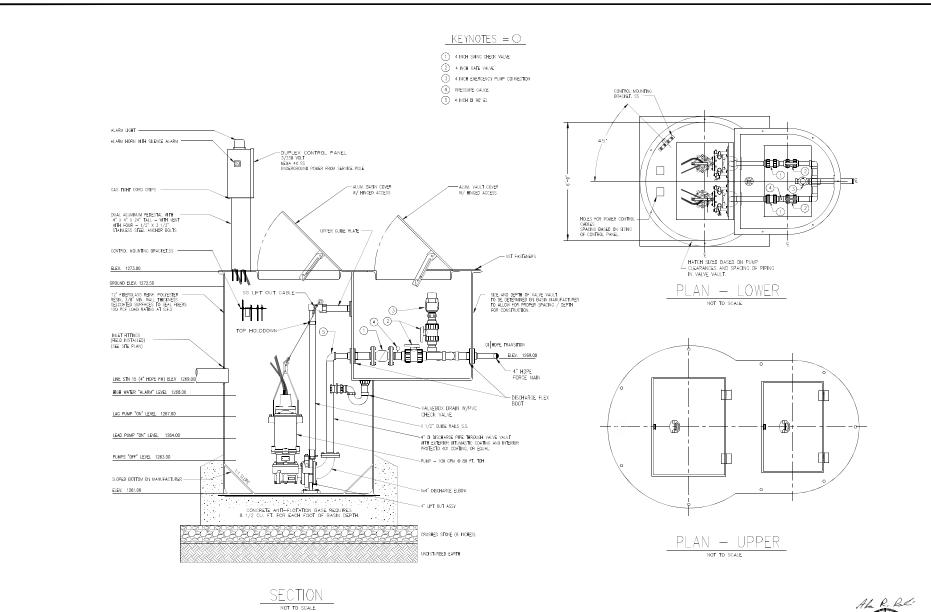

SHEET NUMBER:


SANITARY SEWER COLLECTION SYSTEM EXPANSION PHASE ONE - CONTRACT No. 39

HWY 701 PUMP STATION DETAILS

McCREARY COUNTY WATER DISTRICT 456 N. HWY 27 WHILEY CITY, KENTUCKY 42653

13 WEST MT. VERNON STREET SOMERSET, KENTLICKY 42501 PHONE: 608-451-0959

ECLIPSE ENGINEERS, PLLC

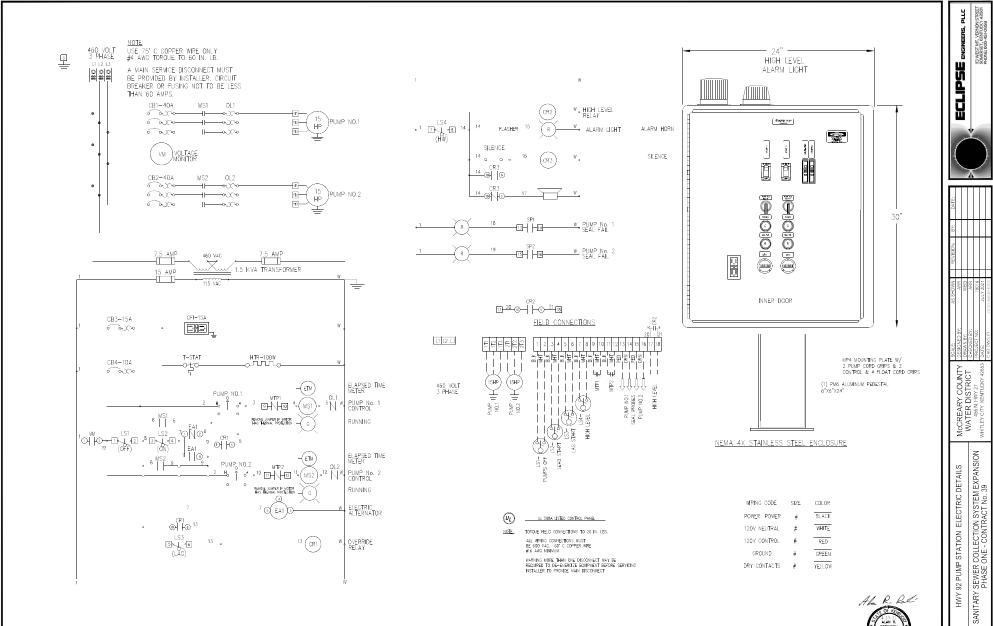


SHEET NUMBER 105

NOTE:

NOTE: THOUGH PUMP CARES FROM THE NETWELL SHALL BE RINN UP THROUGH THE PRESSTAL AND ATTACHED TO THE RINN UP THROUGH THE PRESSTAL AND ATTACHED TO THE RINN UP SHOULD CONSECTION SHADOW AS STEEL BOOT, AND RECORDER BOUSHING. THE CONSECTION AS STEEL BOOT, AND RECORDER BOUSHING. THE CONSECTION AND ADDRESS AND ADDRESS AS SHALL BE CONSECUTED AND ADDRESS AS SHALL BE CONSECUTED AND ADDRESS AS SHALL BE CONSECUTED AND ADDRESS AS SHALL BE CONSECUED INTO STEEL, OR MULLEAGUE BROW THE ADDRESS AND AD

WETWELL JUNCTION BOX

NOT TO SCALE

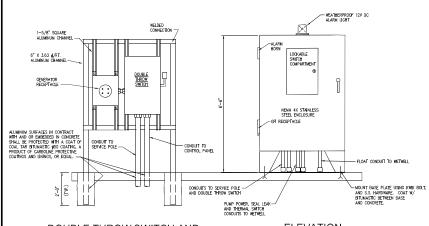



DOUBLE THROW SWITCH AND GENERATOR RECEPTACLE

ELEVATION PROPOSED PUMP CONTROL PANEL NOT TO SCALE

NOT TO SCALE

(FOR PUMPING STATIONS WHERE DEDICATED STANDBY POWER IS NOT REQUIRED)

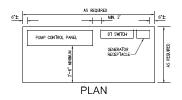


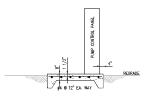

SECTION


DETAIL - SLAB FOR RECEPTACLE, DT SWITCH, AND PUMP CONTROL PANEL

NOT TO SCALE

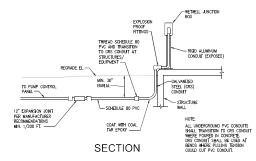

TYPICAL UNDERGROUND PVC CONDUIT TRANSITION TO GRS CONDUIT

NOT TO SCALE

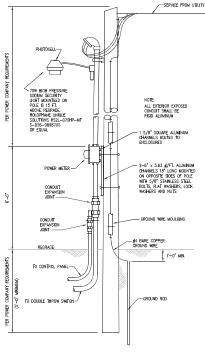

ELECTRIC SERVICE POLE DETAIL

- 1. ELECTRICAL BOND BETWEEN CONDUIT AND PUMP SUPPORT COLUMN REQUIRED.
- CONTRACTOR SHALL PROVIDE GUY WIRE AND ANCHOR FOR SERVICE POLE OPPOSITE SERVICE DROP IF REQUIRED BY POWER COMPANY.
- DOUBLE THROW SAFETY SMITCHES IN STAINLESS STEEL ENCLOSURES ARE USUALLY AVAILABLE FROM ELECTRICAL EQUIPMENT MANUFACTURERS BY SPECIAL GORDER CNLY, AND SHOULD BE ORDERED AS SOON AS POSSBILE BY THE CONTRACTOR.
- EQUIPMENT AND WIRING INSIDE THE WETWELL SHALL CONFORM TO NEC 501 AND AND OTHER APPLICABLE REQUIREMENTS FOR A CLASS I, DIMISION 1, GROUP D HAZARDOUS LOCATION.
- 5. UNDERGROUND CONDUITS SHALL BE SEALED WITH SILICONE CAULK.
- 6. THE DECLINEARY FOR A PUMPING STATION TO HAVE DEDICATED STANDS AND PROPER STATE OF THE DESCRIPTION OF THE WASTEWATER DEPARTMENT ANALOGE.
- RTU/DIALER SHALL BE FURNISHED BY EAGLE RESEARCH CORP. AND INSTALLED BY PANEL BUILDER.





McCREARY COUNTY WATER DISTRICT 456N, HWY 27 WHITLEY CITY, KENTUCKY 42653

ECLIPSE

SEWER COLLECTION SYSTEM EXPANSION PHASE ONE - CONTRACT No. 39 HWY 701 SANITARY 8

SHEET NUMBER 106