
# LCWD 2020 OFFICE BUILDING LARUE COUNTY #1 WATER DISTRICT LARUE COUNTY, KENTUCKY CONTRACT II - OFFICE BUILDING

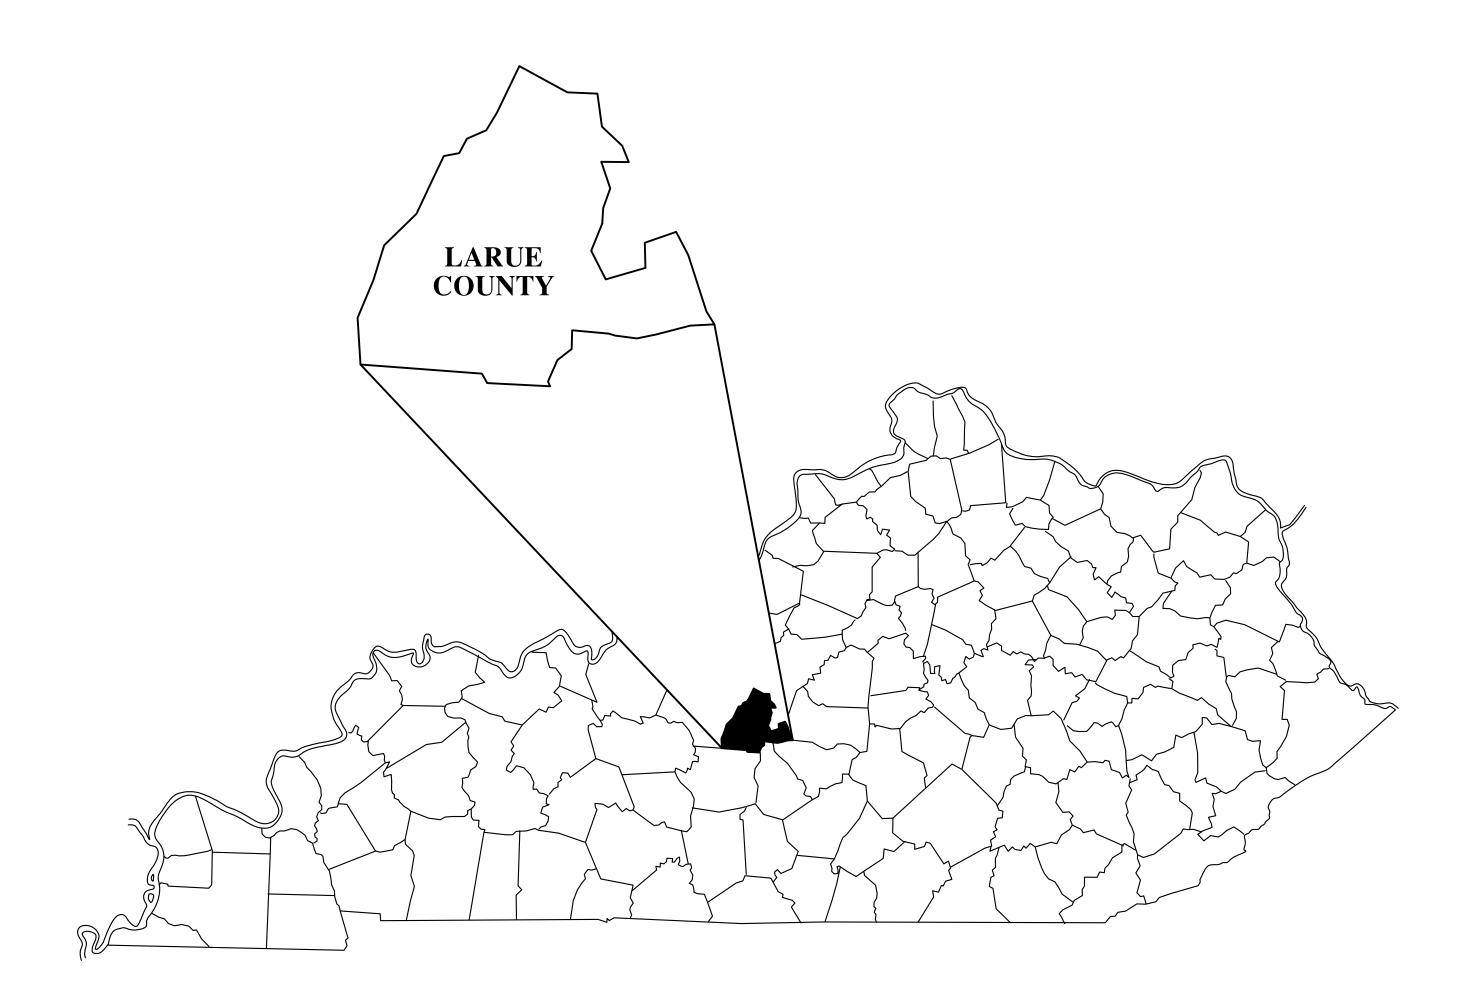

#### STATEMENT OF SPECIAL INSPECTIONS

LARUE COUNTY WATER DISTRICT #1 OFFICE BUFFALO, KENTUCKY LARUE COUNTY CASE #: COMMISSION #: 2628

ITEM OF CONSTRUCTION	TYPE OF INSPECTION	REQUIRED * (Y/N/NA)	INSPECTOR
1. EARTH WORK			
A. EXCAVATION	VISUAL	Υ	RS WHITAKER
B. COMPACTION	PROCTOR	NA	
C. BACKFILL	VISUAL	Y	RS WHITAKER
2. CONCRETE			
A. REINFORCEMENT STEEL	VISUAL	Y	RS WHITAKER
B. CONCRETE MIX	SLUMP TEST	Y	RS WHITAKER
C. CONCRETE PLACEMENT	VISUAL	Y	RS WHITAKER
D. CONCRETE STRENGTH	TEST CYLINDERS	Y	RS WHITAKER
a MAGGNEN			
3. MASONRY	1 1121111	.,	
A. MATERIALS	VISUAL	Y	RS WHITAKER
B. REINFORCEMENT	VISUAL	Y	RS WHITAKER
C. WORKMANSHIP	VISUAL	Y	RS WHITAKER
4. CARPENTRY			
A. MATERIALS	VISUAL	Y	RS WHITAKER
B. FASTENERS, TYPE, SIZE,			
NUMBER	VISUAL	Υ	RS WHITAKER
C. ANCHORS	VISUAL	Y	RS WHITAKER
D. PRE-FABRICATED			
MEMBERS	IN-PLANT TESTING	Υ	RS WHITAKER
E. SEISMIC CONNECTORS	VISUAL	Y	RS WHITAKER
E CTEEL			
5. STEEL	VIOLIAI	\ \ \\ \\ \\ \\ \\ \\ \\ \\ \\ \\ \\ \\	DO MUITAKED
A. MATERIALS	VISUAL	Y	RS WHITAKER
B. CONNECTORS BOLTS WELDS	VISUAL	Y	RS WHITAKER
C. PRE-FABRICATED			
MEMBERS	IN-PLANT TESTING	Y	MANUFACTURER
D. SEISMIC CONNECTORS	VISUAL	Y	RS WHITAKER
6. EXTERIOR			
INSULATION & FINISH			
SYSTEM (EIFS)	VISUAL	NA	
7. SMOKE CONTROL			
SYSTEM	SMOKE TEST	NA	
9 SEISMIC			
8. SEISMIC			
A. SEISMIC FORCE	MELIAI		
RESISTING SYSTEM	VISUAL	Y	RS WHITAKER
B. HVAC DUCTWORK	VISUAL	NA NA	<del> </del>
C. PIPING SYSTEM	VISUAL	NA	<u> </u>

\* Y = YES N = NO NA = NOT APPLICABLE OR NOT REQUIRED BY EXCEPTION, KBC 2018 NOTE: R.S. WHITAKER IS AN INTERNATIONAL CODE COUNCIL CERTIFIED INSPECTOR

#### DRAWING INDEX TITLE SHEET EXISTING & PROPOSED GRADING PLAN PROPOSED SITE DEVELOPMENT PLAN FOOTING, FOUNDATION WALL & FLOOR SLAB PLAN FOOTING, FOUNDATION WALL & FLOOR SLAB DETAILS BUILDING SECTION & WALL FRAMING DETAILS ROOF FRAMING PLAN ROOF FRAMING DETAILS MEZZANINE & STAIR FRAMING DETAILS ARCHITECTURAL FLOOR PLAN BUILDING ELEVATIONS **BUILDING ELEVATIONS** ROOF PLAN DOOR, FINISH & WINDOW SCHEDULES MECHANICAL FLOOR PLAN PLUMBING FLOOR PLAN PLUMBING FIXTURE DETAILS & WASTE & VENT RISER DIAGRAM ELECTRICAL POWER DISTRIBUTION PLAN LIGHTING PLAN E-3 ELECTRICAL PANEL SCHEDULES

#### **BUILDING DESIGN PARAMETERS**

ROOF LIVE LOAD:

**ROOF UPLIFT RATING:** 

SEISMIC RESPONSE COEFFICIENT (CS):

LAURE COUNTY WATER DISTRICT #1 OFFICE BUFFALO, KENTUCKY LARUE COUNTY CASE #: 2010-000299 COMMISSION #: 2628

USE GROUPS: B, OFFICE F-1, GARAGE

CONSTRUCTION TYPE NOTE: USE GROUPS "B" AND F-1" ARE SEPARATED

UL 90

0.064

AREA PER FEMA "FIRM" MAP

RATED PER UL DESIGN

BUILDING AREA: ALLOWED AREA: B = 9,000 S.F., F-1 = 8,500 S.F. ACTUAL AREA: B = 4,216 S.F., F-1 = 4,836 S.F. BUILDING HEIGHT:

ALLOWED HEIGHT B: 2 STORY, 40'-0", F-1: 1 STORY, 40'-0" ACTUAL HEIGHT B: 1 STORY, 25'-6", F-1: 1 STORY, 33'-8" FLOOR LIVE LOAD: 80 PSF MEZZANINE

FROST DEPTH: GROUND SNOW LOAD (Pg FLAT ROOF SNOW LOAD (Pf): N/A SNOW EXPOSURE FACTOR (Ce SNOW IMPORTANCE FACTOR (Is): THERMAL FACTOR (Ct):

WIND LOAD: ULTIMATE WIND SPEED 115 MPH BUILDING CATEGORY, 1.15 IMPORTANCE FACTOR (Iw) WIND EXPOSURE CATEGORY: COMPONENT & CLADDING WIND PRESSURE: 10, (-) 19.5

EARTHQUAKE LOADS: SEISMIC DESIGN CATEGORY: B- (LARUE COUNTY) SEISMIC USE GROUP: SHORT PERIOD SPECTRAL RESPONSE ACCELERATION (Sdi): 1 PERIOD SPECTRAL RESPONSE ACCELERATION (Sdi):

C, DENSE SOIL & SOFT ROCK SITE CLASS: BASIC SEISMIC-FORCE-RESISTING SYSTEM ORDINARY CONCENTRICALLY BRACED STEEL FRAME RESPONSE MODIFICATION FACTOR (R): 3.00

SEISMIC BASE SHEAR: EQUIVALENT LATERAL FORCE METHOD ANALYSIS PROCEDURE N/A, NOT IN A FLOOD HAZARD FLOOD LOADS:

FIRE PROTECTION SYSTEM: NOT REQUIRED **SECTION 903 KBC 2018** FIRE BARRIER WALL 2 HOUR FIRE RESISTIVE RATED PER

UL DESIGN U905 FIRE ALARM & DETECTION SYSTEM: MANUAL FIRE ALARM & SMOKE DETECTOR SYSTEM CORRIDOR & STORAGE ROOM WALLS: 1 HOUR FIRE RESISTIVE RATED PER UL DESIGN 1 HOUR FIRE RESISTIVE CORRIDOR & STORAGE ROOM CEILINGS:

## WHITAKER 2

1860 FRANKFORT ROAD SHELBYVILLE, KENTUCKY 40065 502-633-4981 / 502-633-0377


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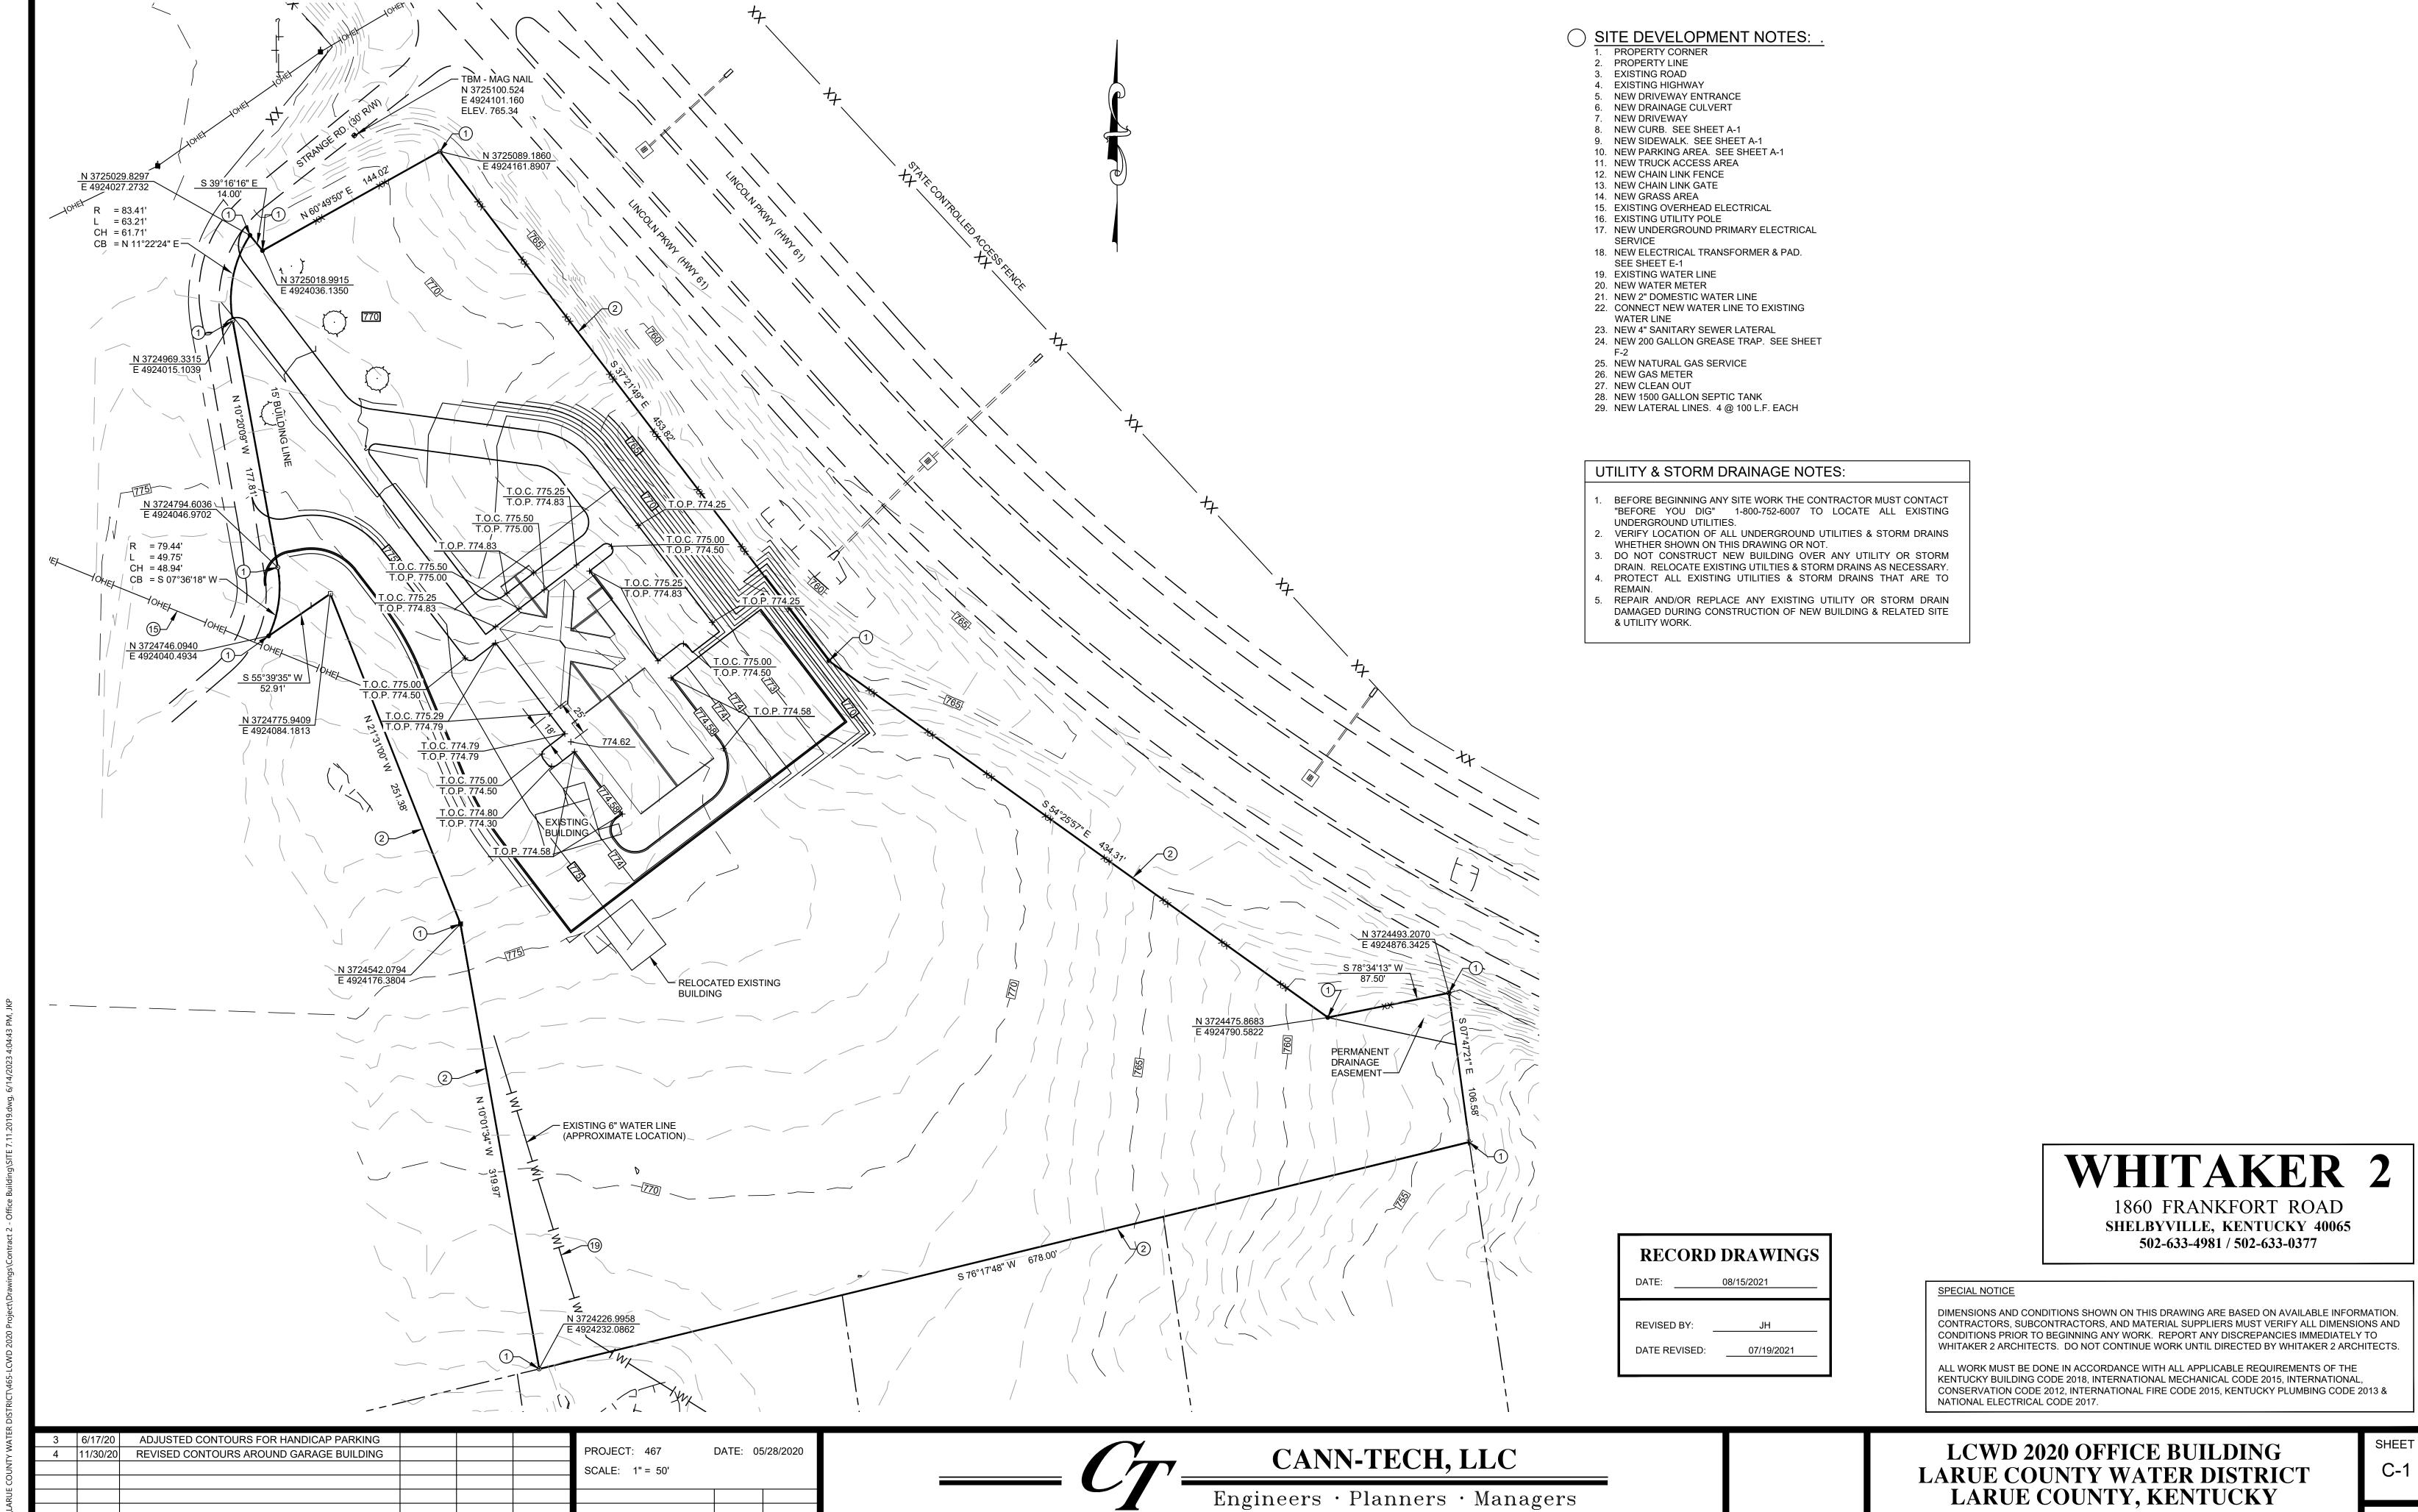
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DATE: 08/15/2021								
REVISED BY:	JH							
DATE REVISED:	07/19/2021							

MAY 2020



Lawrenceburg, KY 40342

Phone (502) 859-0907 Fax (502) 859-0668

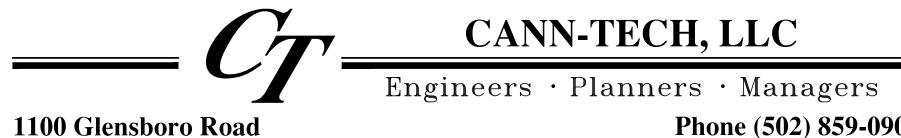

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Fax (502) 859-0668

1100 Glensboro Road

Lawrenceburg, KY 40342

**DESIGNED BY:** 

DRAWN BY:

NO. DATE


CHECKED BY:

RECORD DRAWINGS

RSW

RSW

**EXISTING & PROPOSED GRADING PLAN** 

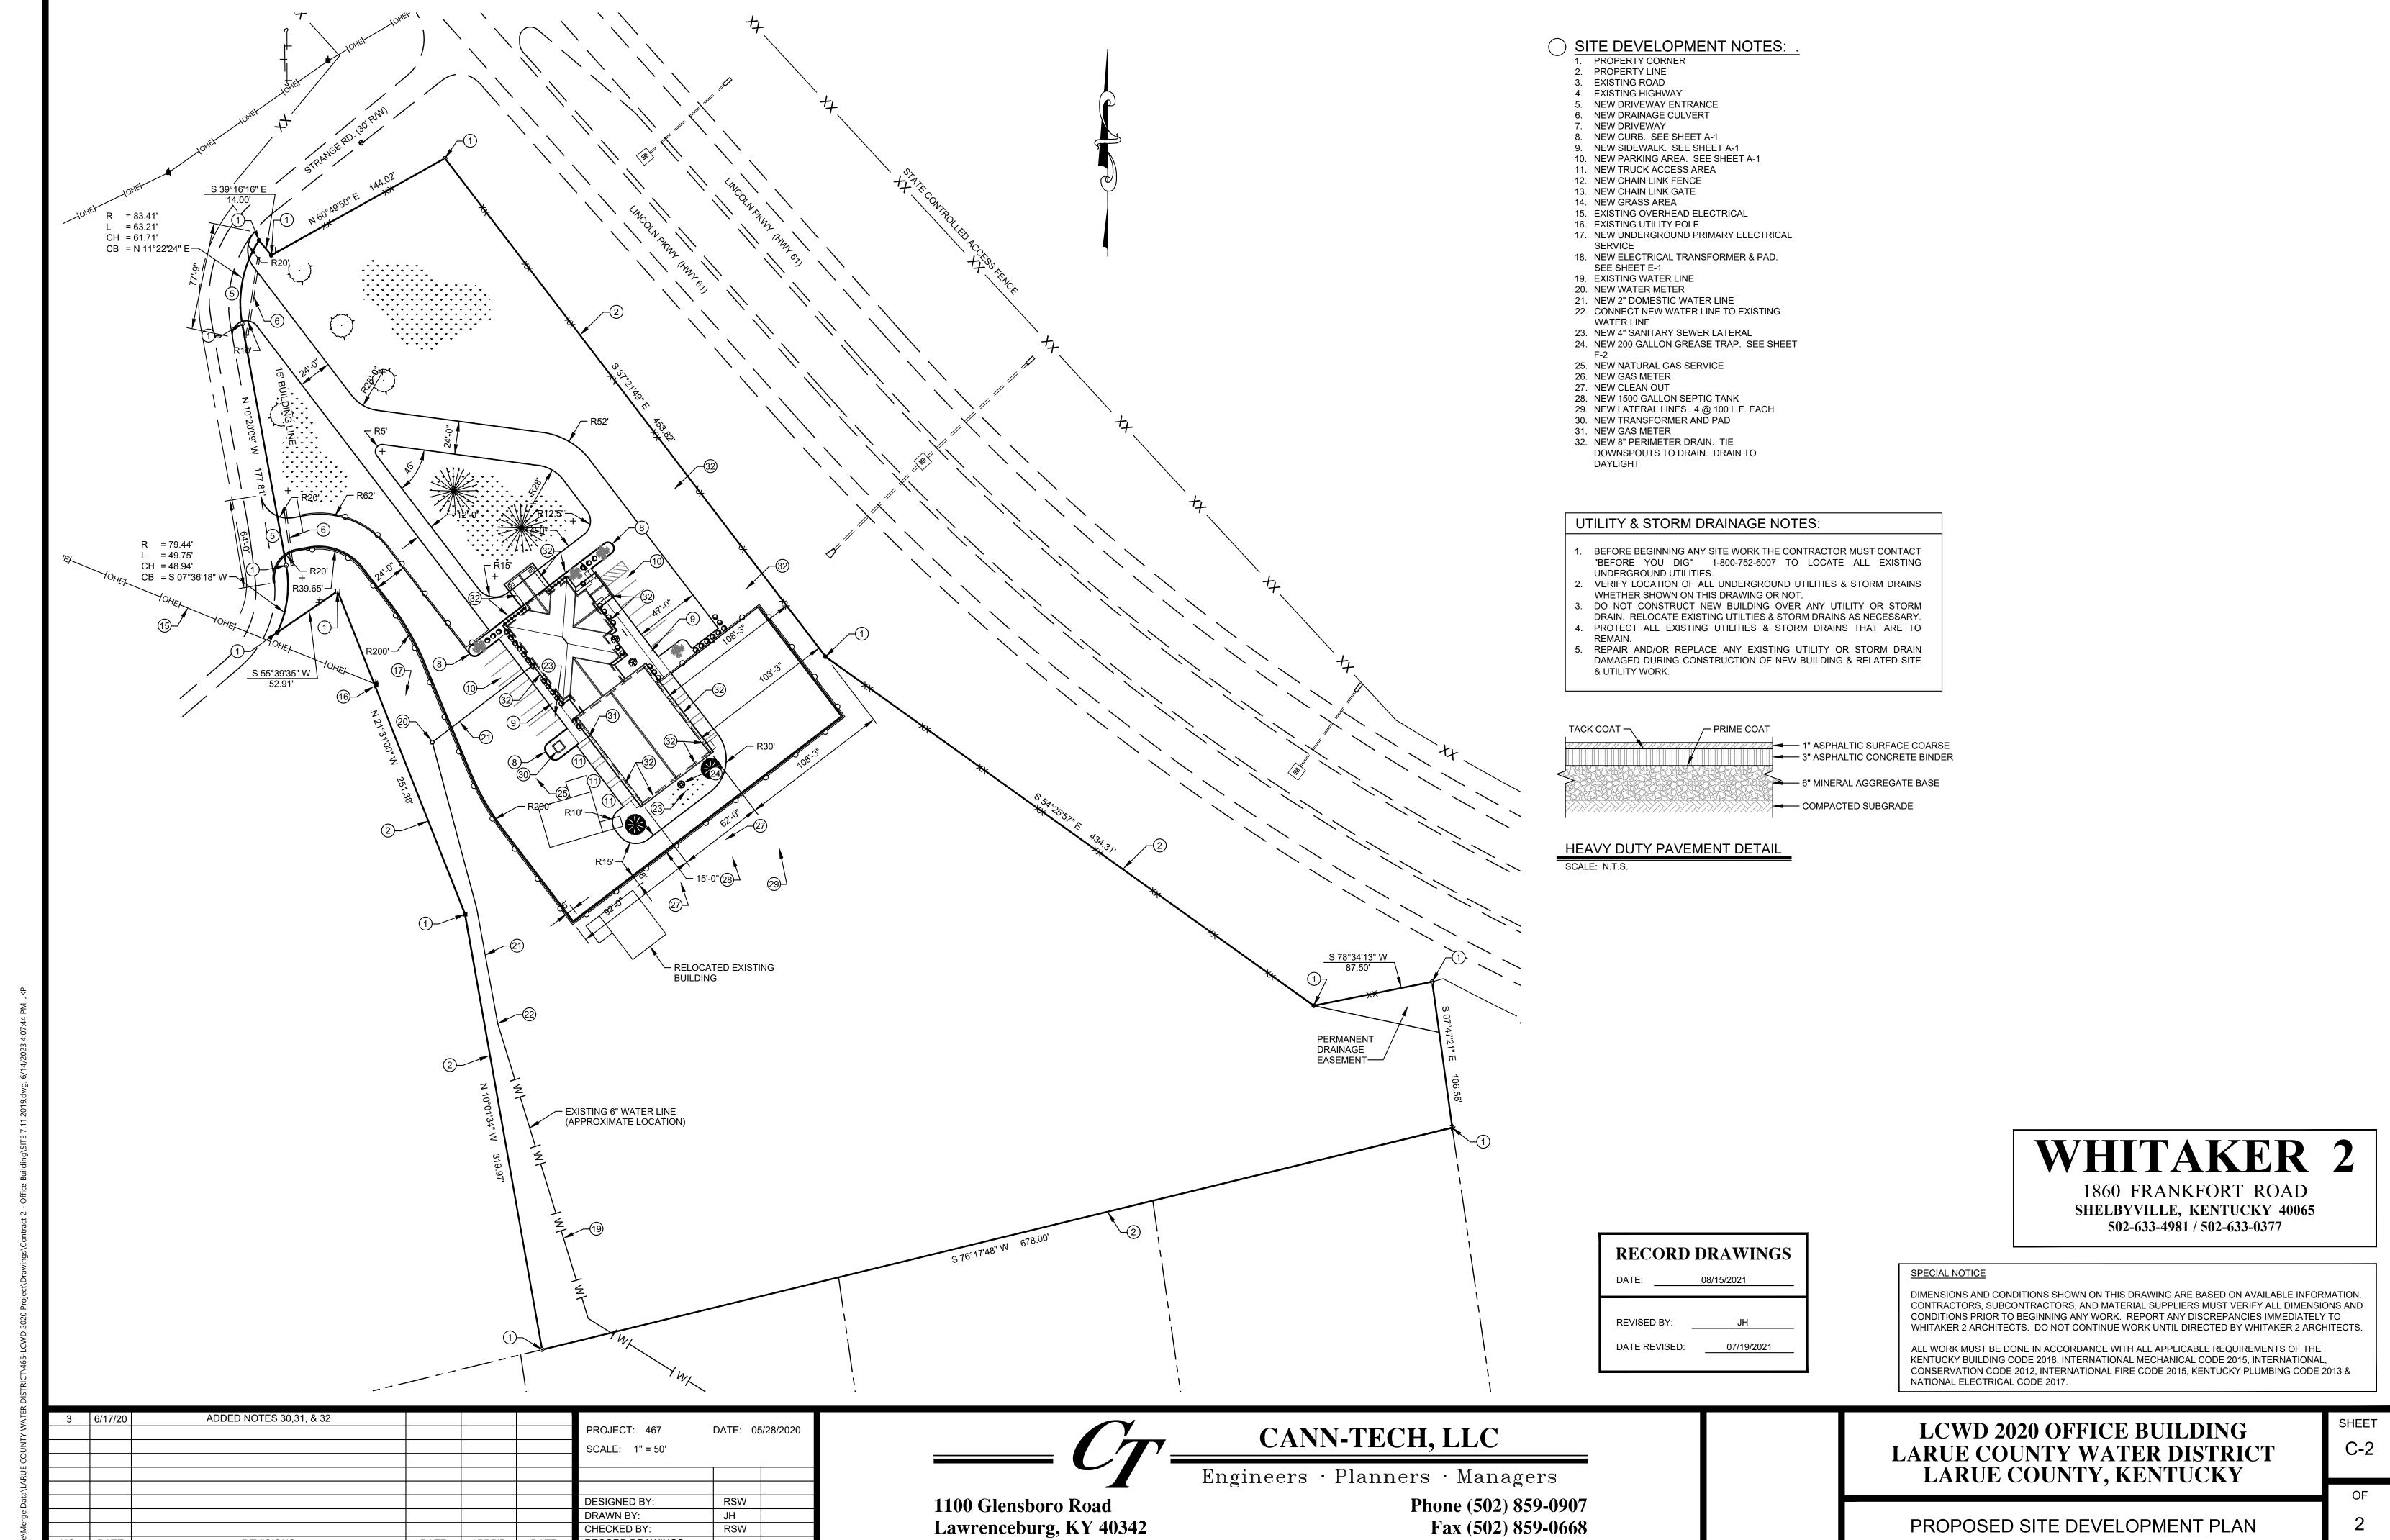


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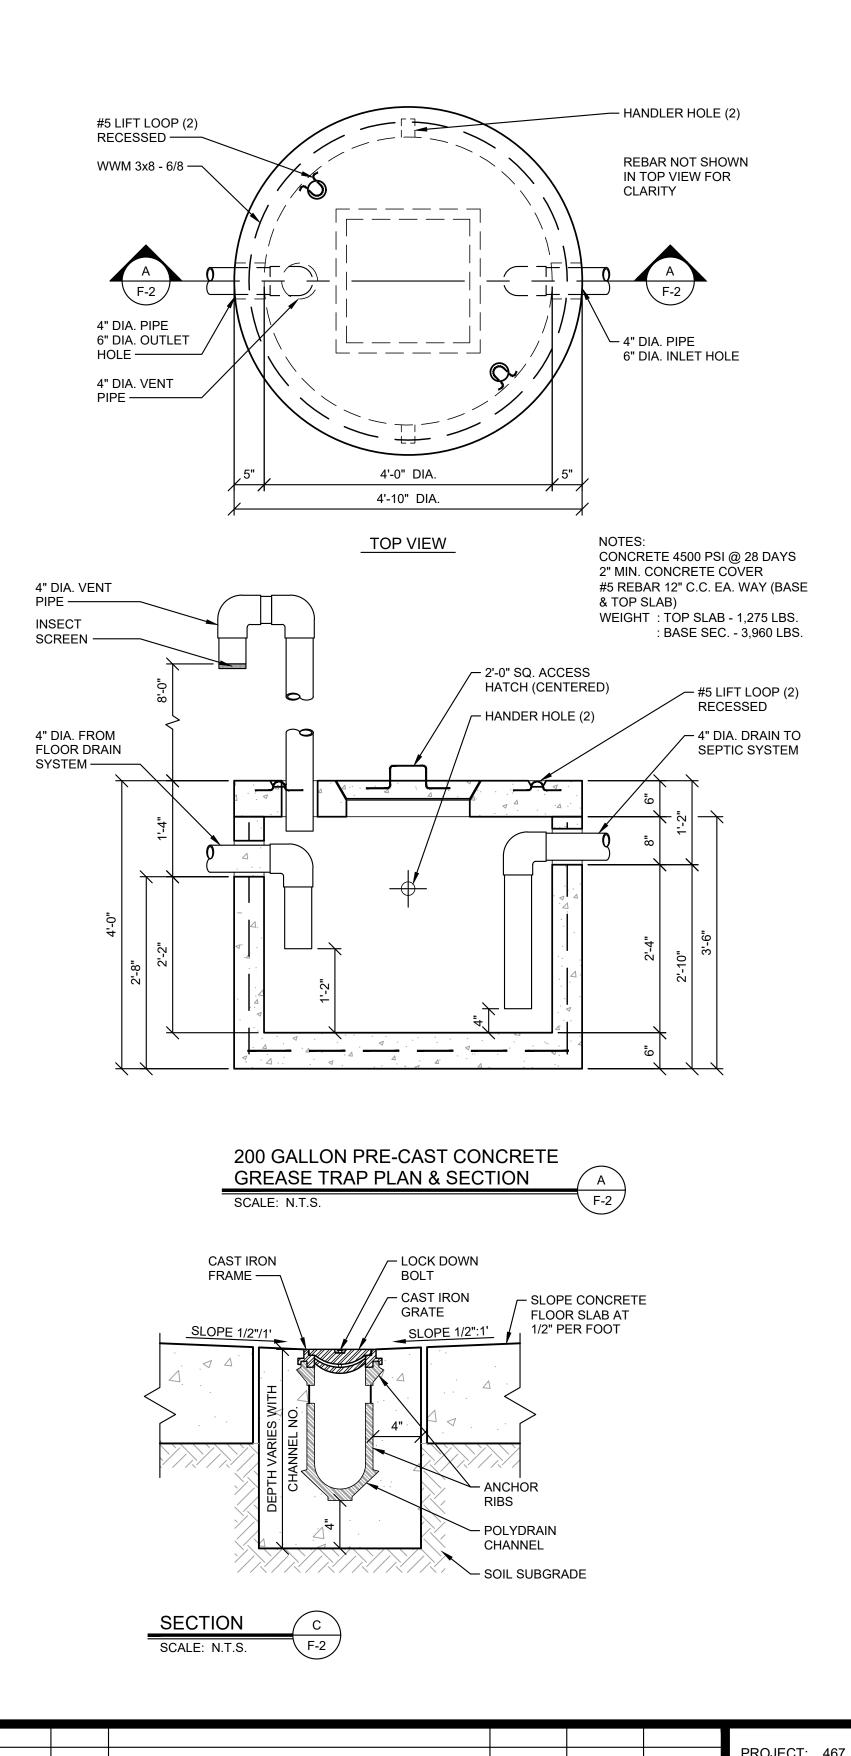
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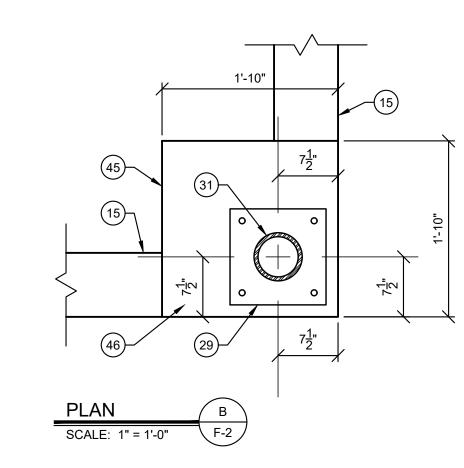
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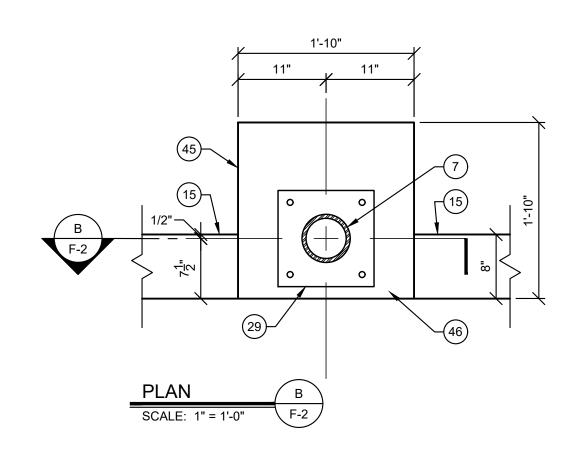
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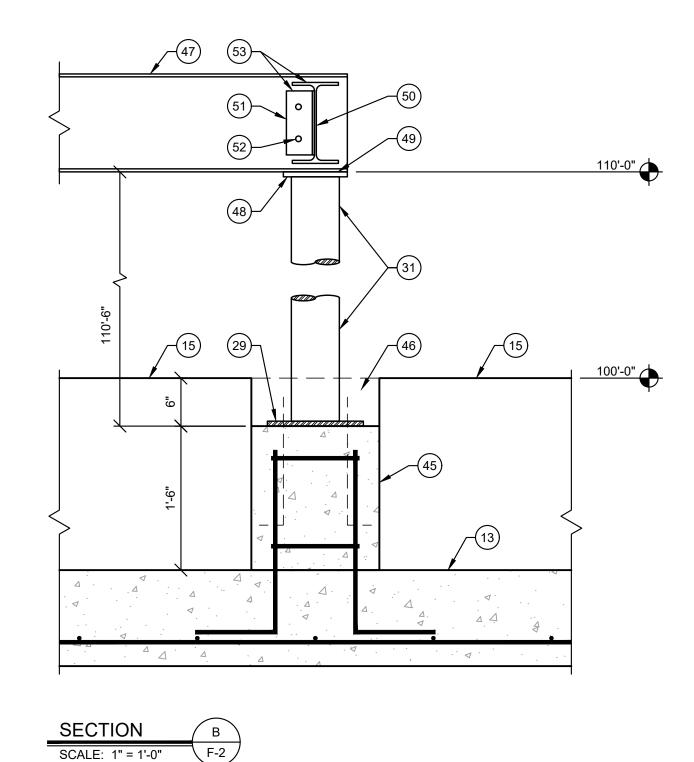
Fax (502) 859-0668

FOOTING, FOUNDATION WALL & FLOOR SLAB PLAN







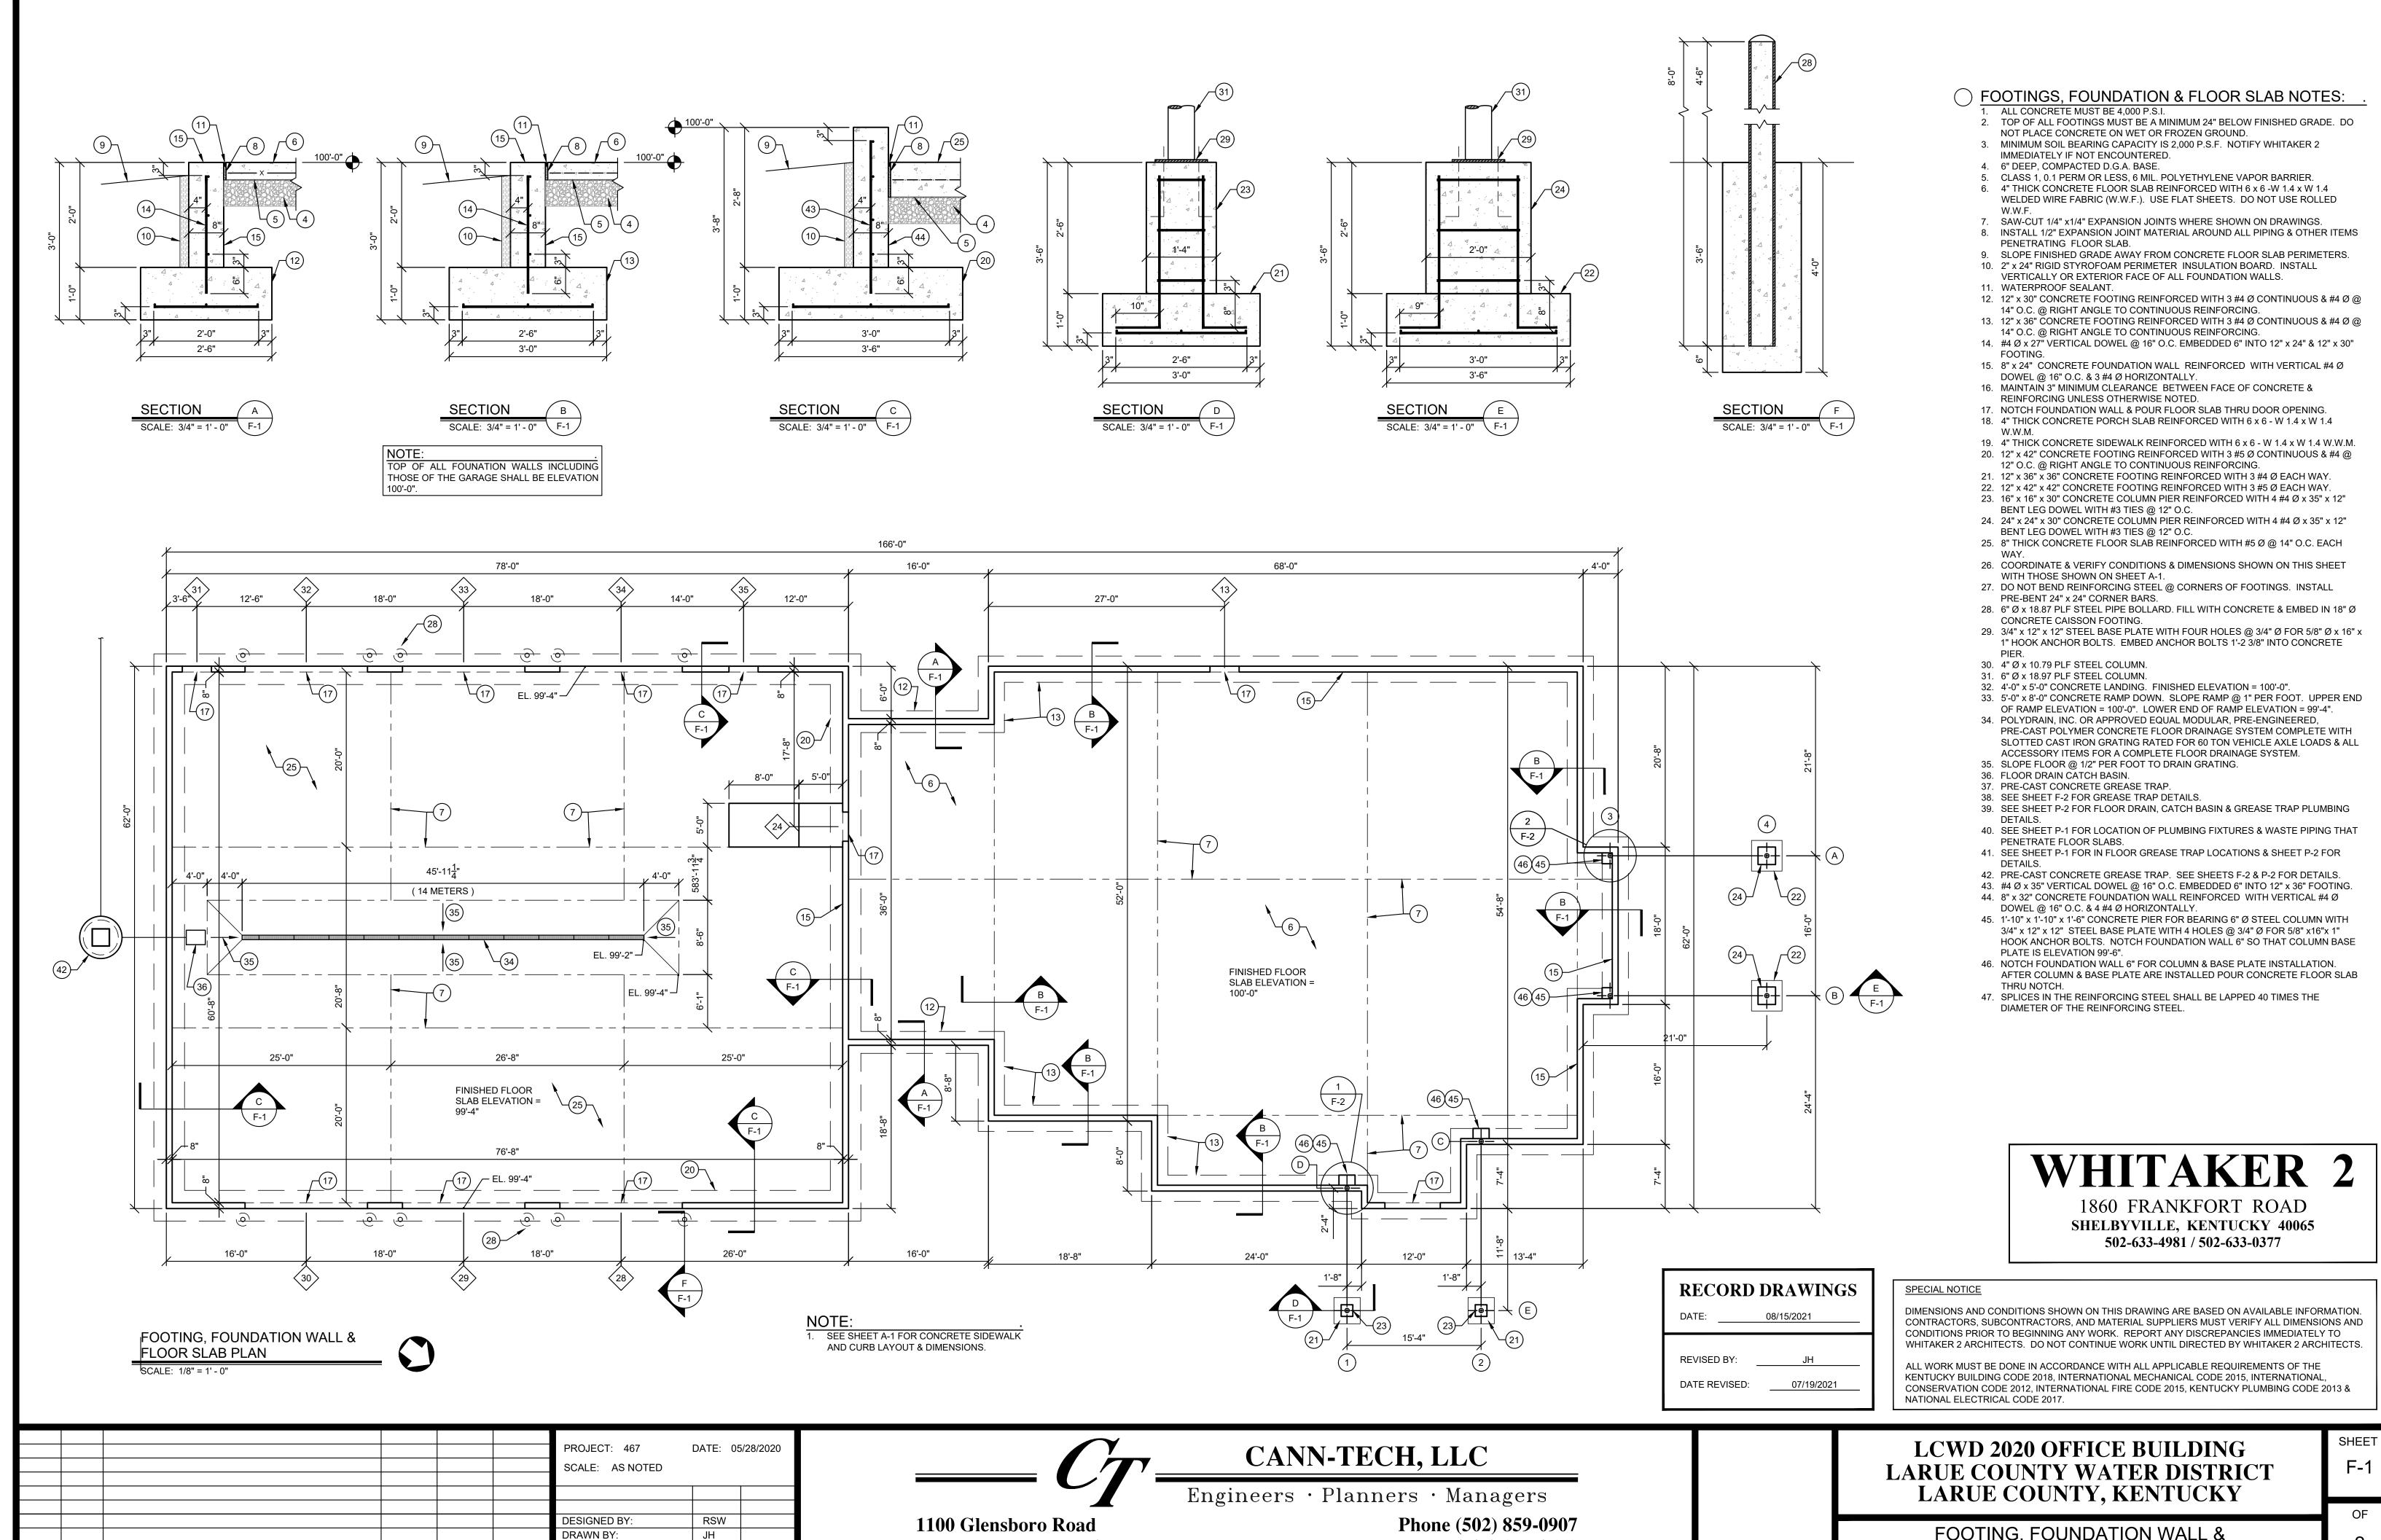

#### TOOTINGS, FOUNDATION & FLOOR SLAB NOTES:

- ALL CONCRETE MUST BE 4,000 P.S.I. 2. TOP OF ALL FOOTINGS MUST BE A MINIMUM 24" BELOW FINISHED GRADE. DO
- NOT PLACE CONCRETE ON WET OR FROZEN GROUND.
- 3. MINIMUM SOIL BEARING CAPACITY IS 2,000 P.S.F. NOTIFY WHITAKER 2 IMMEDIATELY IF NOT ENCOUNTERED.
- 4. 6" DEEP, COMPACTED D.G.A. BASE.
- 5. CLASS 1, 0.1 PERM OR LESS, 6 MIL. POLYETHYLENE VAPOR BARRIER. 6. 4" THICK CONCRETE FLOOR SLAB REINFORCED WITH 6 x 6 -W 1.4 x W 1.4
- WELDED WIRE FABRIC (W.W.F.). USE FLAT SHEETS. DO NOT USE ROLLED
- 7. SAW-CUT 1/4" x1/4" EXPANSION JOINTS WHERE SHOWN ON DRAWINGS. 8. INSTALL 1/2" EXPANSION JOINT MATERIAL AROUND ALL PIPING & OTHER ITEMS
- PENETRATING FLOOR SLAB. 9. SLOPE FINISHED GRADE AWAY FROM CONCRETE FLOOR SLAB PERIMETERS.
- 10. 2" x 24" RIGID STYROFOAM PERIMETER INSULATION BOARD. INSTALL
- VERTICALLY OR EXTERIOR FACE OF ALL FOUNDATION WALLS. 11. WATERPROOF SEALANT.
- 12. 12" x 30" CONCRETE FOOTING REINFORCED WITH 3 #4 Ø CONTINUOUS & #4 Ø @ 14" O.C. @ RIGHT ANGLE TO CONTINUOUS REINFORCING.
- 13. 12" x 36" CONCRETE FOOTING REINFORCED WITH 3 #4 Ø CONTINUOUS & #4 Ø @ 14" O.C. @ RIGHT ANGLE TO CONTINUOUS REINFORCING.
- 14. #4 Ø x 27" VERTICAL DOWEL @ 16" O.C. EMBEDDED 6" INTO 12" x 24" & 12" x 30"
- 15. 8" x 24" CONCRETE FOUNDATION WALL REINFORCED WITH VERTICAL #4 Ø DOWEL @ 16" O.C. & 3 #4 Ø HORIZONTALLY.
- 16. MAINTAIN 3" MINIMUM CLEARANCE BETWEEN FACE OF CONCRETE &
- REINFORCING UNLESS OTHERWISE NOTED.
- 17. NOTCH FOUNDATION WALL & POUR FLOOR SLAB THRU DOOR OPENING.
- 18. 4" THICK CONCRETE PORCH SLAB REINFORCED WITH 6 x 6 W 1.4 x W 1.4
- 19. 4" THICK CONCRETE SIDEWALK REINFORCED WITH 6 x 6 W 1.4 x W 1.4 W.W.M.
- 20. 12" x 42" CONCRETE FOOTING REINFORCED WITH 3 #5 Ø CONTINUOUS & #4 @
- 12" O.C. @ RIGHT ANGLE TO CONTINUOUS REINFORCING.
- 21. 12" x 36" x 36" CONCRETE FOOTING REINFORCED WITH 3 #4 Ø EACH WAY.
- 22. 12" x 42" x 42" CONCRETE FOOTING REINFORCED WITH 3 #5 Ø EACH WAY.
- 23. 16" x 16" x 30" CONCRETE COLUMN PIER REINFORCED WITH 4 #4 Ø x 35" x 12" BENT LEG DOWEL WITH #3 TIES @ 12" O.C.
- 24. 24" x 24" x 30" CONCRETE COLUMN PIER REINFORCED WITH 4 #4 Ø x 35" x 12" BENT LEG DOWEL WITH #3 TIES @ 12" O.C.
- 25. 8" THICK CONCRETE FLOOR SLAB REINFORCED WITH #5 Ø @ 14" O.C. EACH
- 26. COORDINATE & VERIFY CONDITIONS & DIMENSIONS SHOWN ON THIS SHEET
- WITH THOSE SHOWN ON SHEET A-1.
- 27. DO NOT BEND REINFORCING STEEL @ CORNERS OF FOOTINGS. INSTALL PRE-BENT 24" x 24" CORNER BARS.
- 28. 6" Ø x 18.87 PLF STEEL PIPE BOLLARD. FILL WITH CONCRETE & EMBED IN 18" Ø CONCRETE CAISSON FOOTING.
- 29. 3/4" x 12" x 12" STEEL BASE PLATE WITH FOUR HOLES @ 3/4" Ø FOR 5/8" Ø x 16" x
- 1" HOOK ANCHOR BOLTS. EMBED ANCHOR BOLTS 1'-2 3/8" INTO CONCRETE
- 30. 4" Ø x 10.79 PLF STEEL COLUMN.
- 31. 6" Ø x 18.97 PLF STEEL COLUMN.
- 32. 4'-0" x 5'-0" CONCRETE LANDING. FINISHED ELEVATION = 100'-0".
- 33. 5'-0" x 8'-0" CONCRETE RAMP DOWN. SLOPE RAMP @ 1" PER FOOT. UPPER END OF RAMP ELEVATION = 100'-0". LOWER END OF RAMP ELEVATION = 99'-4".
- 34. POLYDRAIN, INC. OR APPROVED EQUAL MODULAR, PRE-ENGINEERED, PRE-CAST POLYMER CONCRETE FLOOR DRAINAGE SYSTEM COMPLETE WITH SLOTTED CAST IRON GRATING RATED FOR 60 TON VEHICLE AXLE LOADS & ALL
- ACCESSORY ITEMS FOR A COMPLETE FLOOR DRAINAGE SYSTEM. 35. SLOPE FLOOR @ 1/2" PER FOOT TO DRAIN GRATING.
- 36. FLOOR DRAIN CATCH BASIN.
- 37. PRE-CAST CONCRETE GREASE TRAP. 38. SEE SHEET F-2 FOR GREASE TRAP DETAILS.
- 39. SEE SHEET P-2 FOR FLOOR DRAIN, CATCH BASIN & GREASE TRAP PLUMBING
- DETAILS. 40. SEE SHEET P-1 FOR LOCATION OF PLUMBING FIXTURES & WASTE PIPING THAT PENETRATE FLOOR SLABS.
- 41. SEE SHEET P-1 FOR IN FLOOR GREASE TRAP LOCATIONS & SHEET P-2 FOR
- 42. PRE-CAST CONCRETE GREASE TRAP. SEE SHEETS F-2 & P-2 FOR DETAILS.
- 43. #4 Ø x 35" VERTICAL DOWEL @ 16" O.C. EMBEDDED 6" INTO 12" x 36" FOOTING. 44.  $8" \times 32"$  CONCRETE FOUNDATION WALL REINFORCED WITH VERTICAL #4 Ø
- DOWEL @ 16" O.C. & 4 #4 Ø HORIZONTALLY. 45. 1'-10" x 1'-10" x 1'-6" CONCRETE PIER FOR BEARING 6" Ø STEEL COLUMN WITH
- 3/4" x 12" x 12" STEEL BASE PLATE WITH 4 HOLES @ 3/4" Ø FOR 5/8" x16"x 1" HOOK ANCHOR BOLTS. NOTCH FOUNDATION WALL 6" SO THAT COLUMN BASE PLATE IS ELEVATION 99'-6".
- 46. NOTCH FOUNDATION WALL 6" FOR COLUMN & BASE PLATE INSTALLATION. AFTER COLUMN & BASE PLATE ARE INSTALLED POUR CONCRETE FLOOR SLAB THRU NOTCH.
- 47. W 12 x 26 STEEL BEAM FOR ROOF TRUSS SUPPORT.
- 48. 5/8" x 8" x 8" STEEL TOP PLATE SHOP WELDED TO 6" Ø STEEL COLUMN. 49. FIELD WELD BOTTOM FLANGE OF W 12 x 26 STEEL BEAM TO 5/8" x 8" X 8" TOP
- PLATE WITH 1/4" x 2 1/2" FILLET WELD, BOTH SIDES OF BOTTOM FLANGE. 50. W 10 x 22 LATERAL SUPPORT BEAM.
- 51. 3 1/2" x 3 1/2" x 1/4" x 8" ANGLE SHOP WELDED TO WEB OF W 10 x 22 LATERAL
- SUPPORT BEAM. WELD ANGLE @ EACH END OF BEAM. 52. SHOP DRILL TWO 11/16" Ø HOLES FOR 5/8" \$\$C A325 BOLTS.
- 53. FIELD BOLT LATERAL SUPPORT BEAM TO W 12 x 26 ROOF BEAM.
- 54. 6" Ø STEEL COLUMN SHALL BE POSITIONED SO THAT IT IS WITH 6" STEEL STUD
- 55. SPLICES IN REINFORCING STEEL SHALL BE LAPPED 40 TIMES THE DIAMETER OF THE STEEL REINFORCING.

### WHITAKER 2

1860 FRANKFORT ROAD SHELBYVILLE, KENTUCKY 40065 502-633-4981 / 502-633-0377

# **RECORD DRAWINGS** REVISED BY

07/19/2021

DATE REVISED:

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PROJECT: 467 DATE: 05/28/2020 SCALE: AS NOTED **DESIGNED BY:** RSW DRAWN BY: JΗ CHECKED BY RSW NO. DATE DATE APPR'D DATE **RECORD DRAWINGS** 

1100 Glensboro Road

Lawrenceburg, KY 40342

CANN-TECH, LLC

Engineers · Planners · Managers

Phone (502) 859-0907 Fax (502) 859-0668 LARUE COUNTY, KENTUCKY FOOTING, FOUNDATION WALL &


SHEET

FLOOR SLAB DETAILS

**LCWD 2020 OFFICE BUILDING** 

LARUE COUNTY WATER DISTRICT

OF

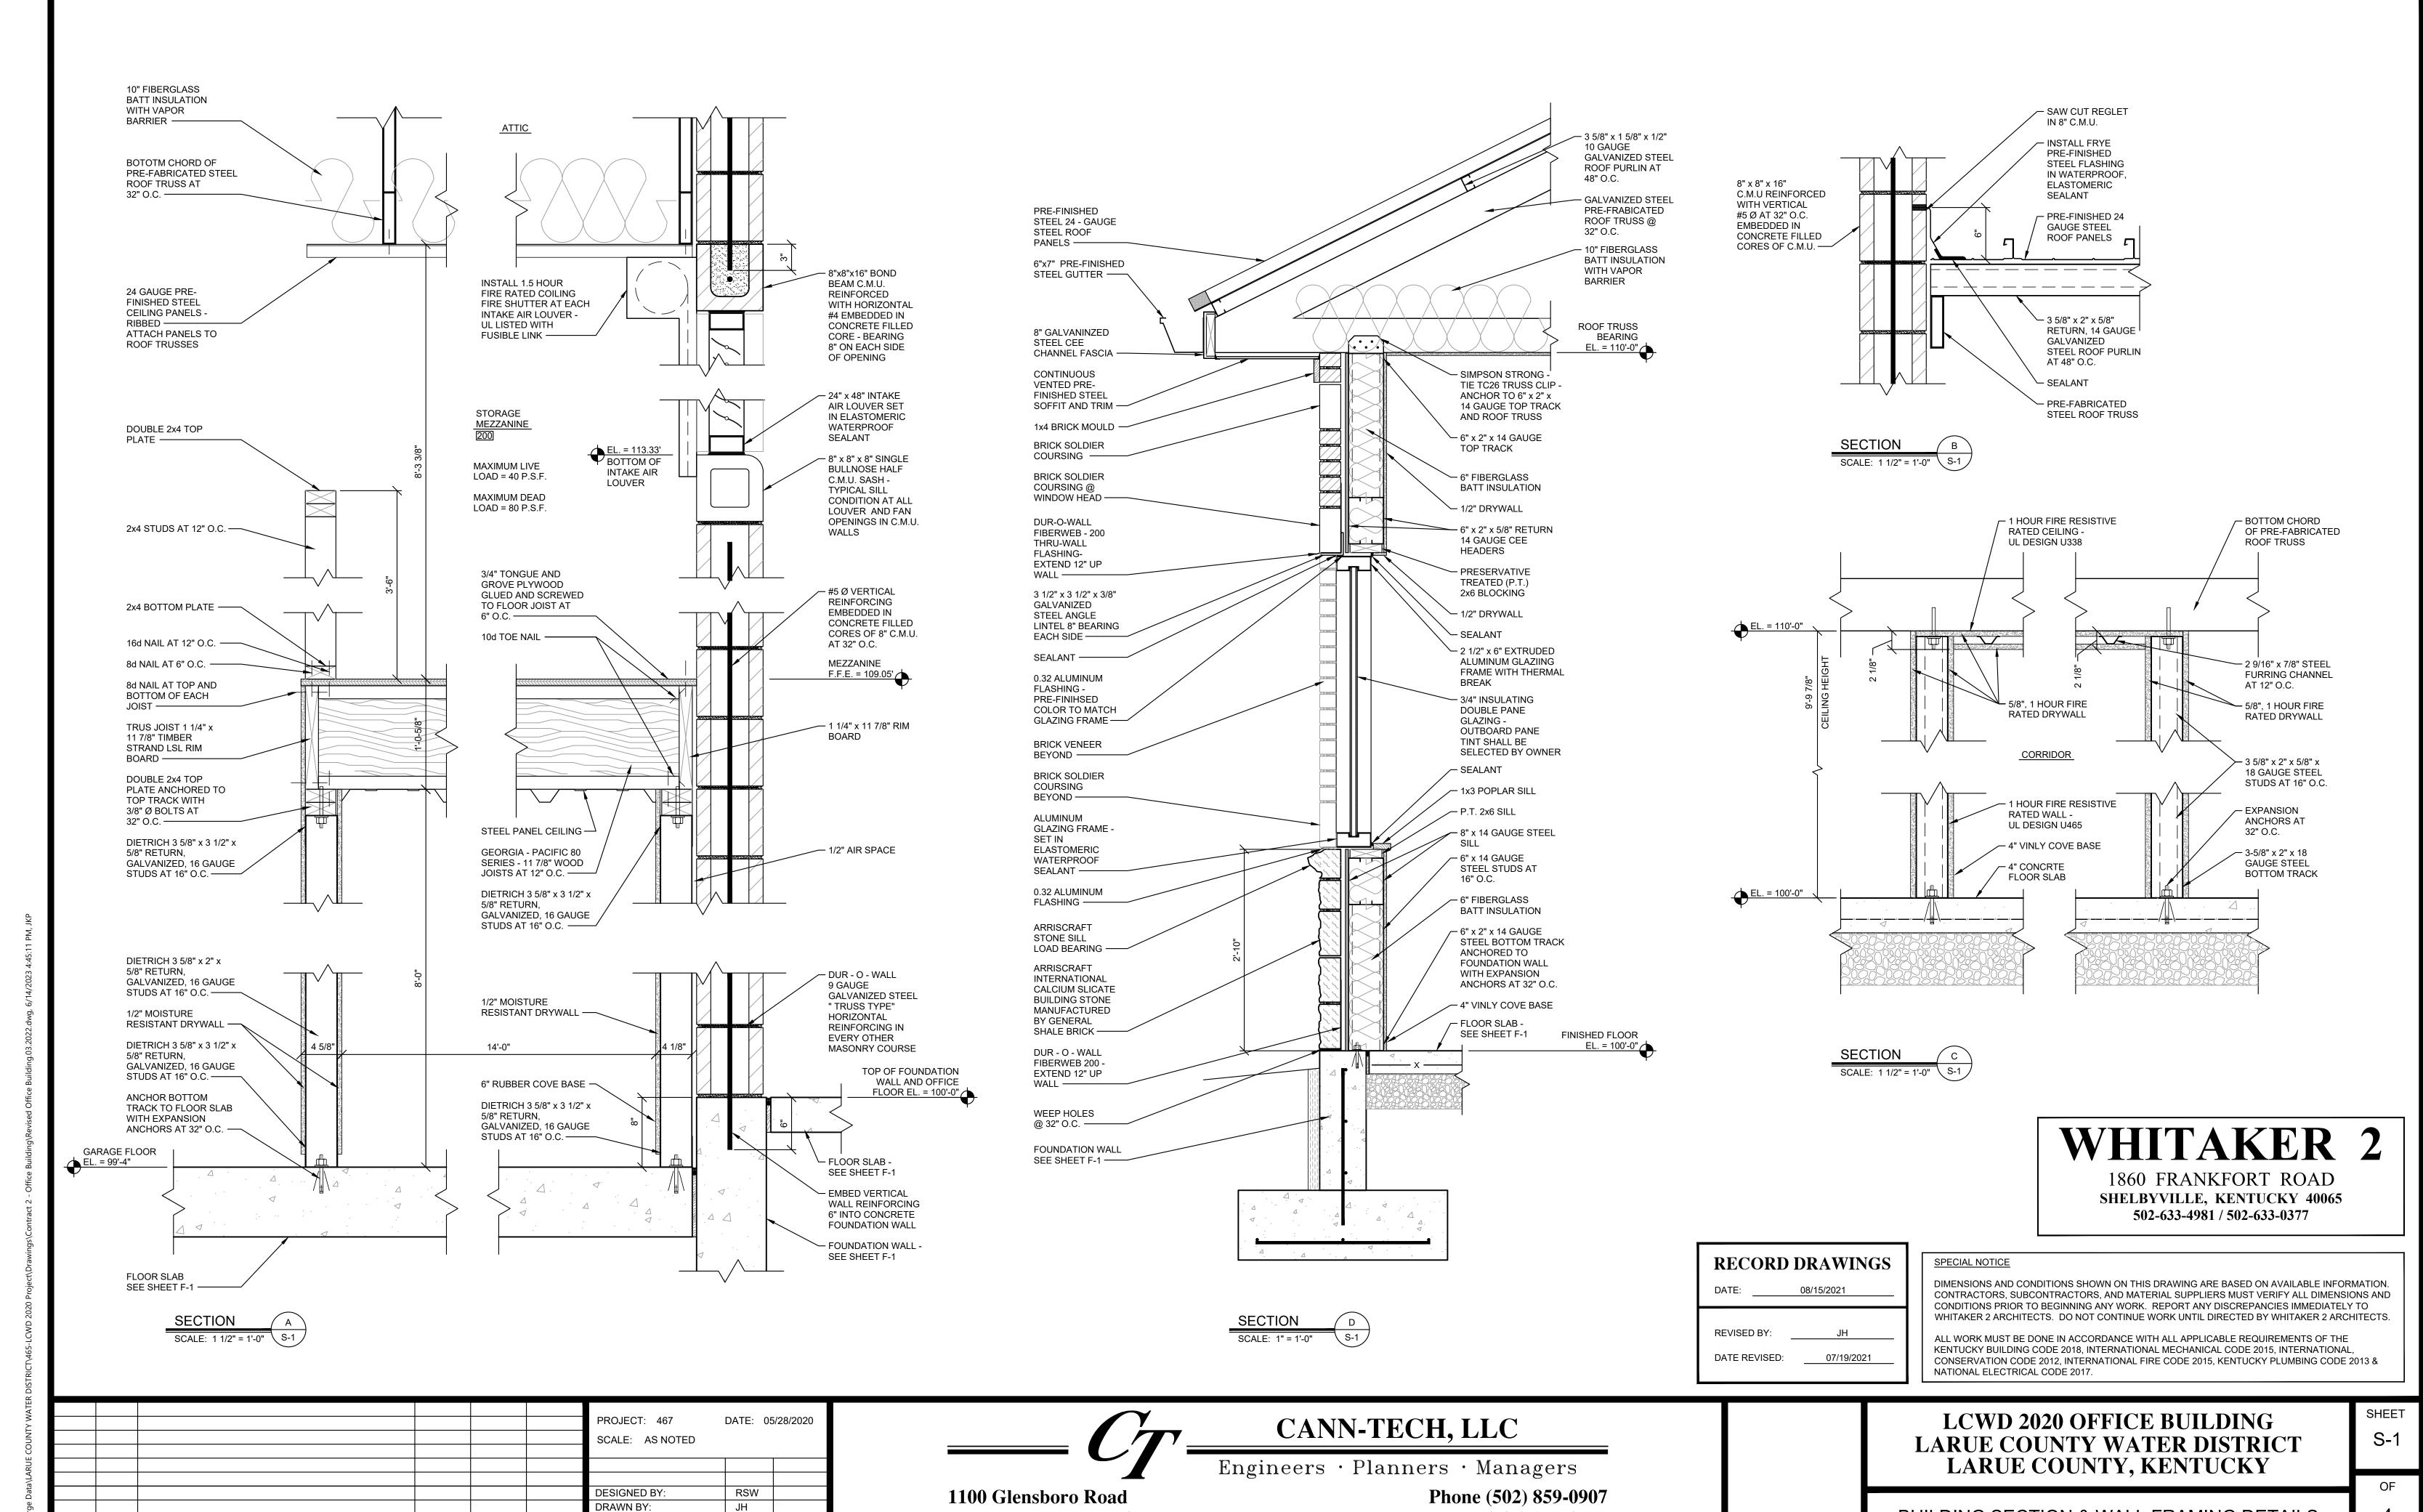

Lawrenceburg, KY 40342

CHECKED BY

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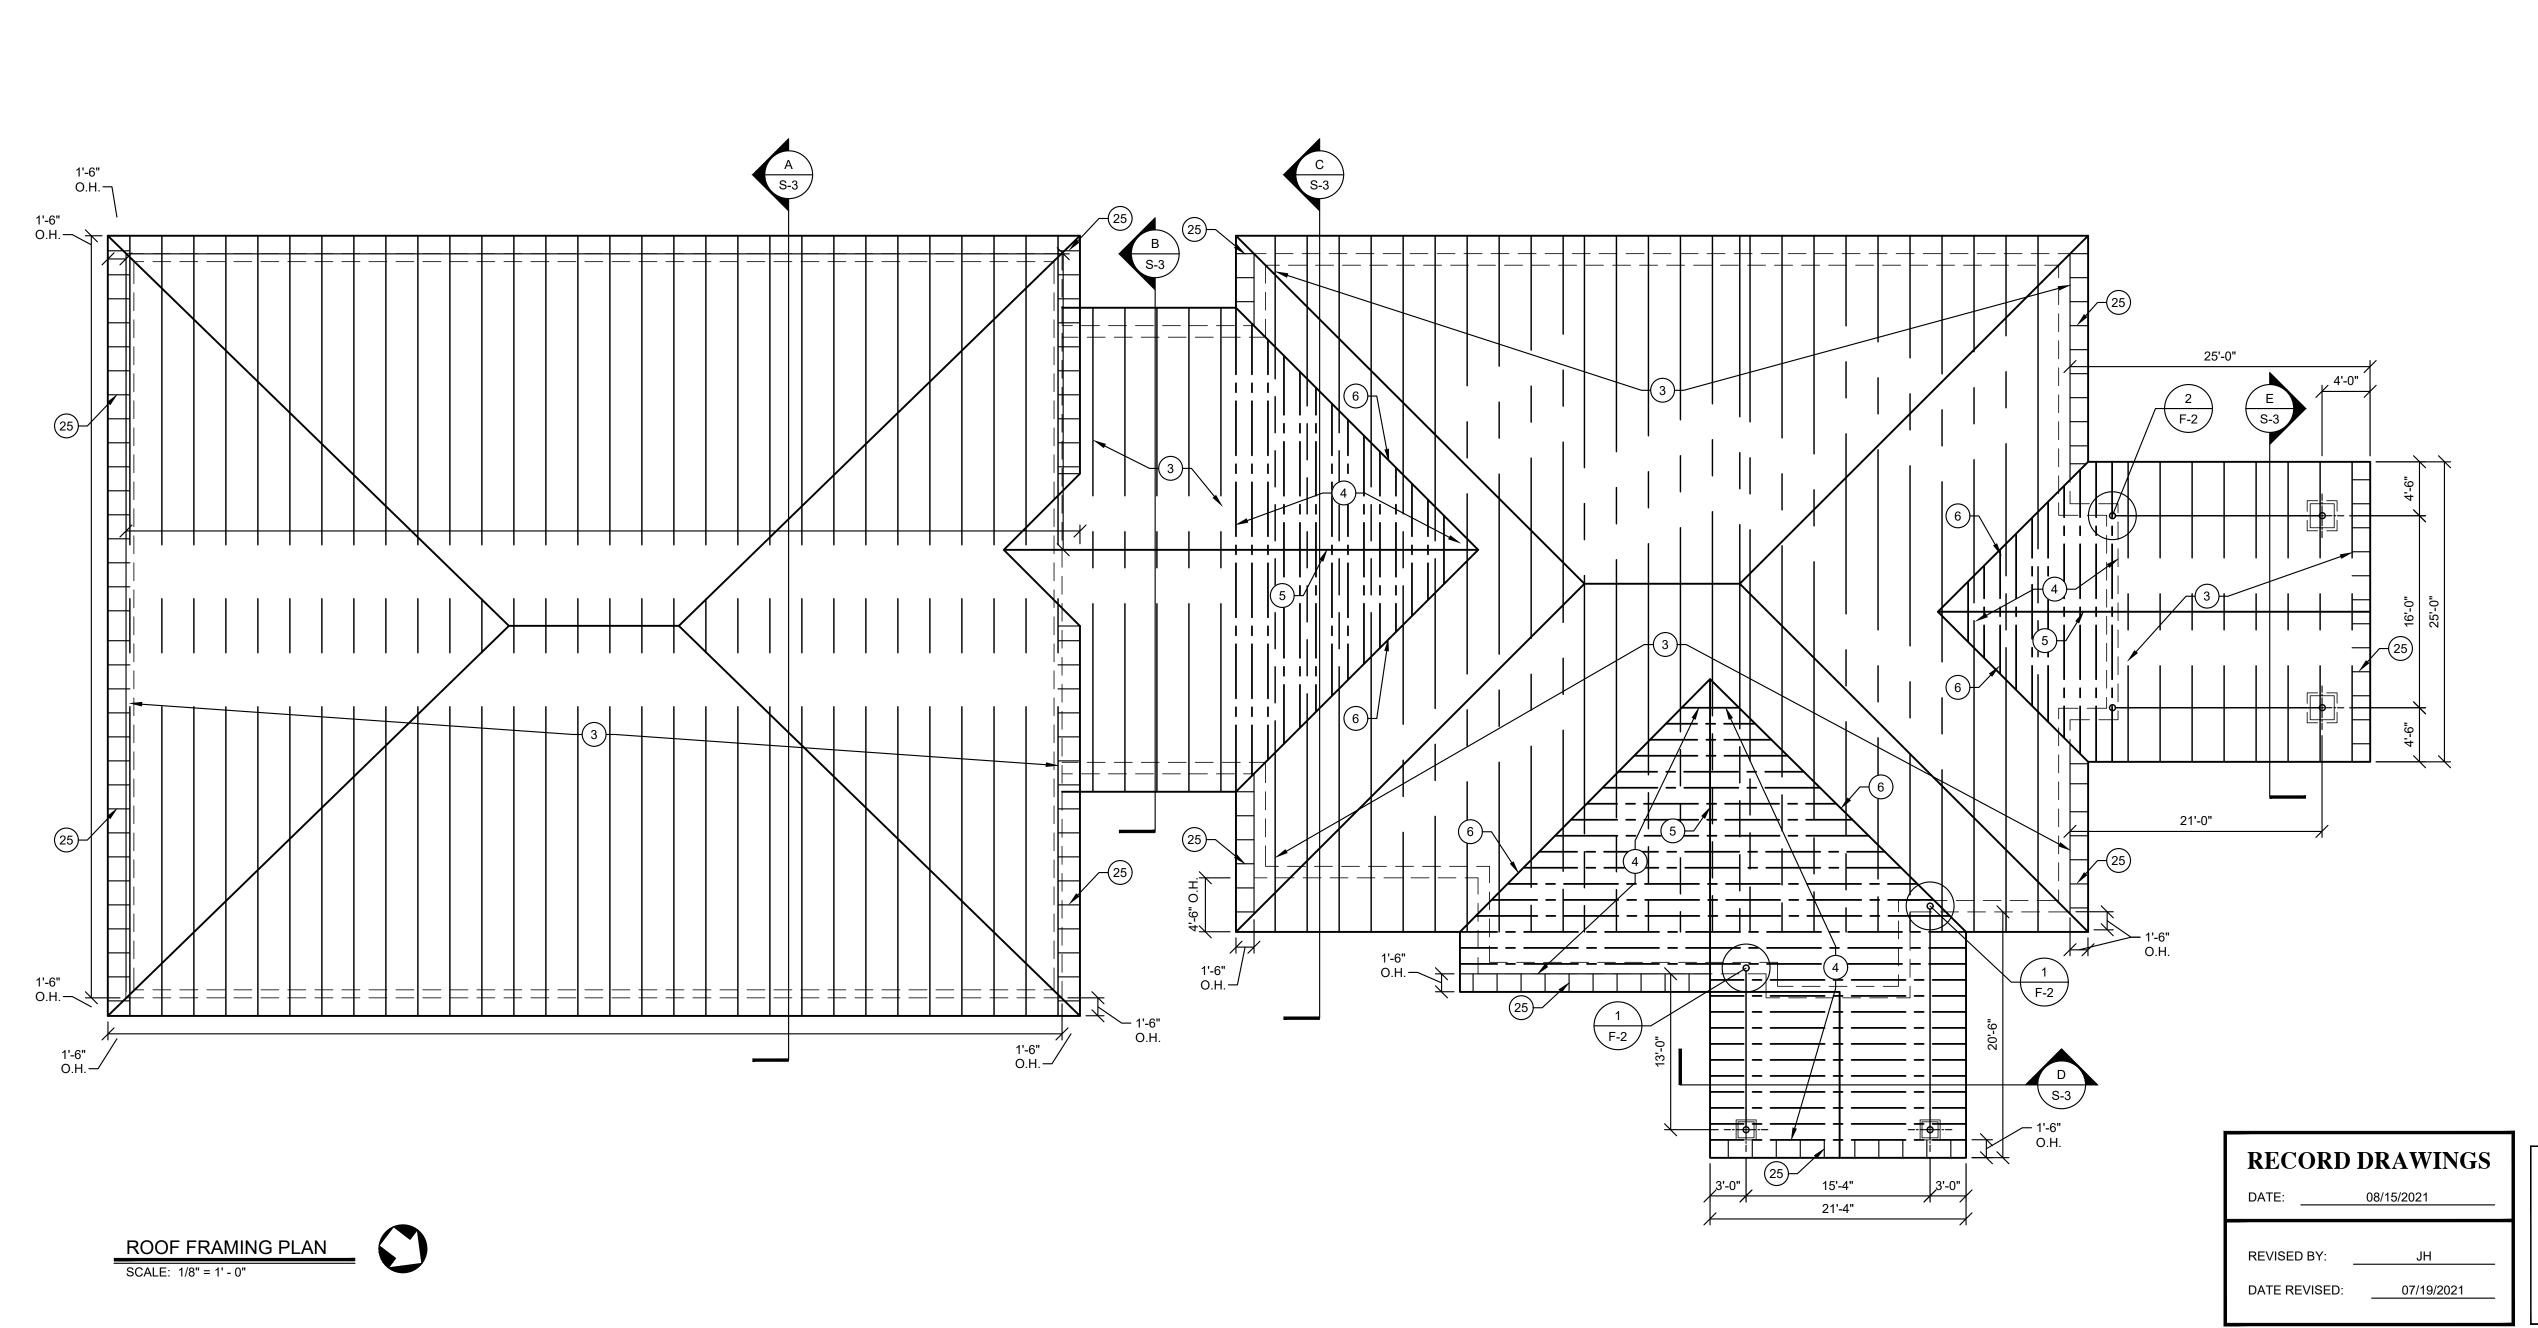
NO. DATE

REVISIONS

RSW

Fax (502) 859-0668

**BUILDING SECTION & WALL FRAMING DETAILS** 



O ROOF FRAMING NOTES:

- 1. PRE-FABRICATED, GALVANIZED STEEL ROOF TRUSSES MUST BE DESIGNED BY A KENTUCKY LICENSED ENGINEER TO SAFELY AND ADQUATELY SUPPORT ALL LIVE, SNOW, WIND, SEISMIC AND DEAD LOADS IMPOSED ON THE ROOF COMPLETED ACCORDANCE WITH ALL APPLICABLE SECTIONS OF THE KENTUCKY BUILDING CODE.
- 2018 EDITION. 2. FOUR COPIES OF THE ROOF TRUSS SHOP DRAWINGS ALONG WITH DESIGN CALCULATIONS MUST BE PREPARED, SEALED, SIGNED AND TRANSMITTED TO WHITAKER 2.
- 3. PRE-FABRICATED, GALVANIZED STEEL ROOF TRUSS AT 32" O.C. 4. 10" x 1 5/8" x 1/2 x 10 GAUGE GALVANIZED STEEL ROOF RAFTER AT
- 5. DOUBLE 12" x 1 5/8" x 1/2" x 10 GAUGE GALVINZED STEEL "CEE"
- CHANNEL ROOF RIDGE. 6. 10" x 1 5/8 " x 1/2" x 10 GAUGE GALVANIZED STEEL "CEE" VALLEY
- MEMBER. PROPERLY ANCHOR VALLEY MEMBER TO ROOF TRUSS. 7. GALVANIZED STEEL ANGLE OF SIZE TO PROPERLY ANCHOR, WITH APPROPRIATE SIZE AND NUMBER OF SCREWS, RAFTERS TO
- VALLEY MEMBER. 8. 3 1/2" x 1 5/8" x 1/2" x 10 GAUGE GALVANZIED STEEL ROOF PURLINS AT 48" O.C.
- 9. 36" WIDE x 24 GAUGE G 90 GALVANIZED STEEL COMMERICAL GRADE ROOF PANEL WITH 1 1/4" HIGH MAJOR RIBS AT 12" O.C. AND TWO MINOR RIBS BETWEEN MAJOR RIBS. SURFACE FINISH SHALL BE 1.0 MIL SILICON POLYESTER. COLOR SELECTED BY OWNER. ROOF PANELS MUST BE RATED TO SUPPORT A MINUM UNIFORM LOARD OF 95 P.S.F. WITH ROOF PURLINS AT 48" O.C.
- 10. INSTALL 8 MIL CLASS 1 VAPOR BARRIER WITH A PERM OF 0.1 OR LESS UNDER ROOF PANELS AND OVER ROOF PURLINS.
- 11. INSTALL 4" VINYL FACED FIBERGLASS BATT INSULATION WHERE
- 12. INSTALL 10" VINYL FACED FIBERGLASS BATT INSULATION WHERE NOTED.
- 13. GALVANIZED STEEL ANGLE OF SIZE TO PROPERLY ANCHOR MEMBERS TOGETHER WITH APPROPIATE NUMBER AND SIZE OF
- 14. CONTINUOUS RIDGE VENT SELECTED TO BE COMPATIBLE WITH
- ROOF PANEL
- 15. 8" x 1 3/8" x 3/8" x 12 GAUGE GALVANIZED STEEL "CEE" CHANNEL
- FASCIA.
- 16. W12 x 26 STEEL BEAM. 17. PERSERVATIVE TREATED 2x4 NAILER ANHORED TO FLANGE OF
- W12 x 26 BEAM WITH SELF-DRILLING ANCHOR SCREWS AT 24" O.C. 18. 2x4 PERSERVATIVE TREATED STUDS AT 16" O.C.
- 19. 1x8 POPLAR TRIM BOARD CUT TO FIT.
- 20. 3/4" HIGH DENSITY OVERLAY BOARD.
- 21. 1" x 4" POPLAR TRIM.
- 22. PRE-FINISHED, CONTINUOUS VENTED ALUMINUM SOFFIT WITH "ELL" TRIM.
- 23. PRE-FINISHED, CONTINUOUS VENTED ALUMINUM CEILING WITH " ELL" TRIM
- 24. 6" x 6" PRE-FINISHED ALUMINUM GUTTER INSTALLED TO POSITVIE DRAIN TO 6" x 4" PRE-FINISHED ALUMINUM DOWNSPOUTS. GUTTER
- PROFILE SUBJECT TO WHITAKER 2 APPROVAL. 25. 6" x 1 5/8" x 1/2" x 10 GAUGE GALVANIZED STEEL "CEE" OUTLOOKER AT 24" O.C.

# WHITAKER 2

1860 FRANKFORT ROAD SHELBYVILLE, KENTUCKY 40065 502-633-4981 / 502-633-0377

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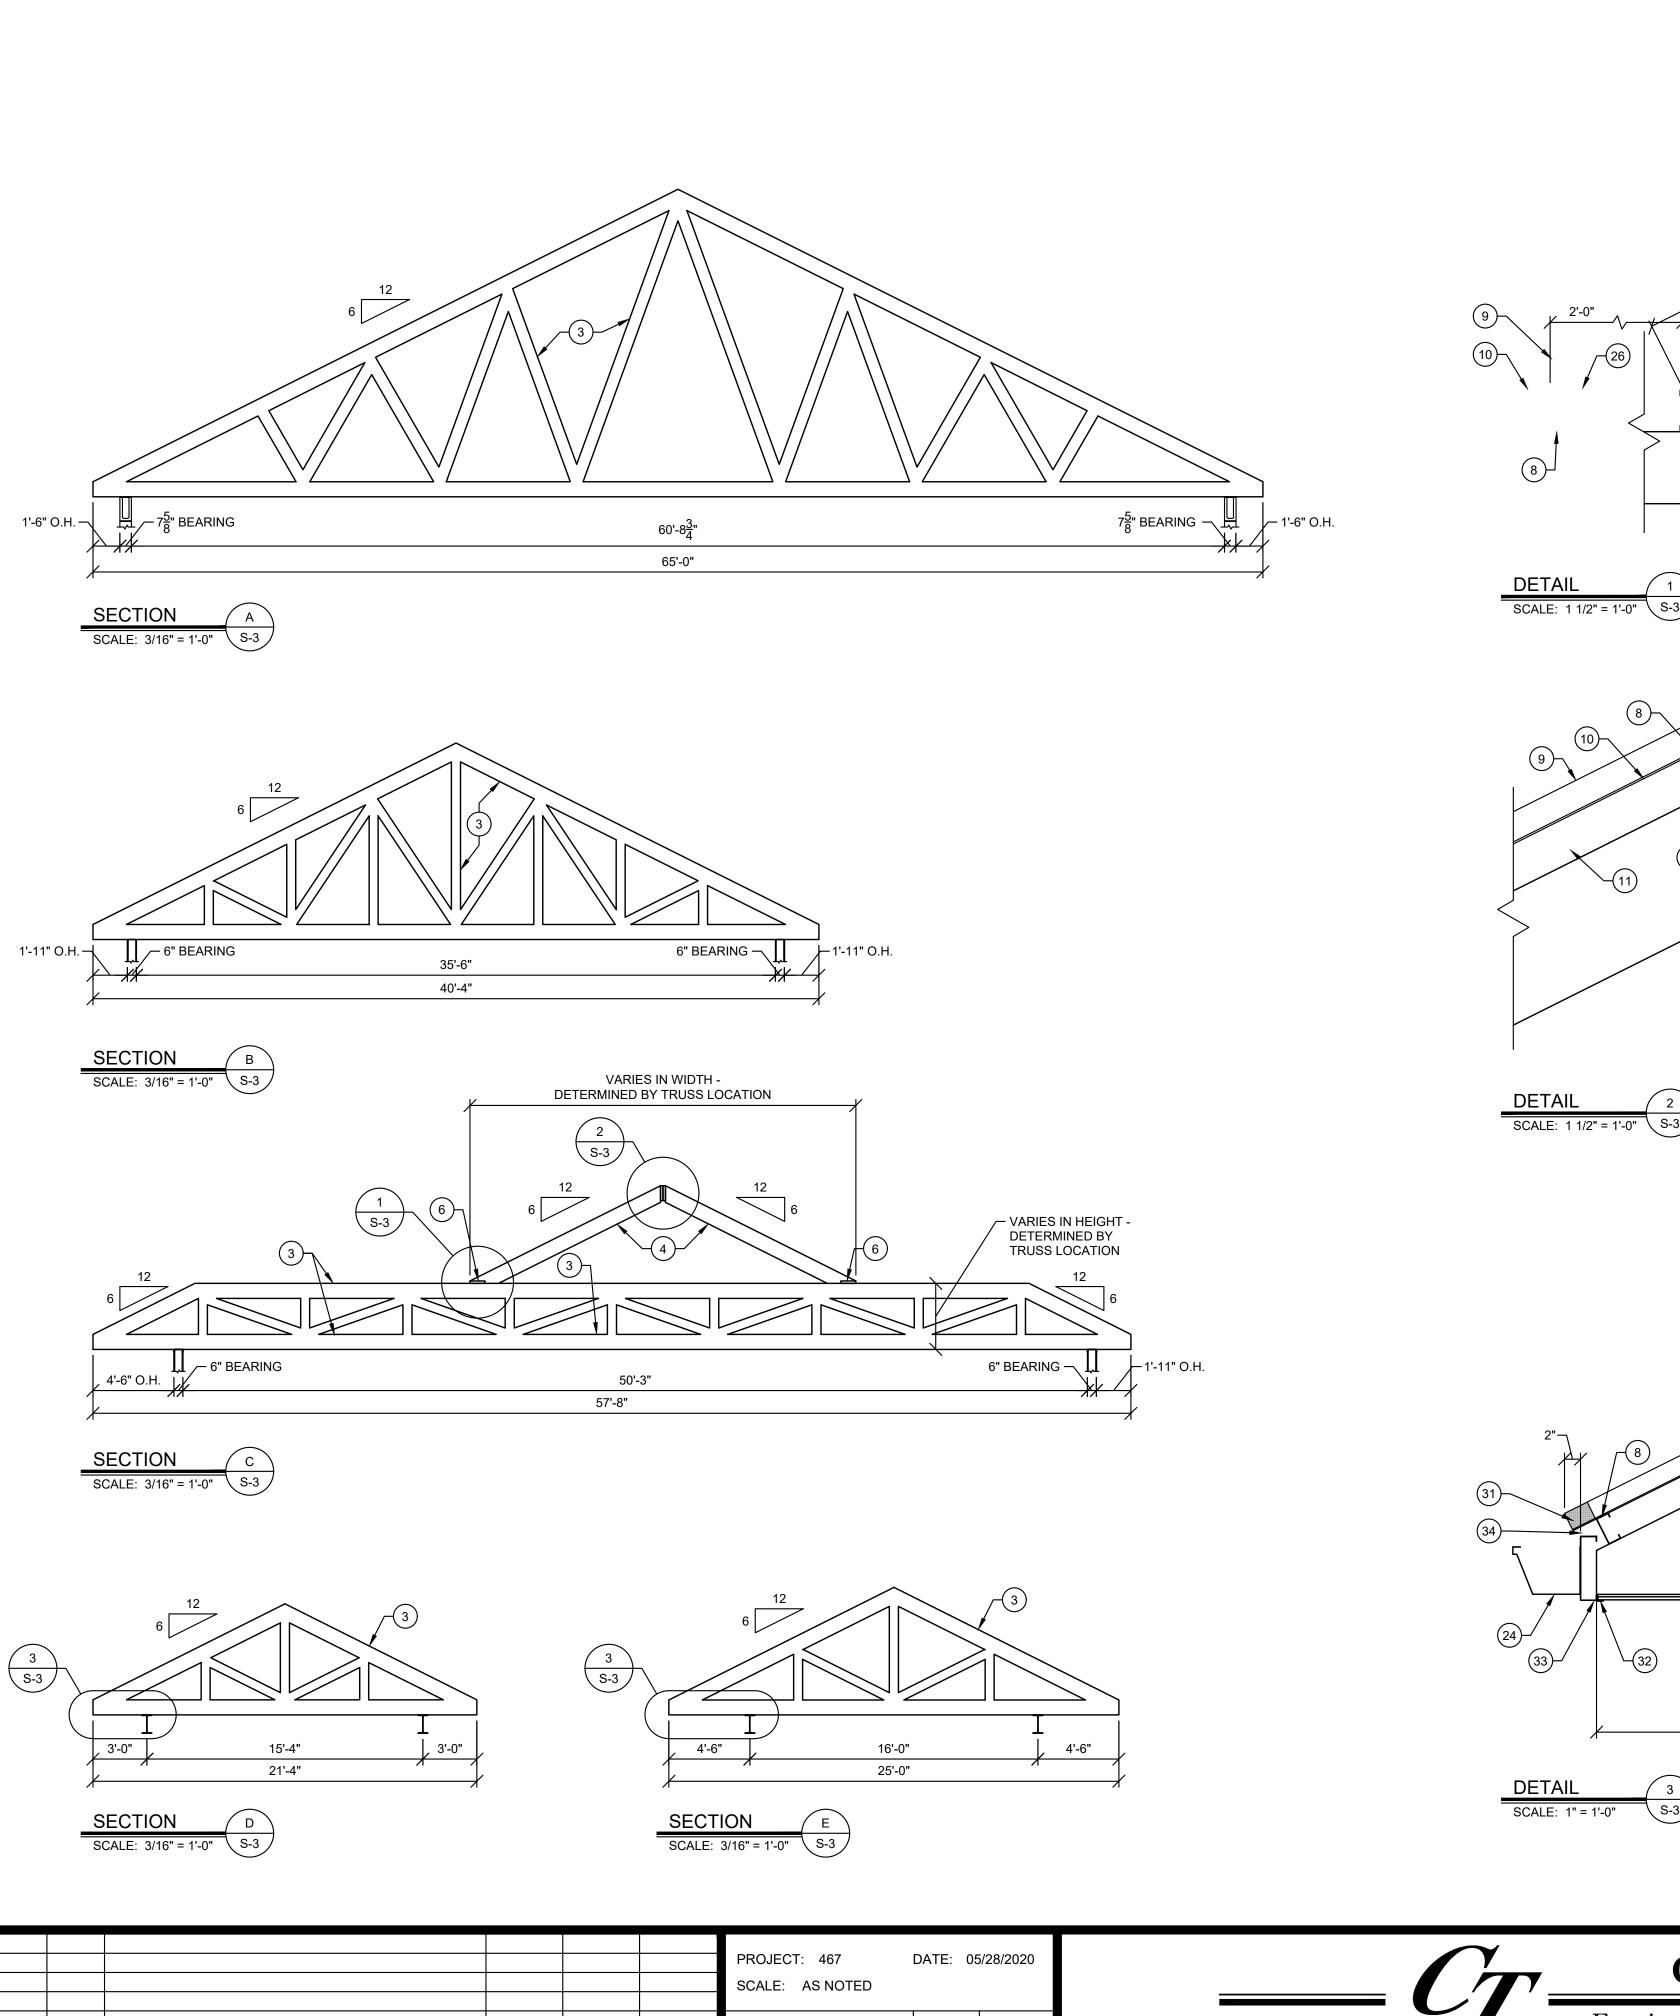
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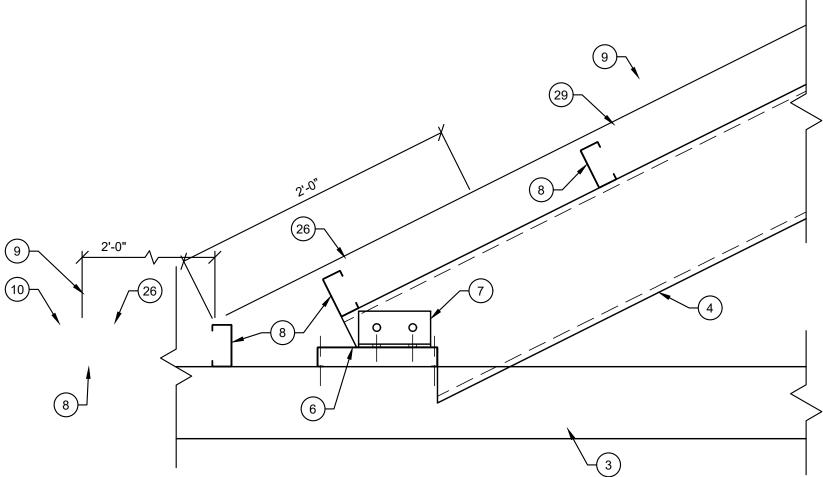
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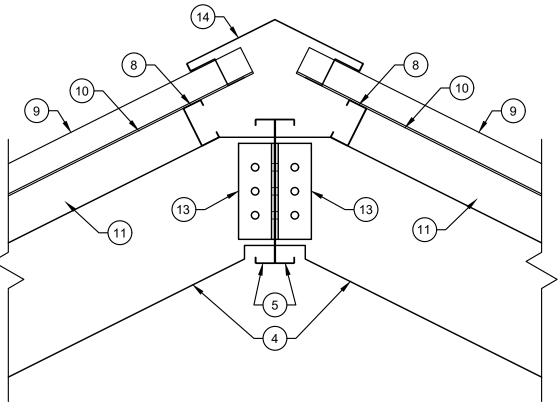
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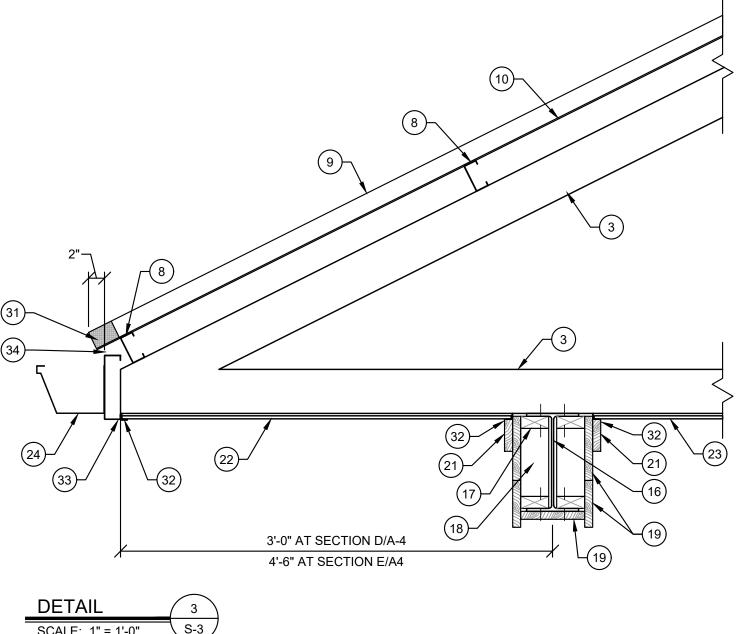
LCWD 2020 OFFICE BUILDING LARUE COUNTY WATER DISTRICT LARUE COUNTY, KENTUCKY

ROOF FRAMING PLAN









#### ROOF FRAMING NOTES:

- PRE-FABRICATED, GALVANIZED STEEL ROOF TRUSSES MUST BE DESIGNED BY A KENTUCKY LICENSED ENGINEER TO SAFELY AND ADEQUATELY SUPPORT ALL LIVE, SNOW, WIND, SEISMIC AND DEAD LOADS IMPOSED ON THE ROOF COMPLETED ACCORDANCE WITH ALL APPLICABLE SECTIONS OF THE KENTUCKY BUILDING CODE,
- 2018 EDITION. 2. FOUR COPIES OF THE ROOF TRUSS SHOP DRAWINGS ALONG WITH DESIGN CALCULATIONS MUST BE PREPARED, SEALED, SIGNED
- AND TRANSMITTED TO WHITAKER 2. 3. PRE-FABRICATED, GALVANIZED STEEL ROOF TRUSS AT 32" O.C. 4. 10" x 1 5/8" x 1/2 x 10 GAUGE GALVANIZED STEEL ROOF RAFTER AT
- 5. DOUBLE 12" x 1 5/8" x 1/2" x 10 GAUGE GALVANIZED STEEL "CEE" CHANNEL ROOF RIDGE.
- 6. 10" x 1 5/8 " x 1/2" x 10 GAUGE GALVANIZED STEEL "CEE" VALLEY MEMBER. PROPERLY ANCHOR VALLEY MEMBER TO ROOF TRUSS.
- 7. GALVANIZED STEEL ANGLE OF SIZE TO PROPERLY ANCHOR, WITH APPROPRIATE SIZE AND NUMBER OF SCREWS, RAFTERS TO VALLEY MEMBER.
- 8. 3 5/8" x 1 5/8" x 1/2" x 10 GAUGE GALVANIZED STEEL ROOF PURLINS
- AT 48" O.C.
- 9. 36" WIDE x 24 GAUGE G 90 GALVANIZED STEEL COMMERCIAL GRADE ROOF PANEL WITH 1 1/4" HIGH MAJOR RIBS AT 12" O.C. AND TWO MINOR RIBS BETWEEN MAJOR RIBS. SURFACE FINISH SHALL BE 1.0 MIL SILICON POLYESTER. COLOR SELECTED BY OWNER. ROOF PANELS MUST BE RATED TO SUPPORT A MINIMUM UNIFORM LOAD OF 95 P.S.F. WITH ROOF PURLINS AT 48" O.C.
- 10. INSTALL 8 MIL CLASS 1 VAPOR BARRIER WITH A PERM OF 0.1 OR LESS UNDER ROOF PANELS AND OVER ROOF PURLINS.
- 11. INSTALL 4" VINYL FACED FIBERGLASS BATT INSULATION OVER
- GARAGE ROOF PANELS. 12. INSTALL 10" VINYL FACED FIBERGLASS BATT INSULATION ABOVE
- CEILINGS IN OFFICE BUILDING. 13. GALVANIZED STEEL ANGLE OF SIZE TO PROPERLY ANCHOR
- MEMBERS TOGETHER WITH APPROPRIATE NUMBER AND SIZE OF
- 14. CONTINUOUS RIDGE VENT SELECTED TO BE COMPATIBLE WITH ROOF PANEL OR SHINGLES.
- 15. 8" x 1 3/8" x 3/8" x 12 GAUGE GALVANIZED STEEL "CEE" CHANNEL
- 16. W12 x 26 STEEL BEAM.
- 17. PRESERVATIVE TREATED 2x4 NAILER ANCHORED TO FLANGE OF
- W12 x 26 BEAM WITH SELF-DRILLING ANCHOR SCREWS AT 24" O.C. 18. 2x4 PRESERVATIVE TREATED STUDS AT 16" O.C.
- 19. 1x8 POPLAR TRIM BOARD CUT TO FIT.
- 20. 3/4" HIGH DENSITY OVERLAY BOARD.
- 21. 1" x 4" POPLAR TRIM.
- 22. PRE-FINISHED, CONTINUOUS VENTED ALUMINUM SOFFIT WITH "ELL" TRIM.
- 23. PRE-FINISHED, CONTINUOUS VENTED ALUMINUM CEILING WITH "
- ELL" TRIM 24. 6" x 6" PRE-FINISHED ALUMINUM GUTTER INSTALLED TO POSITIVE
- DRAIN TO 6" x 4" PRE-FINISHED ALUMINUM DOWNSPOUTS. GUTTER PROFILE SUBJECT TO WHITAKER 2 APPROVAL 25. 6" x 1 5/8" x 1/2" x 10 GAUGE GALVANIZED STEEL "CEE" OUTLOOKER
- AT 24" O.C. 26. 16 GAUGE, PRE-BENT GALVANIZED STEEL, 2'-0"x2'-0" VALLEY
- 27. SEAL ROOF PANEL TO VALLEY FLASHING WITH ELASTOMERIC,
- WATERPROOF SEALANT. 28. SEAL SHINGLES TO VALLEY FLASHING WITH ELASTOMERIC,
- 29. 5/8" AMERICAN PLYWOOD ASSOCIATED RATED ROOF SHEATHING. ANCHOR TO ROOF PURLINS WITH SELF-TAPPING SCREWS @ 8"
- 30. INSTALL SIMPSON STRONG-TIE PLY-CLIPS @ 24" O.C. ON ALL PLYWOOD ROOF SHEATHING.31. PRE-MOLDED NEOPRENE CLOSURE STRIP.
- 32. PRE-FINISHED ALUMINUM "ELL" TRIM.
- 33. 2"x10" PRE-FINISHED STEEL CHANNEL FASCIA. 34. ELASTOMERIC, WATERPROOF SEALANT.

WATERPROOF SEALANT.

### WHITAKER 2

1860 FRANKFORT ROAD SHELBYVILLE, KENTUCKY 40065 502-633-4981 / 502-633-0377

REC	ORD DRAWINGS
DATE:	08/15/2021

REVISED BY DATE REVISED: SPECIAL NOTICE

KENTUCKY BUILDING CODE 2018, INTERNATIONAL MECHANICAL CODE 2015, INTERNATIONAL CONSERVATION CODE 2012, INTERNATIONAL FIRE CODE 2015, KENTUCKY PLUMBING CODE 2013 & NATIONAL ELECTRICAL CODE 2017.

						PROJECT: 467	DATE: 05	/28/2020
						SCALE: AS NOTED		
						DESIGNED BY:	RSW	
						DRAWN BY:	JH	
						CHECKED BY:	RSW	
NO.	DATE	REVISIONS	DATE	APPR'D	DATE	RECORD DRAWINGS		

1100 Glensboro Road

Lawrenceburg, KY 40342


### CANN-TECH, LLC


Engineers · Planners · Managers


Phone (502) 859-0907 Fax (502) 859-0668


LCWD 2020 OFFICE BUILDING LARUE COUNTY WATER DISTRICT LARUE COUNTY, KENTUCKY


ROOF FRAMING DETAILS

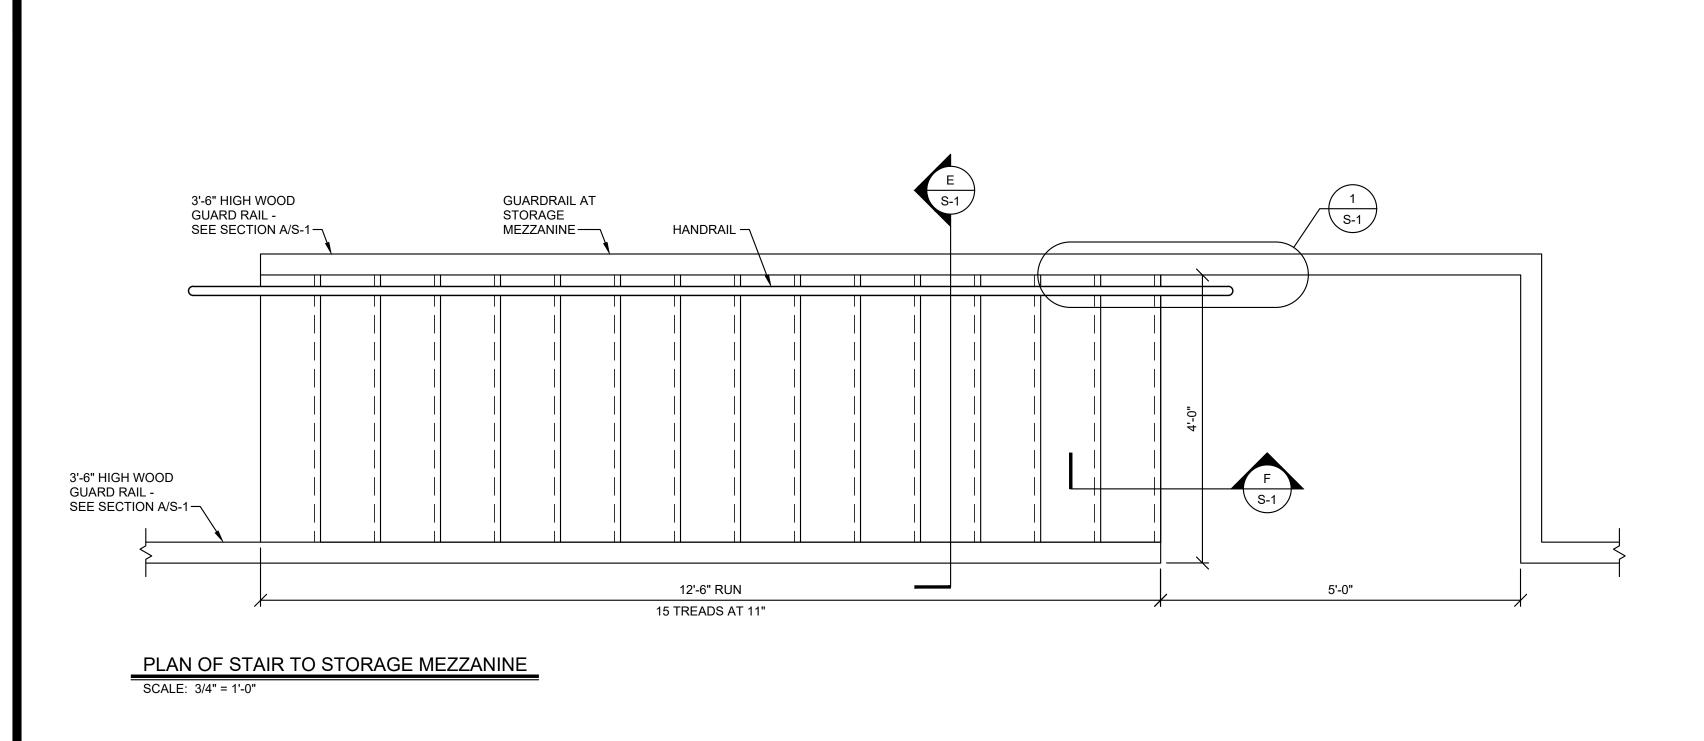

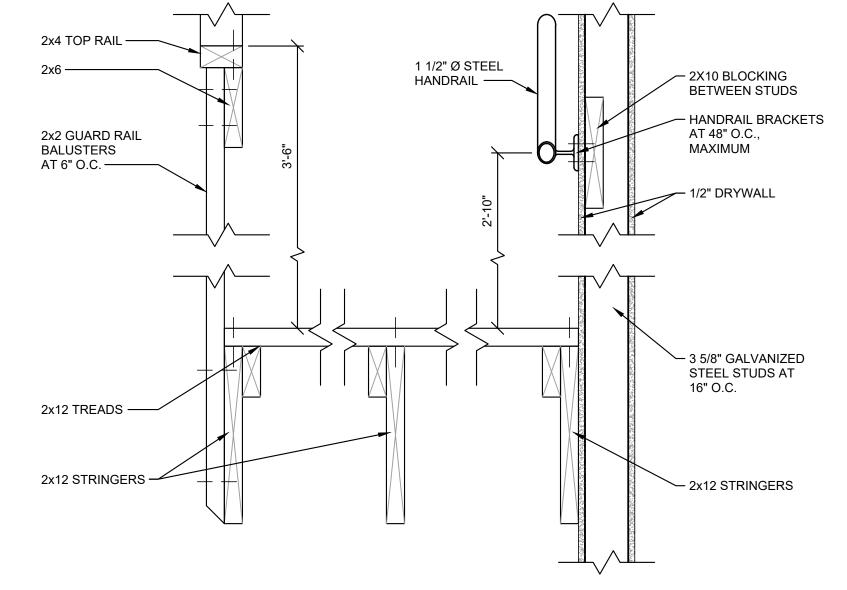

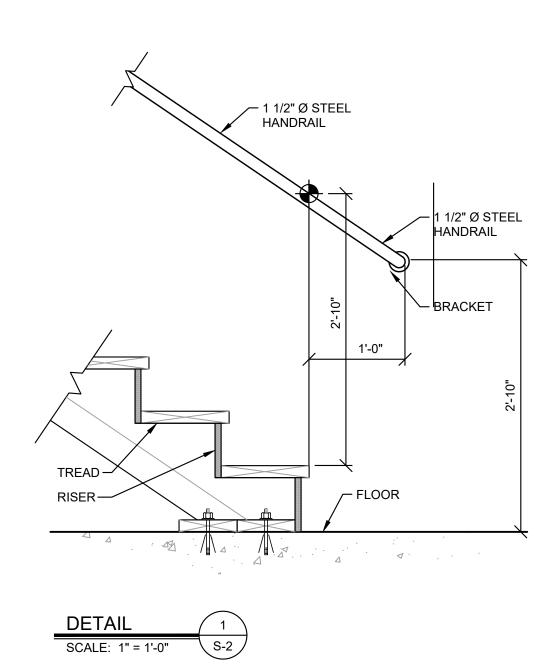

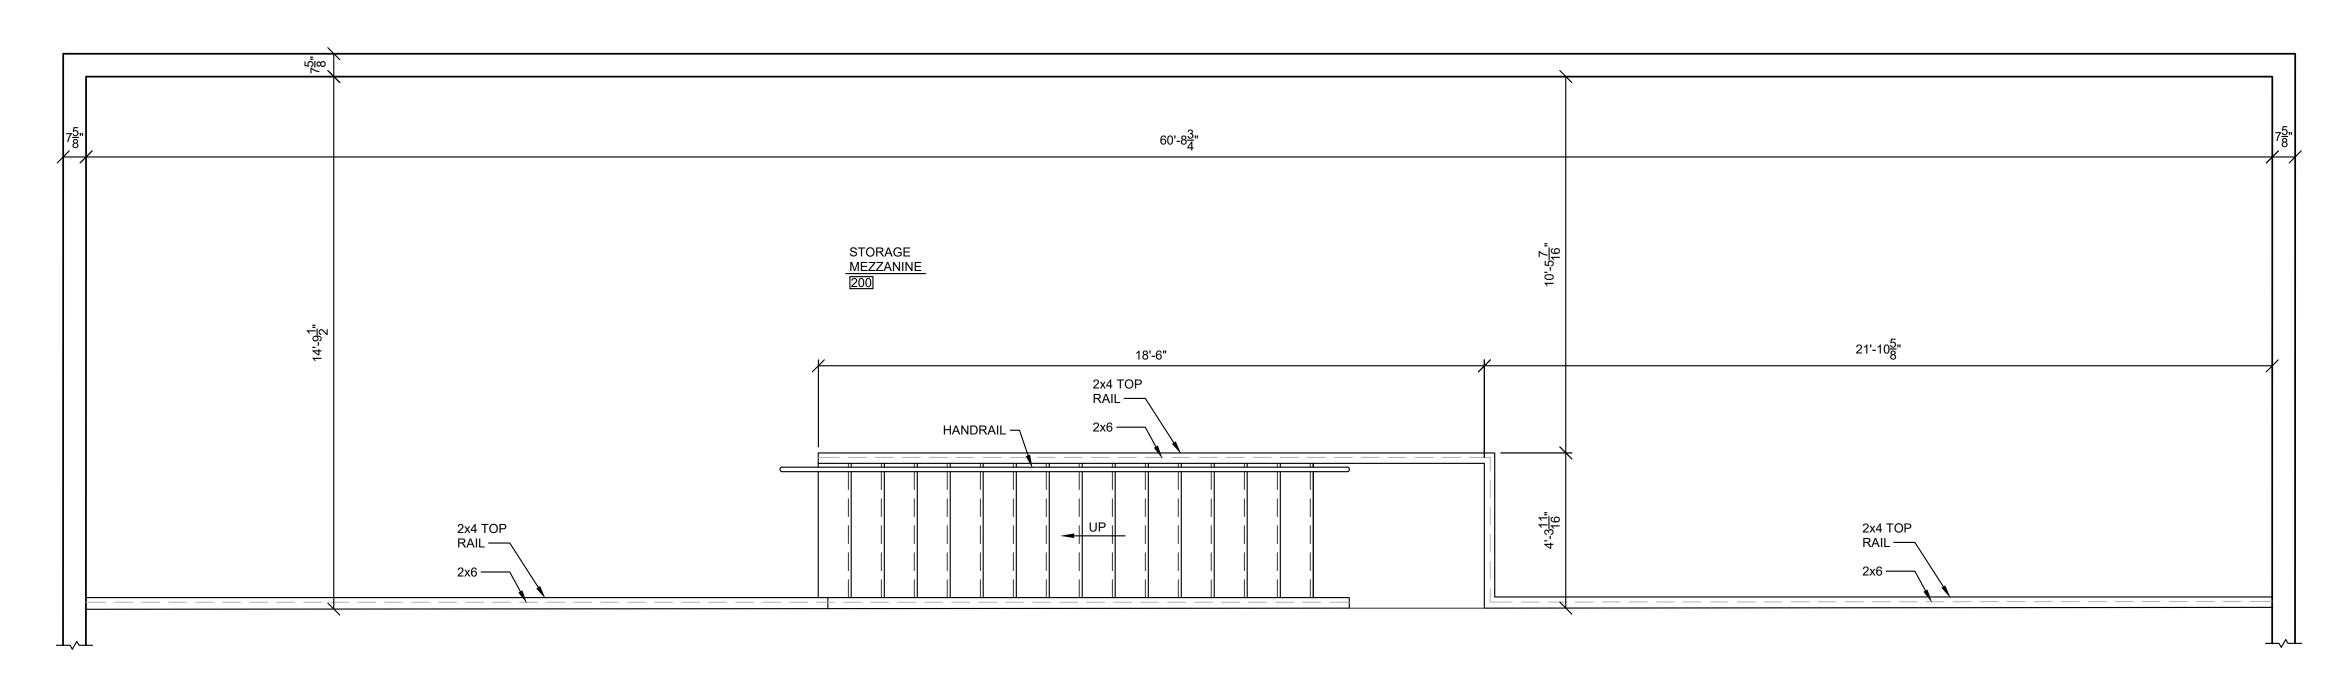

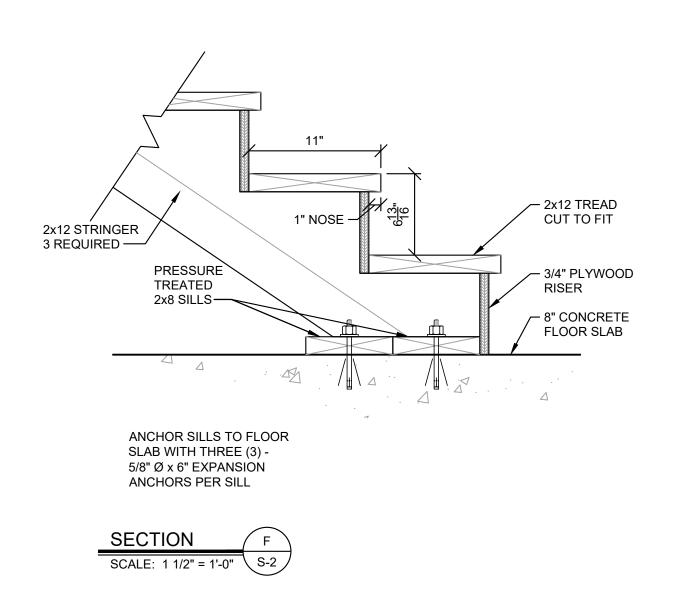

WHITAKER 2

1860 FRANKFORT ROAD SHELBYVILLE, KENTUCKY 40065 502-633-4981 / 502-633-0377

RECOR	D DRAWINGS						
DATE: 08/15/2021							
DEVISED BV:	ILI						

DATE REVISED:

07/19/2021

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						DESIGNED BY:	RSW	
						DRAWN BY:	JH	
						CHECKED BY:	RSW	
NO.	DATE	REVISIONS	DATE	APPR'D	DATE	RECORD DRAWINGS		

STORAGE MEZZANINE PLAN

1100 Glensboro Road

Lawrenceburg, KY 40342

CANN-TECH, LLC


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LCWD 2020 OFFICE BUILDING LARUE COUNTY WATER DISTRICT LARUE COUNTY, KENTUCKY

SHEET

MEZZANINE & STAIR FRAMING DETAILS



RECORD DRAWINGS

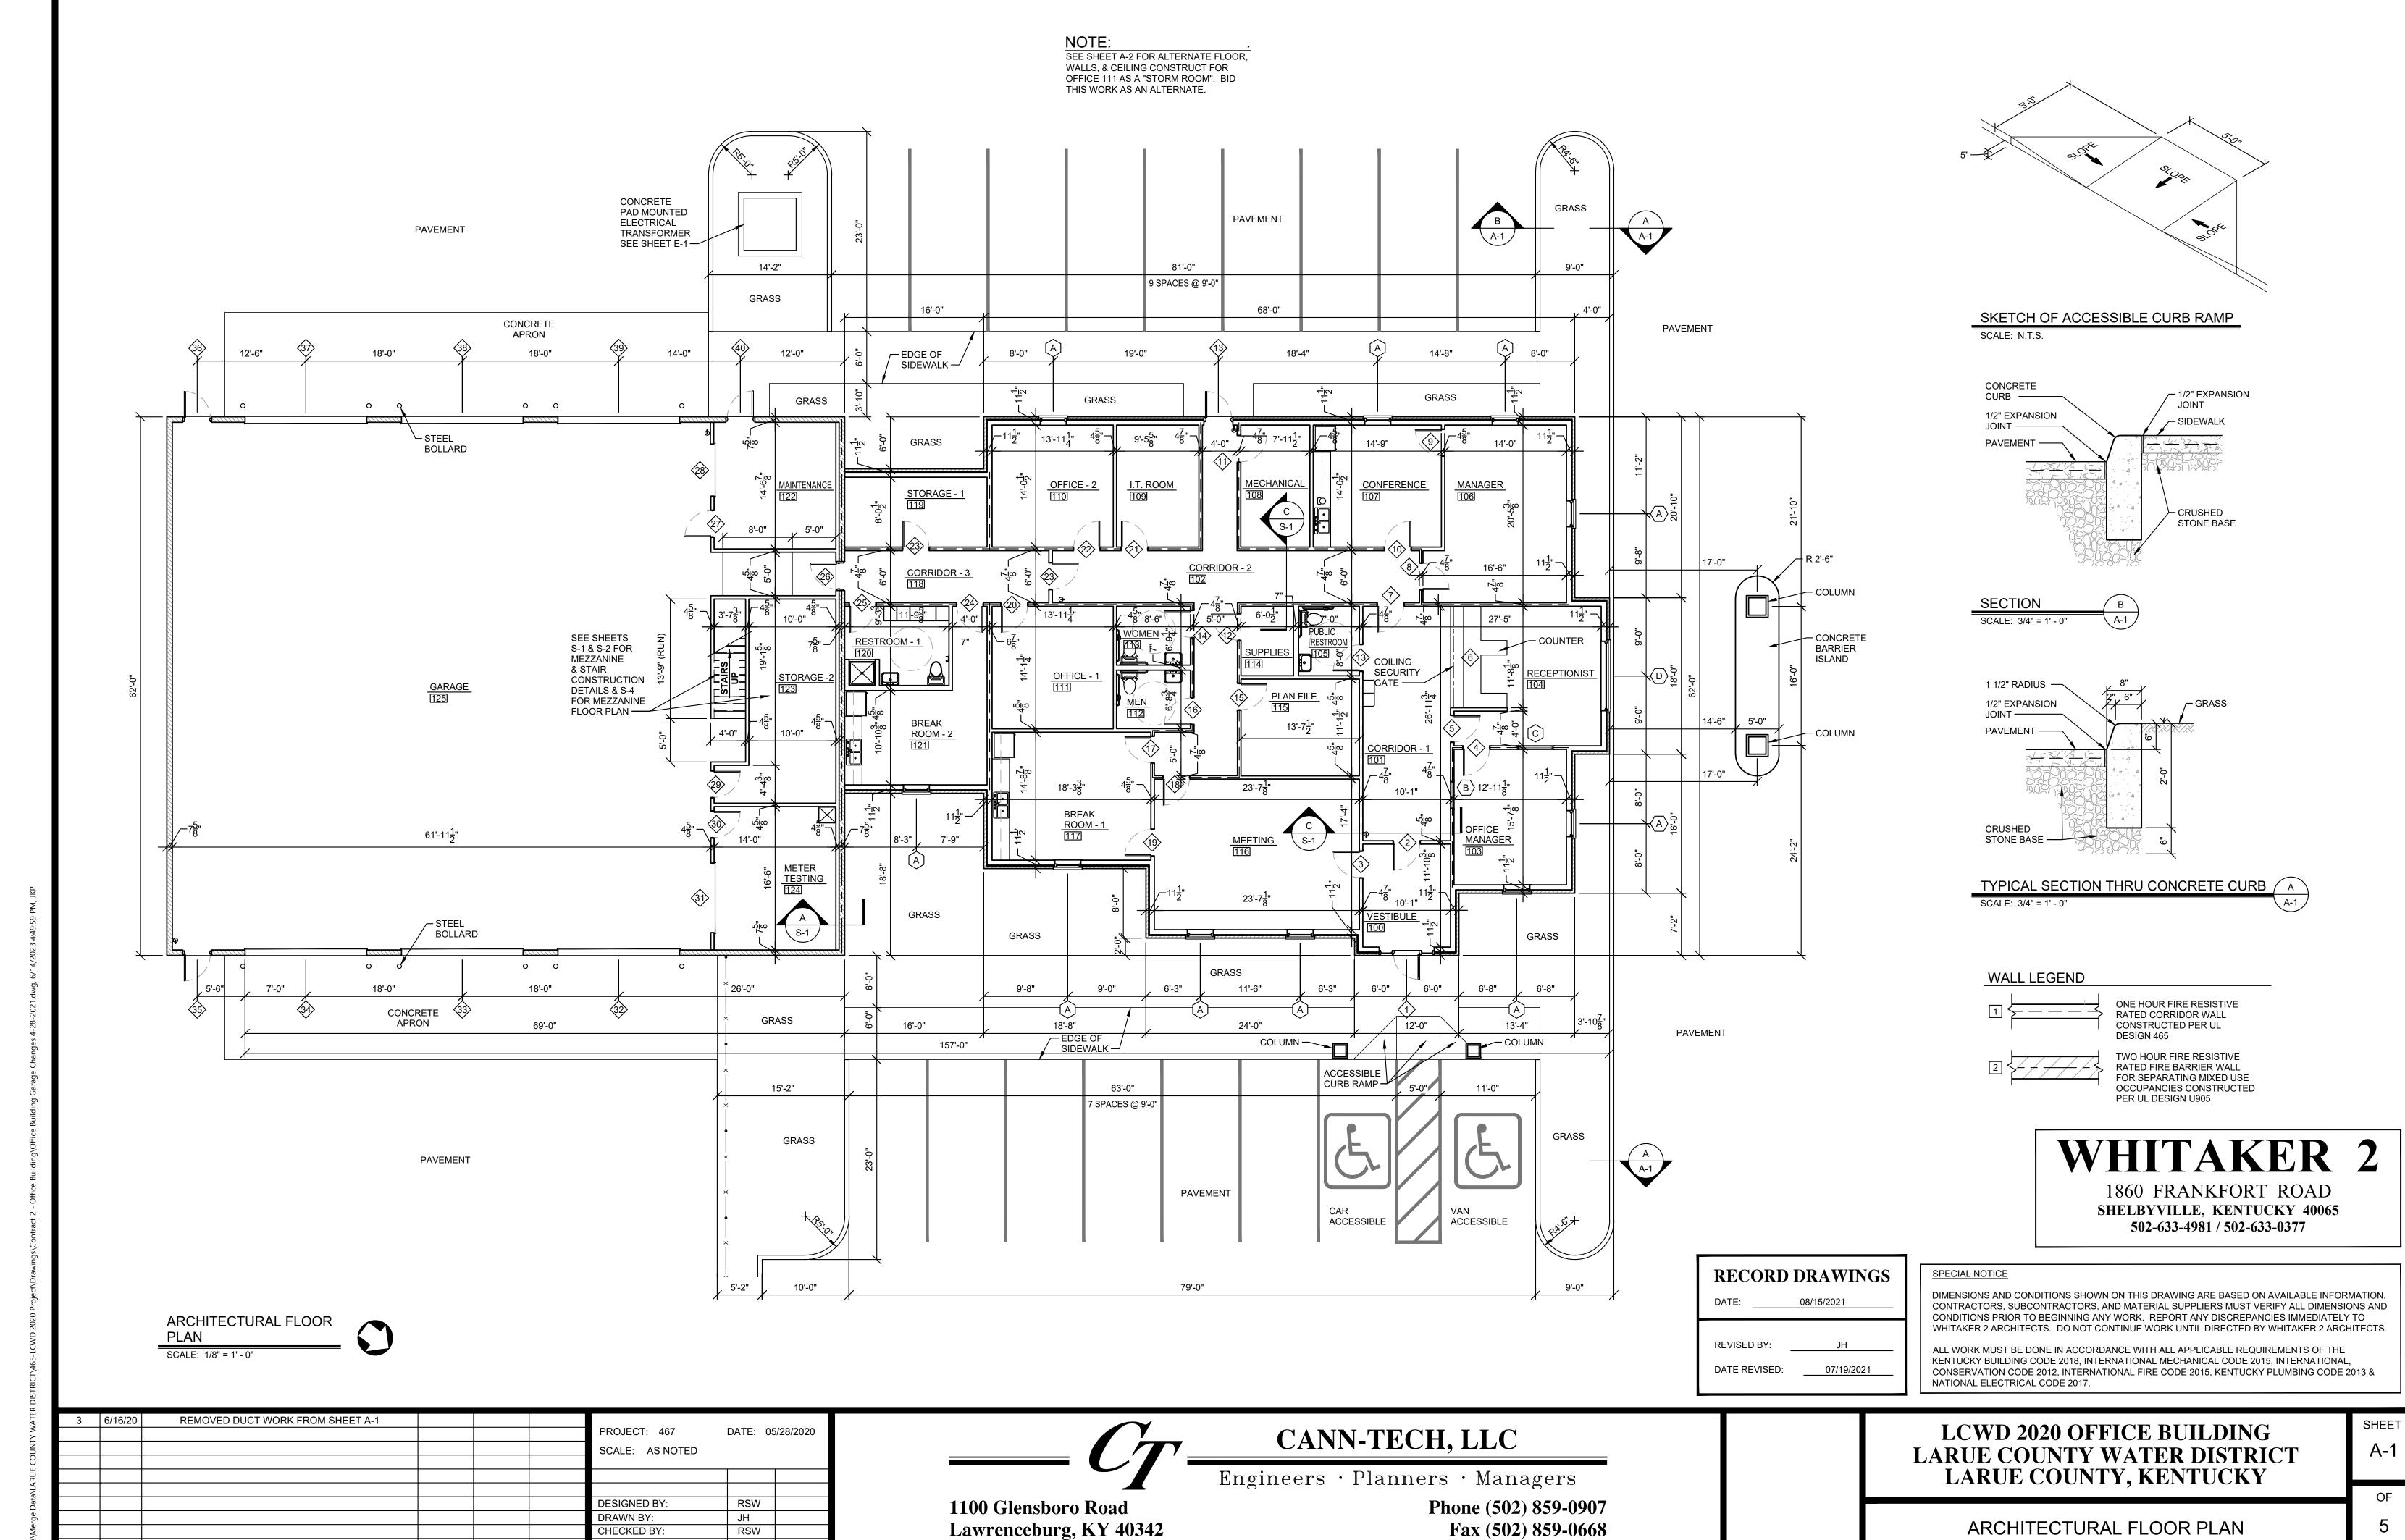
DATE APPR'D DATE

NO. DATE

REVISIONS

Fax (502) 859-0668

ARCHITECTURAL FLOOR PLAN

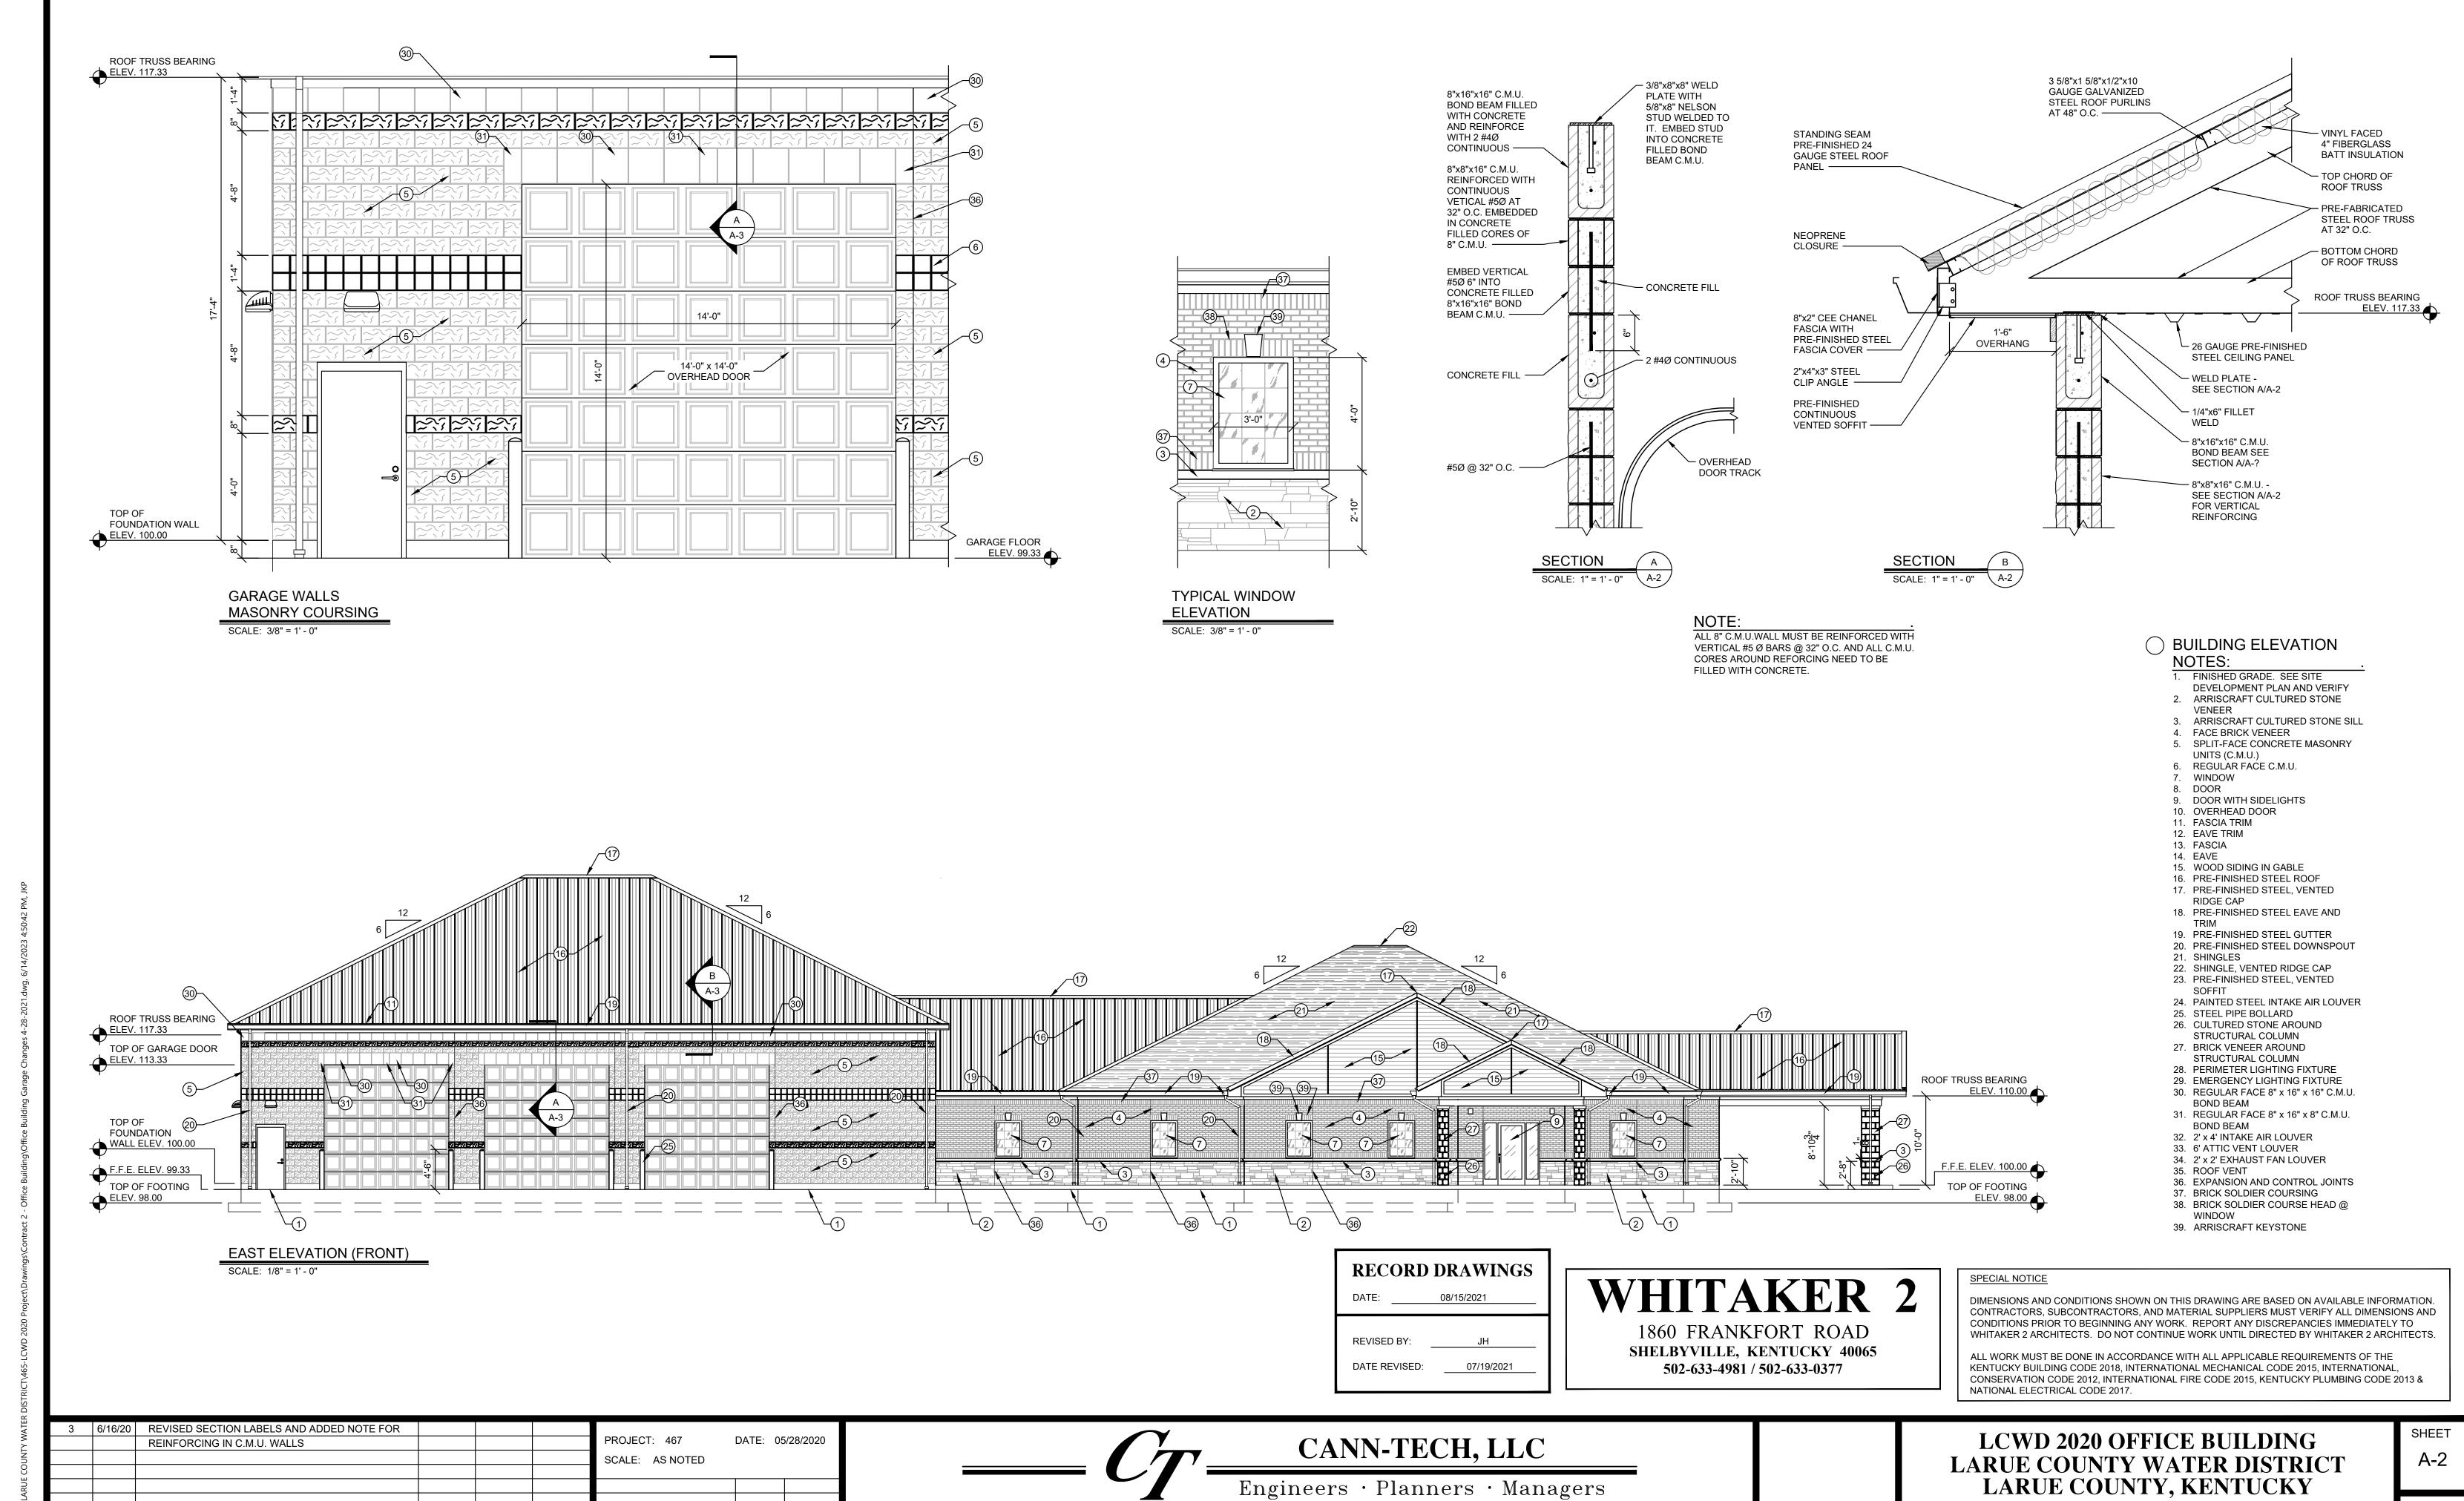

1100 Glensboro Road

Lawrenceburg, KY 40342

**DESIGNED BY:** 

DRAWN BY:

DATE APPR'D DATE

NO. DATE

REVISIONS

CHECKED BY:

**RECORD DRAWINGS** 

RSW


RSW

JH

Phone (502) 859-0907 Fax (502) 859-0668 LARUE COUNTY, KENTUCKY

**BUILDING ELEVATIONS** 

OF

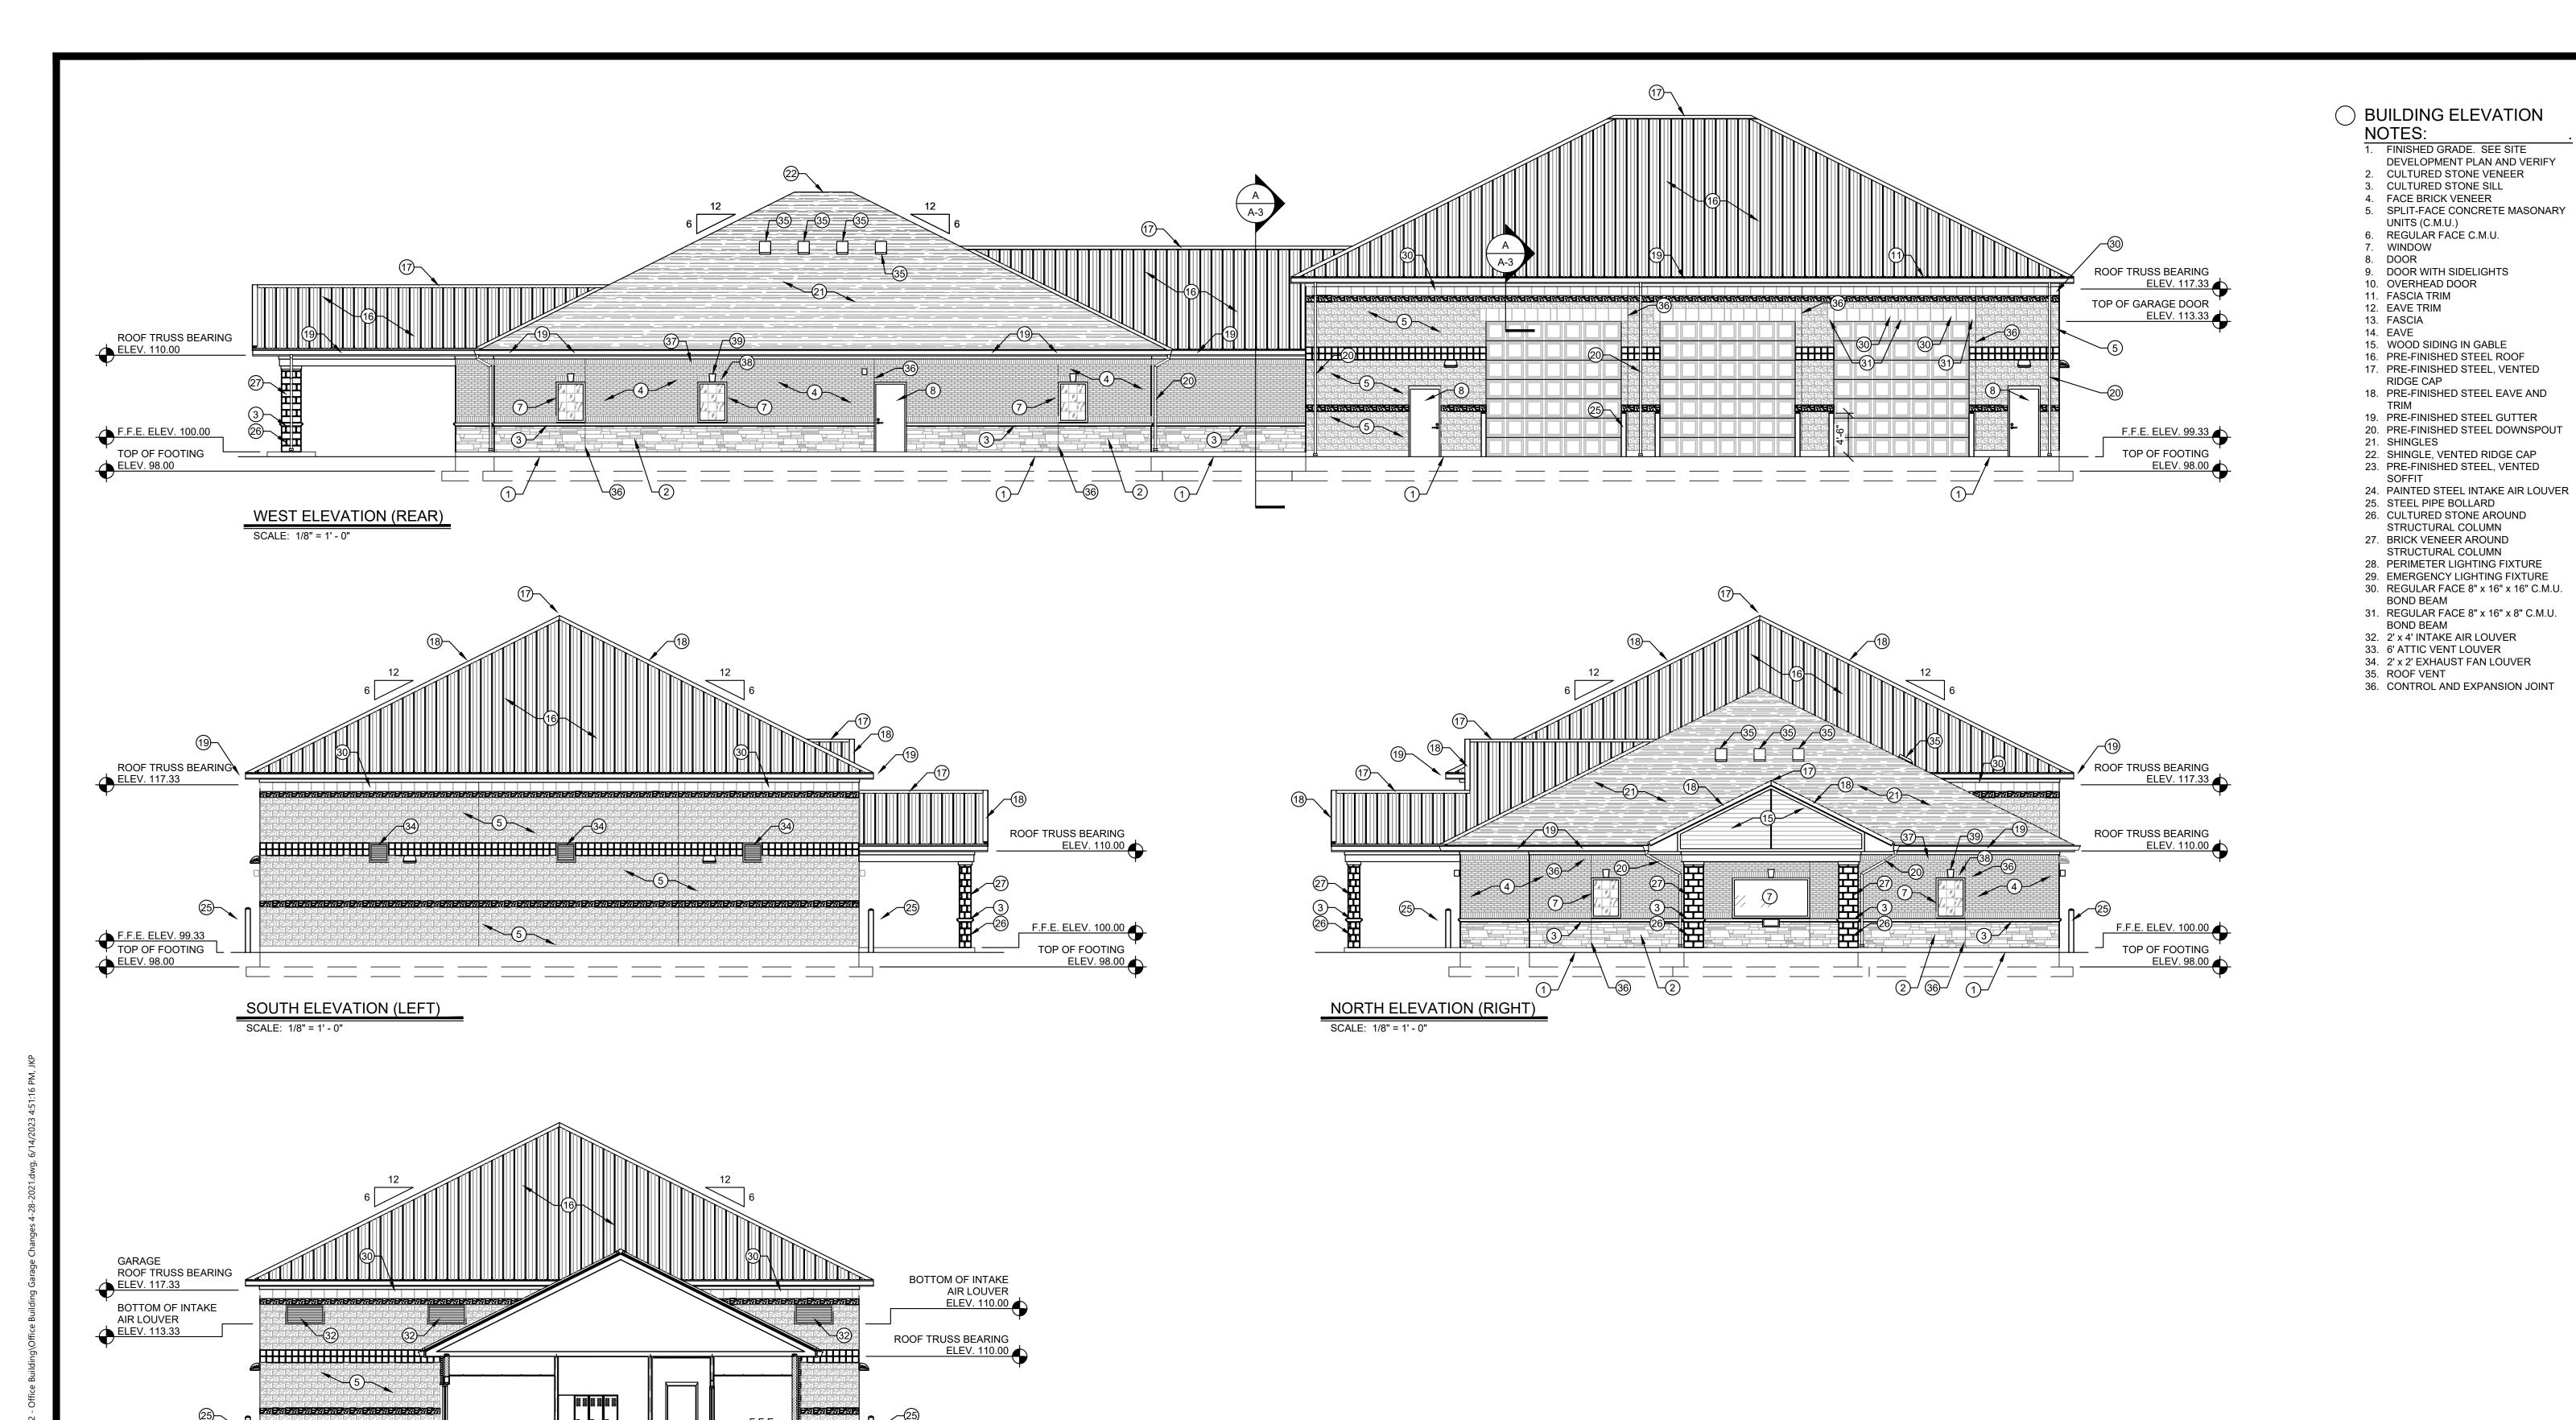



SPECIAL NOTICE WHITAKER 2

1860 FRANKFORT ROAD

SHELBYVILLE, KENTUCKY 40065

502-633-4981 / 502-633-0377

CONDITIONS PRIOR TO BEGINNING ANY WORK. REPORT ANY DISCREPANCIES IMMEDIATELY TO

RIDGE CAP

STRUCTURAL COLUMN

**BOND BEAM** 

KENTUCKY BUILDING CODE 2018, INTERNATIONAL MECHANICAL CODE 2015, INTERNATIONAL CONSERVATION CODE 2012, INTERNATIONAL FIRE CODE 2015, KENTUCKY PLUMBING CODE 2013 & NATIONAL ELECTRICAL CODE 2017.

DATE: 05/28/2020 SCALE: AS NOTED **DESIGNED BY:** RSW DRAWN BY: CHECKED BY: RSW NO. DATE **RECORD DRAWINGS** 

F.F.E. ELEV. 99.33 TOP OF FOOTING

ELEV. 98.00

1100 Glensboro Road

Lawrenceburg, KY 40342

CANN-TECH, LLC

REVISED BY:

Engineers · Planners · Managers

**RECORD DRAWINGS** 

DATE REVISED: 07/19/2021


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LCWD 2020 OFFICE BUILDING LARUE COUNTY WATER DISTRICT LARUE COUNTY, KENTUCKY

SHEET

**BUILDING ELEVATIONS** 

OF

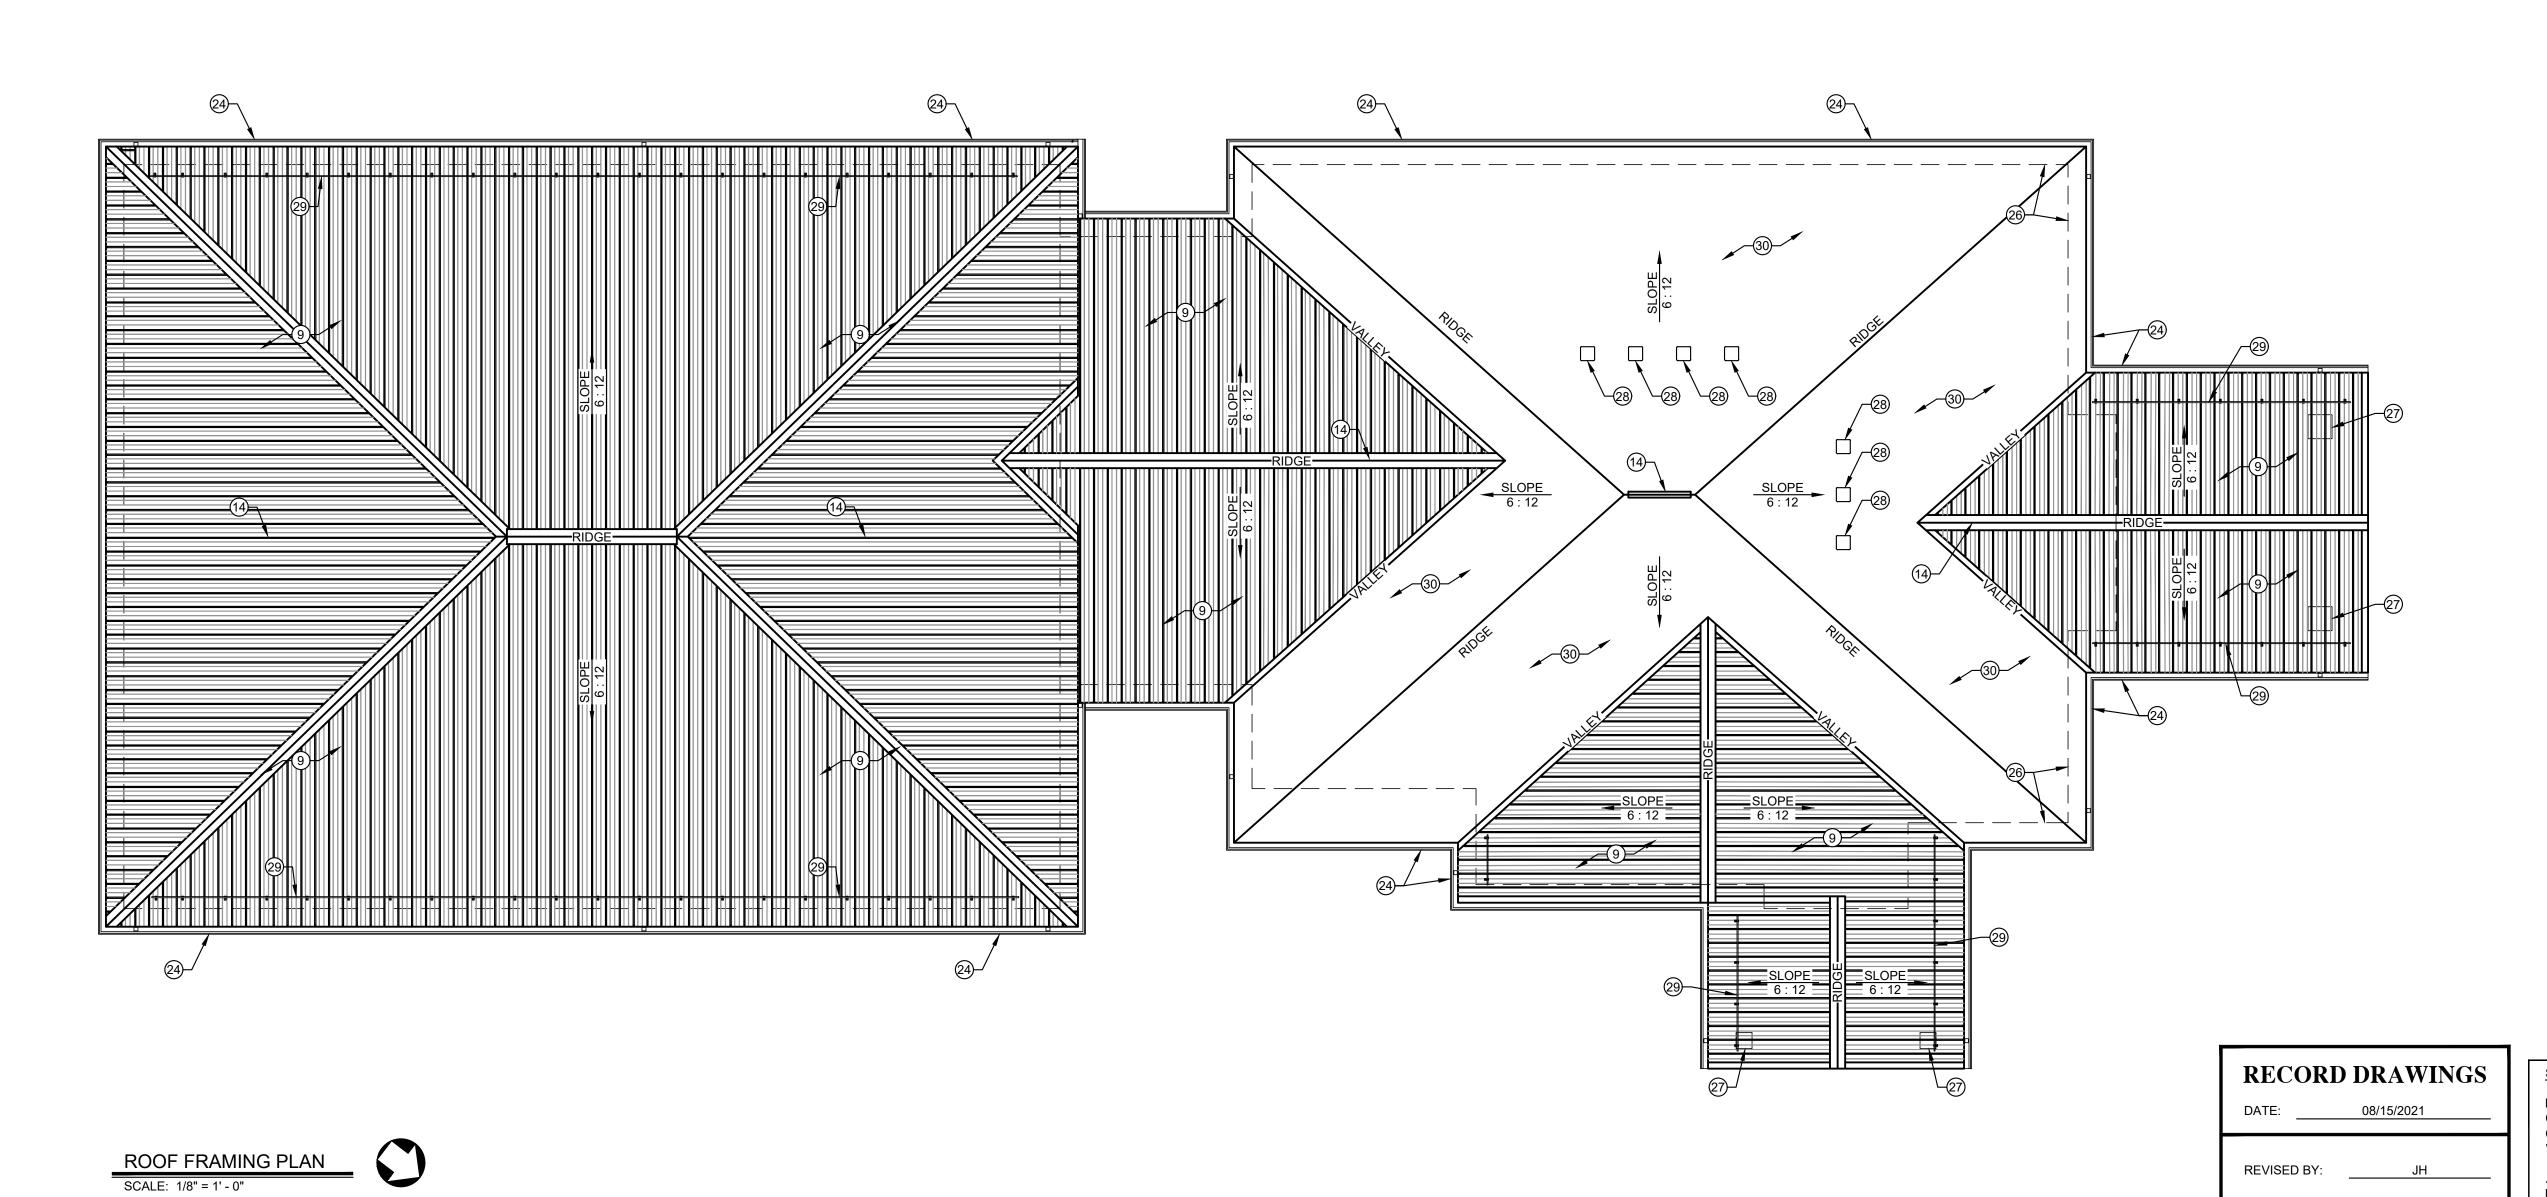

O ROOF FRAMING NOTES:

- 1. PRE-FABRICATED, GALVANIZED STEEL ROOF TRUSSES MUST BE DESIGNED BY A KENTUCKY LICENSED ENGINEER TO SAFELY AND ADEQUATELY SUPPORT ALL LIVE, SNOW, WIND, SEISMIC AND DEAD LOADS IMPOSED ON THE ROOF COMPLETED ACCORDANCE WITH ALL APPLICABLE SECTIONS OF THE KENTUCKY BUILDING CODE,
- 2018 EDITION.

  2. FOUR COPIES OF THE ROOF TRUSS SHOP DRAWINGS ALONG WITH DESIGN CALCULATIONS MUST BE PREPARED, SEALED, SIGNED
- PRE-FABRICATED , GALVANIZED STEEL ROOF TRUSS AT 32" O.C.
   10" x 1 5/8" x 1/2 x 10 GAUGE GALVANIZED STEEL ROOF RAFTER AT

AND TRANSMITTED TO WHITAKER 2.

- 5. DOUBLE 12" x 1 5/8" x 1/2" x 10 GAUGE GALVANIZED STEEL "CEE"
- CHANNEL ROOF RIDGE.
  6. 10" x 1 5/8 " x 1/2" x 10 GAUGE GALVANIZED STEEL "CEE" VALLEY
- MEMBER. PROPERLY ANCHOR VALLEY MEMBER TO ROOF TRUSS.

  7. GALVANIZED STEEL ANGLE OF SIZE TO PROPERLY ANCHOR, WITH APPROPRIATE SIZE AND NUMBER OF SCREWS, RAFTERS TO VALLEY MEMBER.
- 8. 3 1/2" x 1 5/8" x 1/2" x 10 GAUGE GALVANIZED STEEL ROOF PURLINS AT 48" O.C.
- 9. 36" WIDE x 24 GAUGE G 90 GALVANIZED STEEL COMMERCIAL GRADE ROOF PANEL WITH 1 1/4" HIGH MAJOR RIBS AT 12" O.C. AND TWO MINOR RIBS BETWEEN MAJOR RIBS. SURFACE FINISH SHALL BE 1.0 MIL SILICON POLYESTER. COLOR SELECTED BY OWNER. ROOF PANELS MUST BE RATED TO SUPPORT A MINIMUM UNIFORM LOAD OF 95 P.S.F. WITH ROOF PURLINS AT 48" O.C.
- 10. INSTALL 8 MIL CLASS 1 VAPOR BARRIER WITH A PERM OF 0.1 OR LESS UNDER ROOF PANELS AND OVER ROOF PURLINS.
- INSTALL 4" VINYL FACED FIBERGLASS BATT INSULATION WHERE NOTED.
- 12. INSTALL 10" VINYL FACED FIBERGLASS BATT INSULATION WHERE NOTED.
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- 24. 6" x 6" PRE-FINISHED ALUMINUM GUTTER INSTALLED TO POSITIVE DRAIN TO 6" x 4" PRE-FINISHED ALUMINUM DOWNSPOUTS. GUTTER PROFILE SUBJECT TO WHITAKER 2 APPROVAL.
- 25. 6" x 1 5/8" x 1/2" x 10 GAUGE GALVANIZED STEEL "CEE" OUTLOOKER AT 24" O.C.
- 26. LINE OF EXTERIOR WALL BELOW.27. COLUMN BELOW
- 28. ROOF VENT
- 29. ICE GUARD
- 30. ASPHALT SHINGLES

### WHITAKER 2

1860 FRANKFORT ROAD SHELBYVILLE, KENTUCKY 40065 502-633-4981 / 502-633-0377

SPECIAL NOTICE

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						PROJECT: 467 SCALE: AS NOTED	DATE: 05/2	8/2020
						DESIGNED BY:	RSW	
						DRAWN BY:	JH	
						CHECKED BY:	RSW	·
NO	DATE	REVISIONS	DATE	APPR'D	DATE	RECORD DRAWINGS		

1100 Glensboro Road

Lawrenceburg, KY 40342

CANN-TECH, LLC

Engineers · Planners · Managers

Phone (502) 859-0907 Fax (502) 859-0668 LCWD 2020 OFFICE BUILDING LARUE COUNTY WATER DISTRICT LARUE COUNTY, KENTUCKY

ROOF PLAN

SHEET
A-4

N

5

ABBREVIATIONS

A - ALUMINUM FL - FLUSH SF - STOREFRONT OH - OVERHEAD ST - STEEL WA - WRAP AROUND C - COILING SECURITY DOOR MFR - MANUFACTURER'S

DOOR HARDWARE NOTES:

HARDWARE SETS: SET #1 PANIC HARDWARE, LOCKABLE, EXTERIOR THUMBLATCH CLOSURE

WEATHERSTRIPPING & THRESHOLD LOCKSET, LEVER ACTION

LOCKSET, LEVER ACTION, CLOSURE PANIC HARDWARE, LEVER ACTION, CLOSURE

OVERHEAD DOOR MANUFACTURER'S DOOR OPERATOR, LOCK

SYSTEM & WEATHER SEAL. LOCKSET, LEVER ACTION, CLOSURE, WATERSTOP THRESHOLD

PUSH-PULL, CLOSURE, PRIVACY LOCK SET #7 COILING DOOR MANUFACTURER'S HARDWARE WITH LOCK

ADA COMPLIANT:

DOOR HARDWARE INCLUDING HANDLES, PULLS, LATCHES, LOCKS, AND OTHER OPERATION DEVICES ON ACCESSIBLE DOORS SHALL HAVE A SHAPE THAT IS EASY TO GRASP WITH ONE HAND AND DOES NOT REQUIRE TIGHT GRASPING, TIGHT PINCHING OR TWISTING OF THE WRIST TO OPERATE, LEVER-OPERATED MECHANISMS, PUSH-TYPE MECHANISMS AND U-SHAPED HANDLES ARE ACCEPTABLE DESIGNS.

ALL THUMBLATCHES SHALL BE RELEASED BY OPERATION OF PANIC HARDWARE ON DOORS EQUIPPED WITH PANIC HARDWARE.

4. ALL EGRESS DOORS SHALL BE READILY OPERABLE FROM EGRESS SIDE WITHOUT THE USE OF A KEY OR SPECIAL KNOWLEDGE OR EFFORT.

FINIS	SH SCHEDULE	- WTP	BUIL	OING	}					
ROOM NO.	ROOM NAME	FLOOR	BASE	WALI N	_S _E	S	W	CLG.	CLG. HT.	REMARKS & NOTES
100	VESTIBULE	LVT	V	FD	FD	FD	FD	FD	9'-8 7/8"	1 HR. RATED
101	CORRIDOR - 1	LVT	V	FD	FD	FD	FD	FD	9'-8 7/8"	1 HR. RATED
102	CORRIDOR - 2	LVT	V	FD	FD	FD	FD	FD	9'-8 7/8"	1 HR. RATED
103	OFFICE MANAGER	С	V	D	D	FD	FD	SAT	9'-6"	1 HR. RATED
104	RECEPTIONIST	С	V	D	FD	FD	FD	FD	9'-8 7/8"	1 HR. RATED
105	PUBLIC RESTROOM	LVT	V	FD	ED	ED	FD	ED	9'-11 3/8"	
106	MANAGER	С	V	D	FD	D	D	SAT	9'-6"	
107	CONFERENCE	С	V	D	FD	D	D	SAT	9'-6"	
108	MECHANICAL	SC	V	D	FD	D	D	D	9'-11 3/8"	
109	I.T. ROOM	С	V	FD	FD	D	D	SAT	9'-6"	
110	OFFICE - 2	С	V	D	FD	D	D	SAT	9'-6"	
111	OFFICE - 1	С	V	CM	CM	CM	CM	D	9'-7 3/4"	
112	MEN	LVT	V	FD	D	D	D	SAT	9'-5"	
113	WOMEN	LVT	V	FD	D	D	FD	SAT	9'-6"	
114	SUPPLIES	LVT	V	D	D	FD	FD	SAT	9'-6"	
115	PLAN FILE	LVT	V	FD	D	FD	D	SAT	9'-6"	
116	MEETING	С	V	D	FD	D	FD	SAT	9'-6"	
117	BREAK ROOM - 1	LVT	V	FD	D	D	D	SAT	9'-6"	
118	CORRIDOR - 3	LVT	V	FD	FD	D	FD	SAT	9'-6"	1 HR. RATED
119	STORAGE - 1	SC	V	FD	FD	FD	D	SAT	9'-6"	
120	RESTROOM - 1	LVT	V	D	D	D	FD	SAT	9'-6"	
121	BREAK ROOM - 2	LVT	V	FD	D	D	FD	SAT	9'-6"	
122	MAINTENANCE	SC	V	FD	D	D	D			
123	STORAGE - 2	SC	V	FD	D	D	D			
124	METER TESTING	SC	V	D	D	D	D			
125	GARAGE	SC	V	CM	CM	СМ	CM			

ABBREVIATIONS

LVT - LUXURY VINYL TILE

 CARPET SEALED CONCRETE

 DRYWALL DRYWALL - PAINTED

- SUSPENDED ACOUSTICAL TILE

- SEALED & PAINTED CONCRETE MASONRY UNITES - EPOXY COATED WATER RESISTANT DRYWALL

FIRE RATED DRYWALL

WINE	WINDOW SCHEDULE - WTP BUILDING								
MARK	MANUFACTURER	TYPE OR MODEL NUMBER	ROUGH OPENING SIZE (VARIFY)						
Α	KAWNEER *	2" x 6" FRAME	3'-0 1/4" x 4'-0 1/4"						
В	KAWNEER	2" x 4" FRAME	3'-0 1/4" x 4'-0 1/4"						
С	KAWNEER	2" x 4" FRAME	4'-0 1/4" x 4'-0 1/4"						


\* OR APPROVED EQUAL

#### WINDOW FRAME NOTES:

- . FRAMES SHALL BE EXTRUDED ALUMINUM, ANODIZED.
- 2. EXTERIOR FRAMES SHALL HAVE THERMAL BREAK. 3. COLOR OF FRAMES SELECTED BY OWNER.
- 4. INTERIOR WINDOWS "B" & "C" SHALL BE U.L. LISTED AS 1.5 FIRE RATED.

#### **GLAZING NOTES:**

- 1. ALL GLAZING WITHIN 36" OF A WALKING SURFACE MUST BE SAFETY
- GLAZING. ALL GLAZING IN SWINGING DOORS MUST BE SAFETY GLAZING.
- ALL SAFETY GLAZING SHALL MEET THE REQUIREMENTS OF CPSC 16 CFR 1201, CATEGORY I OR II AS DETERMINED BY SECTION R 308, KRC, LATEST EDITION.
- GLAZING SHALL BE DOUBLE PANE PPG INSULATING GLASS WITH PLASTIC GRIDS SIMULATING 12 INDIVIDUAL PANES BETWEEN INBOARD & OUTBOARD GLASS. COLOR OF GRIDS SHALL BE SELECTED BY
- OUTBOARD (EXTERIOR) GLASS SHALL BE TINTED. COLOR OF TINT SHALL BE SELECTED BY OWNER.

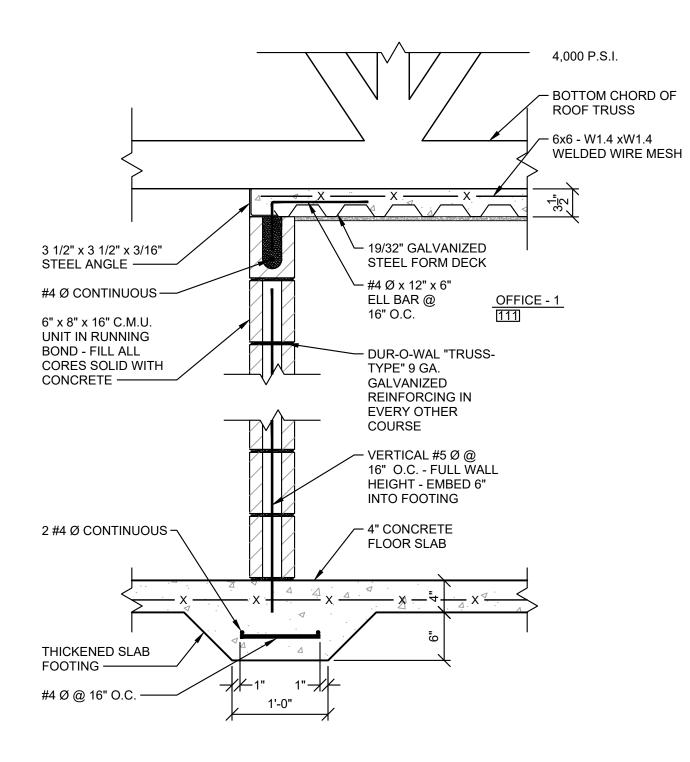



# WHITAKER 2

1860 FRANKFORT ROAD SHELBYVILLE, KENTUCKY 40065 502-633-4981 / 502-633-0377

RECORD DRAWINGS REVISED BY: 07/19/2021 DATE REVISED:

SPECIAL NOTICE

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1100 Glensboro Road

Lawrenceburg, KY 40342

CANN-TECH, LLC


Engineers · Planners · Managers

Phone (502) 859-0907 Fax (502) 859-0668

LCWD 2020 OFFICE BUILDING LARUE COUNTY WATER DISTRICT LARUE COUNTY, KENTUCKY

DOOR, FINISH & WINDOW SCHEDULE

OF

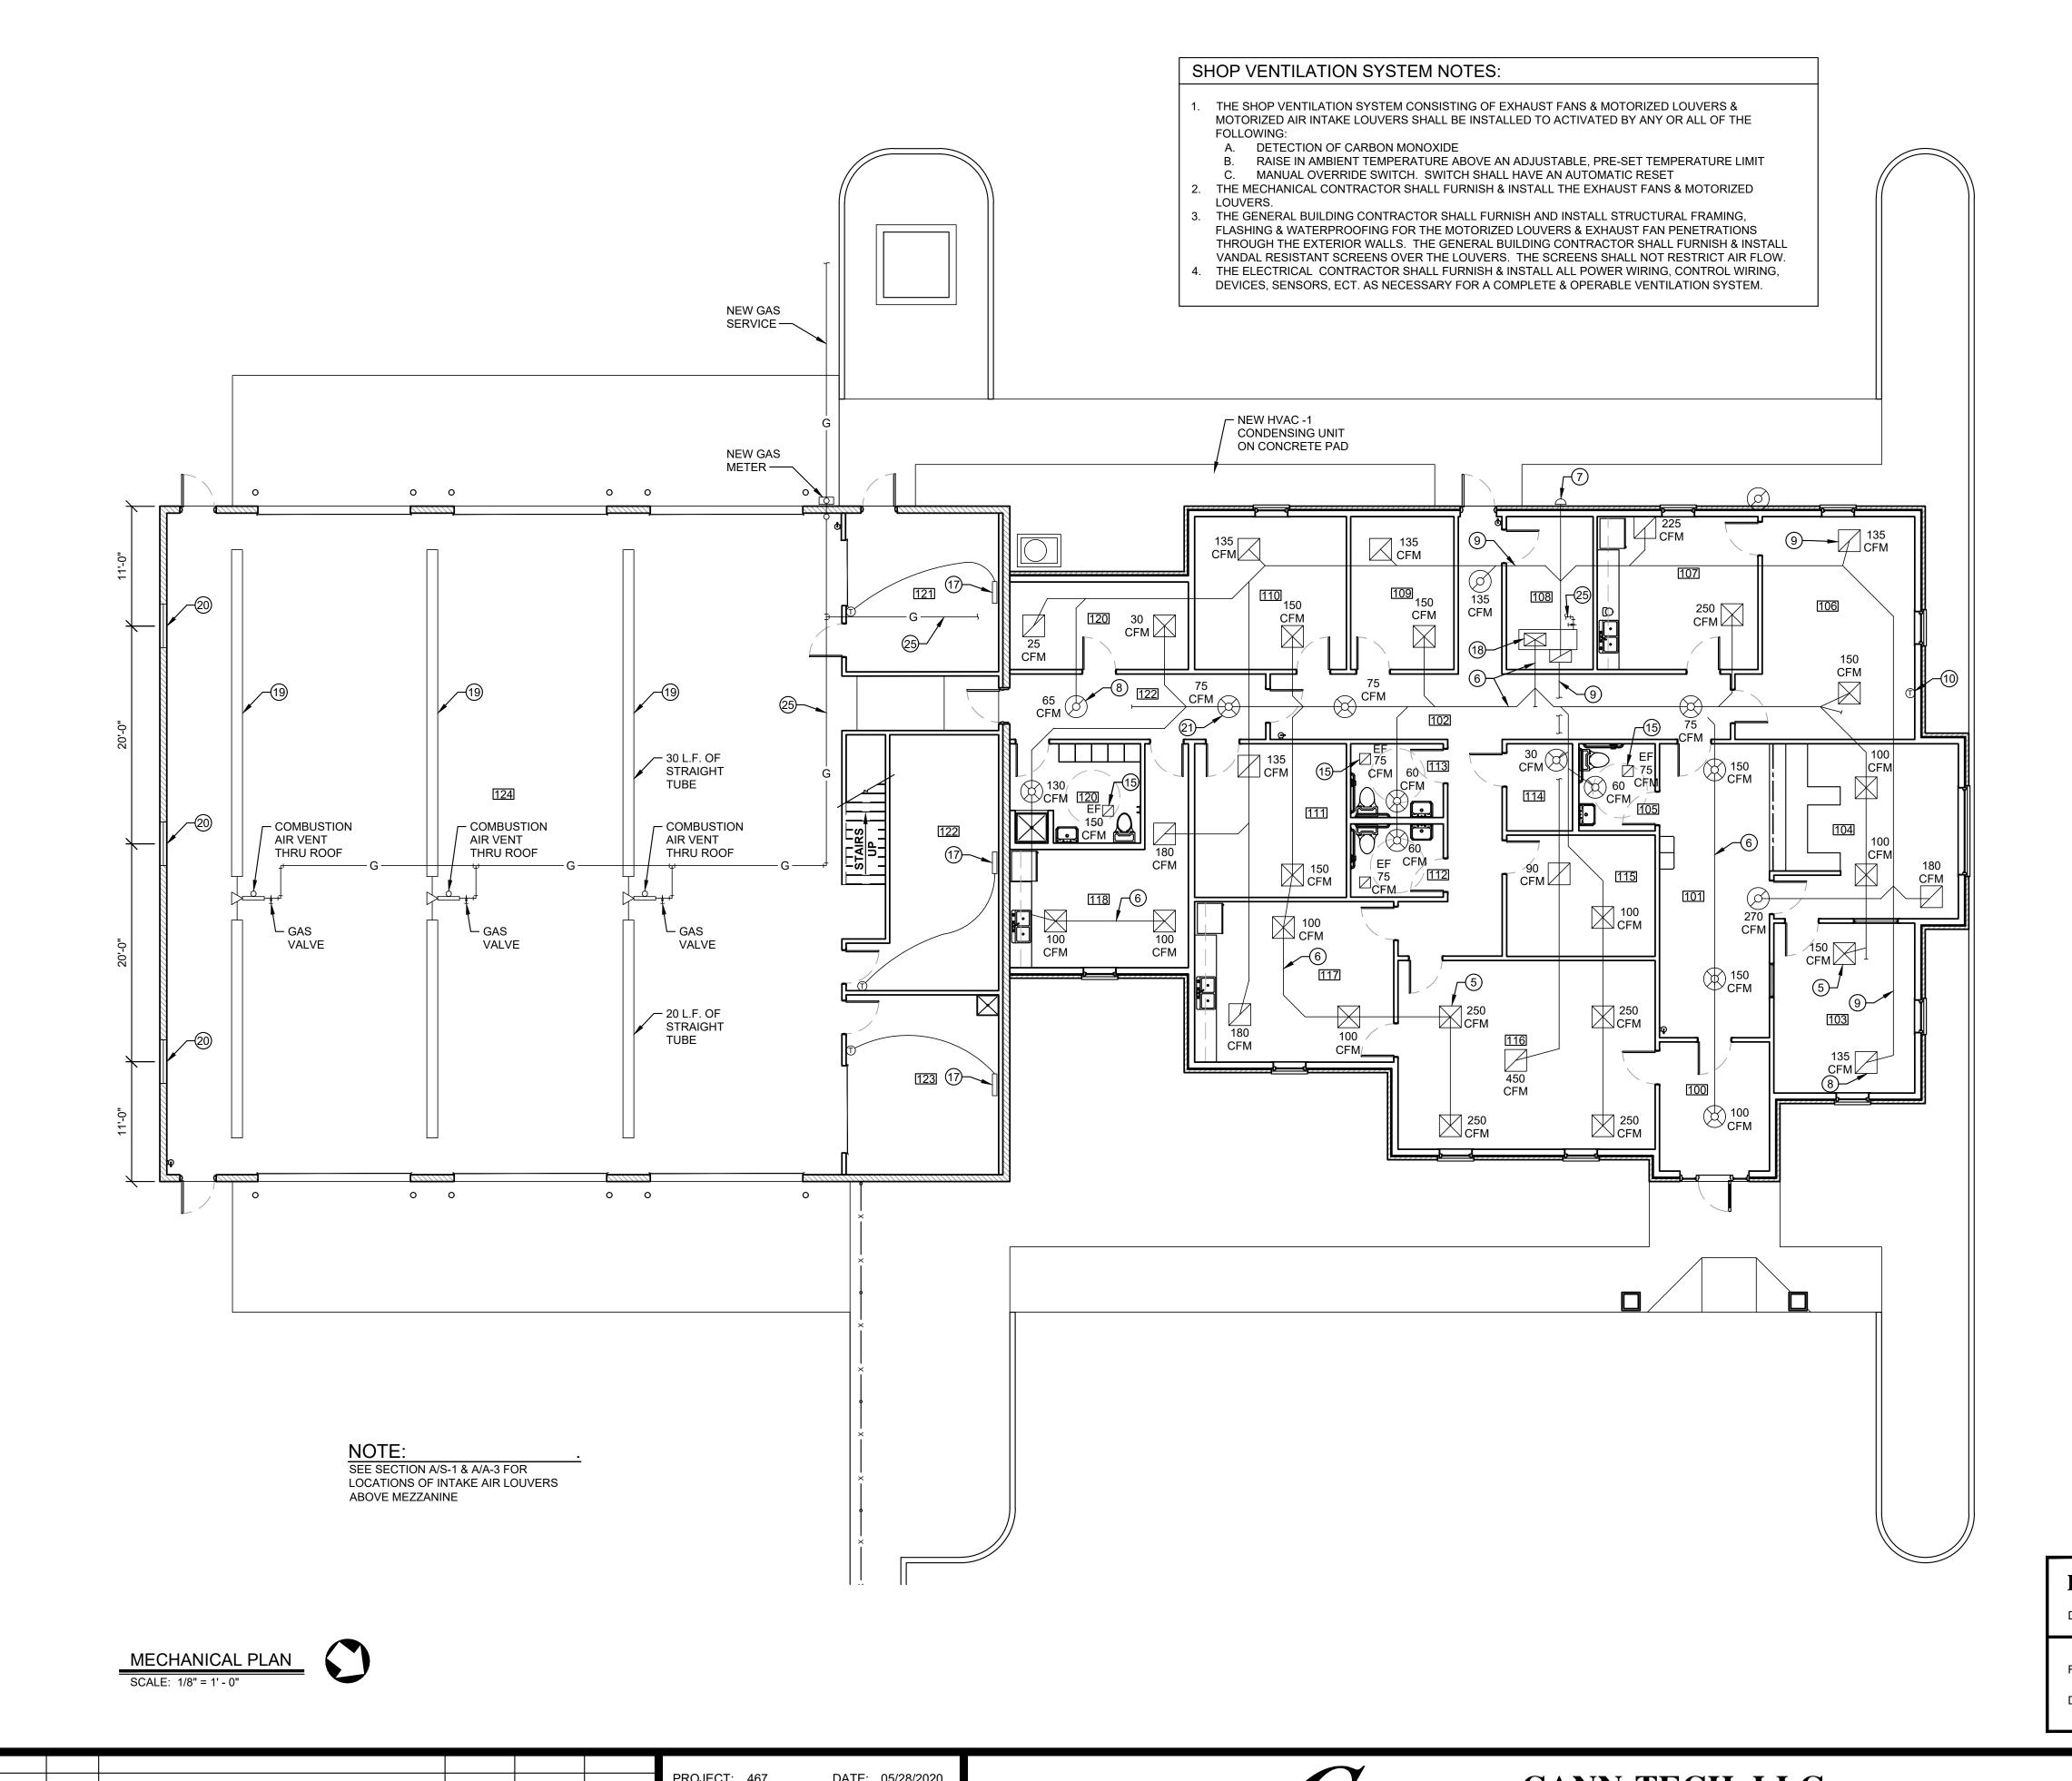

MECHANICAL NOTES:

- 1. THE INSTALLATION OF ALL HEATING, VENTILATING AND AIR CONDITIONING SYSTEMS SHALL BE PERFORMED BY A LICENSED KENTUCKY MASTER
- HEATING, VENTILATING & AIR CONDITIONING (HVAC) CONTRACTOR. 2. SMOKE DETECTORS CAPABLE OF SHUTTING DOWN THE HVAC SYSTEM SHALL BE INSTALLED DOWNSTREAM OF FILTERS AND BEFORE ANY BRANCH CONNECTION IN SUPPLY AIR SYSTEM OF MORE THAN 2,000
- 3. FLEXIBLE DUCTS AND CONNECTORS SHALL COMPLY WITH UL 181 AND ALL DUCT MATERIALS SHALL HAVE A FLAME SPREAD RATE OF 25 OR LESS AND A SMOKED DEVELOPED RATING OF 50 OR LESS.
- 4. HVAC CONTRACTOR SHALL SUBMIT 4 COPIES OF SHOP DRAWINGS TO WHITAKER 2 SHOWING DETAILS OF CONSTRUCTION INSTALLATION OF ALL HVAC SYSTEMS. THESE DRAWINGS SHALL SHOW COMPLIANCE WITH INTERNATIONAL MECHANICAL CODE 205 & KENTUCKY BUILDING CODE,
- 5. CEILING MOUNTED SUPPLY AIR DIFFUSER.
- 6. SUPPLY AIR DUCT. 7. OUTSIDE AIR INTAKE LOUVER WITH MANUALLY ADJUSTABLE DAMPER.
- 8. CEILING MOUNTED RETURN AIR GRILLE.
- RETURN AIR DUCT. 10. THERMOSTAT.
- 11. HVAC CONTRACTOR SHALL INSTALL PRIMARY AND SECONDARY CONDENSATE COLLECTION & DISPOSAL SYSTEM @ EACH AIR HANDLER PER INTERNATIONAL MECHANICAL CODE.
- 12. CONNECT ALL DUCTS TO AIR HANDLERS WITH FLEXIBLE CONNECTORS TO REDUCE VIBRATIONS & NOISE.
- 13. INSTALL INSULATION ON EXTERIOR OF ALL SUPPLY & RETURN DUCTS.
- 14. ALL SUPPLY & RETURN AIR DIFFUSERS SHALL BE EQUIPPED WITH ADJUSTABLE DAMPERS TO FACILITATE AIR BALANCE.
- 15. TOILET EXHAUST FAN. DUCT THRU ROOF VIA GALVANIZED STEEL DUCT & TERMINATE WITH RAIN CAP & INSECT SCREEN.
- 16. LIGHTING FIXTURE SHOWN AS REFERENCE POINT.
- 17. 2,000 WATT ELECTRIC UNIT HEATER WITH REMOTE THERMOSTAT. 18. SPLIT SYSTEM ELECTRIC COOLING/GAS HEAT HVAC SYSTEM WITH
  - FOLLOWING MINIMUM SPECIFICATIONS: 148,000 BTUH COOLING CAPACITY
  - 240,000 BTUH HEATING CAPACITY
- 80% AFUE 19. ROBERTS - GORDON, OR APPROVED EQUAL, VANTAGE RADIANT HEATER WITH 20' & 30' TUBES. VENT HEATER THROUGH ROOF VIA GALVANIZED
- DUCT WITH RAIN CAP & FLASHING. 20. GARAGE VENTILATION EXHAUST FANS SHALL BE INDUSTRIAL AIR, OR APPROVED EQUAL, 033 DIRECT DRIVE PANEL VENTURI FANS PROVIDING
- 3,193 CFM @ 870 RPM 1/2 HP MOTOR. 21. INSTALL U.L. LISTED 1.5 HOUR RATED FIRED DAMPERS WHEREVER DUCTS
- PENETRATE 1 HOUR FIRE RESISTIVE RATED CEILINGS. DO NOT INSTALL ADJUSTABLE DAMPERS IN DUCTS WITH FIRE DAMPERS.
- 22. DIFFUSERS & GRILLES IN SUSPENDED ACOUSTICAL TILE CEILINGS SHALL BE SQUARE. 23. DIFFUSERS & GRILLES IN DRYWALL CEILINGS SHALL BE ROUND.
- 24. COORDINATE LOCATIONS OF DIFFUSERS, GRILLES & EXHAUST FANS WITH LOCATIONS OF LIGHTING FIXTURES.
- 25. INSTALL GAS PIPING FROM NEW GAS METER TO RADIANT HEATERS IN GARAGE & GAS BURNERS IN HVAC AIR HANDLER IN MECHANICAL ROOM
- 26. INSTALL ADJUSTABLE AIR DAMPERS AT ALL SUPPLY DIFFUSERS AND RETURN AIR GRILLS THAT ARE NOT FIRE RATED TO FACILITATE AIR

ROOM#	ROOM NAME	# PEOPLE	SUPPLY	RETURN	EXHUAST	OUTSIDE AIR 🛪
100	VESTIBULE		100			10
101	CORRIDOR - 1		300	270		20
102	CORRIDOR - 2		150	135		10
103	OFFICE MANAGER	2	150	135		10
104	RECEPITIONIST	3	200	180		15
105	PUBLIC RR		60		75	5
106	MANAGER	2	150	135		10
107	CONFERENCE	4	250	225		20
108	MECHANICAL		20			5
109	I.T. ROOM		150	135		15
110	OFFICE - 2	2	150	135		10
111	OFFICE - 1	2	150	135		10
112	MEN		60		75	5
113	WOMEN		60		75	5
114	SUPPLIES		30			5
115	PLAN FILE	2	100	90		10
116	MEETING	10	500	450		25
117	BREAK - 1	4	200	180		20
118	CORRIDOR - 3		75	65		5
119	STORAGE -1		30	25		5
120	RESTROOM - 1		130		150	10
121	BREAK - 2	4	200	180		20
		0.5	0045	0.475	075	252
	TOTALS	35	3215	2475	375	250

### WHITAKER 2

1860 FRANKFORT ROAD SHELBYVILLE, KENTUCKY 40065 502-633-4981 / 502-633-0377

RECORD DRAWINGS REVISED BY: DATE REVISED: 07/19/2021

SPECIAL NOTICE

CONTRACTORS, SUBCONTRACTORS, AND MATERIAL SUPPLIERS MUST VERIFY ALL DIMENSIONS AND CONDITIONS PRIOR TO BEGINNING ANY WORK. REPORT ANY DISCREPANCIES IMMEDIATELY TO

KENTUCKY BUILDING CODE 2018, INTERNATIONAL MECHANICAL CODE 2015, INTERNATIONAL, CONSERVATION CODE 2012, INTERNATIONAL FIRE CODE 2015, KENTUCKY PLUMBING CODE 2013 & NATIONAL ELECTRICAL CODE 2017.

SCALE: AS NOTED  SCALE: AS NOTED  DESIGNED BY: RSW DRAWN BY: JH		
SCALE: AS NOTED  SCALE: AS NOTED  DESIGNED BY: RSW DRAWN BY: JH		
		DATE: 05/28/2020
DRAWN BY: JH		
DRAWN BY: JH		
DRAWN BY: JH		
DRAWN BY: JH		D0/4/
	ļ	
		RSW
NO. DATE REVISIONS DATE APPR'D DATE RECORD DRAWINGS	NO	KOW

1100 Glensboro Road

Lawrenceburg, KY 40342

CANN-TECH, LLC


Engineers · Planners · Managers


Phone (502) 859-0907 Fax (502) 859-0668


LCWD 2020 OFFICE BUILDING LARUE COUNTY WATER DISTRICT LARUE COUNTY, KENTUCKY

SHEET


MECHANICAL FLOOR PLAN

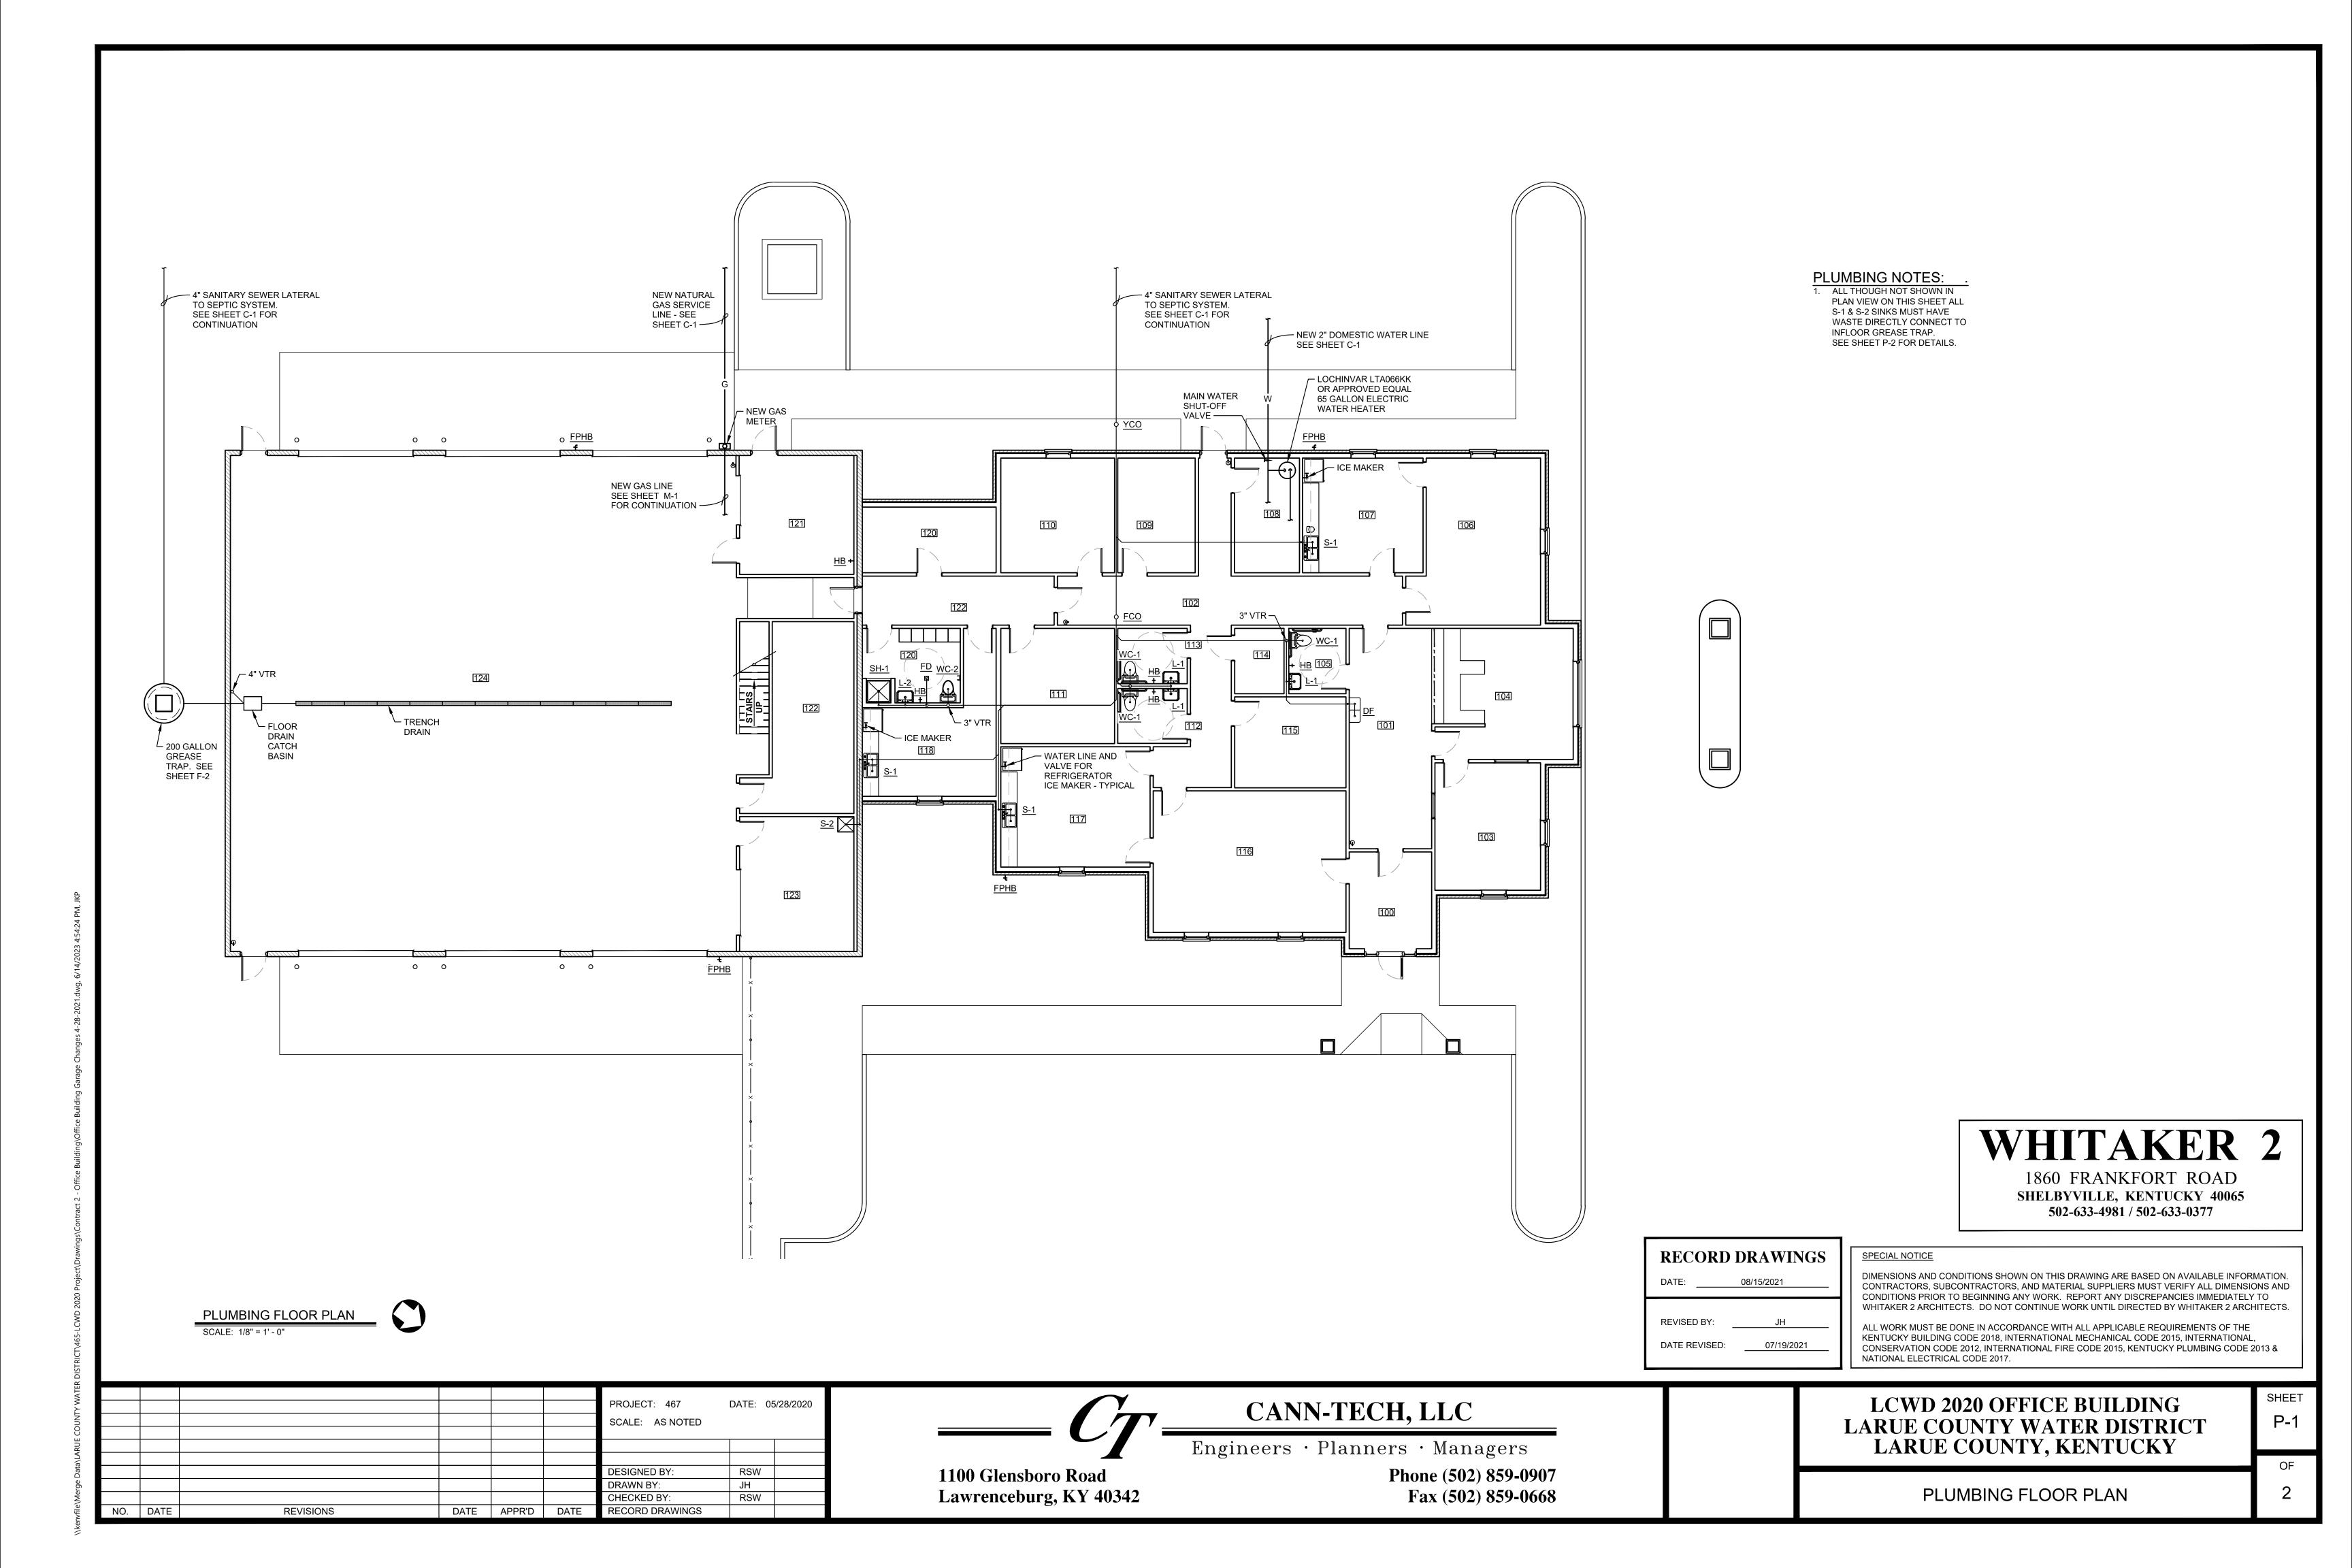

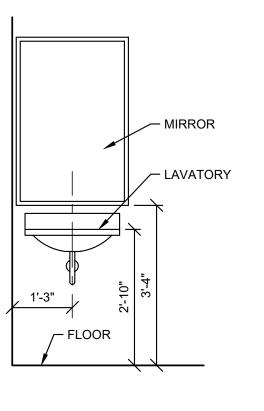


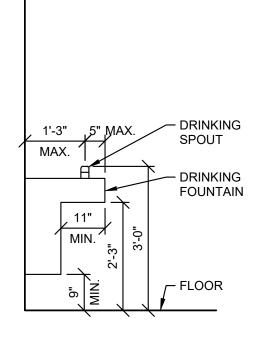


PLUN	IBING FIXTURE PIF	ING SCH	IEDULE		
FIX.		DOMESTIC	C WATER	WASTE	
ABR.	FIXTURE	COLD	HOT	BRANCH	COMMENTS
WC-1	WATERCLOSET	1/2"		3"	ADA COMPLIANT
WC-2	WATERCLOSET	1/2"		3"	
L-1	LAVATORY	1/2"	1/2"	1-1/2"	ADA COMPLIANT
S-1	SINK	1/2"	1/2"	1-1/2"	2 COMPARTMENT
S-2	SINK	1/2"	1/2"	1-1/2"	JANITOR
FD	FLOOR DRAIN			3"	
НВ	HOSE BIBB	1/2"			
FCO	FLOOR CLEAN OUT			4"	
YCO	YARD CLEAN OUT			4"	
WH	WATER HEATER	3/4"	3/4"		65 GAL. ELECTRIC
FPHB	FREEZE PROOF HOSE BIBB	3/4"			
SH	SHOWER	1/2"	1/2"	2"	
DW	DRINKING FOUNTAIN	1/2"		1 - 1 1/2"	ADA COMPLIANT

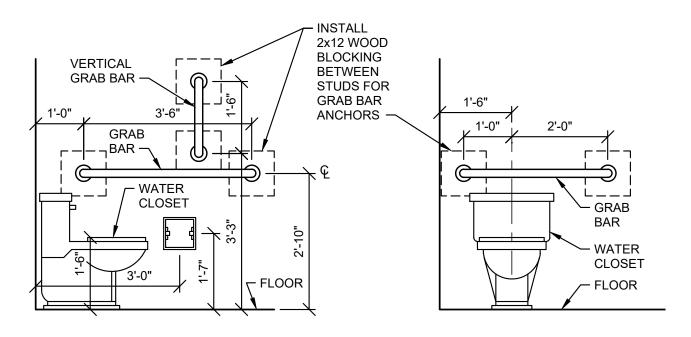

#### ACCESSIBLE PLUMBING FIXTURE DETAILS

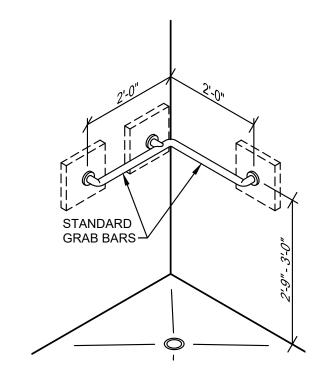


ACCESSIBLE SHOWER STALL
SCALE: N.T.S.

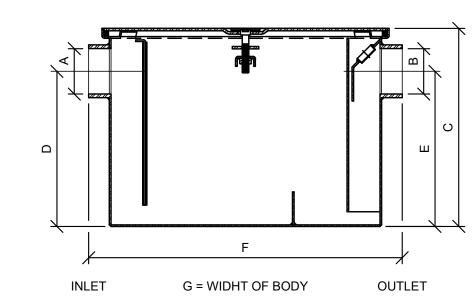

MODEL	A/B INLET/OUTLET NO-HUB	FLOW RATE G.P.M. [L]	CAPACITY GREASE LBS. [kg]	DIMENSION IN INCHES					
NUMBER				С	D/E	F	G		
GT2700 - 7	2 [51]	7 [26]	4 [6]	11 1/8 [283]	8 1/8 [206]	17 1/4 [438]	11 7/8 [302]		

#### ZURN IN-FLOOR GREASE TRAP GT2700 - 7

SCALE: N.T.S.

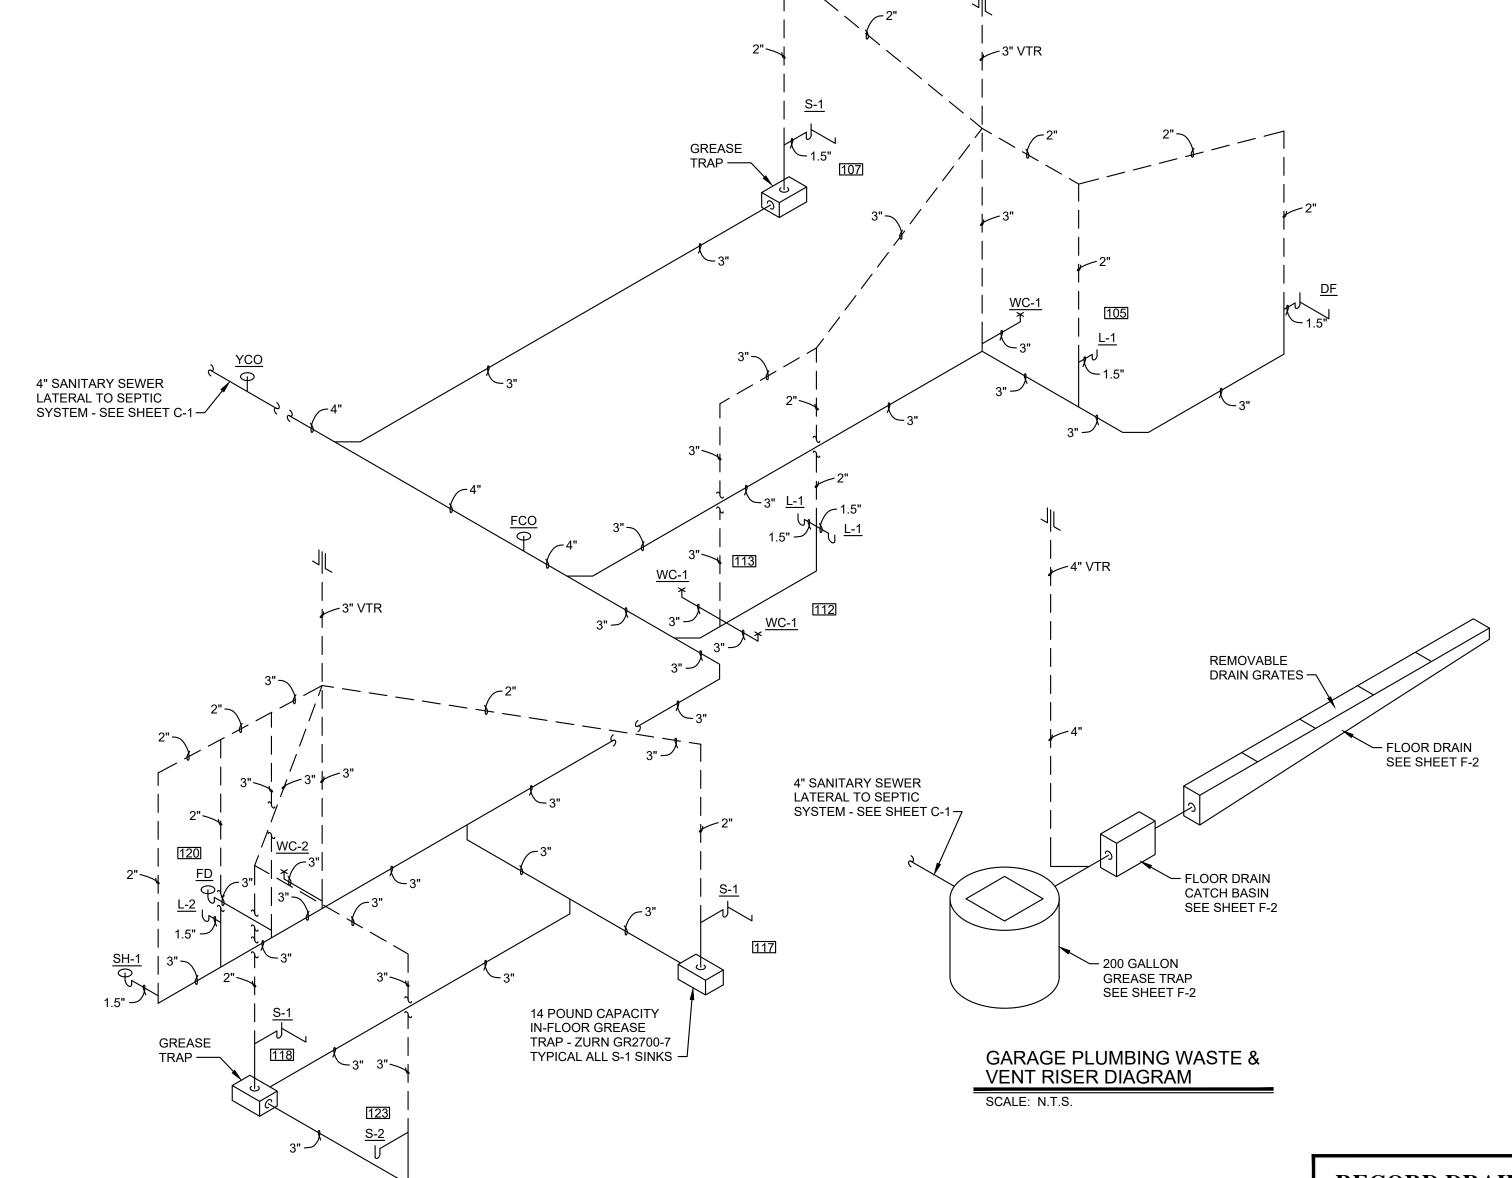

### **RECORD DRAWINGS**

REVISED BY: 07/19/2021 DATE REVISED:

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WHITAKER 2

1860 FRANKFORT ROAD SHELBYVILLE, KENTUCKY 40065

502-633-4981 / 502-633-0377

KENTUCKY BUILDING CODE 2018, INTERNATIONAL MECHANICAL CODE 2015, INTERNATIONAL CONSERVATION CODE 2012, INTERNATIONAL FIRE CODE 2015, KENTUCKY PLUMBING CODE 2013 & NATIONAL ELECTRICAL CODE 2017.

						PROJECT: 467	DATE: (	05/28/2020
						SCALE: AS NOTED		
						DESIGNED BY:	RSW	
						DRAWN BY:	JH	
						CHECKED BY:	RSW	
NO	DATE	REVISIONS	DATE	APPR'D	DATE	RECORD DRAWINGS		



1100 Glensboro Road

Lawrenceburg, KY 40342

PLUMBING WASTE & VENT RISER DIAGRAM


CANN-TECH, LLC

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### LCWD 2020 OFFICE BUILDING LARUE COUNTY WATER DISTRICT LARUE COUNTY, KENTUCKY

PLUMBING FIXTURE DETAILS AND WASTE AND VENT RISER DIAGRAM



Fax (502) 859-0668

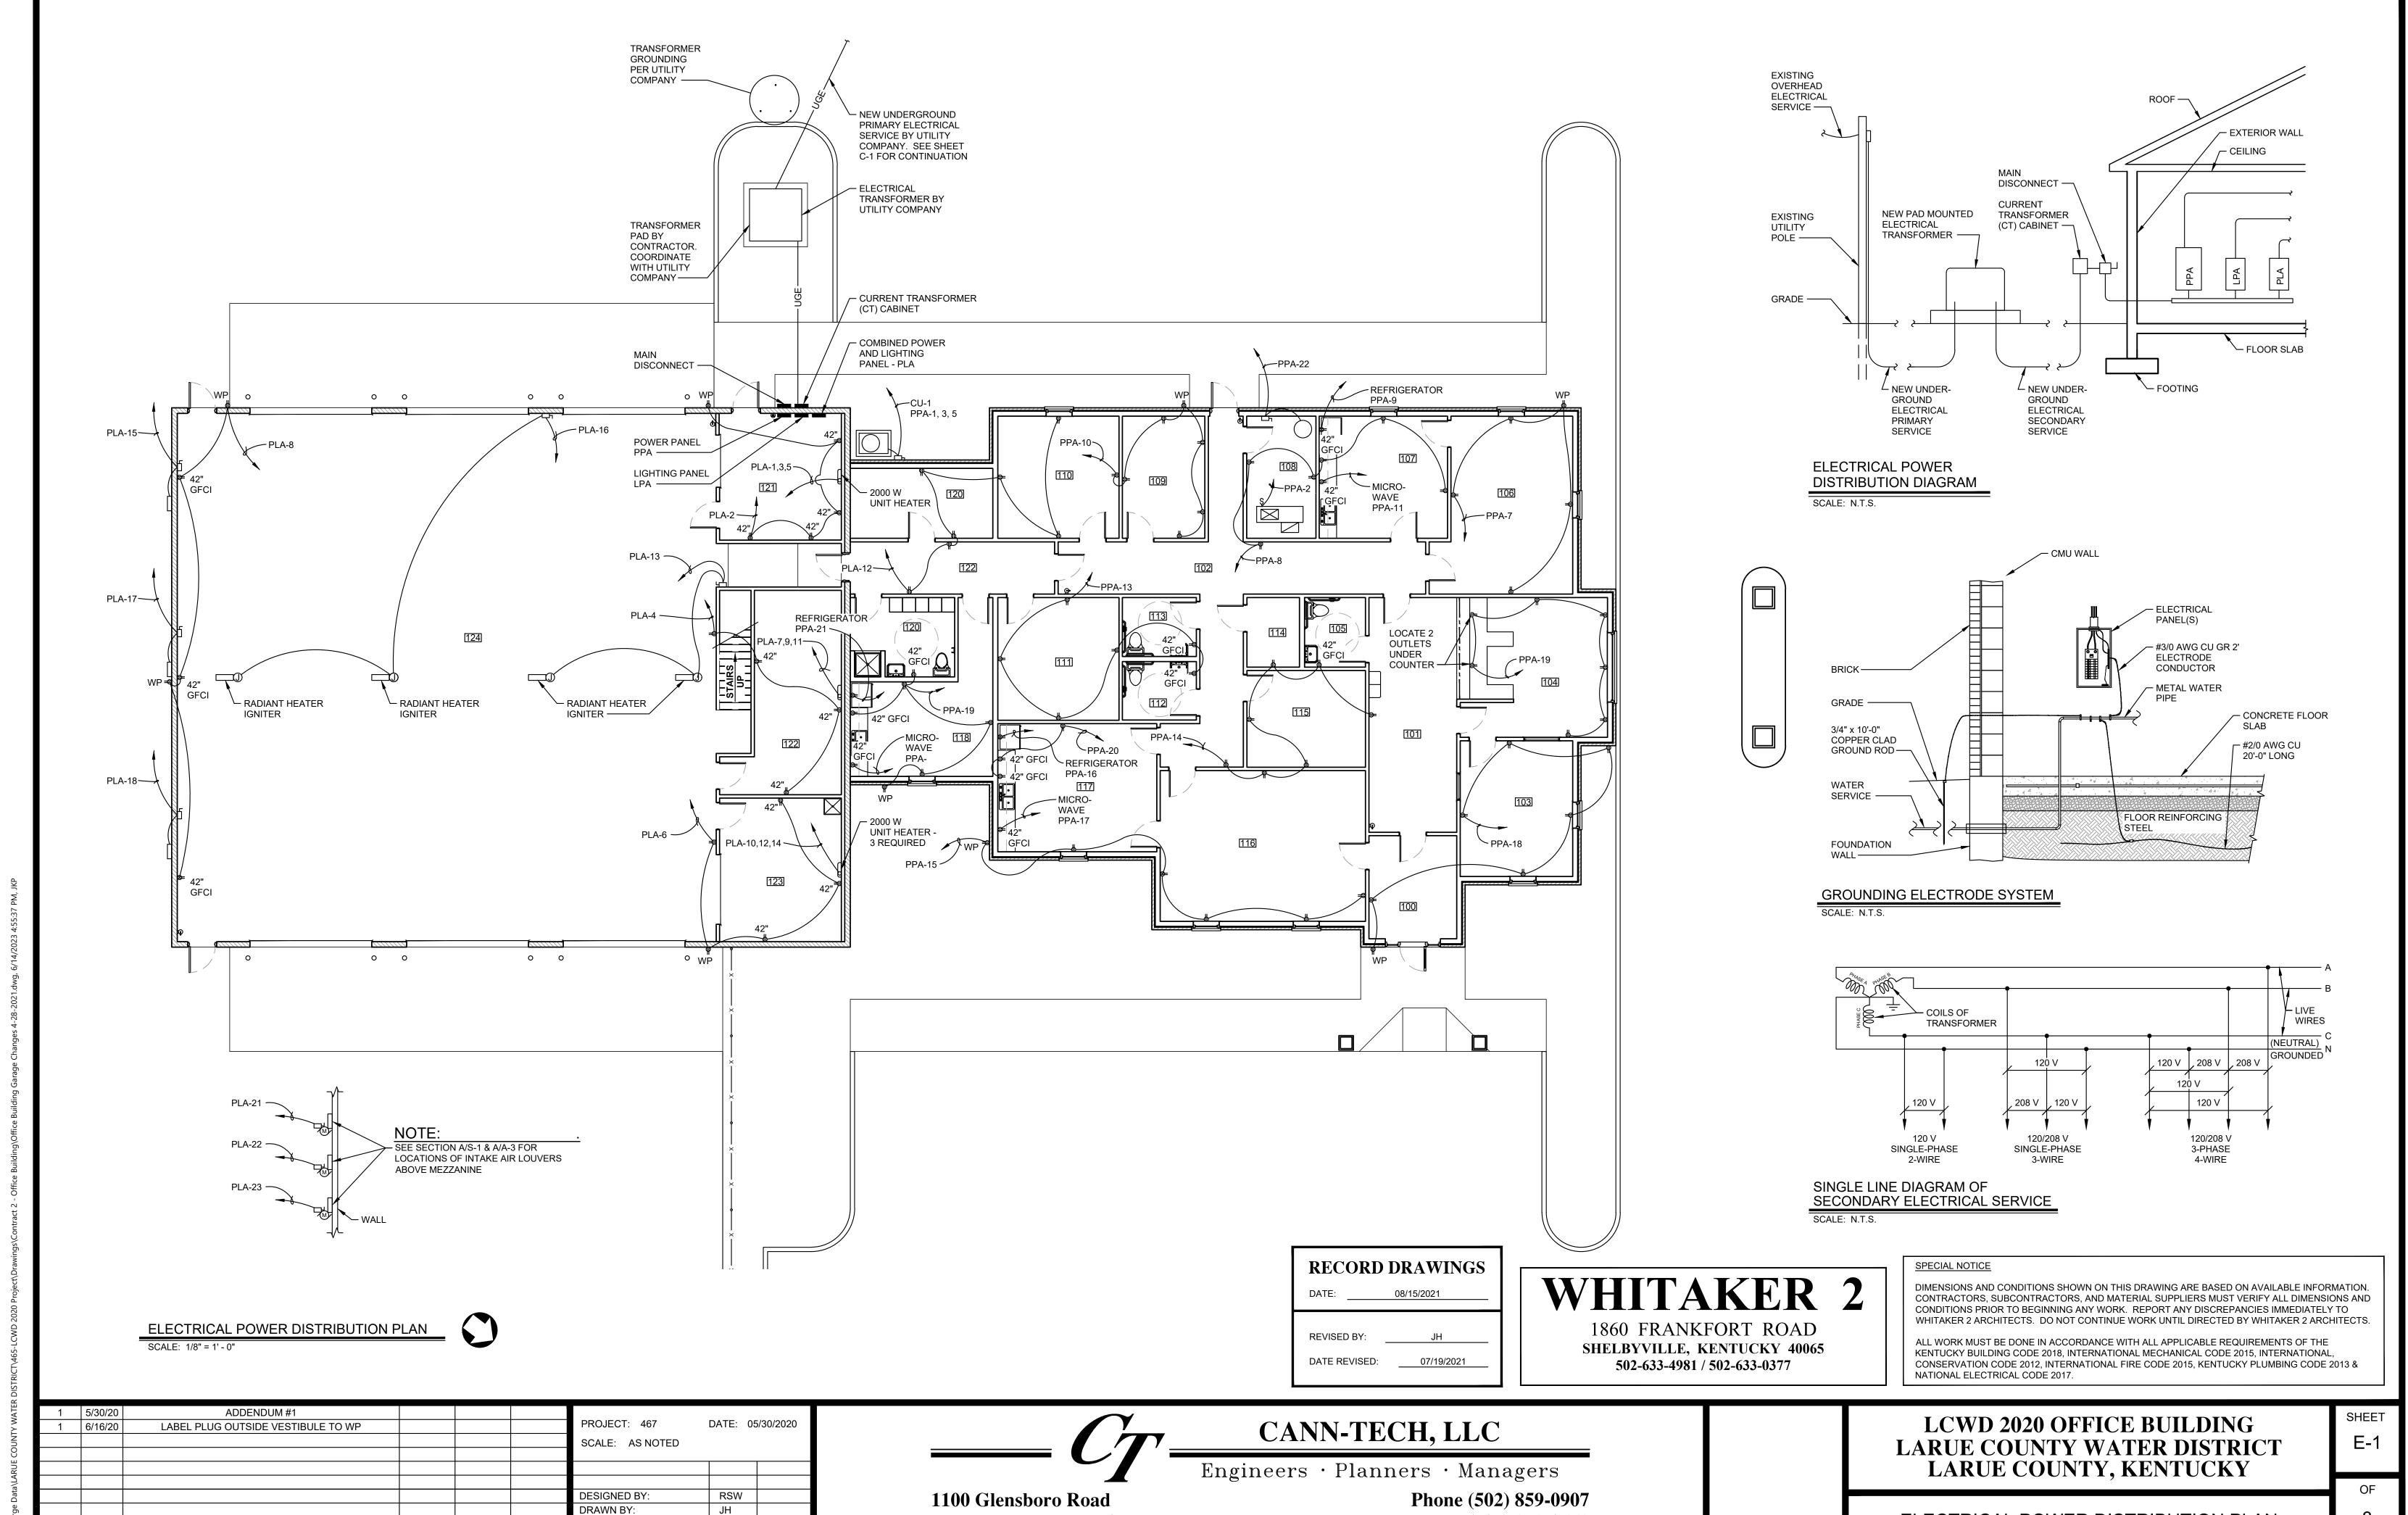Lawrenceburg, KY 40342

CHECKED BY:

DATE APPR'D DATE


RECORD DRAWINGS

RSW

ELECTRICAL POWER DISTRIBUTION PLAN

NO. DATE

REVISIONS

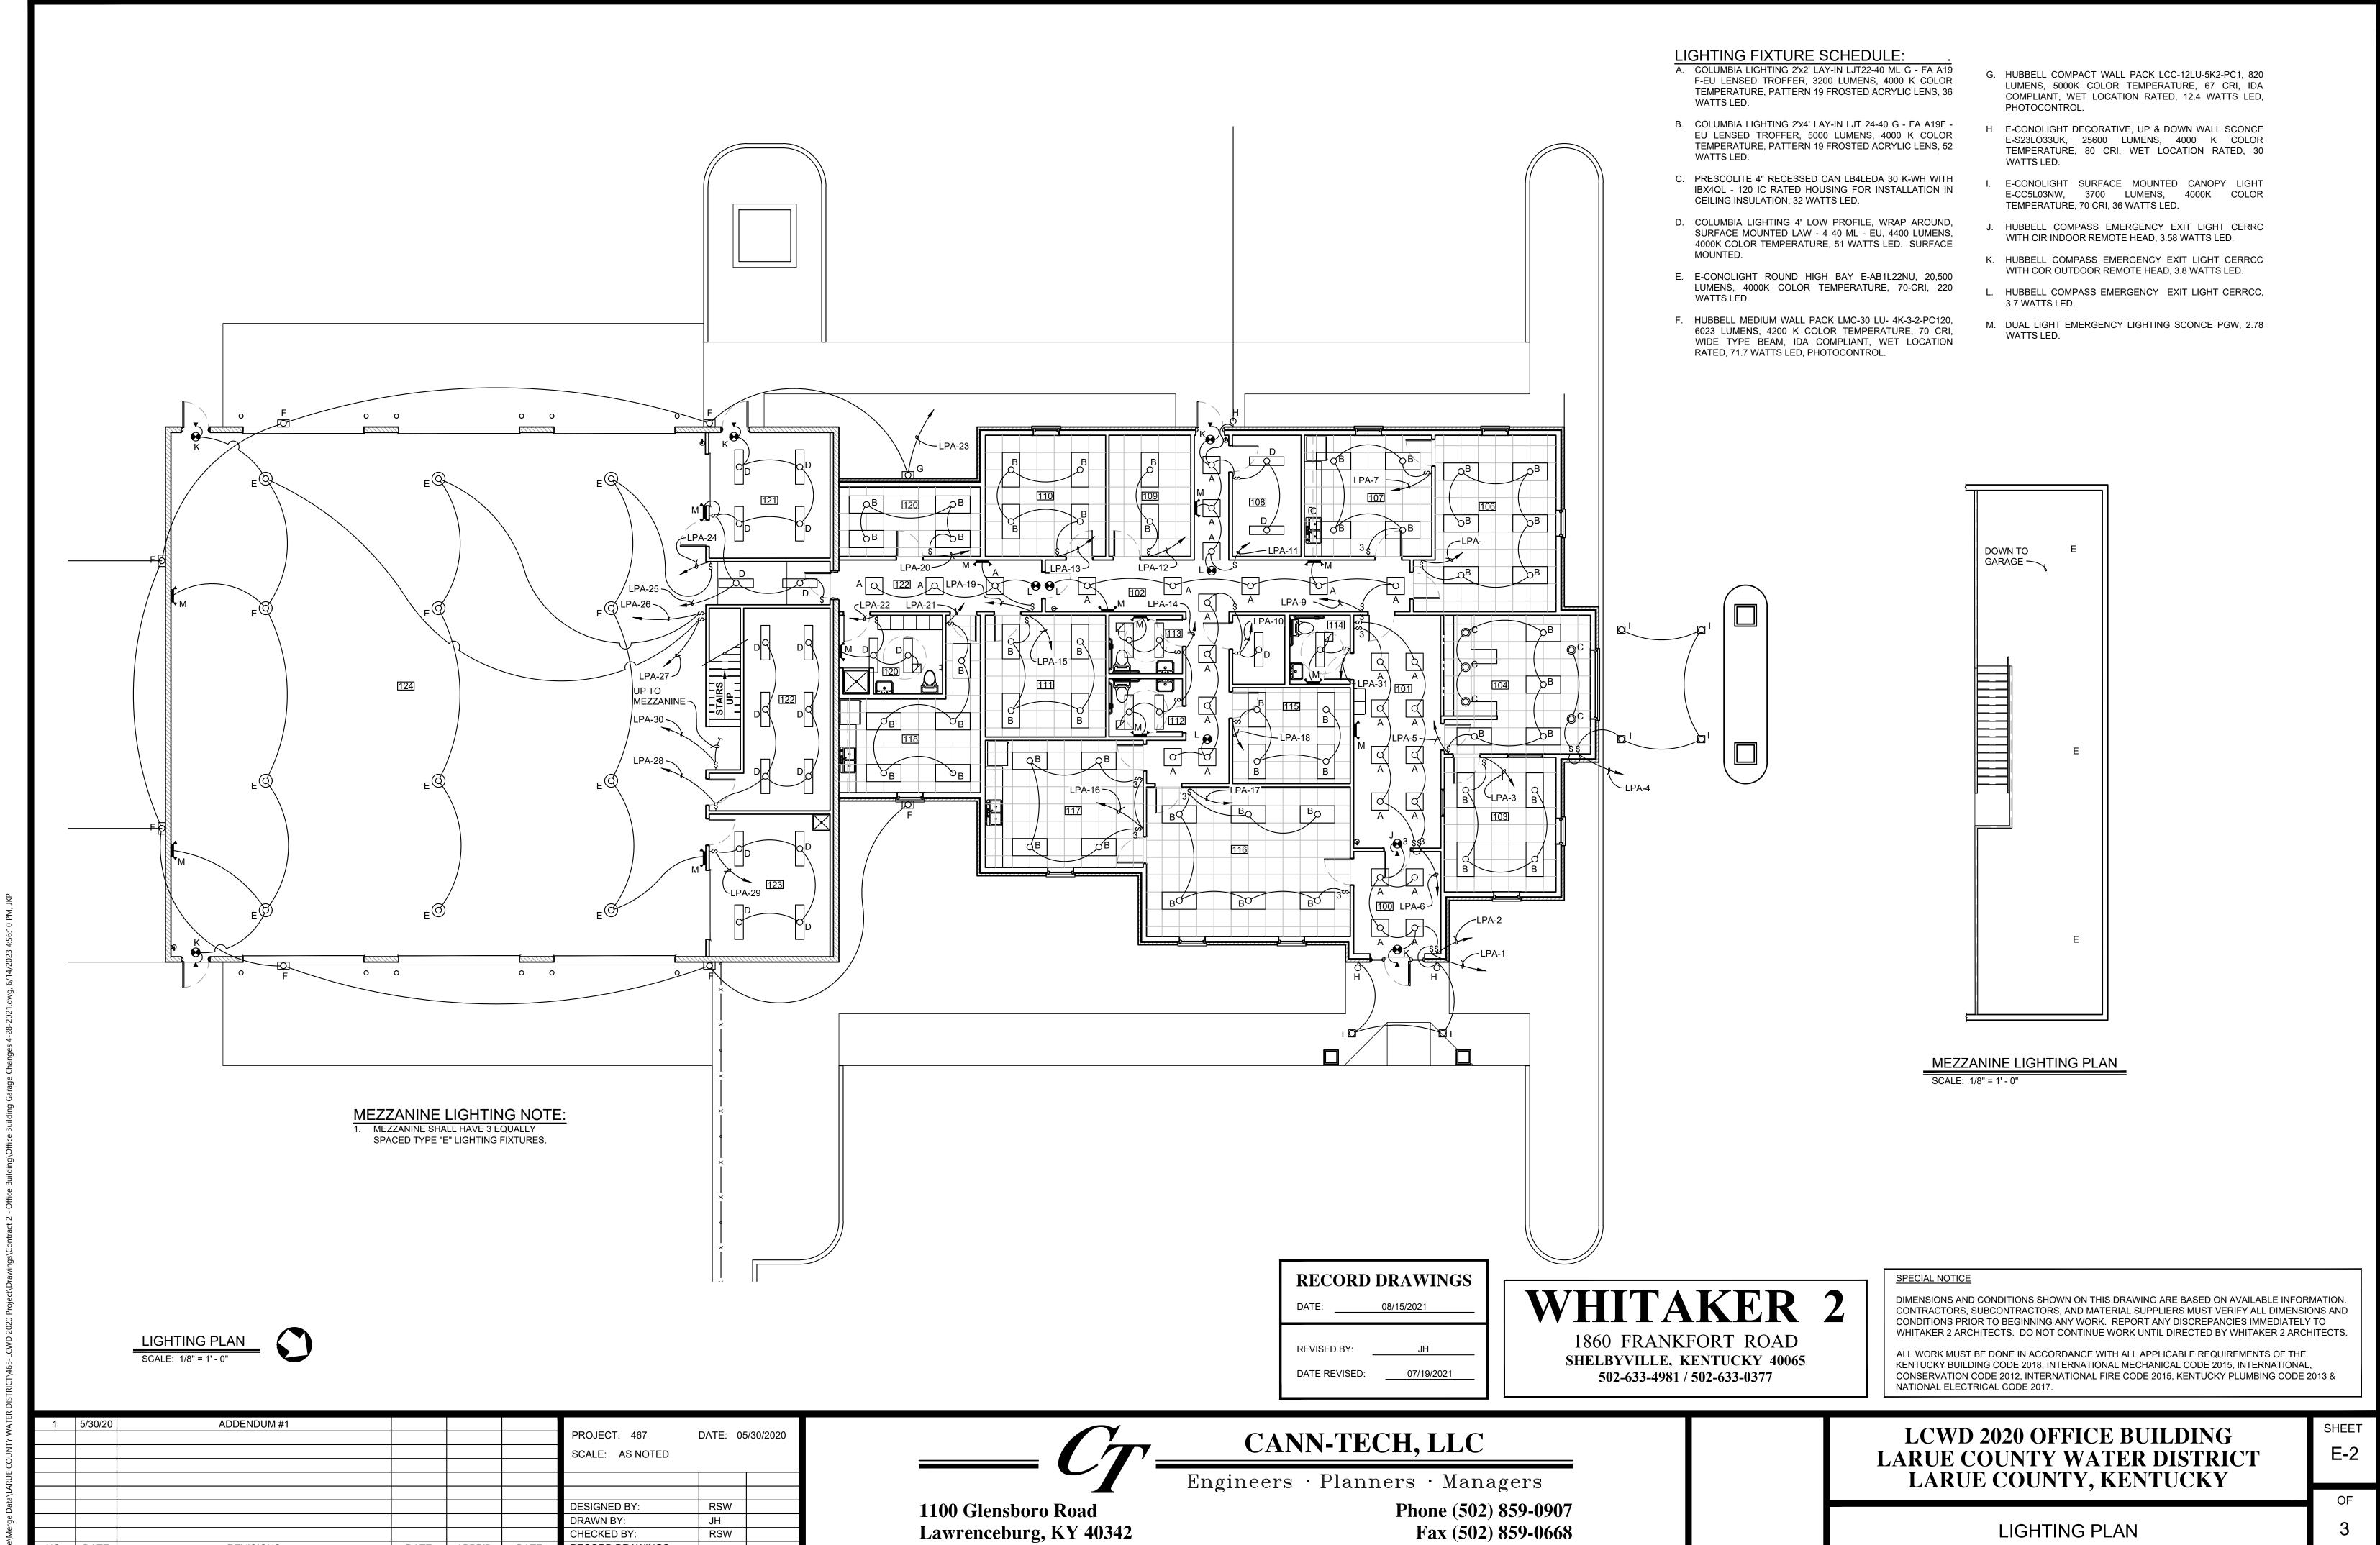

RECORD DRAWINGS

NO. DATE

REVISIONS

Fax (502) 859-0668

VOLTAGE	<u> </u>	0 / 208 WYE	PHASE _	3	WIRE _	4		MAIN CKT B	KR <u>10</u>	00
								1		Т
POLE/	CKT.	CEDVEC	10.74		LOAD		10.44	OEDVEC	CKT.	POLE/
CKT. NO.		SERVES	KVA	A	В	С	KVA	SERVES	TRIP	CKT. NO.
1	15	UNIT HEATER - 1	0.67	1.57	4.00		0.90	RECEPTACLES	20	2
3	15	"	0.67		1.39	4.57	0.72	RECEPTACLES	20	4
5	15		0.67			1.57	0.90	RECEPTACLES	20	6
7	15	UNIT HEATER - 2	0.67	1.39			0.72	RECEPTACLES	20	8
9	15	"	0.67		1.34		0.67	UNIT HEATER - 3	15	10
11	15		0.67			1.34	0.67	"	15	12
13	20	RADIANT HEATERS	1.66	2.03			0.67	"	15	14
15	20	EXHAUST FAN	0.86		2.52		1.66	RAIDANT HEATERS	20	16
17	20	EXHAUST FAN	0.86			1.72	0.86	EXHAUST FAN	20	18
19	20	RECEPTACLES	0.90	1.80			0.90	RECEPTACLES	20	20
21	20	EF LOUVER	0.67		1.34		0.67	EF LOUVER	20	22
23	20	EF LOUVER	0.67			1.67	1.00	SPARE	20	24
25										26
27										28
29										30
31										32
33										34
35										36
37										38
39										40
41										42
				Α	В	С				
		TOTAL KVA:	I	6.79	6.59	6.30		TOTAL PANEL BOARD K	/A:	19.68

PANEL BO	OARD _	LPA (LIGHTING PANEL)						MOUN	ITING <u>SURFA</u>	CE_
VOLTAGE	12	20 / 208 WYE	PHASE _	3	WIRE _	4		MAIN	CKT BKR100	0
POLE/	CKT.				LOAD				СКТ.	POLE/
CKT. NO.	TRIP	SERVES	KVA	A	В	С	KVA	SERVES	TRIP	CKT. NO.
1	20	LIGHTING	0.13	0.21	_		0.08	LIGHTING	20	2
3	20	LIGHTING	0.21		0.40		0.19	LIGHTING	20	4
5	20	LIGHTING	0.31			0.62	0.31	LIGHTING	20	6
7	20	LIGHTING	0.31	0.52			0.21	LIGHTING	20	8
9	20	LIGHTING	0.19		0.37		0.18	LIGHTING	20	10
11	20	LIGHTING	0.22			0.32	0.10	LIGHTING	20	12
13	20	LIGHTING	0.21	0.42			0.21	LIGHTING	20	14
15	20	LIGHTING	0.21		0.42		0.21	LIGHTING	20	16
17	20	LIGHTING	0.31			0.52	0.21	LIGHTING	20	18
19	20	LIGHTING	0.11	0.33			0.21	LIGHTING	20	20
21	20	LIGHTING	0.26		0.36		0.10	LIGHTING	20	22
23	20	LIGHTING	0.51			1.39	0.88	LIGHTING	20	24
25	20	LIGHTING	0.31	1.19			0.88	LIGHTING	20	26
27	20	LIGHTING	0.89		1.09		0.20	LIGHTING	20	28
29	20	LIGHTING	0.31			2.06	0.66	LIGHTING	20	30
31	20	LIGHTING	0.31	1.31			1.00	SPARE	20	32
33	20	SPARE	1.00		2.00		1.00	SPARE	20	34
35	20	SPARE	1.00			2.00	1.00	SPARE	20	36
37										38
39										40
41										42
				А	В	С				
		TOTAL KVA:		4.67	4.64	6.91		TOTAL PANEL BOA	RD KVA: 1	5.53

# WHITAKER 2

1860 FRANKFORT ROAD SHELBYVILLE, KENTUCKY 40065 502-633-4981 / 502-633-0377

# RECORD DRAWINGS

REVISED BY: DATE REVISED:

07/19/2021

SPECIAL NOTICE

DIMENSIONS AND CONDITIONS SHOWN ON THIS DRAWING ARE BASED ON AVAILABLE INFORMATION. CONTRACTORS, SUBCONTRACTORS, AND MATERIAL SUPPLIERS MUST VERIFY ALL DIMENSIONS AND CONDITIONS PRIOR TO BEGINNING ANY WORK. REPORT ANY DISCREPANCIES IMMEDIATELY TO WHITAKER 2 ARCHITECTS. DO NOT CONTINUE WORK UNTIL DIRECTED BY WHITAKER 2 ARCHITECTS.

ALL WORK MUST BE DONE IN ACCORDANCE WITH ALL APPLICABLE REQUIREMENTS OF THE KENTUCKY BUILDING CODE 2018, INTERNATIONAL MECHANICAL CODE 2015, INTERNATIONAL, CONSERVATION CODE 2012, INTERNATIONAL FIRE CODE 2015, KENTUCKY PLUMBING CODE 2013 & NATIONAL ELECTRICAL CODE 2017.

	1	5/30/20	ADDENDUM #1						
							PROJECT: 467	DATE: 05	/30/2020
							SCALE: AS NOTED		
							DESIGNED BY:	RSW	
							DRAWN BY:	JH	
	·						CHECKED BY:	RSW	
1	NO.	DATE	REVISIONS	DATE	APPR'D	DATE	RECORD DRAWINGS		



Lawrenceburg, KY 40342

### CANN-TECH, LLC

Engineers · Planners · Managers

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LCWD 2020 OFFICE BUILDING
LARUE COUNTY WATER DISTRIC
LARUE COUNTY, KENTUCKY

ELECTRICAL PANEL SCHEDULES