





1951 West Park Rd.

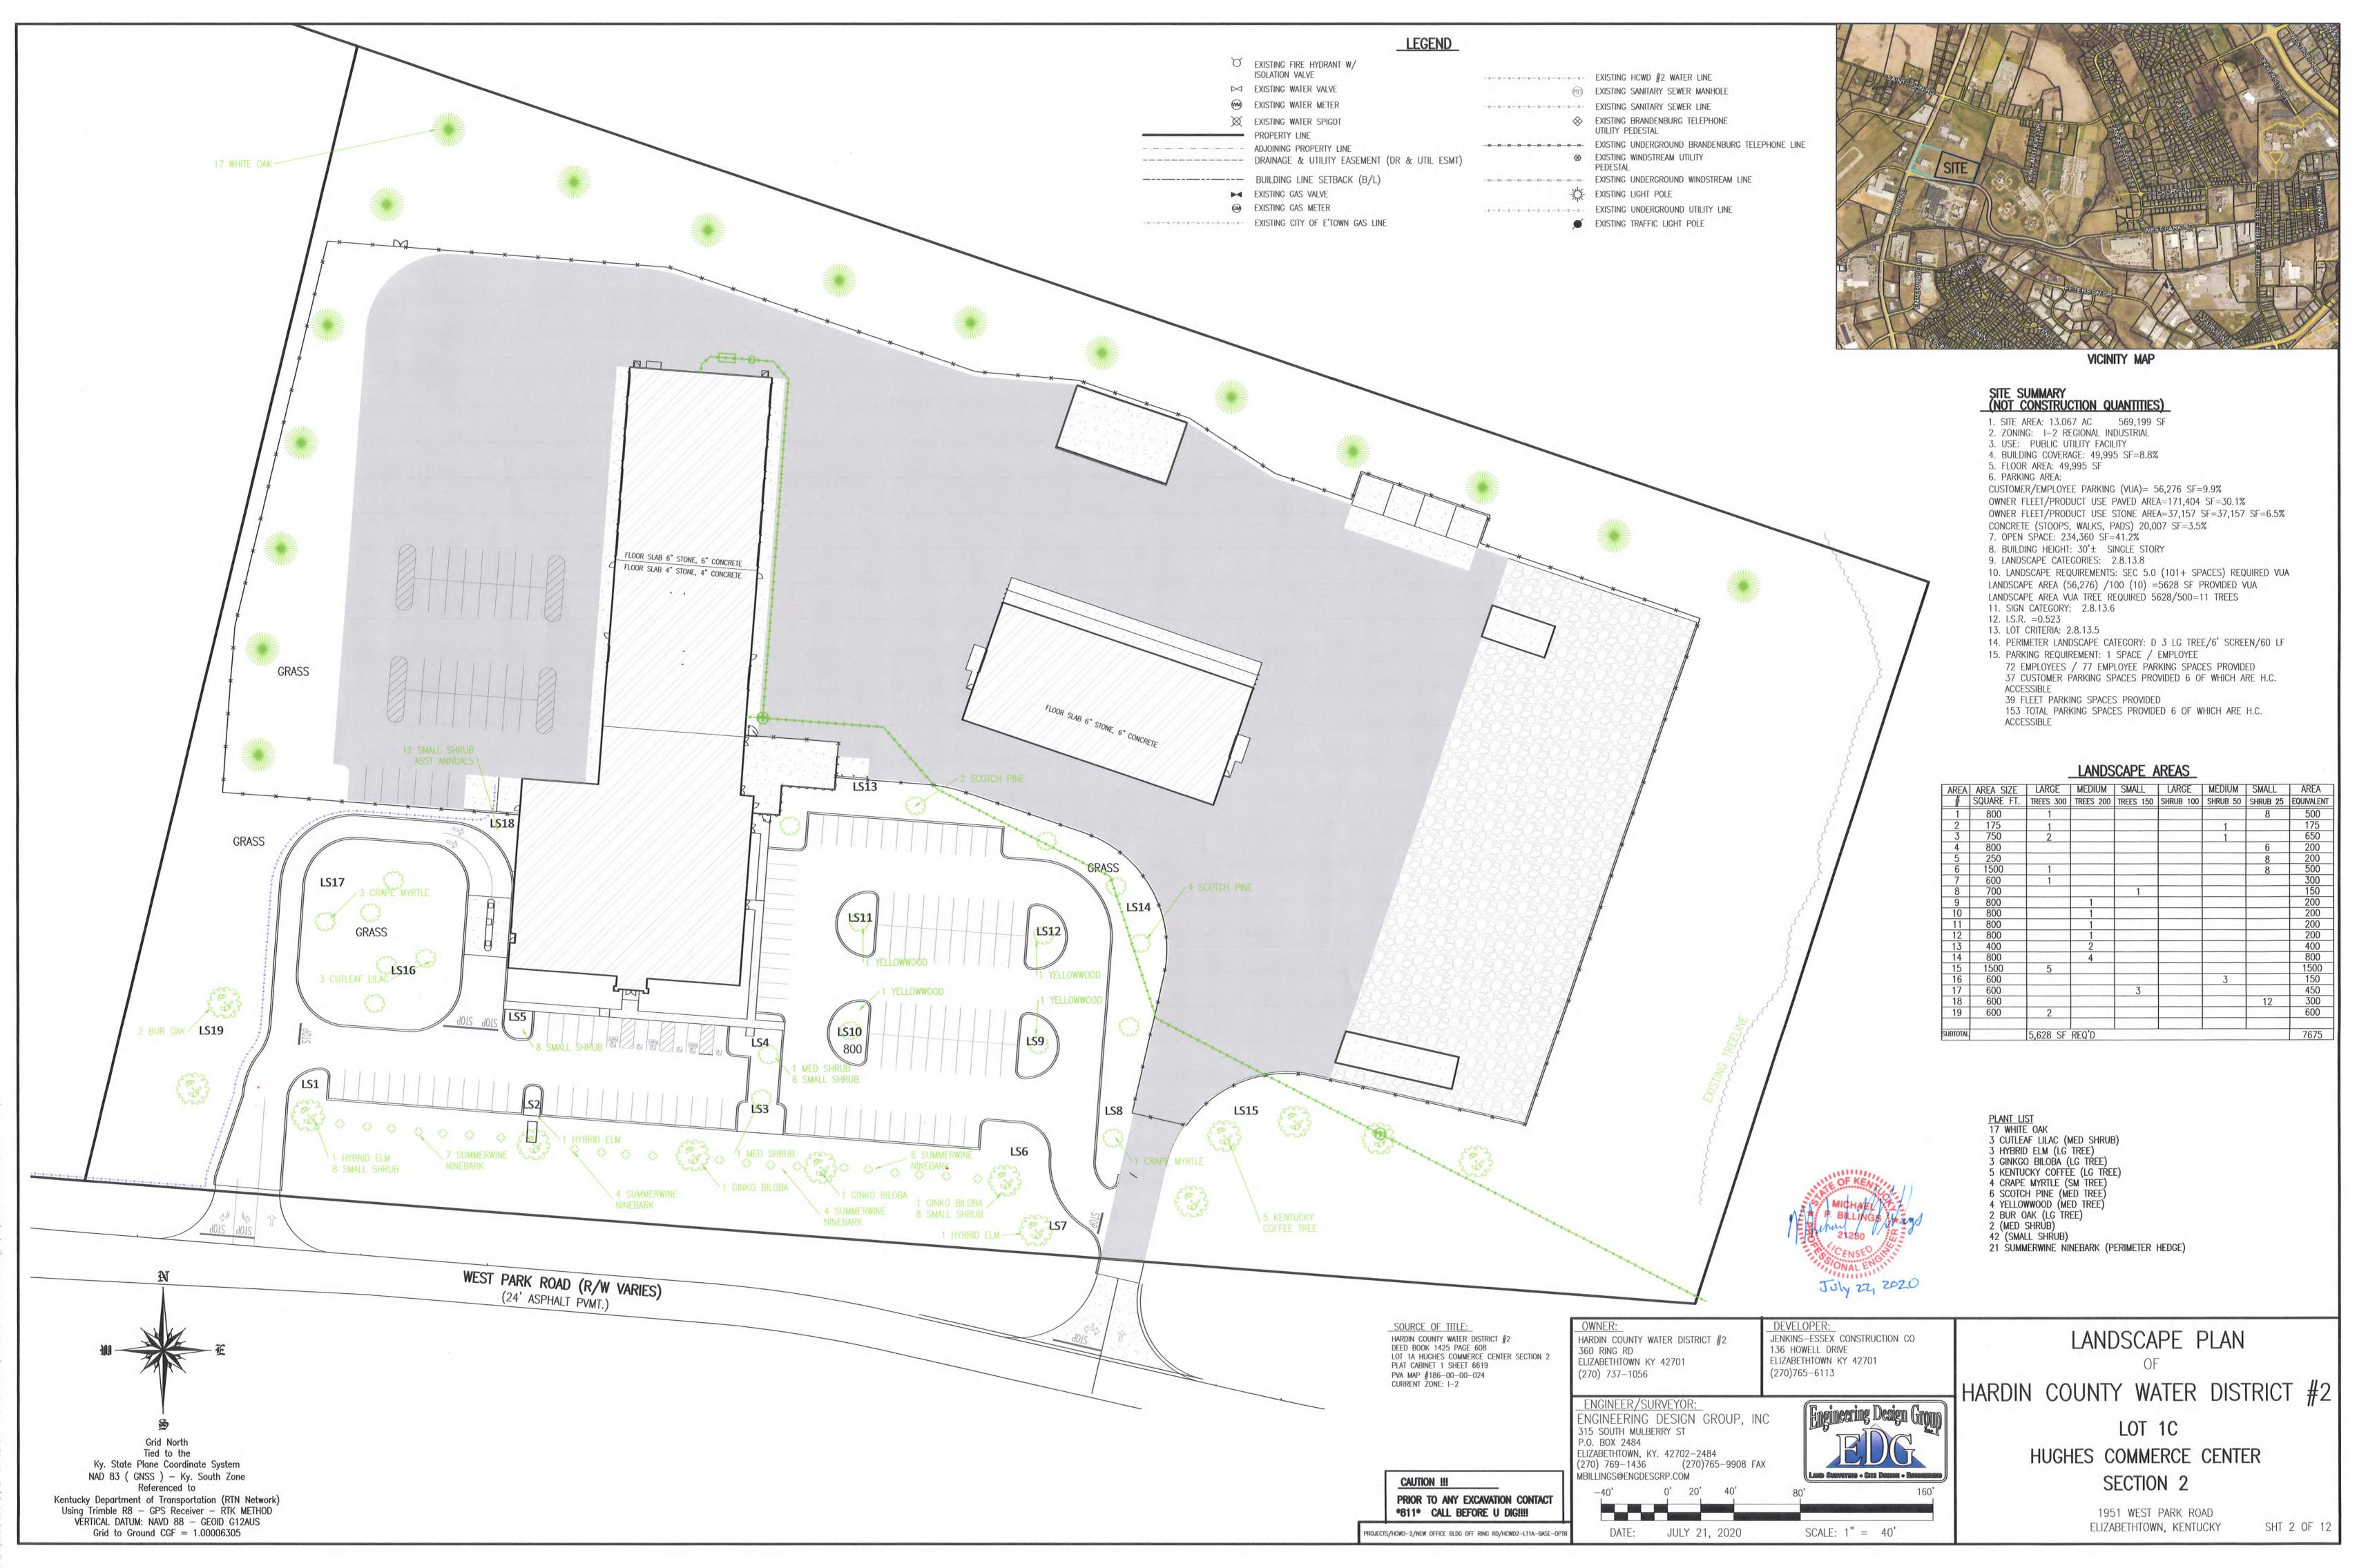

Z. Projects/Howd-2/NEW OFFICE OFF RING ROAD 2015/HCWD2-L-11A-EASE-OPT3.0Wg.

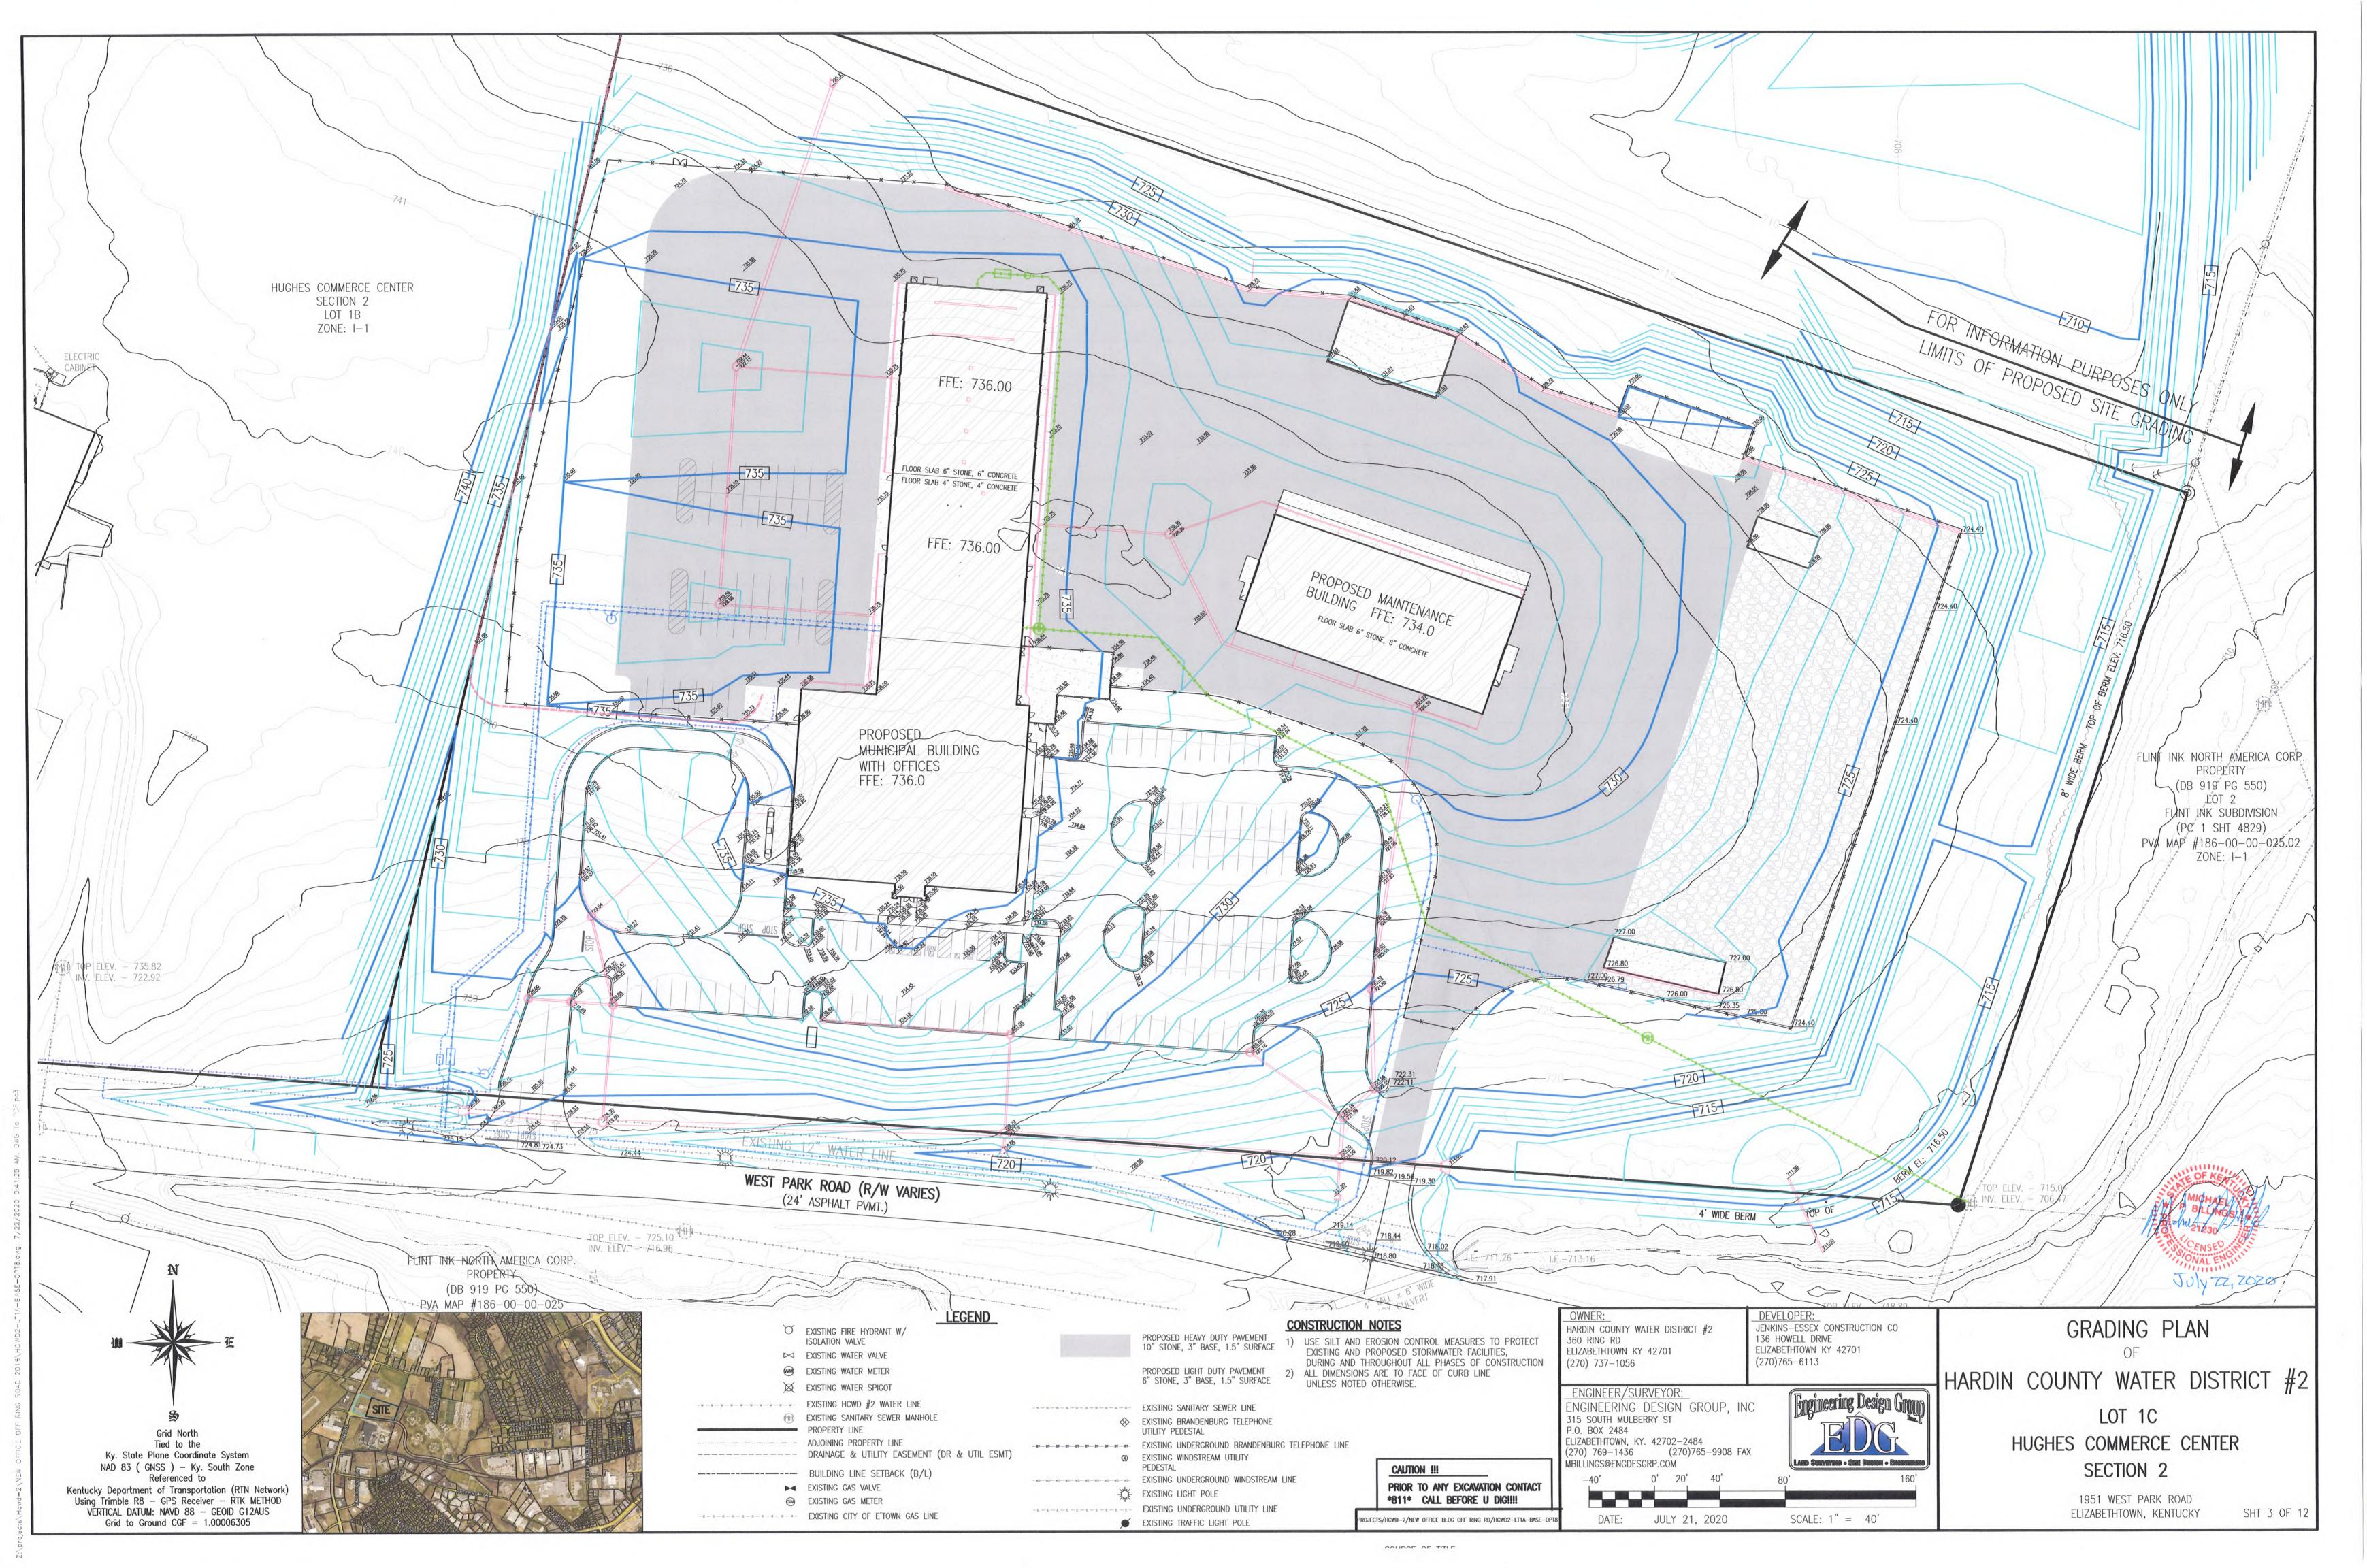


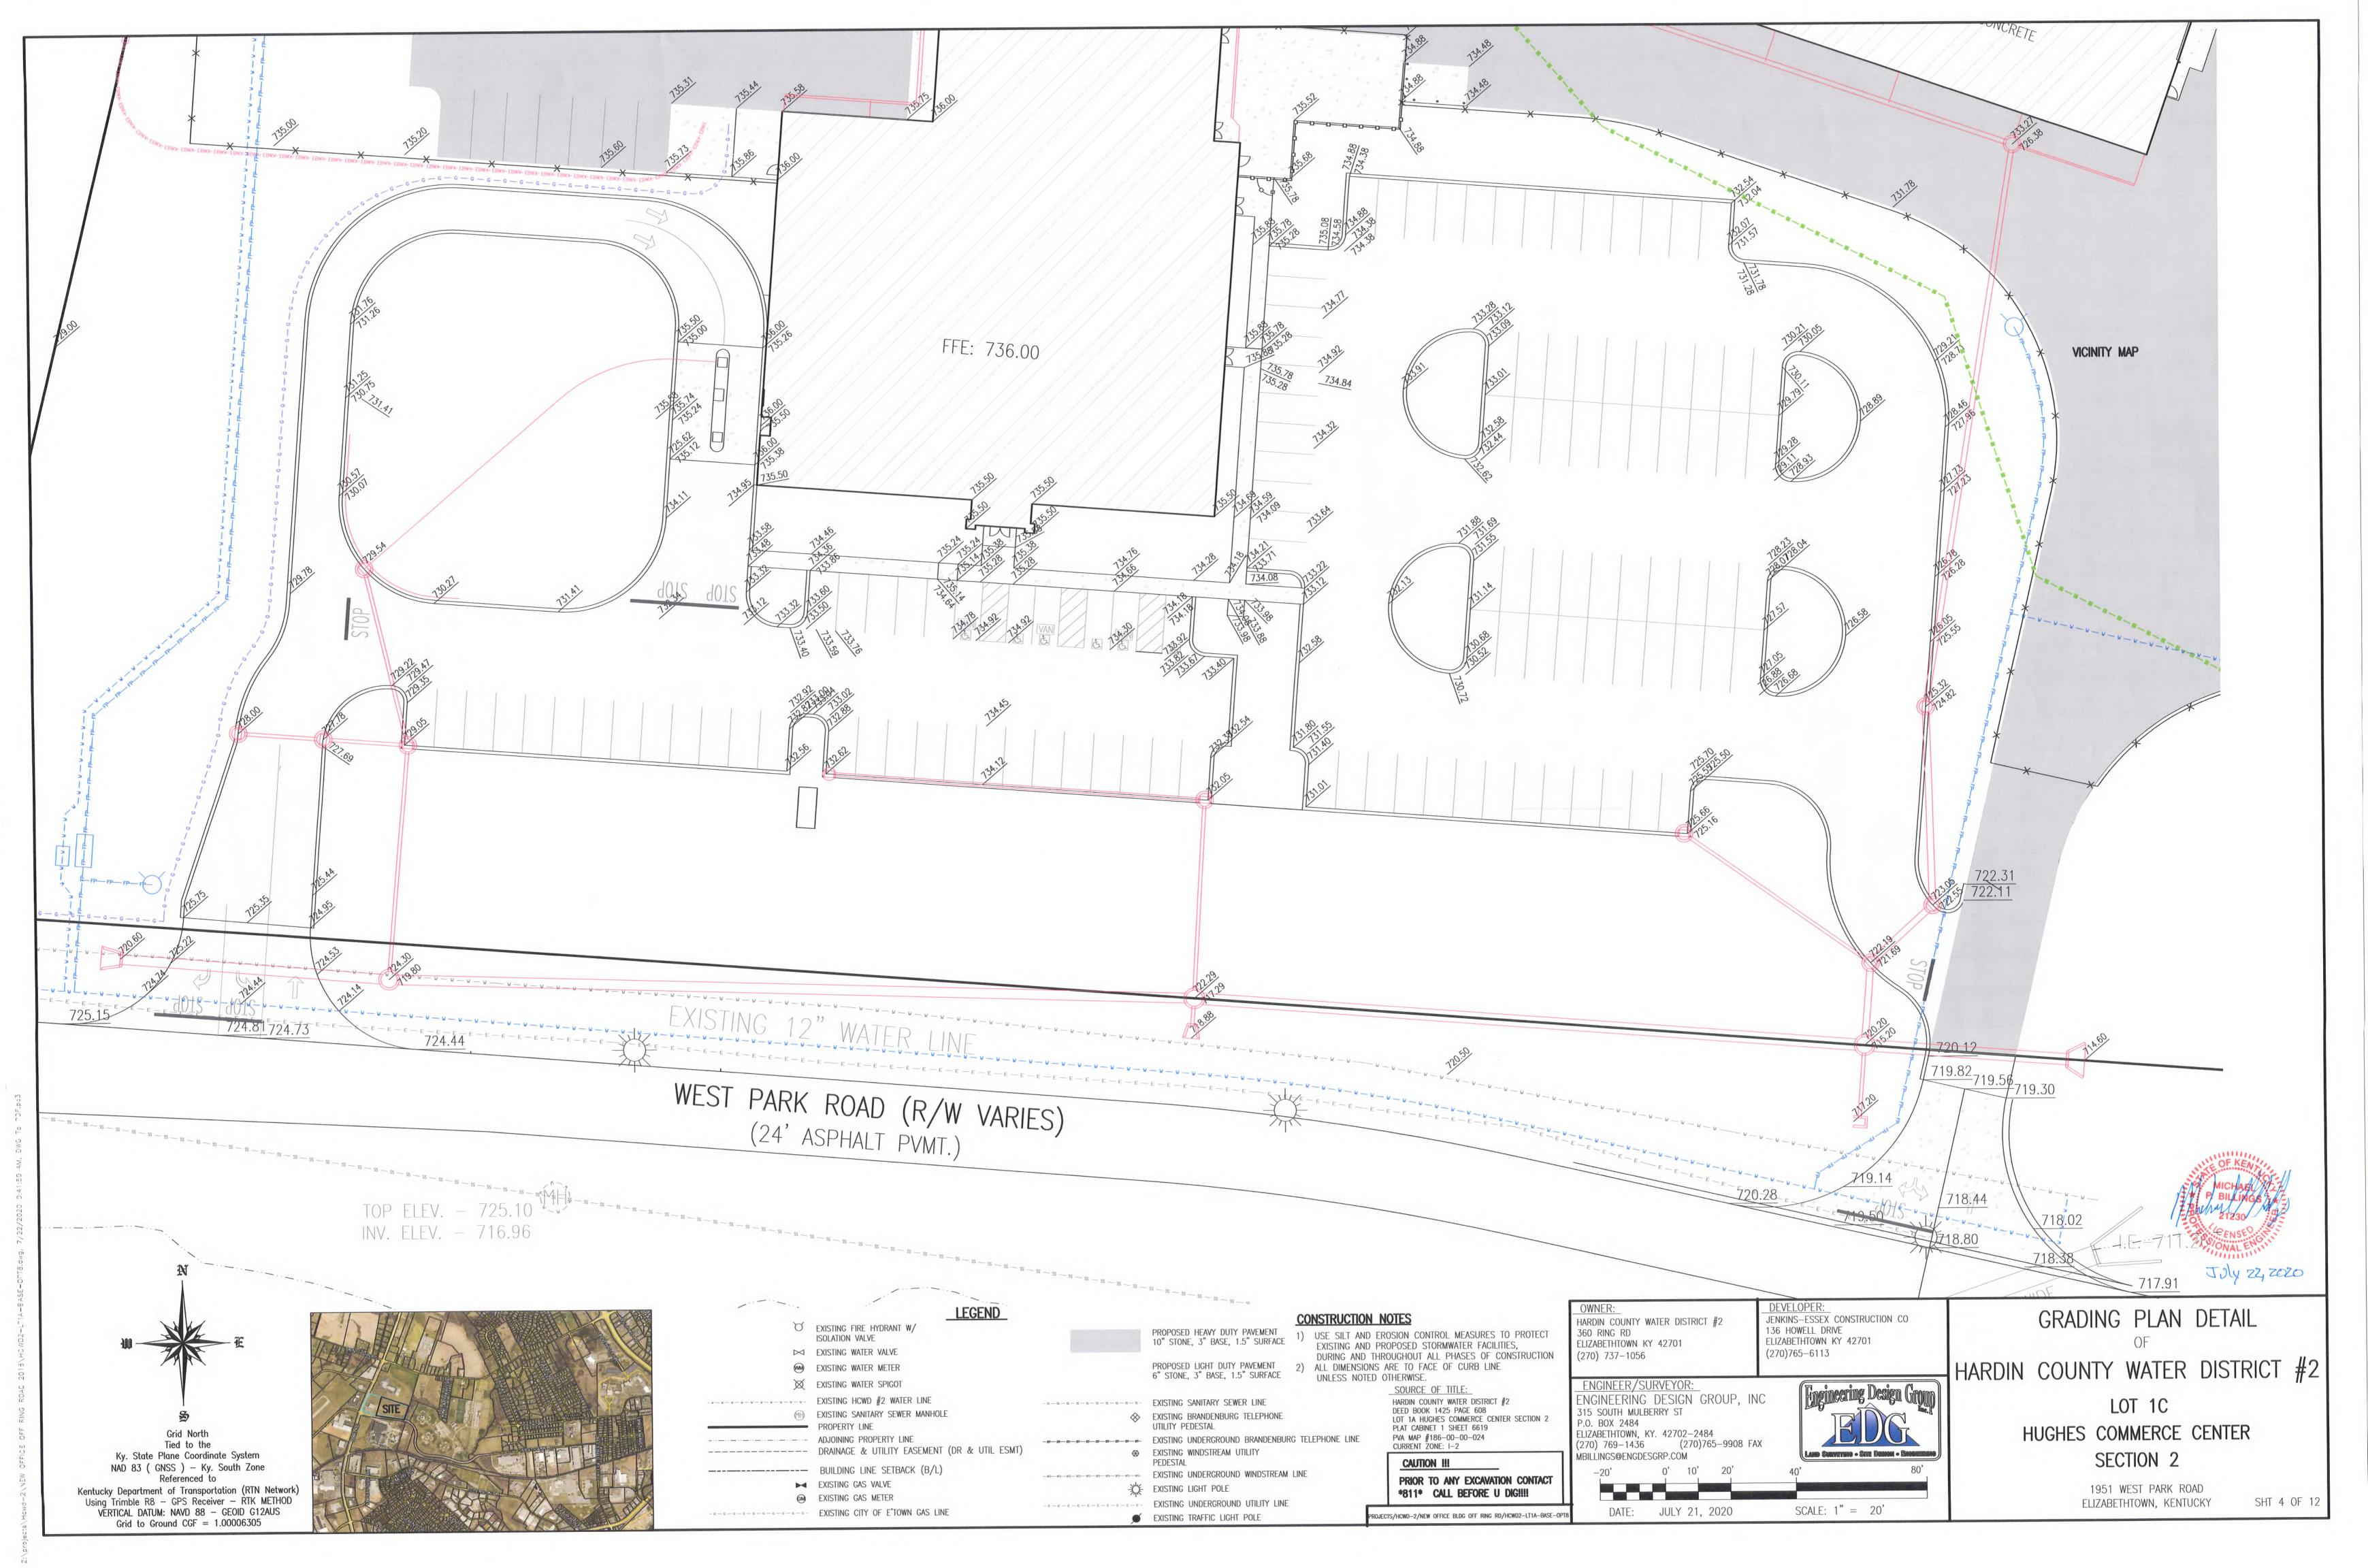

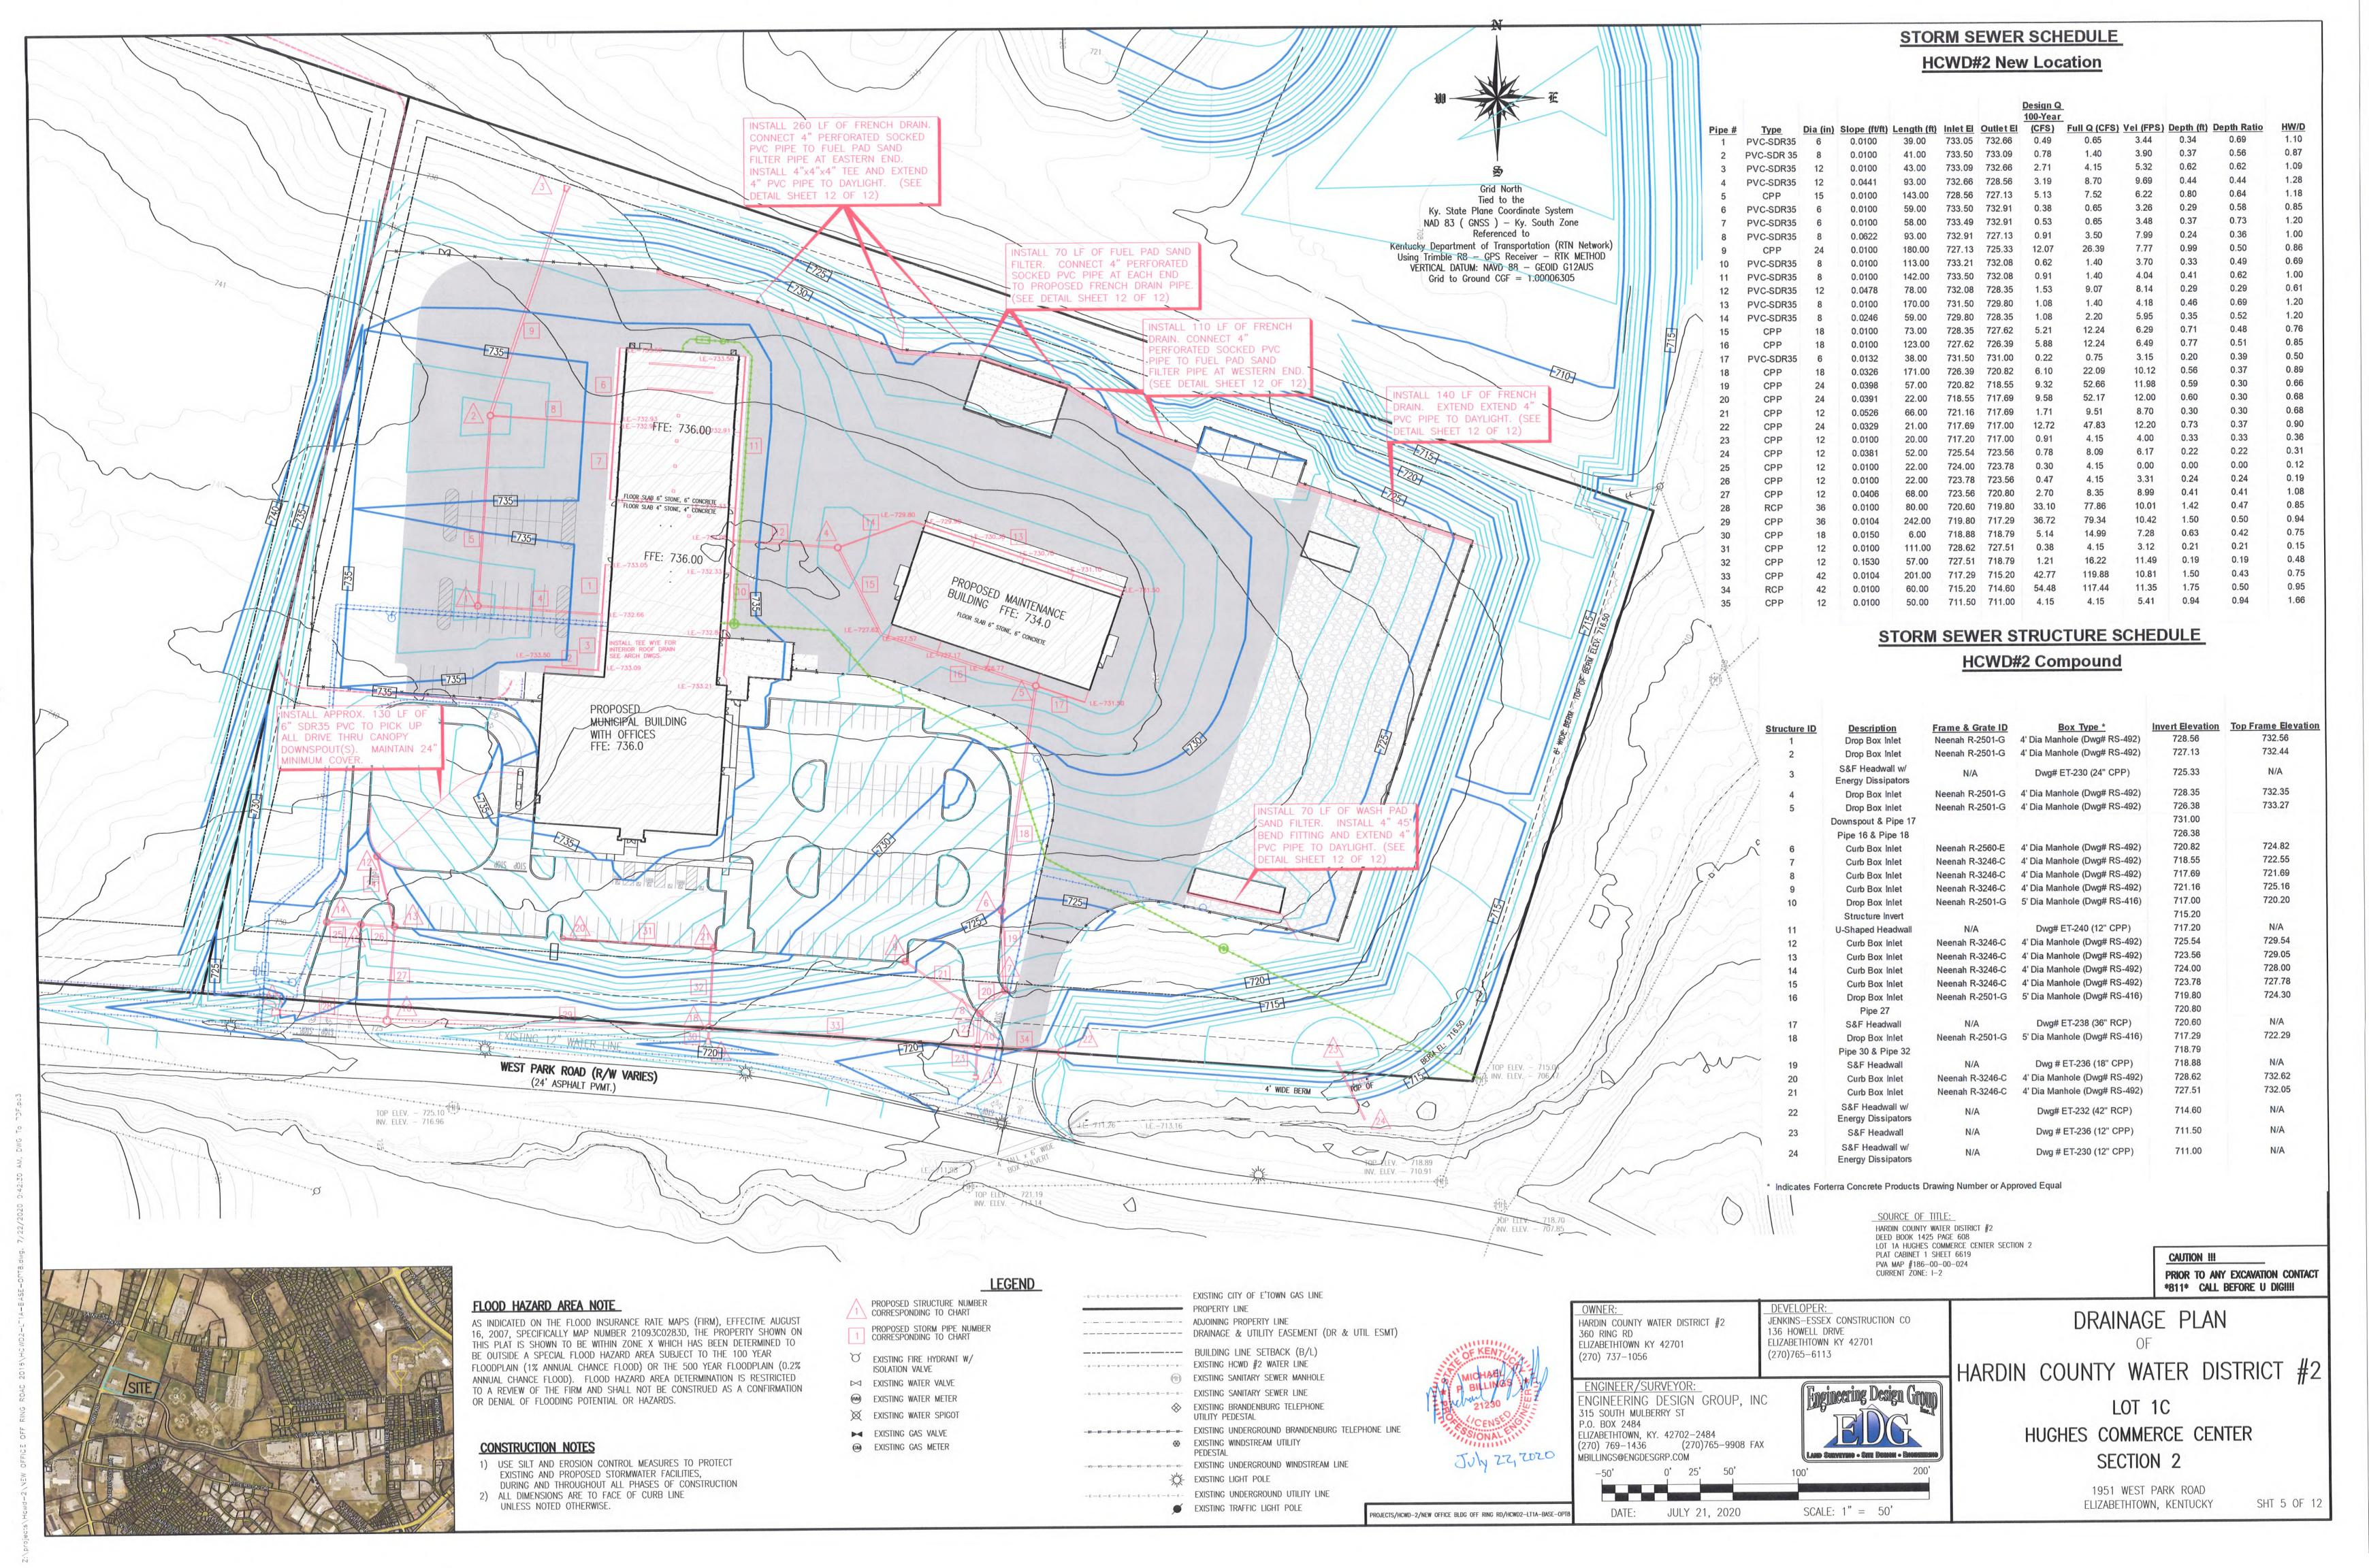

DRAINAGE SWALE SCHEDULE **HCWD#2 COMPOUND**

		Top			Horizontal				Design Q	Design Q	Design Q		
		Width	Side Slope	Side Slope	Slope	Length			100-Year	100-Year	100-Year	Full Depth	
wale #	Type	(ft) *	(Left)	(Right)	(ft/ft)	(ft)	Inlet El	Outlet El	(CFS)	Vel (FPS)	Depth (ft)	<u>(ft)</u>	Full Q (CFS)
1	Sod	3.12	4	5	0.0200	100.00	735.00	733.00	0.72	1.89	0.29	0.39	1.58
2	Sod	4.82	4	9	0.0417	63.00	733.00	730.37	1.26	2.64	0.27	0.37	2.91
3	Sod	7.07	5	4	0.0200	350.00	735.00	728.00	7.12	3.37	0.69	0.79	10.24
4	Sod	6.67	5	4	0.0387	140.73	728.00	722.55	8.30	4.49	0.64	0.74	12.22
5	Sod	11.53	4	8	0.0347	157.00	728.00	722.55	23.13	5.21	0.86	0.96	31.02
6	Sod	10.00	4	4	0.0347	57.00	722.55	720.57	33.10	6.26	1.15	1.25	41.35
7	Sod	5.44	4	4	0.0200	250.00	724.00	719.00	4.05	3.00	0.58	0.68	6.19
8	Sod	3.64	4	4	0.0200	75.00	720.50	719.00	1.09	2.16	0.36	0.46	2.11
9	Sod	8 10	10	10	0.0264	125.00	720.50	717 20	2 13	2 28	0.31	0.41	4.53

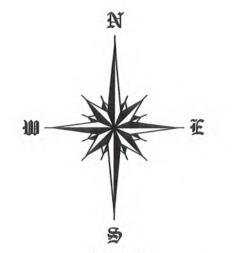

Tied to the Ky. State Plane Coordinate System NAD 83 (GNSS) - Ky. South Zone

Kentucky Department of Transportation (RTN Network) Using Trimble R8 - GPS Receiver - RTK METHOD VERTICAL DATUM: NAVD 88 - GEOID G12AUS Grid to Ground CGF = 1.00006305



STORM SEWER SCHEDULE

HCWD#2 New Location

							Design Q 100-Year					
e #	Type	Dia (in)	Slope (ft/ft)	Length (ft)	Inlet El	Outlet El	(CFS)	-	Vel (FPS)	Depth (ft)	Depth Ratio	HW/E
	PVC-SDR35	6	0.0100	39.00	733.05	732.66	0.49	0.65	3.44	0.34	0.69	1.10
	PVC-SDR 35	8	0.0100	41.00	733.50	733.09	0.78	1.40	3.90	0.37	0.56	0.87
	PVC-SDR35	12	0.0100	43.00	733.09	732.66	2.71	4.15	5.32	0.62	0.62	1.09
	PVC-SDR35	12	0.0441	93.00	732.66	728.56	3.19	8.70	9.69	0.44	0.44	1.28
	CPP	15	0.0100	143.00	728.56	727.13	5.13	7.52	6.22	0.80	0.64	1.18
,	PVC-SDR35	6	0.0100	59.00	733.50	732.91	0.38	0.65	3.26	0.29	0.58	0.85
	PVC-SDR35	6	0.0100	58.00	733.49	732.91	0.53	0.65	3.48	0.37	0.73	1.20
	PVC-SDR35	8	0.0622	93.00	732.91	727.13	0.91	3.50	7.99	0.24	0.36	1.00
)	CPP	24	0.0100	180.00	727.13	725.33	12.07	26.39	7.77	0.99	0.50	0.86
0	PVC-SDR35	8	0.0100	113.00	733.21	732.08	0.62	1.40	3.70	0.33	0.49	0.69
1	PVC-SDR35	8	0.0100	142.00	733.50	732.08	0.91	1.40	4.04	0.41	0.62	1.00
2	PVC-SDR35	12	0.0478	78.00	732.08	728.35	1.53	9.07	8.14	0.29	0.29	0.61
3	PVC-SDR35	8	0.0100	170.00	731.50	729.80	1.08	1.40	4.18	0.46	0.69	1.20
4	PVC-SDR35	8	0.0246	59.00	729.80	728.35	1.08	2.20	5.95	0.35	0.52	1.20
5	CPP	18	0.0100	73.00	728.35	727.62	5.21	12.24	6.29	0.71	0.48	0.76
6	CPP	18	0.0100	123.00	727.62	726.39	5.88	12.24	6.49	0.77	0.51	0.85
7	PVC-SDR35	6	0.0132	38.00	731.50	731.00	0.22	0.75	3.15	0.20	0.39	0.50
8	CPP	18	0.0326	171.00	726.39	720.82	6.10	22.09	10.12	0.56	0.37	0.89
9	CPP	24	0.0398	57.00	720.82	718.55	9.32	52.66	11.98	0.59	0.30	0.66
0	CPP	24	0.0391	22.00	718.55	717.69	9.58	52.17	12.00	0.60	0.30	0.68
1	CPP	12	0.0526	66.00	721.16	717.69	1.71	9.51	8.70	0.30	0.30	0.68
2	CPP	24	0.0329	21.00	717.69	717.00	12.72	47.83	12.20	0.73	0.37	0.90
3	CPP	12	0.0100	20.00	717.20	717.00	0.91	4.15	4.00	0.33	0.33	0.36
4	CPP	12	0.0381	52.00	725.54	723.56	0.78	8.09	6.17	0.22	0.22	0.31
5	CPP	12	0.0100	22.00	724.00	723.78	0.30	4.15	0.00	0.00	0.00	0.12
6	CPP	12	0.0100	22.00	723.78	723.56	0.47	4.15	3.31	0.24	0.24	0.19
7	CPP	12	0.0406	68.00	723.56	720.80	2.70	8.35	8.99	0.41	0.41	1.08
В	RCP	36	0.0100	80.00	720.60	719.80	33.10	77.86	10.01	1.42	0.47	0.85
9	CPP	36	0.0104	242.00	719.80	717.29	36.72	79.34	10.42	1.50	0.50	0.94
0	CPP	18	0.0150	6.00	718.88	718.79	5.14	14.99	7.28	0.63	0.42	0.75
1	CPP	12	0.0100	111.00	728.62	727.51	0.38	4.15	3.12	0.21	0.21	0.15
2	CPP	12	0.1530	57.00	727.51	718.79	1.21	16.22	11.49	0.19	0.19	0.48
3	CPP	42	0.0104	201.00	717.29	715.20	42.77	119.88	10.81	1.50	0.43	0.75
4	RCP	42	0.0100	60.00	715.20	714.60	54.48	117.44	11.35	1.75	0.50	0.95
5	CPP	12	0.0100	50.00	711.50	711.00	4.15	4.15	5.41	0.94	0.94	1.66

STORM SEWER STRUCTURE SCHEDULE

HCWD#2 Compound

Structure ID	Description	Frame & Grate ID	Box Type *	Invert Elevation	Top Frame Elevation
1 Drop Box Inlet		Neenah R-2501-G	4' Dia Manhole (Dwg# RS-492)	728.56	732.56
2 Drop Box Inlet		Neenah R-2501-G	4' Dia Manhole (Dwg# RS-492)	727.13	732.44
3	S&F Headwall w/ Energy Dissipators	N/A	Dwg# ET-230 (24" CPP)	725.33	N/A
4	Drop Box Inlet	Neenah R-2501-G	4' Dia Manhole (Dwg# RS-492)	728.35	732.35
5	Drop Box Inlet	Neenah R-2501-G	4' Dia Manhole (Dwg# RS-492)	726.38	733.27
	Downspout & Pipe 17			731.00	
	Pipe 16 & Pipe 18			726.38	
6	Curb Box Inlet	Neenah R-2560-E	4' Dia Manhole (Dwg# RS-492)	720.82	724.82
7	Curb Box Inlet	Neenah R-3246-C	4' Dia Manhole (Dwg# RS-492)	718.55	722.55
8	Curb Box Inlet	Neenah R-3246-C	4' Dia Manhole (Dwg# RS-492)	717.69	721.69
9	Curb Box Inlet	Neenah R-3246-C	4' Dia Manhole (Dwg# RS-492)	721.16	725.16
10	Drop Box Inlet	Neenah R-2501-G	5' Dia Manhole (Dwg# RS-416)	717.00	720.20
	Structure Invert			715.20	
11	U-Shaped Headwall	N/A	Dwg# ET-240 (12" CPP)	717.20	N/A
12	Curb Box Inlet	Neenah R-3246-C	4' Dia Manhole (Dwg# RS-492)	725.54	729.54
13	Curb Box Inlet	Neenah R-3246-C	4' Dia Manhole (Dwg# RS-492)	723.56	729.05
14	Curb Box Inlet	Neenah R-3246-C	4' Dia Manhole (Dwg# RS-492)	724.00	728.00
15	Curb Box Inlet	Neenah R-3246-C	4' Dia Manhole (Dwg# RS-492)	723.78	727.78
16	Drop Box Inlet	Neenah R-2501-G	5' Dia Manhole (Dwg# RS-416)	719.80	724.30
	Pipe 27			720.80	
17	S&F Headwall	N/A	Dwg# ET-238 (36" RCP)	720.60	N/A
18	Drop Box Inlet	Neenah R-2501-G	5' Dia Manhole (Dwg# RS-416)	717.29	722.29
	Pipe 30 & Pipe 32			718.79	
19	S&F Headwall	N/A	Dwg # ET-236 (18" CPP)	718.88	N/A
20	Curb Box Inlet	Neenah R-3246-C	4' Dia Manhole (Dwg# RS-492)	728.62	732.62
21	Curb Box Inlet	Neenah R-3246-C	4' Dia Manhole (Dwg# RS-492)	727.51	732.05
22	S&F Headwall w/ Energy Dissipators	N/A	Dwg# ET-232 (42" RCP)	714.60	N/A
23	S&F Headwall	N/A	Dwg # ET-236 (12" CPP)	711.50	N/A
24	S&F Headwall w/ Energy Dissipators	N/A	Dwg # ET-230 (12" CPP)	711.00	N/A

* Indicates Forterra Concrete Products Drawing Number or Approved Equal

SOURCE OF TITLE: HARDIN COUNTY WATER DISTRICT #2
DEED BOOK 1425 PAGE 608
LOT 1A HUGHES COMMERCE CENTER SECTION 2 PLAT CABINET 1 SHEET 6619 PVA MAP #186-00-00-024 CURRENT ZONE: I-2

CAUTION !!!

PRIOR TO ANY EXCAVATION CONTACT

811 CALL BEFORE U DIG!!!! DRAINAGE AREA MAP

HARDIN COUNTY WATER DISTRICT #2

LOT 1C HUGHES COMMERCE CENTER

SECTION 2

1951 WEST PARK ROAD

FLOOD HAZARD AREA NOTE AS INDICATED ON THE FLOOD INSURANCE RATE MAPS (FIRM), EFFECTIVE AUGUST 16, 2007, SPECIFICALLY MAP NUMBER 21093C0283D, THE PROPERTY SHOWN ON THIS PLAT IS SHOWN TO BE WITHIN ZONE X WHICH HAS BEEN DETERMINED TO BE OUTSIDE A SPECIAL FLOOD HAZARD AREA SUBJECT TO THE 100 YEAR FLOODPLAIN (1% ANNUAL CHANCE FLOOD) OR THE 500 YEAR FLOODPLAIN (0.2% ANNUAL CHANCE FLOOD). FLOOD HAZARD AREA DETERMINATION IS RESTRICTED TO A REVIEW OF THE FIRM AND SHALL NOT BE CONSTRUED AS A CONFIRMATION OR DENIAL OF FLOODING POTENTIAL OR HAZARDS.

CONSTRUCTION NOTES

- 1) USE SILT AND EROSION CONTROL MEASURES TO PROTECT EXISTING AND PROPOSED STORMWATER FACILITIES, DURING AND THROUGHOUT ALL PHASES OF CONSTRUCTION
- 2) ALL DIMENSIONS ARE TO FACE OF CURB LINE

UNLESS NOTED OTHERWISE.

LEGEND PROPOSED STRUCTURE NUMBER CORRESPONDING TO CHART

1 PROPOSED STORM PIPE NUMBER CORRESPONDING TO CHART

EXISTING FIRE HYDRANT W/ ISOLATION VALVE M EXISTING WATER VALVE EXISTING WATER METER

X EXISTING WATER SPIGOT ► EXISTING GAS VALVE M EXISTING GAS METER

---- DRAINAGE & UTILITY EASEMENT (DR & UTIL ESMT) ---- BUILDING LINE SETBACK (B/L) -v-v-v-v-v-v-v-v- EXISTING HCWD #2 WATER LINE MH EXISTING SANITARY SEWER MANHOLE -s-s-s-s-s-s-s- EXISTING SANITARY SEWER LINE ♦ EXISTING BRANDENBURG TELEPHONE UTILITY PEDESTAL PEDESTAL EXISTING LIGHT POLE

■ EXISTING TRAFFIC LIGHT POLE

-c-c-c-c-c-c-c-c- EXISTING CITY OF E'TOWN GAS LINE

 ${}^{-\epsilon-\epsilon-\epsilon-\epsilon-\epsilon-\epsilon-\epsilon-\epsilon-\epsilon-\epsilon-\epsilon-} \quad \text{EXISTING UNDERGROUND UTILITY LINE}$

PROPERTY LINE

----- ADJOINING PROPERTY LINE

July 22, 2020

P.O. BOX 2484 ELIZABETHTOWN, KY. 42702-2484 (270) 769–1436 (270)765–9908 FAX MBILLINGS@ENGDESGRP.COM

PROJECTS/HCWD-2/NEW OFFICE BLDG OFF RING RD/HCWD2-LT1A-BASE-OPT

JULY 21, 2020

HARDIN COUNTY WATER DISTRICT #2

ENGINEERING DESIGN GROUP, INC

ELIZABETHTOWN KY 42701

ENGINEER/SURVEYOR:

315 SOUTH MULBERRY ST

360 RING RD

(270) 737-1056

SCALE: 1" = 80'

JENKINS-ESSEX CONSTRUCTION CO

Engineering Design Group

LAND SURVEYING • SITE DESIGN • ENGINEERIN


136 HOWELL DRIVE


(270)765 - 6113

ELIZABETHTOWN KY 42701

ELIZABETHTOWN, KENTUCKY

SHT 6 OF 12

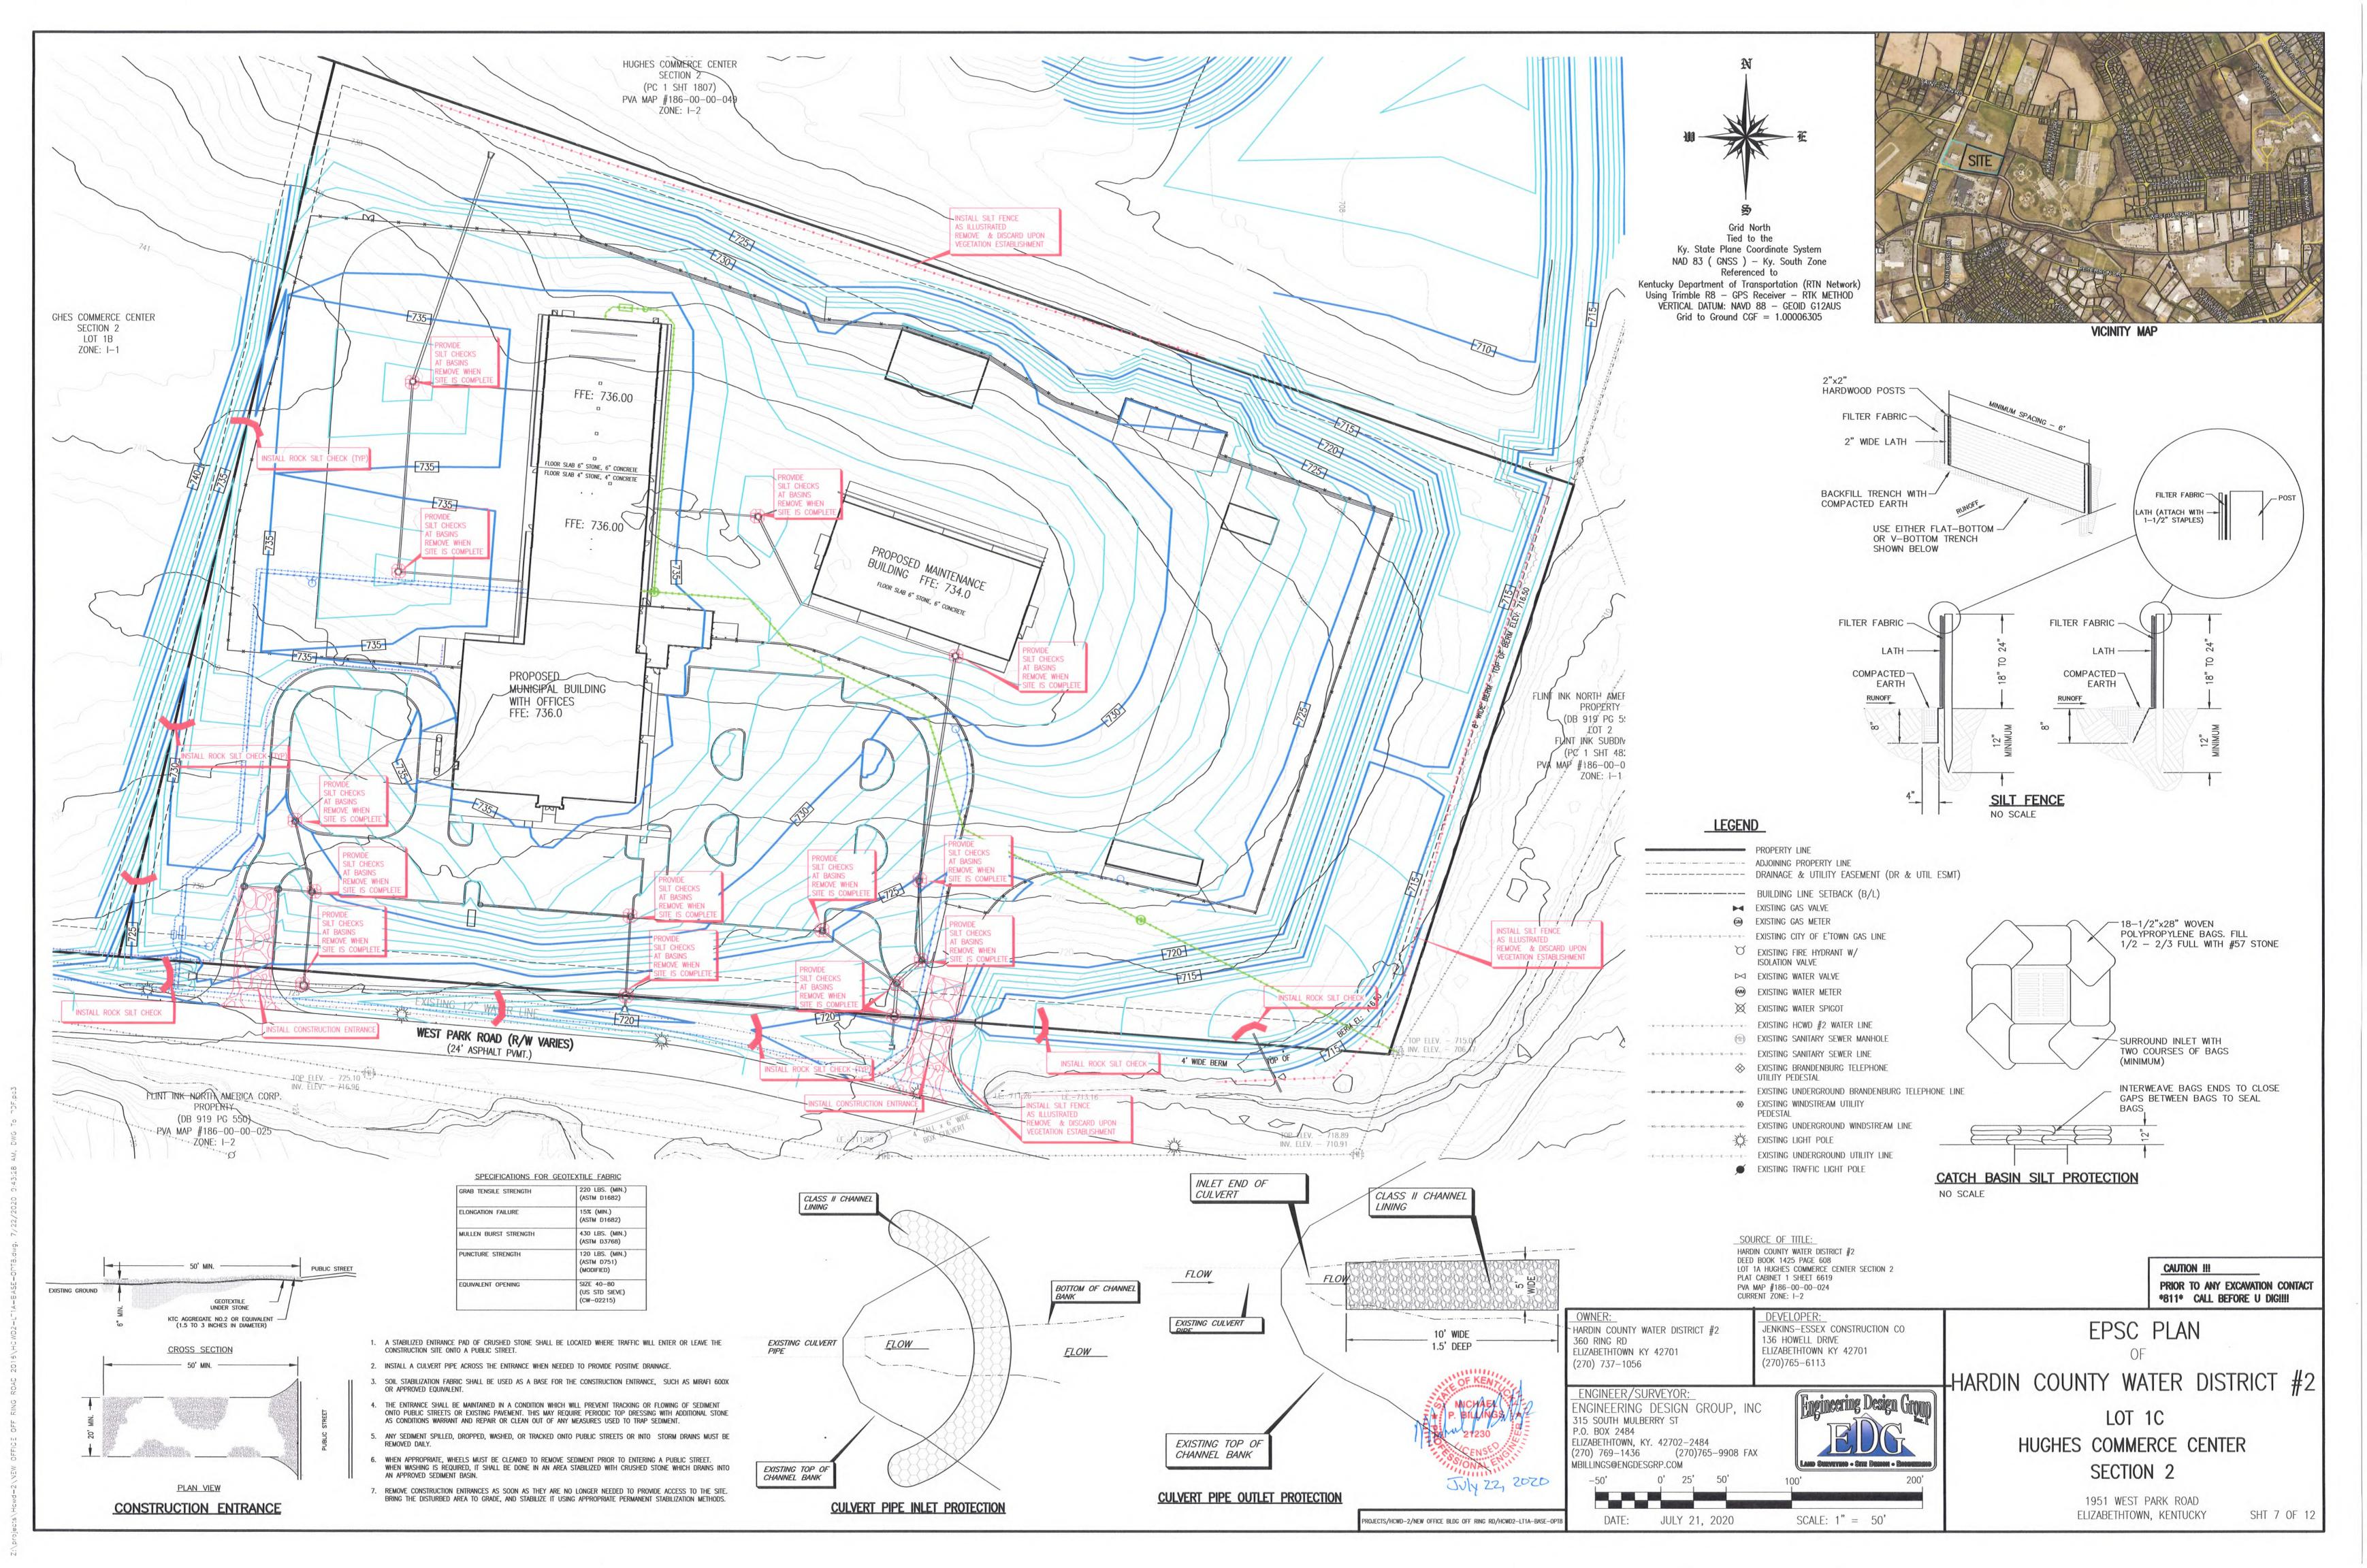

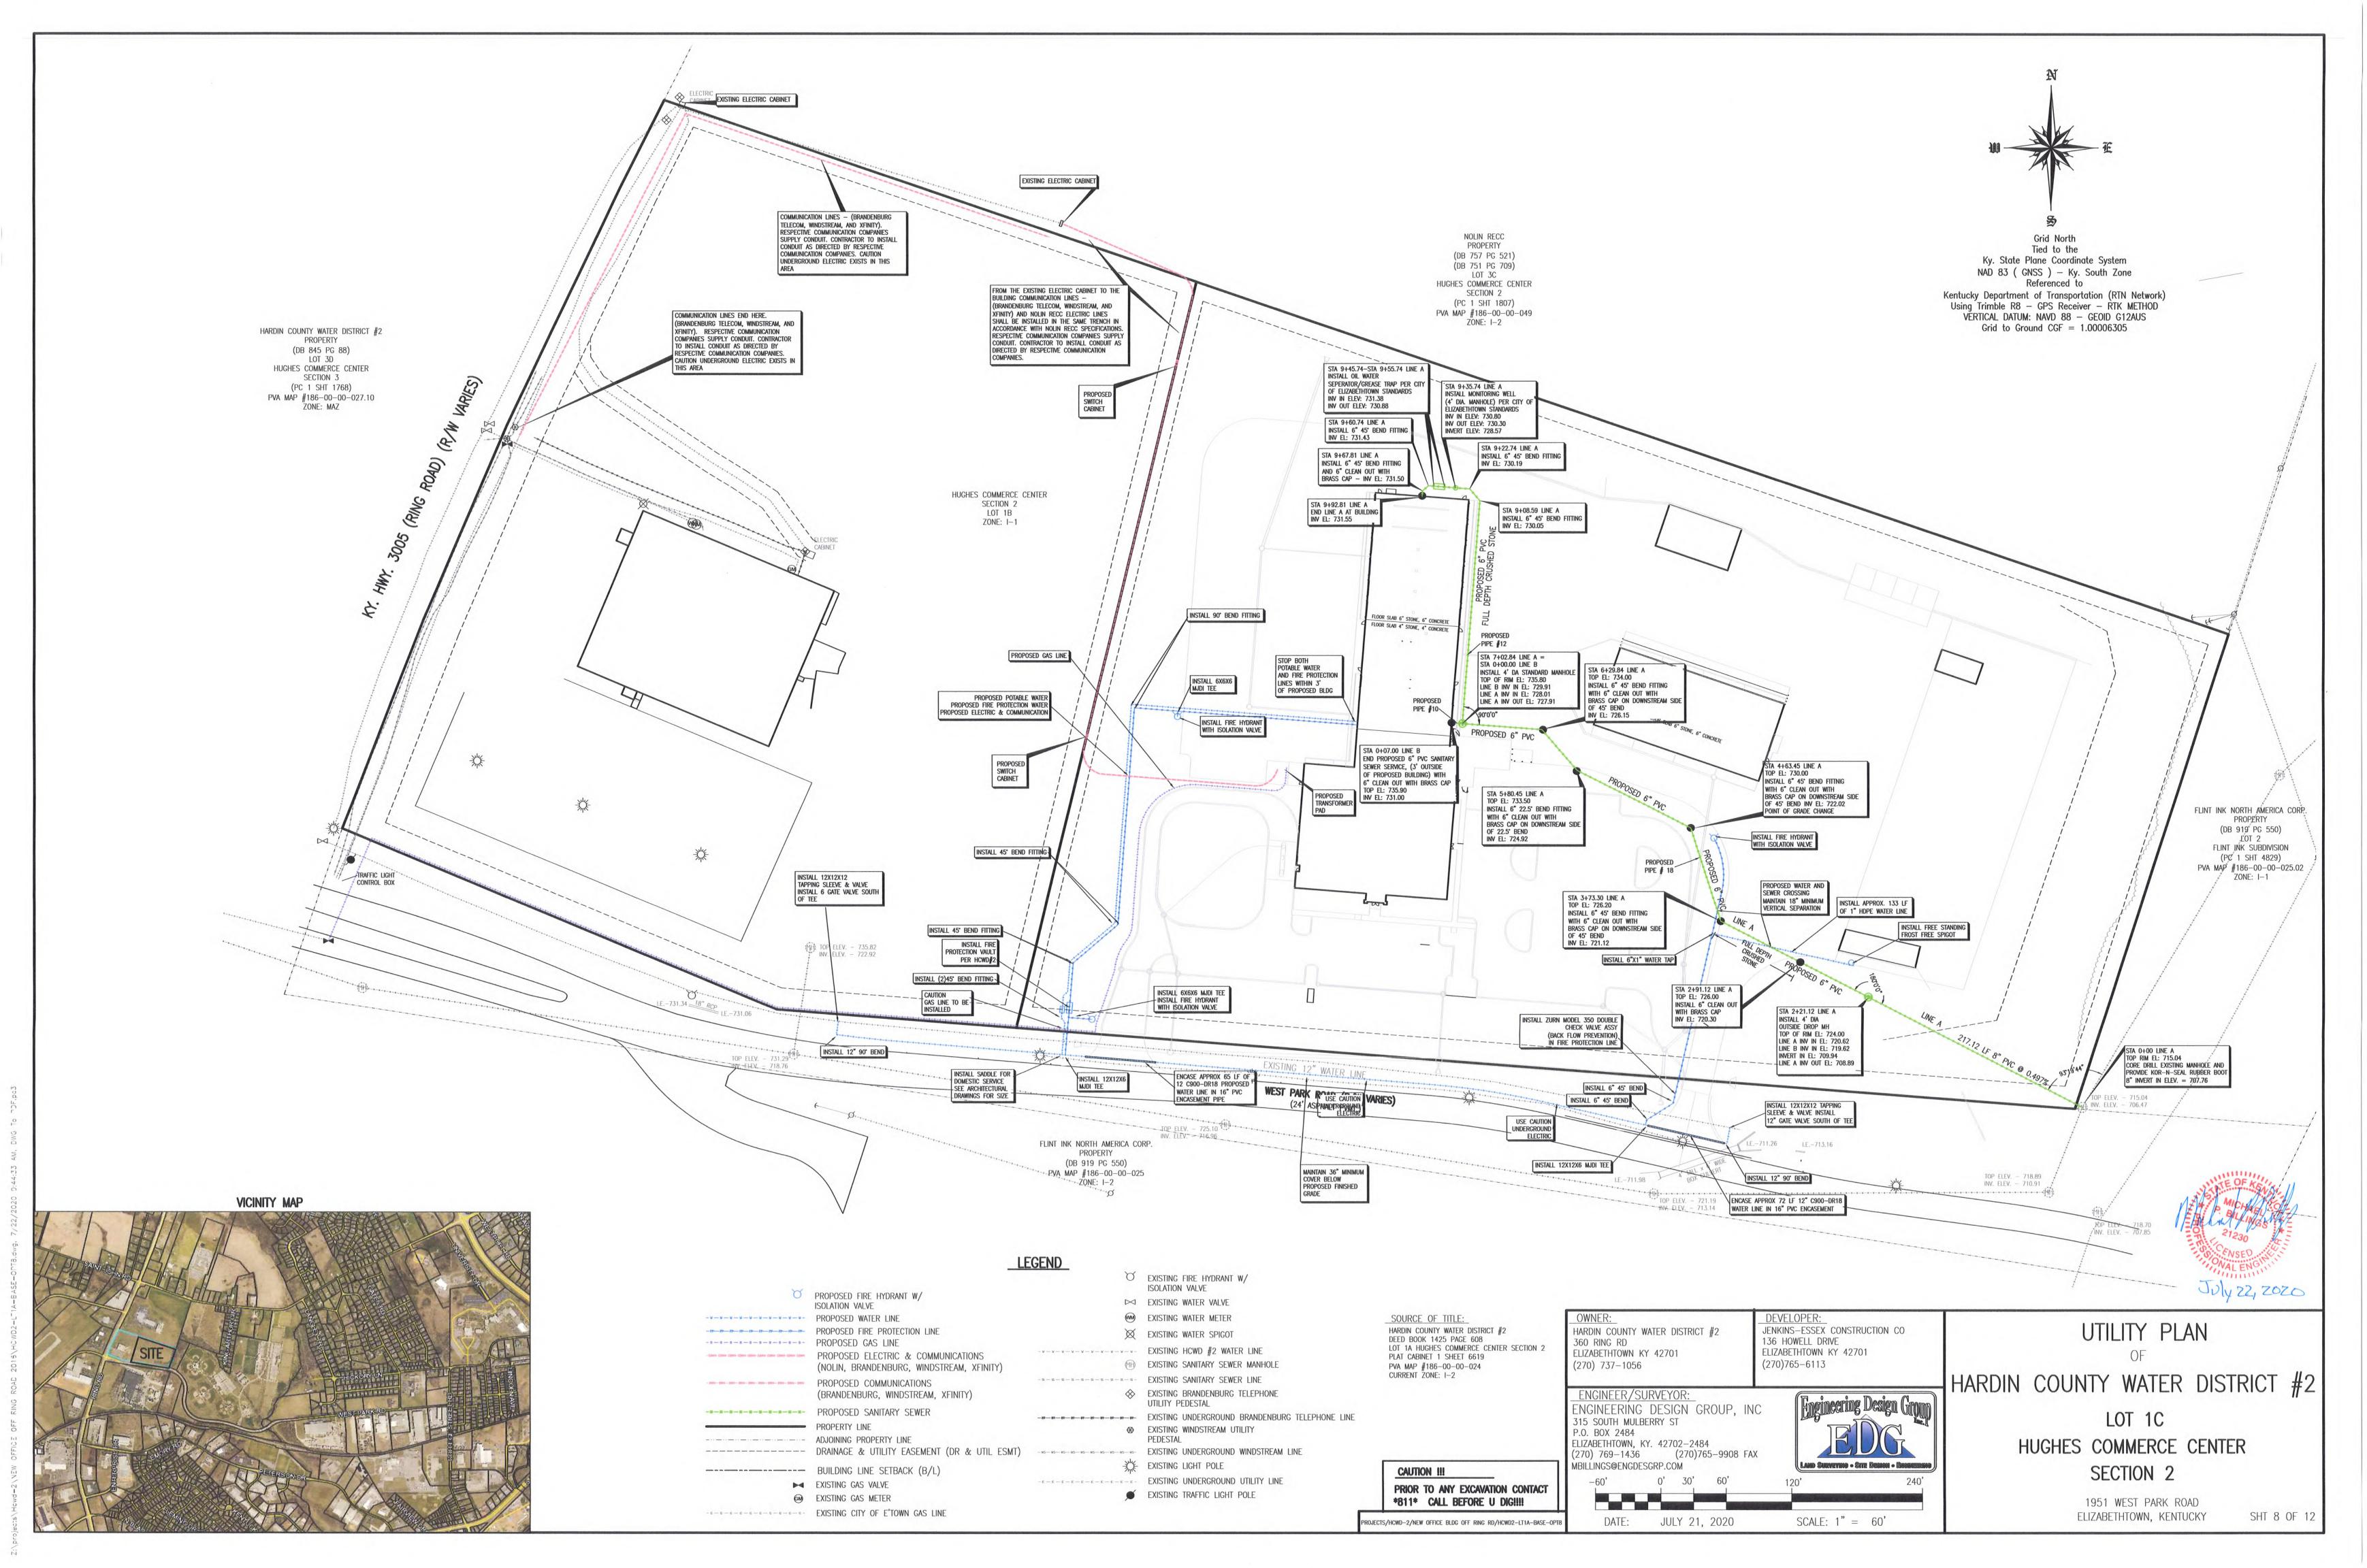



CAUTION III

PRIOR TO ANY EXCAVATION CONTACT
811 CALL BEFORE U DIGIIII

DEVELOPER:
JENKINS—ESSEX CONSTRUCTION CO
136 HOWELL DRIVE
ELIZABETHIOWN KY 42701
(270) 737—1056

ENGINEER/SURVEYOR:
ENGINEER/SURVEYOR:
ENGINEERING DESIGN GROUP, INC
315 SOUTH MULBERRY ST
P.O. BOX 2484
ELIZABETHIOWN, KY. 42702—2484
(270) 769—1436 (270)765—9908 FAX
MBILLINGS@ENGDESGRP.COM


-50' 0' 25' 50' 100' 200'


DATE: JULY 21, 2020 SCALE: 1" = 50'


SANITARY SEWER PROFILE
OF
HARDIN COUNTY WATER DISTRICT #2
LOT 1C
HUGHES COMMERCE CENTER
SECTION 2


1951 WEST PARK ROAD ELIZABETHTOWN, KENTUCKY


SHT 9 OF 12

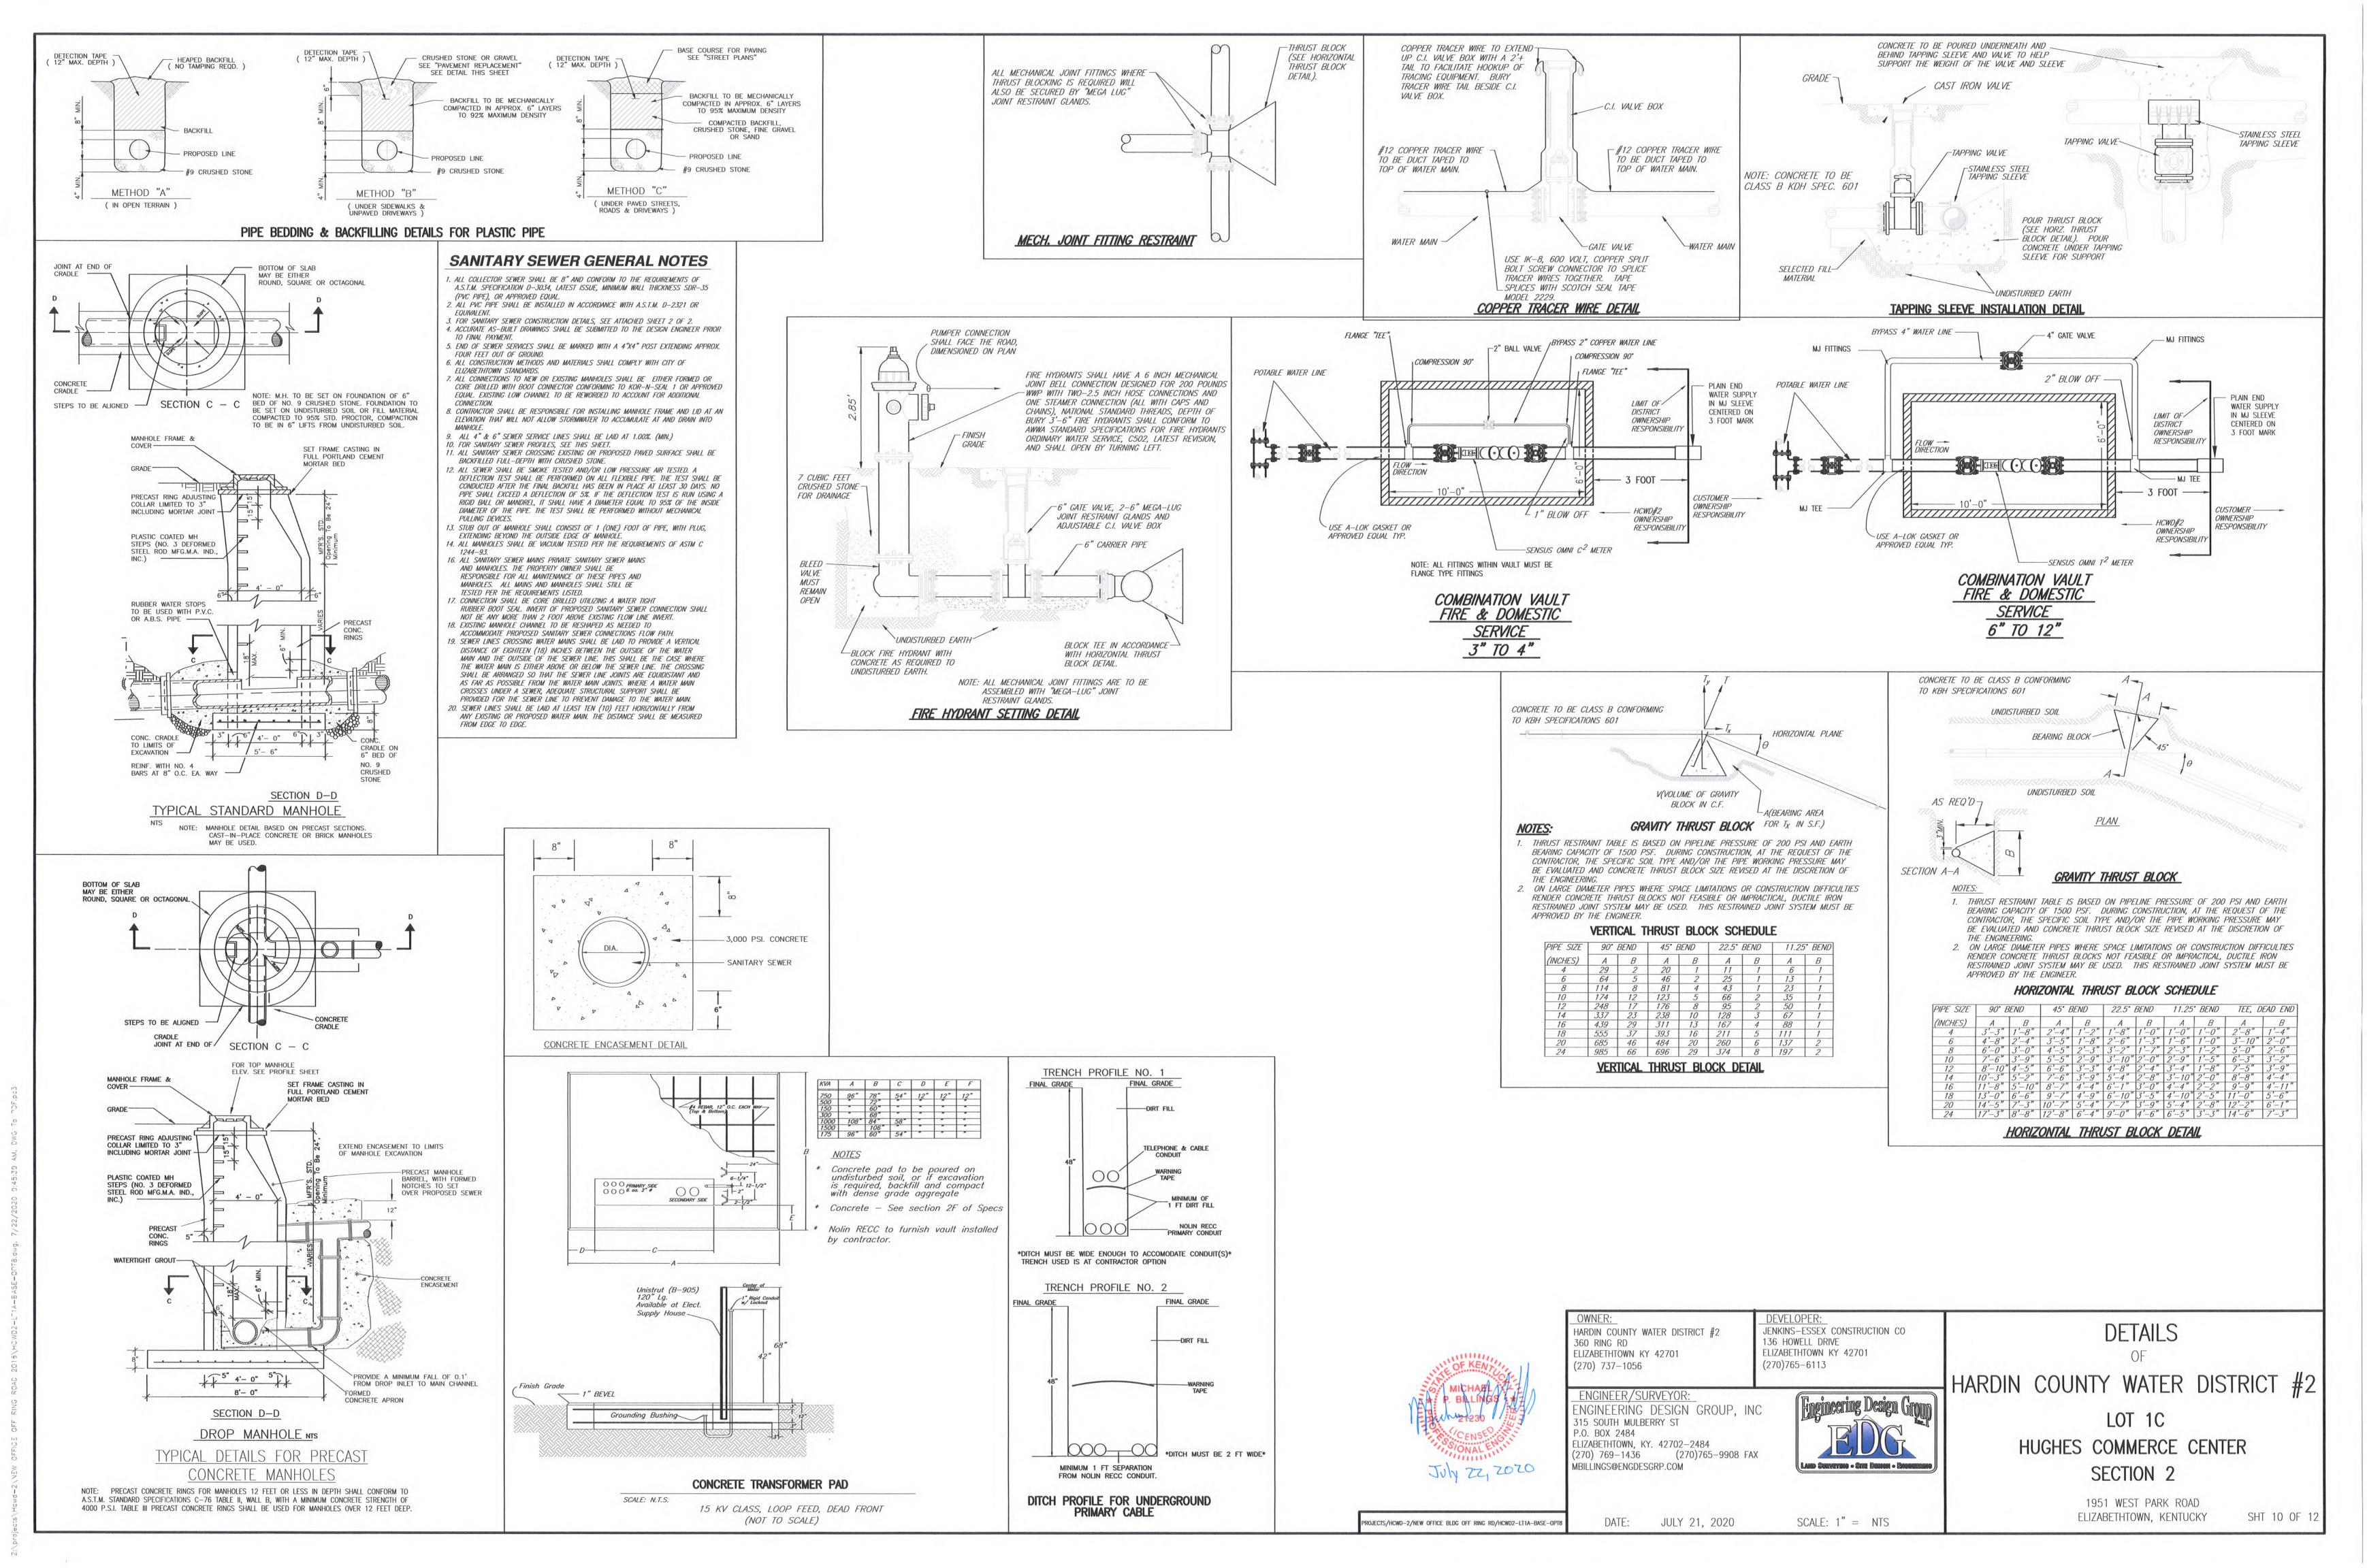


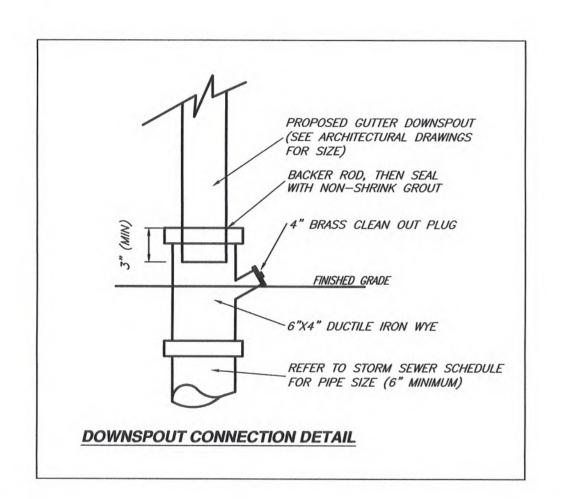


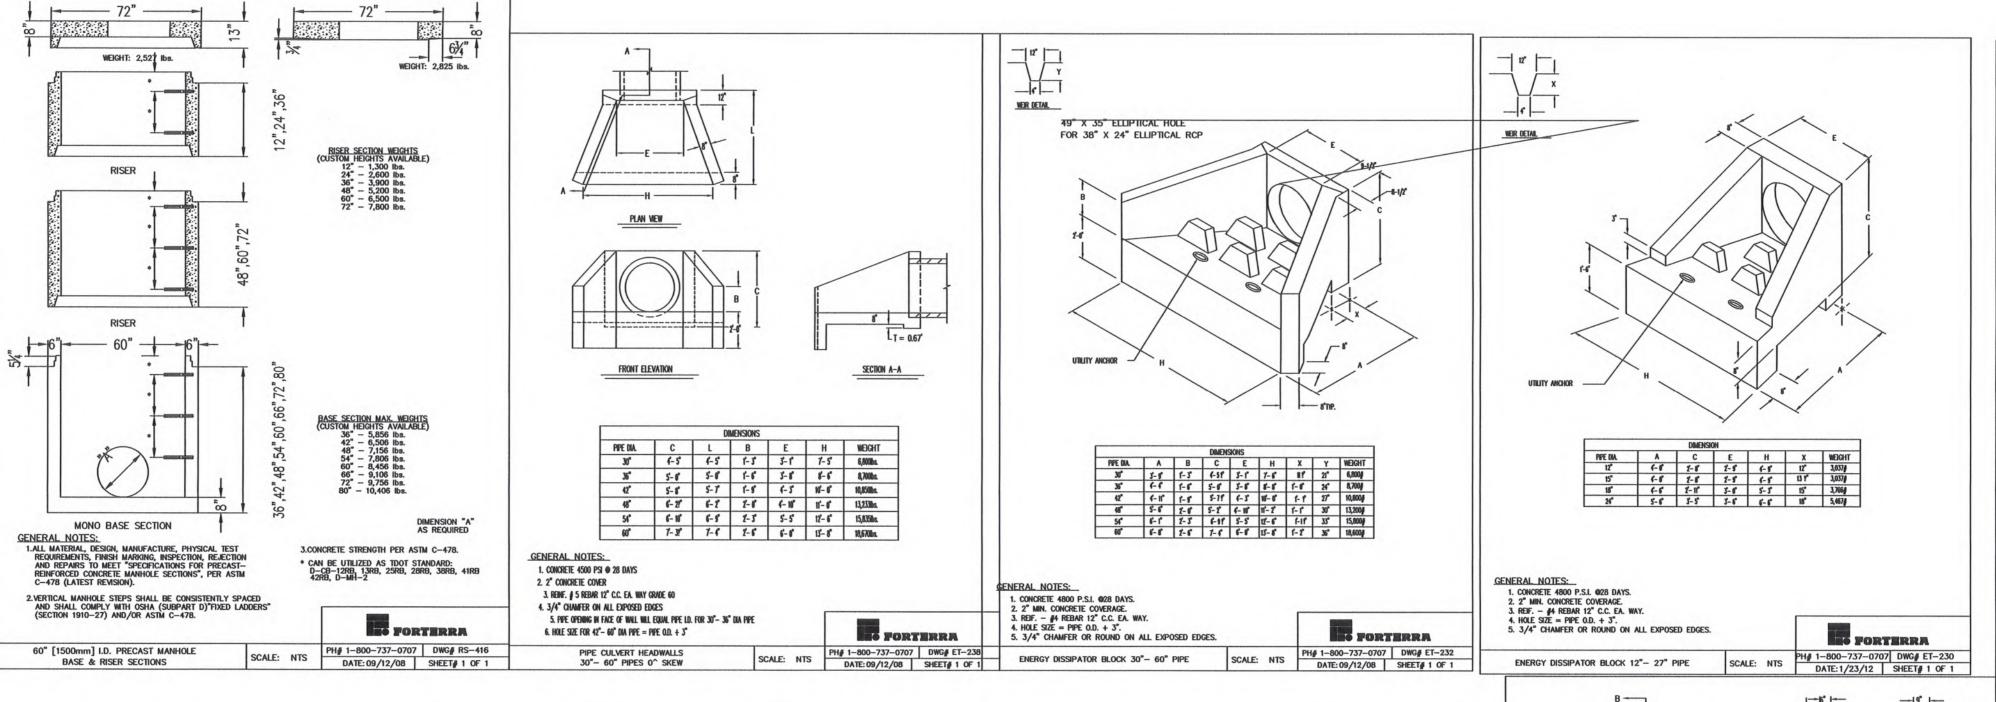

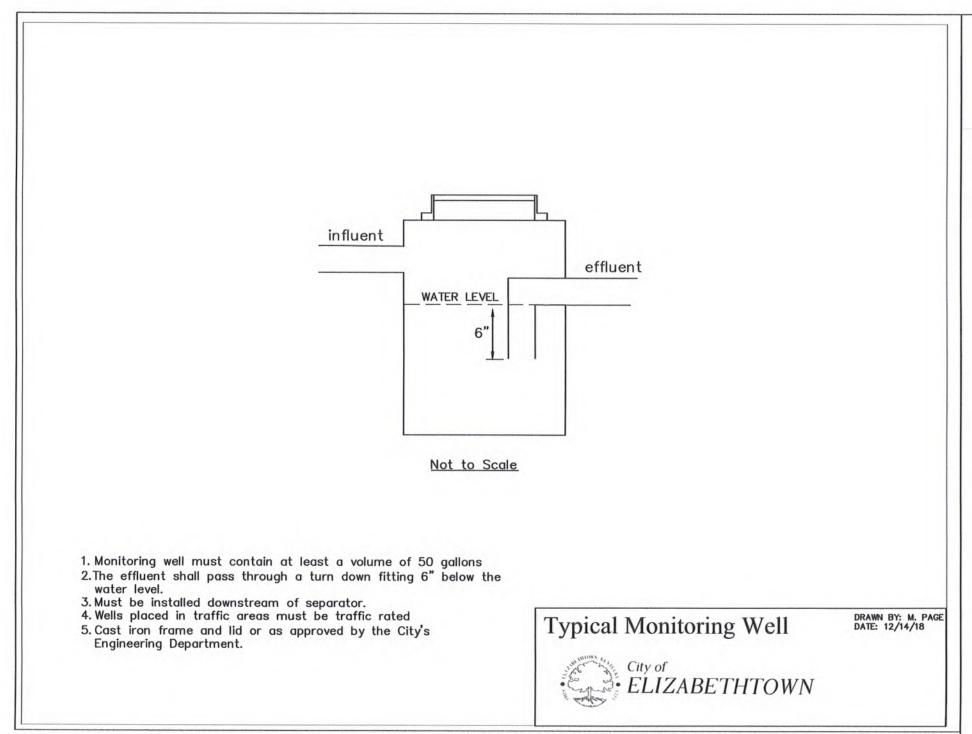

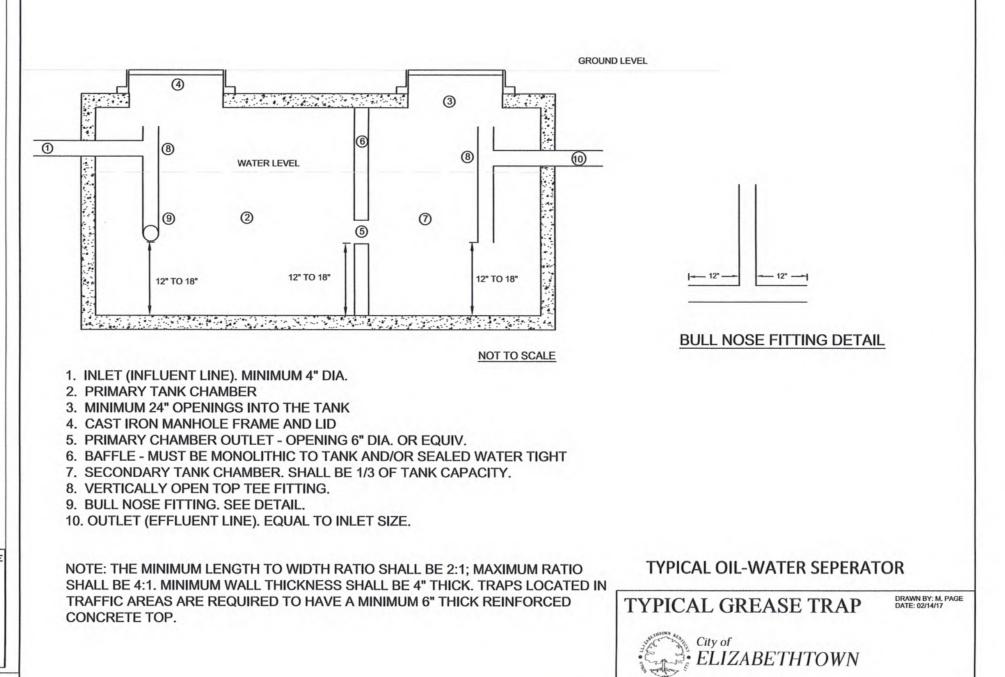

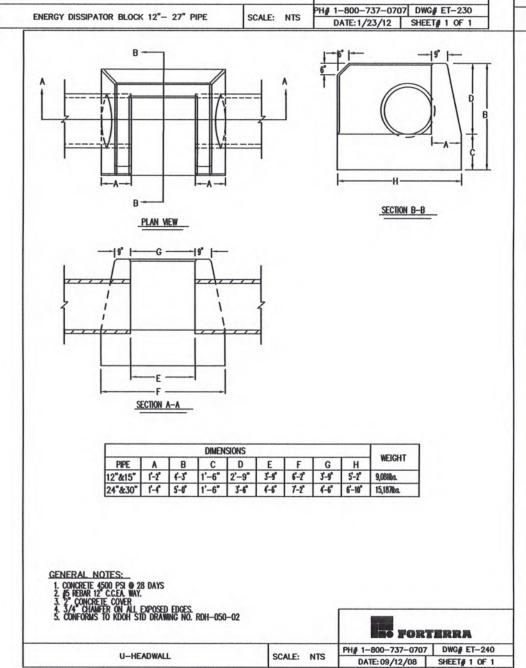

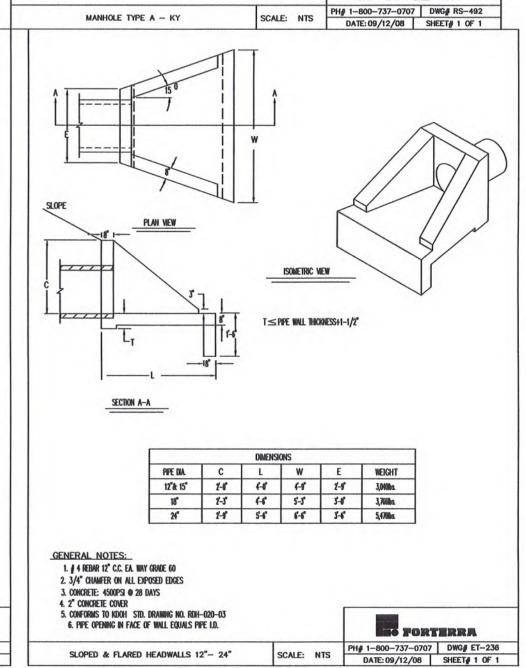

SEE DETAIL A

FORTERRA

DETAIL "B"

BUTYL SEALANT USED @JOINTS -

GENERAL NOTES:

1. Concrete 4,500psi @ 28 days

4. Hole Size* Pipe O.D. + 3"

Weights: Base - 4,850 lbs max Riser - 850 lbs / vert. ft. Top Slab - 1,500 lbs

3. Reinforcement #5 rebar 6" C.C. Ea. Way

5. Conforms to KDOH STD drawing NO. RDM-001-06

2. 2" MIN Concrete Cover



July 22, 2020

CAUTION !!! PRIOR TO ANY EXCAVATION CONTACT *811* CALL BEFORE U DIG!!!!

projects/HCWD-2/NEW OFFICE BLDG OFF RING RD/DETAIL

HARDIN COUNTY WATER DISTRICT #2 360 RING RD ELIZABETHTOWN KY 42701 (270) 737-1056

ENGINEER/SURVEYOR: ENGINEERING DESIGN GROUP, INC 315 SOUTH MULBERRY ST P.O. BOX 2484 ELIZABETHTOWN, KY. 42702-2484 (270) 769-1436 (270)765-9908 FAX MBILLINGS@ENGDESGRP.COM

DATE: JULY 21, 2020

Engineering Design Groun LAND SURVEYING - SITE DESIGN - ENGINEERING

SCALE: 1" = NTS

DEVELOPER:
JENKINS-ESSEX CONSTRUCTION CO

136 HOWELL DRIVE

(270)765 - 6113

ELIZABETHTOWN KY 42701

DETAILS HARDIN COUNTY WATER DISTRICT #2 LOT 1C HUGHES COMMERCE CENTER

> 1951 WEST PARK ROAD ELIZABETHTOWN, KENTUCKY

SECTION 2

SHT 11 OF 12

