COMMONWEALTH OF KENTUCKY

BEFORE THE PUBLIC SERVICE COMMISSION

In the Matter of:

ELECTRONIC APPLICATION OF ESTILL)
COUNTY WATER DISTRICT NO. 1 FOR A) CASE NO. 2019-00119
SURCHARGE TO FINANCE WATER LOSS)
CONTROL EFFORTS)

VERIFIED MOTION FOR AUTHORIZATION TO EXPEND SURCHARGE PROCEEDS

Pursuant to KRS 278.160(2) and 807 KAR 5:001, Section 4, Estill County Water District No. 1 ("Estill District" or "the District") moves the Public Service Commission ("the Commission") for authorization to expend a portion of the proceeds of its Water Loss Control Program Surcharge ("Surcharge") to replace a deteriorating creek crossing. Because of the urgent need to replace the creek crossing, the District requests that the Commission rule on this motion no later than November 26, 2025.

In support of its Motion, Estill District states:

1. On August 29, 2019, the Commission authorized Estill District to assess a monthly surcharge of \$3.54 to fund water loss control efforts.¹ Pursuant to the Commission's Order of August 30, 2024 in Case No. 2023-00371,² the District will cease billing the surcharge on December 31, 2025. As of September 30, 2025, the District's surcharge account had a balance of \$409,362.92.³

-1-

¹ Order of Aug. 29, 2019 at 4. See also Order of July 28, 2020 at 2.

² Electronic Application of Estill County Water District No. 1 For A Rate Adjustment Pursuant To 807 KAR 5:076, Case No. 2023-00371 (Ky. PSC Aug. 30, 2024), Order at 29.

³ September 2025 Monthly Activity Report.

- 2. Under the terms of the District's Water Loss Control Program Surcharge Rate Schedule, "Estill District must obtain Commission approval for the use of surcharge proceeds for a specific water loss control activity prior to the expenditure of any surcharge proceeds for such activity."
- 3. Estill District proposes to use no more than \$40,000 of Surcharge proceeds to replace a creek crossing located in the community of Hargett of Estill County near the intersection of Hargett Road and Kentucky Route 89. This creek crossing was recently washed out, exposing a 6-inch water line. A photograph of the existing water line is attached to this Motion as **Exhibit A**. A break or rupture in existing water line will result in a loss of 11,000 gallons of water per minute and the disruption of water service to 409 customers.
 - 4. Plans for the proposed creek crossing are attached to this Motion as **Exhibit B**.
- 5. Kentucky Division of Water approval is not required for the creek crossing replacement.
- 6. The estimated cost of the proposed creek crossing replacement is less than \$40,000. The project engineer's estimate of constructing the replacement is attached to this Motion as **Exhibit C**. The District will invite qualified firms to submit written quotes detailing scope, pricing, and timelines for replacing the creek crossing. The District will award the contract to construct the replacement crossing based upon its evaluation of submitted quotes, which will include consideration of such factors as cost, firm experience, and responsiveness. Because the project cost is less than \$40,000, and the project is urgently needed, formal advertising and sealed bids will not be required.⁵

⁴ Tariff of Estill County Water District No. 1, PSCKY No. 4, First Revised Sheet No. 1.1.

As the District has not adopted the Local Model Procurement Code (KRS 45A.343-.460), KRS 424.260 governs the District's procurement. KRS 424.260(1) provides that a special district may not enter a contract for goods or

7. Use of Surcharge proceeds for the creek crossing replacement is reasonable and consistent with the Surcharge's purpose.

8. The District must act quickly to replace the existing creek cross. The creek crossing has become more volatile due to recent flooding. Furthermore, failure to complete construction before the onset of freezing weather conditions could adversely affect the temporary water line that is currently in place. Therefore, the District requests that the Commission act upon this Motion no later than **November 26, 2025**.

WHEREFORE, Estill District moves for an Order that authorizes the District's use of Surcharge proceeds to replace the creek crossing near the intersection of Hargett Road and Kentucky Route 89 in Estill County and that such Order be entered no later than **November 26**, **2025**.

Dated: November 14, 2025 Respectfully submitted,

Gerald E. Wuetcher

Stoll Keenon Ogden PLLC

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Telephone: (859) 231-3017

Fax: (859) 259-3517

gerald.wuetcher@skofirm.com

Counsel for Estill County Water District No. 1

service involving an expenditure of more than \$40,000 without first making newspaper advertisement for bids. It does not require an advertisement for bids if the expenditure is less than \$40,000.

CERTIFICATE OF SERVICE

In accordance with 807 KAR 5:001, Section 8, and the Public Service Commission's Order of July 22, 2021 in Case No. 2020-00085, I certify that this document was transmitted to the Public Service Commission on November 14, 2025, and that there is currently no party that the Public Service Commission has excused from participation by electronic means in this proceeding.

Counsel for Estill County Water District No. 1

VERIFICATION

COMMONWEALTH OF KENTUCKY)
) SS:
COUNTY OF ESTILL)
General Manager of Estill County Water Dist	ing duly sworn, deposes and states that she is the rict No. 1 and that she has personal knowledge of the statements contained in this Motion are true and edge, and belief.
6	Miller Audrea Miller
Subscribed and sworn to before me, a this 44th day of November 2025.	a Notary Public in and before said County and State,
•	Notary Public (SEAL)
	My Commission Expires: 6/20/26
, ·	Notary ID: KYNP 53871









HARGETT CREEK CROSSING WATERLINE REPLACEMENT

JULY 2025


School Country Bogic HARGETT CREEK SITE Ocentrative Country Ocentry Ocentrative Country Ocentrative Country

SCALE = 1" = 2000'

Prepared For:

ESTILL COUNTY WATER DISTRICT 76 CEDAR GROVE ROAD

IRVINE, KENTUCKY 40336

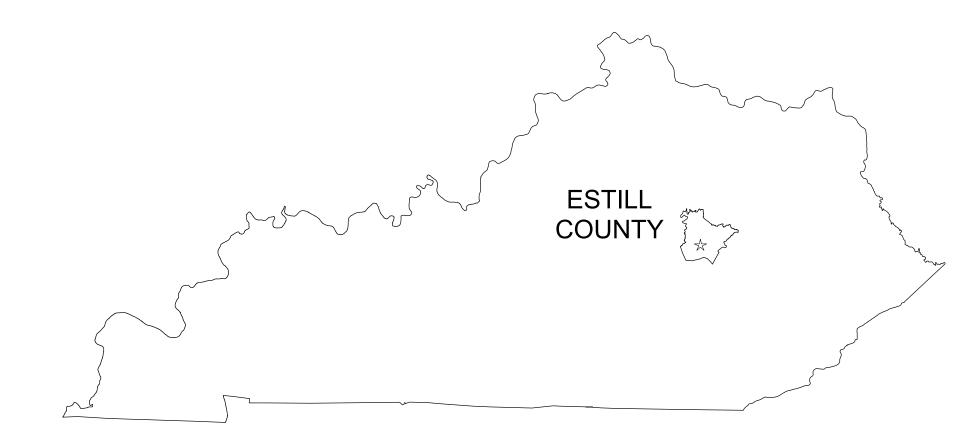



SITE Skyler King Cemetery Hargett Owen Walling Cemetery Dugan Cemetery Dugan Cemetery

SCALE 1" = 500'

INDEX OF DRAWINGS

COVER - LOCATION & VICINITY MAPS, INDEX OF DRAWINGS
GENERAL NOTES, ABBREVIATIONS, LEGEND AND UTILITIES
SITE PLAN AND PROFILE
STANDARD DETAILS



GENERAL NOTES

- 1. MINIMUM COVER OVER WATER PIPE SHALL BE 30" UNLESS NOTED OTHERWISE.
- 2. MINIMUM COVER OVER VALVE NUT TO BE 12". MAXIMUM COVER OVER VALVE NUTS TO BE 48". WHERE VALVES ARE BURIED DEEPER THAN 48", A 3/4" OR 1" SOLID STEEL VALVE OPERATING NUT EXTENSION SHALL BE REQUIRED AND SECURED TO VALVE OPERATING NUT.
- 3. CONTRACTOR SHALL HAVE THE OWNER'S PERSONNEL ON SITE WHEN DIGGING OVER OR AROUND THE OWNER'S UTILITY LINES. CONTRACTOR SHALL SCHEDULE EXCAVATION WITH RESIDENT OBSERVER.
- 4. EXACT SIZES, DEPTHS, MATERIALS AND LOCATIONS OF EXISTING UTILITIES ARE UNKNOWN. IT SHALL BE THE CONTRACTOR'S RESPONSIBILITY TO DETERMINE THE EXACT LOCATION OF THESE FAR ENOUGH IN ADVANCE OF THE PIPELINE OPERATION SO AS NOT TO CAUSE ANY UNNECESSARY DELAYS. RELOCATION OF EXISTING UTILITIES FOUND TO BE IN DIRECT CONFLICT AND UNAVOIDABLE PER THE ENGINEER'S DISCRETION WITH THIS CONTRACT SHALL BE ACCOMPLISHED BY THE OWNER OF THE UTILITIES INVOLVED. THE CONTRACTOR SHALL BE RESPONSIBLE FOR NOTIFYING UTILITY COMPANIES HAVING UTILITIES IN THE AREA PRIOR TO EXCAVATION. 12, EXACT SIZES, DEPTHS, MATERIALS AND LOCATIONS OF OTHER UTILITIES CONTINUOUS COMMUNICATIONS ON A DAY TO DAY BASIS WILL BE REQUIRED. THE UTILITY COMPANIES ARE LISTED BELOW.
- 5. KENTUCKY STATUTES (KRS 367.4901 THRU 367.4917) REQUIRE THAT ALL EXCAVATORS PLANNING EXCAVATION OR DEMOLITION WORK SHALL CALL ALL UTILITY COMPANIES IN THE AREA AND AN UNDERGROUND PROTECTION SERVICE SUCH AS "BUD" (1-800-752-6007) AT LEAST TWO (2) WORKING DAYS BEFORE COMMENCING WORK TO NOTIFY UTILITY COMPANIES IN THE AREA WITH UNDERGROUND UTILITIES OF THE PLANNED EXCAVATION OR DEMOLITION ACTIVITIES.

- 6. FITTINGS SHALL BE RESTRAINED JOINT (RJ) WHERE NOTED ON PLANS UNLESS NOTED OTHERWISE.
- 7. WHEREVER POSSIBLE, FIRE HYDRANTS SHALL BE LOCATED FOR MINIMUM DEPTH OF BURY. EXTENSIONS SHALL BE REQUIRED FOR DEEPER INSTALLATIONS.
- 8. ALL TIE-IN LOCATIONS SHALL BE UNCOVERED PRIOR TO CONSTRUCTION TO 15. ALL CULVERTS AND CROSS DRAINS AT STREETS, DRIVES AND MAINTAIN PROPER ALIGNMENT AND ELEVATION OF NEW CONNECTIONS.
- 9. CONTRACTOR SHALL INVENTORY REQUIRED MATERIALS, TRENCH DEWATERING EQUIPMENT, AND ASSEMBLE IF NECESSARY ALL REQUIRED FITTINGS PRIOR TO CUT-INS SO TO ENSURE MINIMUM DOWN TIME FOR CONNECTION.
- 10. SURFACE DRAINAGE SHALL BE MAINTAINED ON A DAY-BY-DAY BASIS.
- 11. THE CONTRACTOR WILL BE REQUIRED TO DISPOSE OF ALL EXCESS EXCAVATED MATERIAL FROM WATER LINE AND SERVICE LINE CONSTRUCTION THAT IS NOT PERMITTED TO BE BACKFILLED OVER THE PIPE.
- SUCH AS SEWER SERVICES AND BRANCH SEWERS ARE UNKNOWN. THE CONTRACTOR SHALL ACCURATELY DETERMINE THESE AHEAD OF HIS/HER TRENCHING OPERATION, SO AS TO AVOID DELAYING THE PIPE LAYING PROGRESS. THE PROPOSED WATERLINE SHALL BE CONSTRUCTED SUCH THAT THE MINIMUM DISTANCE OVER OR UNDER THE OUTSIDE DIAMETER TO 20. BENCHMARKS/CONTROL POINTS ARE SHOWN ON THE PLANS. THE THE OUTSIDE DIAMETER OF ANY EXISTING UTILITY IS A MINIMUM OF 6 INCHES. FOR SEWER CROSSINGS THIS MINIMUM DISTANCE SHALL BE 18 INCHES.

- 13. EXCAVATION IN ALL STREETS, DRIVEWAYS AND PAVED PARKING AREAS SHALL BE BACKFILLED PER THE SPECIFIED TOP OF TRENCH SURFACE.
- 14. ALL ROCKS, EARTH CLODS AND OTHER LARGE MATERIAL SHALL BE REMOVED FROM THE TRENCH BOTTOM PRIOR TO PLACEMENT OF THE
- ENTRANCES NEAR THE WORK AREA SHALL BE PROTECTED. IF IN THE PATH OF THE WORK, THE RESIDENT OBSERVER SHALL BE NOTIFIED. AND THE CONTRACTOR SHALL AVOID THESE UTILITIES WITH ADDITIONAL FITTINGS IF NECESSARY.
- 16. ELEVATIONS SHOWN ARE BASED ON USGS CONTOURING AND/OR OBTAINED ELEVATIONS ON NAVD 88.
- 17. PROPERTY LINES, IF SHOWN, ARE APPROXIMATE. PROPERTY INFORMATION WAS TAKEN FROM THE COUNTY PVA MAPS AND SHALL NOT BE CONSIDERED A TRUE BOUNDARY.
- 18. EXCAVATION IS UNCLASSIFIED; NO SEPARATE PAYMENT SHALL BE MADE FOR ROCK REMOVAL.
- 19. THE CONTRACTOR SHALL MAINTAIN CONTINUOUS ACCESS TO ALL COMMERCIAL ESTABLISHMENTS AND RESIDENTIAL DWELLINGS.
- CONTRACTOR SHALL USE THESE POINTS FOR LAYOUT OF THE PROPOSED WORK.
- 21. ELEVATIONS SHOWN ARE BASED ON FEET ABOVE MEAN SEA LEVEL THE ENGINEER IMMEDIATELY OF ANY DIFFERENCES IN FIELD CONDITIONS AND THE MAPPING.
- 22. NO SEPARATE PAY ITEM HAS BEEN ESTABLISHED FOR FITTINGS AND NO DETERMINATION OF THE NUMBER OF FITTINGS REQUIRED ON THE JOB HAS BEEN MADE. THE CONTRACTOR, DURING THE BIDDING PHASE, SHALL DETERMINE THE NUMBER OF FITTINGS REQUIRED ON THE JOB AND INCLUDE THE COST OF THE FITTINGS AND INSTALLATION IN THE CONTRACT UNIT PRICE PER LF OF PIPE.

- 23. SILT CHECKS/FENCES SHALL BE PROVIDED TO PREVENT SEDIMENT RUNOFF FROM ENTERING DRAINAGE SYSTEMS. SILT CHECKS SHALL BE INSTALLED PER SPECS.
- 24. CONTRACTOR SHALL REPAIR OR REPLACE AREAS OF ROADS AND DRIVEWAYS DAMAGED DURING CONSTRUCTION.
- 25. EXISTING SANITARY SEWER LATERALS, IN GENERAL, CONNECT TO THE TRUNK SYSTEM PERPENDICULARLY FROM EACH HOUSE OR BUSINESS INTO THE STREET. THE EXACT LOCATION OF THE LATERALS ARE NOT KNOWN. IT IS THE CONTRACTORS RESPONSIBILITY TO AVOID THESE LATERALS BY EXCAVATING FAR ENOUGH IN ADVANCE TO MOVE THE WATERLINE UP OR DOWN TO AVOID THE CONFLICT. ANY DAMAGE TO AN EXISTING SANITARY SEWER LATERAL SHALL BE PAID FOR AT THE CONTRACTORS EXPENSE.
- 26. ALL NON-PAVED DISTURBED AREAS SHALL BE REVEGETATED AFTER WORK IN THE IMMEDIATE VICINITY HAS BEEN COMPLETED IN ACCORDANCE WITH THE SPECIFICATIONS. REVEGETATION SHALL BE COMPLETED NO LATER THAN TWO (2) WEEKS FOLLOWING COMPLETION OF WORK IN THE IMMEDIATE VICINITY.
- 27. ANY ADJUSTMENT OR RELOCATIONS OF EXISTING UTILITIES, OUTSIDE THE SCOPE OF THIS WORK SHALL BE PERFORMED BY OTHERS. THE CONTRACTOR SHALL TAKE SPECIAL CARE TO PROTECT EXISTING UTILITIES TO THE MAXIMUM EXTENT PRACTICABLE. THE CONTRACTOR SHALL COORDINATE WORK WITH THE OWNER TO MINIMIZE DISRUPTION OF EXISTING SERVICES. THE CONTRACTOR SHALL NOTIFY THE OWNER AND ENGINEER 2 DAYS IN ADVANCE OF ANY WORK WHICH REQUIRES EXISTING UTILITIES TO BE TAKEN OUT OF SERVICE.
- 28. MUD, SEDIMENT, AND OTHER CONSTRUCTION DEBRIS TRACKED FROM ACTIVE CONSTRUCTION AREAS ONTO ROADWAYS ARE TO BE SWEPT FROM THE ROADWAY AT THE END OF EACH WORK DAY.
- FROM THE U.S. GEOLOGICAL SURVEY. THE CONTRACTOR SHALL NOTIFY 29. UNLESS NOTED OTHERWISE, CONTRACTOR SHALL REPLACE ALL DAMAGED SIDEWALKS PER THE DETAIL SHOWN.
 - 30. ALL PROPOSED WATER LINES SHALL BE INSTALLED A MINIMUM HORZONTAL DISTANCE OF 10 FEET AND MINIMUM VERTICAL DISTANCE OF 18 INCHES FROM EXISTING OR PROPOSED SANITARY SEWER LINES.

ABBREVIATIONS

AV — AIR /VACIIIM VAI VE
B BOTTOM
AV — AIR/VACUUM VALVE B — BOTTOM C.I. — CAST IRON
¢ — CENTERLINE
CMP — CORRUGATED METAL PIPE
CO — CLEAN OUT
CONC. — CONCRETE
CONST. — CONSTRUCT
CPP — CORRUGATED PLASTIC PIPE D — DRAIN
D — DRAIN
DB — DIRECTIONAL BORE DIA, Ø — DIAMETER
D.I. DUCTILE IRON D.I.P. DUCTILE IRON PIPE
DIST. — DUCTILE IRON PIPE DIST. — DISTURBED
EL. , ELEV. — ELEVATION
EOP — EDGE OF PAVEMENT
EX. , EXIST. — EXISTING FH — FIRE HYDRANT
FH FIRE HYDRANT
FLH — FLUSHING HYDRANT
FM — FORCE MAIN F.V. — FIELD VERIFY
F.V. FIELD VERIFY
FC — FLUSHING CONNECTION GAL. — GALLON
GALV — GALVANIZED
GL — GAS LINE GM — GAS METER
GS — GAS METER GS — GAS SERVICE LINE
GV — GAS SERVICE LINE GV — GATE VALVE
HDPE — HIGH-DENSITY
POLYETHYLENE I.E. ———————————————————————————————————
11111
KDOH — KENTUCKY DEPARTMENT OF HIGHWAYS
OI HIGHWATS


LA — LATERAL ASSEMBLY

мн ——	MANHOLE
MAX. —	MAXIMUM
M.J. —	MECHANICAL JOINT
MIN. —	MINIMUM
oc —	
O.D. —	OUTSIDE DIAMETER
P.E. —	POLYETHYLENE
PROP	——————————————————————————————————————
	PLUG VALVE
PVC —	POLYVINYL CHLORIDE
	- REINFORCED CONC. PIPE
REINF	REINFORCE(D)
REQ. —	REQUIRED
R.J. —	RESTRAINT JOINT
	RAW WATER
SCHED.	SCHEDULE
	——————————————————————————————————————
51	SEI 110 17(IVI
JIL.	JILLL
	TOP TO BE ABANDONED
T.B.A. — T.B.R. —	TO BE REMOVED
T.R. —	TO BE REMOVED TO REMAIN
	TAPPING SLEEVE AND VALVE
TYP. —	TAPPING SLEEVE AND VALVE
	- UNLESS NOTED OTHERWISE
VCP —	VITRIFIED CLAY PIPE
VERT. —	VIIIIII CLAT THE VERTICAL
V	VALVE VAULT
w ——	WATER LINE
WLM —	WATER LINE MARKER
WM	WATER METER
WS	WATER SERVICE LINE
UE —	- UNDERGROUND ELECTRIC
DB	DIRECTIONAL BORE

LEGEND



⊙ EX. FIRE HYDRANT

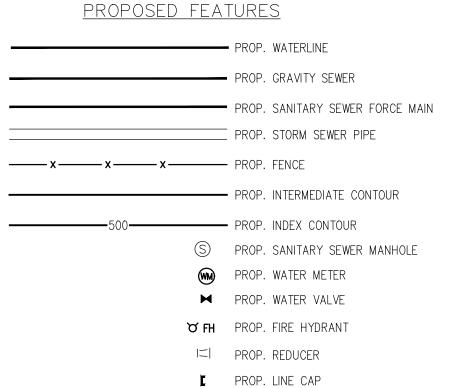

UTILITIES

TELEPHONE : WINDSTREAM COMMUNICATIONS

IRVINE, KY 40336 PHONE (606)-723-0311 <u>POWER :</u> KENTUCKY UTILITIES

1 QUALITY STREET

LEXINGTON, KY 40507

2640 IRONWORKS RD

WINCHESTER, KY 40391

PHONE (859) 744 4251

PHONE (800)-981-0600

<u>POWER:</u> CLARK ENERGY COOPERATIVE

<u>POWER :</u> JACKSON ENERGY

FIBER OPTIC : WINDSTREAM COMMUNICATIONS PHONE (606) XXX-XXXX

IRVINE COMMUNITY TELEVISION, INC. 251 BROADWAY IRVINE, KY PHONE (606)723-4240

GAS : COLUMBIA GAS OF KENTUCKY 115 JACKSON CEMETERY ROAD 2001 MERCER ROAD LEXINGTON, KY 40511 CEO KIMERA COLE PHONE (800) 432-9345

> ESTILL COUNTY WATER DISTRICT 76 CEDAR GROVE ROAD IRVINE, KY 40336 AUDREA MILLER (GENERAL MANAGER) PHONE (606)723-3795

SANITARY SEWER:

ALAN R. ROBINSON 23,414

SHEET NUMBER


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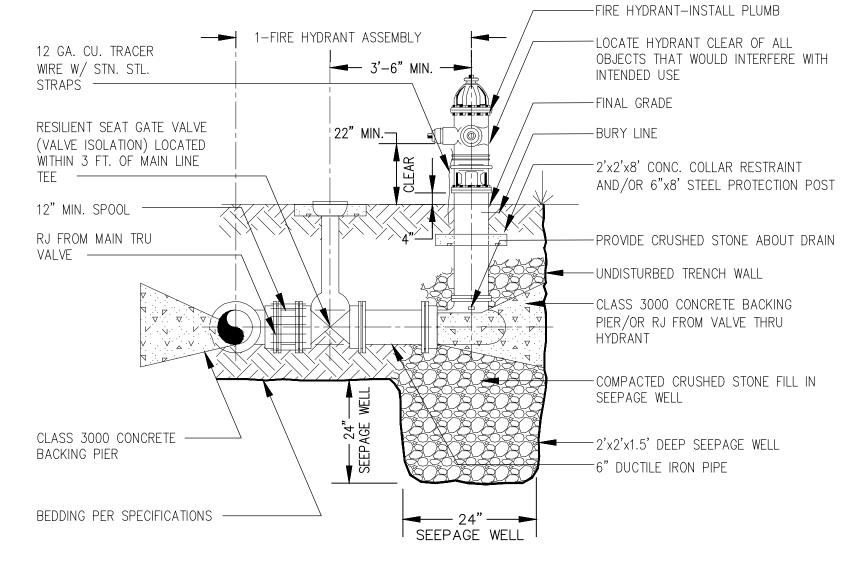


NOTES: TYPICAL ALL CREEK CROSSINGS VERTICAL BENDS MAY BE REQUIRED AT CREEK CROSSINGS. CONTRACTOR TO INSTALL WATER MAIN EXTRA DEPTH, AS NECESSARY TO FIT CREEK CHANNEL. DURING THE CONSTRUCTION OF THE CROSSING, NO MATERIAL MY BE PLACED IN THE STREAM OR IN THE FLOOD PLAIN OF THE STREAM TO FORM CONSTRUCTION PADS, COFFER DAMS, ACCESS ROADS, ETC. THE TRENCH SHALL BE BACKFILLED AS CLOSELY AS POSSIBLE TO THE ORIGINAL CONTOUR. ALL EXCESS MATERIAL FROM THE CONSTRUCTION OF THE TRENCH SHALL BE DISPOSED OF OUTSIDE THE FLOOD PLAIN. FOR SUBFLUMAL CROSSINGS OF ERODIBLE CHANNELS. THERE SHALL BE AT LEAST THIRTY (30) INCHES CLEAR TO THE TOP OF THE PIPE OR CONDUIT AT ALL POINTS. FOR SUBFLUMAL CROSSINGS OF NONERODIBLE CHANNELS, THERE SHALL BE AT LEAST SIX (6) INCHES OF CLEAR COVER ABOVE THE TOP OF THE PIPE OR CONDUIT AT ALL POINTS, AND THE PIPE OR CONDUIT SHALL BE ENCASED ON ALL SIDES BY AT LEAST SIX (6) INCHES OF CONCRETE. THE WEIGHT OF A PIPE AND ITS CONTENTS DURING NORMAL OPERATING CONDITIONS AT ALL POINTS MUST EXCEED THAT OF AN EQUAL VOLUME OF WATER.


HORIZONTAL DIRECTION DRILL CROSSING DETAIL

NOT TO SCALE



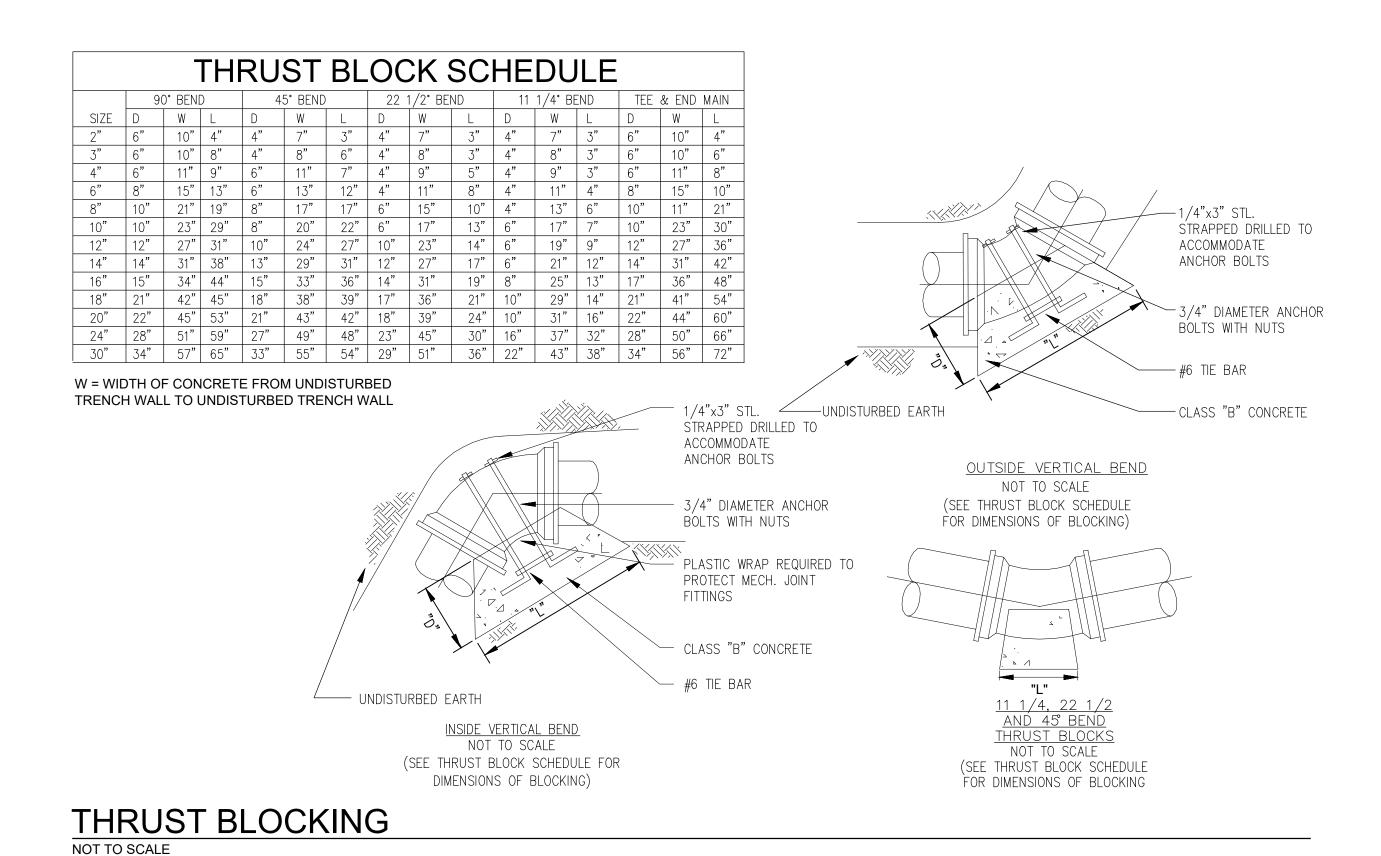

FIRE HYDRANT SETTING NOT TO SCALE

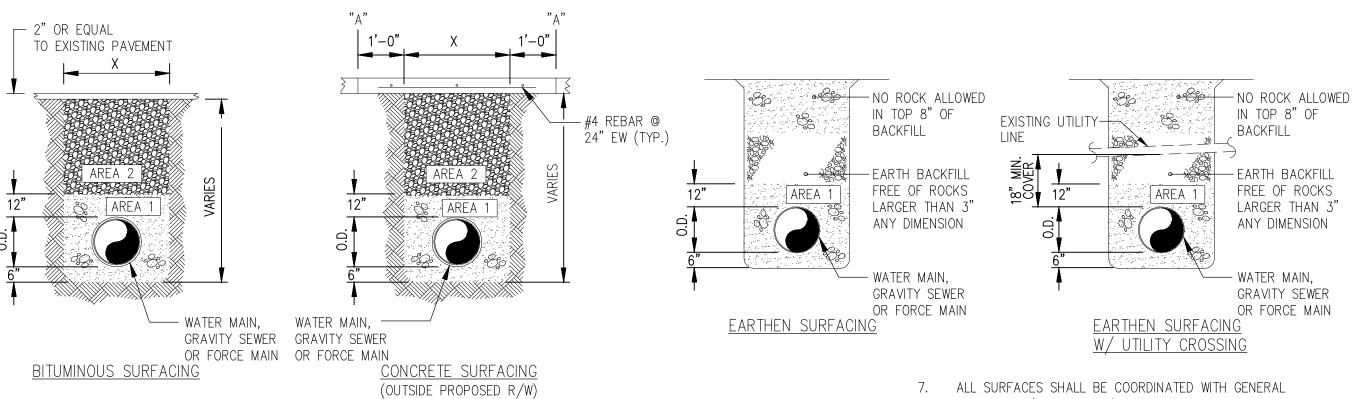

1. AREA 1 MATERIAL: WATER MAIN, GRAVITY SEWER AND FORCE MAIN = NO. 9 CRUSHED STONE.

NOTES:

- 2. AREA 2 = NO., 9 CRUSHED STONE. CONTRACTOR SHALL BE RESPONSIBLE FOR MAINTAINING THE TRENCH SURFACE IN A CONDITION SUITABLE FOR VEHICULAR
- 3. REPLACE BITUMINOUS PAVEMENT WITH SAME TYPE AND THICKNESS (2" MIN.) AS EXISTING PAVEMENT.
- 4. IF ROCK IS ENCOUNTERED, A MINIMUM OF 6" NO. 9 CRUSHED STONE MUST BE PLACED UNDER THE ENCASEMENT PIPE (IF OPEN CUT).
- 5. X = MAX. WIDTH OF TRENCH AT SURFACE UNDER NORMAL CONDITIONS (2' + PIPE O.D.).
- 6. FROM POINTS "A" TO NEAREST JOINT OR BREAK IN PAVEMENT MUST BE AT LEAST SIX (6) FEET OR MORE, IF LESS THAN SIX (6) FEET REMOVE PAVEMENT TO JOINT OR BREAK AND REPLACE ENTIRE SLAB.

7. ALL SURFACES SHALL BE COORDINATED WITH GENERAL CONTRACTOR'S ROADWAY/PAVING SCHEDULE.
SURFACES SHALL REMAIN IN DRIVABLE CONDITIONS WHERE APPLICABLE AND COST OF TEMPORARY PAVING AND FOR FINAL PAVING SHALL BE INCLUDED IN THE COST PER LF OF PIPE.



PIPE BEDDING AND BACKFILLING NOT TO SCALE

SHEET NUMBER

BY: DATE:

SCALE: N.T.S.

DESIGNED BY: ARR

DRAWN BY: WBD

CHECKED BY: ARR

ND PROJECT NO: 25010

DATE: JULY 2025

CAD DWG ID: JOB 25010 HARGET CR WL

WATER DISTRIC
76 CEDAR GROVE RO,
IRVINE, KENTUCKY

STANDARD DETAILS
HARGETT CREEK CROSSING
WATERLINE REPLACEMENT



