DATA REQUEST

Please provide a copy of all documents that you intend to use at a hearing on the merits in this matter.

RESPONSE

The Company has not determined which, if any, documents it will use at the hearing in this matter. Kentucky Power will seasonably supplement this response upon identifying any such documents. Kentucky Power reserves the right to use any document of record in this case at the hearing.

Witness: Ranie K. Wohnhas

DATA REQUEST

2

Please provide a copy of all workpapers prepared in conjunction with or used to support the Wohnhas Testimony and/or any response to a request for information propounded by either Riverside or Commission Staff.

RESPONSE

Please see KPCO_R_Riverside_1_2_Attachment1.xlsx which is an Excel copy of Exhibit RKW-1 filed in this case. See also the Company's response to the Commission Staff's request for information two and three filed simultaneously with the Riverside responses, June 1, 2018.

Witness: Ranie K. Wohnhas

DATA REQUEST

Please provide a copy of all correspondence, e-mails, memoranda,

agreements, and similar documents between or involving Kentucky Power and Riverside or Riverside's predecessors-in-interest with respect

to the facilities at issue.

RESPONSE

See KPCO_R_Riverside_1_3_Attachment1.pdf for the requested information.

Witness: Ranie K. Wohnhas



E J Clayton 04/24/2001 08:21 AM

To:

David M Roush/OR3/AEPIN@AEPIN, Errol K Wagner/AS1/AEPIN@AEPIN

cc:

Subject: Re: Riverside energization date

Below is the customer's estimated date for commercial operation. Any updates on special

------ Forwarded by E J Clayton/CH1/AEPIN on 04/24/2001 08:14 AM ------

Bill.Hanley@dynegy.com on 04/23/2001 01:56:56 PM

To:

ejclayton@aep.com

cc:

Subject: Re: Riverside energization date

EJ,

The date is tentative, but we are hoping to have the first unit complete with testing and available for commercial operation on June 16th.

Bill

ejclayton@aep.com on 04/20/2001 10:21:00 AM

To: Bill.Hanley@dynegy.com

CC:

Subject: Re: Riverside energization date

Bill

Do you have a startup date for commercial operation of facility?

Bill.Hanley@dynegy.com on 04/19/2001 04:19:27 PM


To: ejclayton@aep.com

CC:

Subject: Riverside energization date

EJ,

KPSC Case No. 2017-00472 Riverside's First Set of Data Requests Dated May 18, 2018 Item No. 3 Attachment 1 Page 2 of 89

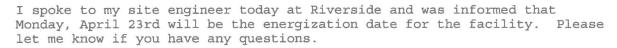

Bill

KPSC Case No. 2017-00472 Riverside's First Set of Data Requests Dated May 18, 2018 Item No. 3 Attachment 1 Page 3 of 89

American Electric Power 1701 Central Avenue Ashland, KY 41105-1428



April 20, 2001

Bill Hanley Riverside Generating Company, LLC 1000 Louisiana Street Suite 5800 Houston, TX, 77002-5050

Dear Bill,

Enclosed for your records is a fully executed service agreement. Please call anytime at (606) 327-1137 should you have questions, comments, etc.

Sincerely,

E. J. Clayton

AEP Customer Services

KPSC Case No. 2017-00472 Riverside's First Set of Data Requests Dated May 18, 2018 Item No. 3 Attachment 1 Page 4 of 89

.is Contract, entered into this 27th day of March 2001, by and between Kentucky Power Company dba American Electric Power, hereafter called the Company, and Riverside Generating Company, LLC, 1000 Louisiana Street, Suite 5800, Houston, TX, 77002-5050, or his or its heirs, successors or assigns, hereafter called the Customer,

Witnesseth:

For and in consideration of the mutual covenants and agreements hereinafter contained, the parties hereto agree with each other as follows:

The Company agrees to furnish to the Customer, during the term of this Contract, and the Customer agrees to take from the Company, subject to Company's standard Terms and Conditions of Service as regularly filed with the <u>Public Service Commission of Kentucky</u>, all the electric energy of the character specified herein that shall be purchased by the Customer in the premises located at <u>Rt. 2</u>, <u>Box 296</u>, <u>Catlettsburg</u>, <u>KY 41129</u>.

The Company is to furnish and the Customer is to take electric energy under the terms of this Contract for an initial period of $\underline{2}$ month(s) from the time such service is commenced, and continuing thereafter until terminated upon $\underline{0}$ months' written notice given by either party of its intention to terminate the Contract. The date that service shall be deemed to have commenced under this Contract shall be the date service is energized.

The electric energy delivered hereunder shall be alternating current at approximately 345000 volts, 3-wire, 3-phase, and it shall be delivered at termination point of customers 345 kV circuit located in the AEP Baker 345 kV Station, which shall constitute the point of delivery under this Contract. The said electric energy shall be delivered at reasonably close maintenance to constant potential and frequency, and it shall be measured by a meter or meters owned and installed by the Company and located at AEP Baker 345 kV Electrical Station.

The Customer acknowledges that the Customer may be eligible to receive service under more than one of the Company's schedules and that such options have been explained to the Customer. The Customer and Company agree that the Customer has chosen to receive service under the provisions of the Company's Tariff **QUANTITY POWER - TRANSMISSION**, code <u>360</u>. The Customer agrees to pay the Company monthly for electric energy delivered hereunder at the rates and under the provisions of the Company's Tariff

IANTITY POWER - TRANSMISSION, code 360, as regularly filed with the Public Service Commission of Kentucky, as long as a schedule is in effect. In the event that the tariff chosen by the Customer is replaced by a new or revised tariff incorporating different rates or provisions, or both, the Company and Customer understand and agree that the Company will continue to provide service, and the Customer will continue to take service, under this Contract, subject to such changed provisions, and that the Customer will pay for such service at the new rates on and after the date such rates become effective.

The Customer's contract capacity under the tariff named herein is hereby fixed at 2,300kW. If a time-of-day demand is available under the tariff and is selected by the Customer, the reservation of capacity aforementioned shall be the peak period reservation of capacity and shall determine the tariff's minimum monthly billing demand. The amount of capacity requested during the off-peak period is 2300 kW.

There are no unwritten understandings or agreements relating to the service hereinabove provided. This Contract cancels and supersedes all previous agreements, relating to the purchase by Customer and sale by Company of electric energy at Customer's premises as referred to above, on the date that service under this Contract commences. This Contract shall be in full force and effect when signed by the authorized representatives of the parties hereto.

An addendum for temporary service is attached hereto and is part of this Contract.		
Kentucky Power Company	Riverside Generating Company, LLC	
By: Marla. Demolelfurge	By: Mu M	
Mark A. Gundelfinger	C.P. Manalac	
Title: Manager	Title: Vice President	
Date: 4/18/01	Date: March 27, 2001	
,		

KPSC Case No. 2017-00472 Riverside's First Set of Data Requests Dated May 18, 2018 Item No. 3 Attachment 1 Page 5 of 89

ADDENDUM TO CONTRACT FOR ELECTRICAL SERVICE

Application of this agreement under tariff QP is for temporary service only, with expiration date not to exceed customer specified commercial 'in service' date for facility.

Kentucky Power Company

By: Marl a. Dundelfinger

Mark A. Gundelfinger

Title: Manager

Date: 4/18/01

Riverside Generating Company, LLC

C Q M 1

ritle: Vice - Paps . West

Date: March 27, 2001

KPSC Case No. 2017-00472 Riverside's First Set of Data Requests Dated May 18, 2018 Item No. 3 Attachment 1 Page 6 of 89

From: Errol K Wagner on 07/06/2001 01:05 PM

To: Kevin F Duffy/OR2/AEPIN@AEPIN

cc: E J Clayton/CH1/AEPIN@AEPIN, David M Roush/OR3/AEPIN@AEPIN

Subject: Re: Service Agreement

Privileged

David M Roush

David M Roush

To: Errol K Wagner/AS1/AEPIN@AEPIN, Kevin F Duffy/OR2/AEPIN@AEPIN, E J

07/06/01 12:41 PM cc: Daniel R Kinney/OR4/AEPIN@AEPIN

Subject: Re: Service Agreement

Privileged

--- Forwarded by David M Roush/OR3/AEPIN on 07/06/01 12:39 PM ---

Kevin F Duffy To: Errol K Wagner/AS1/AEPIN@AEPIN

07/06/01 11:10 AM cc: David M Roush/OR3/AEPIN@aepin, E J Clayton/CH1/AEPIN@aepin

Subject: Re: Service Agreement

Privileged

This e-mail message from the Legal Department of American Electric Power is for the sole use of the intended recipient(s) and may contain confidential and privileged information. Any unauthorized review, use, disclosure or distribution is prohibited. If you are not the intended recipient, please contact the sender by reply e-mail and destroy all copies of the original message.

--- Forwarded by David M Roush/OR3/AEPIN on 07/06/01 12:39 PM ----

Errol K Wagner To: David M Roush/OR3/AEPIN@AEPIN, Kevin F Duffy/OR2/AEPIN@AEPIN

07/06/01 10:12 AM cc: E J Clayton/CH1/AEPIN@AEPIN

Subject: Re: Service Agreement

Privileged

---- Forwarded by Errol K Wagner/AS1/AEPIN on 07/06/01 09:51 AM -----

E J Clayton

To: Errol K Wagner/AS1/AEPIN@AEPIN

07/06/01 09:09 AM

Subject: Re: Service Agreement

Looks like this customer won't need the special agreement for backup power.

Do you have any problem with leaving them on their current QP Temporary Rate until their Illinois Power Contract is implemented September 1?

To:

ejclayton@aep.com

cc:

Subject: Re: Service Agreement

EJ,

It appears that based on recent developments, we will no longer need the special agreement that we had previously discussed. Jolly Hayden (Dynegy) has been working with Daniel Kinney and others with AEP in Columbus to allow us to use IP MW to serve Riverside's aux power needs on the necessary transmission becomes available on September 1st. We have been accepted on our request beginning Sept. 1st. This leaves us needing to still cover July and August with the temporary QP agreement we already have in place that expires once the facility is commercial, currently we estimate that Riverside will be commercial in early August. I would like to amend or change the temporary QP agreement to allow us to go thru August whether Riverside is commercial or not.

Thanks for your help with this matter.

Bill

ejclayton@aep

.com To: Bill.Hanley@dynegy.com

CC:

07/05/01 Subject: Service Agreement

02:10 PM

KPSC Case No. 2017-00472 Riverside's First Set of Data Requests Dated May 18, 2018 Item No. 3 Attachment 1 Page 8 of 89

Bill

. . . .

I received your message on the temporary service agreement. From your description, you would like to extend the temporary agreement to August 31, 2001, or until an agreement is in place for 5 MW from Illinois Power. Would you still need the special agreement discussed previously? A special agreement is being developed for implementation on your commercial start date.

date. E. J. Clayton (606) 327-1137

KPSC Case No. 2017-00472 Riverside's First Set of Data Requests Dated May 18, 2018 Item No. 3 Attachment 1 Page 9 of 89



Bill.Hanley@dynegy.com on 04/02/2001 03:56:43 PM

To:

ejclayton@aep.com

cc:

Subject: Re: Contracts

FYI, just let me know when you have an energization date for Riverside so that I can pass it on to EJ Clayton at AEP.

Tnx.

Bill

ejclayton@aep.com on 04/02/2001 08:50:46 AM

To: Bill.Hanley@dynegy.com

cc:

Subject: Contracts

Bill

You should be receiving original agreements in the mail for the Riverside Generating 345 kV Service. Please authorize these and return to my attention and I will forward executed originals to your attention. Since I have the authorized fax agreement from you, I can request energizing of service anytime. I am currently waiting for your request on a service date.

Dated May 18, 2018
Item No. 3
Attachment 1
Page 10 of 89

Dynegy Inc 1000 Louislana Street, Suite 5800 Houslon, Texas 77002 Phone 713.507.6400



DYNEGY

Date:

March 29, 2001

To:

EJ Clayton

Fax:

606-327-1246

Subject:

Start-up Power

From:

Bill Hanley

Phone:

713-767-8635

Fax:

713-767-8506

Pages:

3

EJ,

Attached is an executed (by Riverside) copy of our start-up power agreement. Once Mark Gundelfinger signs the agreement, please fax back a copy to me at 713-767-8506.

The energization date is undetermined at this time. We will keep you informed about the date once it has been established.

Dynegy's Project Manager for Riverside has verified that BE&K's construction power feed is isolated from the 345 kV service addressed by the attached agreement.

Please call me at (713) 767-8635 if you have any questions.

Sincerely,

Bill Hanley

MAR 29 '01 KPSC2case No. 12017-00412 P. 02 Riverside's First Set of Data Requests

Set of Data Requests
Dated May 18, 2018
Item No. 3
Attachment 1
Page 11 of 89

(This Contract, entered into this 27th day of March 2001, by and between Kentucky Power Company des American Electric Cower, hereafter called the Company, and Riverside Generating Company, LLC, 1000 Louisians Street, Suite 5800, Houston, TX. 77007-5050, or his or its hairs, successors or and gus, hereafter called the Customer.

Witnesseth:

For and in consideration of the munual covenants and agreements hareinafter contained, the parties have agree with each other as follows:

The Company agrees to furnish to the Comment, during the term of this Contract, and the Customer agrees to take from the Company, subject to Company's standard Terms and Conditions of Service as regularly flied with the <u>Public Service Commission of Kantucky</u>, all the electric energy of the character specified herein that shall be purchased by the Customer in the premises located at <u>R4. 2.</u>

Box 296. Catintishurs. KY 41129.

The Company is to furnish and the Customer is to take electric energy under the terms of this Contract for an initial period of 2 months; from the time such service is commenced, and continuing thereafter until terminated upon 0 months; written notice given by citizen party of its intention to terminate the Contract. The date that service shall be decined to have commenced under this Contract shall be the date service is exercised.

The electric energy delivered hereunder shall be alternating current at approximately 345000 volts, 2-wire, 2-phase, and it shall be delivered at termination point of engineers 345 kV circuit located in the AEP Baker 345 kV Starton, which shall contribute the point of delivery under this Contract. The said electric energy shall be delivered at reasonably close maintenance to constant potential and frequency, and it shall be measured by a moter or maters owned and installed by the Company and located at AEP Baker 345 kV.
Electrical Station.

The Customer asknowledges that the Customer may be eligible to receive service under more than one of the Company's schedules and that such options have been explained to the Customer. The Customer and Company agree that the Customer has chosen to receive service under the provisions of the Company's Tariff <u>OUANTITY FOWER - TRANSMISSION</u>, code <u>560</u>. The Customer agrees to pay the Company monthly for electric energy delivered hereunder at the rates and under the provisions of the Company's Tariff <u>OUANTITY FOWER - TRANSMISSION</u>, code <u>560</u>, as regularly filed with the <u>Public Service Commission of Kentucky</u>, as long as that schedule is in effect. In the event that the tariff chosen by the Customer is replaced by a new or revised tariff incorporating different rates or providence, or both, the Company and Customer understand and agree that the Company will continue to provide service, and the Customer will continue to take service, under this Contract, subject to such changed provisions, and that the Customer will pay for such service at the new rates on and after the date such rates become effective.

The Customer's contract capacity under the tariff named herein is hereby fixed at 2.300kW. If a time-of-day demand is available under the tariff and is selected by the Customer, the reservation of capacity aforementioned shall be the peak period reservation of capacity and shall determine the tariff's minimum monthly billing demand. The amount of capacity requested during the off-neak period is 1300 kW.

There are no unwritten understandings or agreements relating to the service hereinabove provided. This Contract emeels and supersedes all previous agreements, relating to the purchase by Customer and sale by Company of electric energy at Customer's premises as referred to above, on the date that service under this Contract commences. This Contract shall be in full force and offers when signed by the authorized representatives of the parties bareto.

Kentucky Power Company	Riverside Generating Company, LLC
Ву:	By: Thomas G. Arles
Mark A. Gundelfinger	THOMAS G. ATER
Title: Manager	Title: VILL PESSIOFNI
Date:	Date: 3-29-51

Item No. 3 Attachment 1 Page 12 of 89

ADDENDUM TO CONTRACT FOR ELECTRICAL SERVICE

Application of this agreement under tariff QP is for temporary service only, with expiration date not to exceed customer specified commercial 'in service' date for facility.

Kentucky Power Company	Riverside Generating Company, LLC
Ву	By: Thom C. Ada
Mark A. Gundelfinger	THO MAS G. ATLE
Tide: Manager	TILLE PRESIDENT
Date:	Date: 3-28-01

KPSC Case No. 2017-00472 Riverside's First Set of Data Requests Dated May 18, 2018 Item No. 3 Attachment 1 Page 13 of 89

American Electric Power 1701 Central Avenue Ashland, KY 41105-1428



March 28, 2001

Bill Hanley Dynergy Engineering, Inc. 1000 Louisiana Street, Suite 5800 Houston, TX 77002-5050

Dear Bill,

Please authorize both copies of the enclosed electrical services agreement and return the completed forms to my attention in the enclosed envelope. An executed agreement will be returned to your attention.

For your review, I have also included the Kentucky Terms and Conditions for Tariff QP. Should you have any questions, please contact me at (606) 327-1137.

Sincerely,

E. J. Clayton

AEP Customer Services

KPSC Case No. 2017-00472
Riverside's First Set of Data Requests

AF Dated May 18, 2018
Item No. 3

AF CAMBChment 1

Fage 14 of 89

FAX Transmission

From:

E. J. Clayton

American Electric Power

Questions?

Call (606) 327-1137 Fax (606) 327-1246 1701 Central Avenue Ashland, KY 41105

To:

Bill Hanley

Company:

Dynergy Engineering, Inc.

Address:

1000 Louisiana Street, Suite Fax: 713-767-8506

5800 Houston TX 77002

Date:

March 28, 2001

Time:

10:06AM

:Pages (including this one)

Subject:

Riverside Service

Agreement

Bill

If the information on the attached service agreement is correct, please authorize and return to my attention at the fax number above.

Please specify a date for energizing the service.

Also, for safety reasons, please provide a brief written statement of the measures taken to separate the existing distribution construction power service at the facility, from the 345 kV service addressed by this agreement.

Upon receipt of the faxed agreement confirmation, I will issue original contract forms to your attention for authorization and return in the mail.

E. J. Clayton, P.E.

AEP Customer Services

KPSC Case No. 2017-00472 Riverside's First Set of Data Requests Dated May 18, 2018 Item No. 3 Attachment 1 Page 15 of 89

This Contract, entered into this 27th day of March 2001, by and between Kentucky Power Company dba American Electric Power, hereafter called the Company, and Riverside Generating Company, LLC, 1000 Louisiana Street, Suite 5800, Houston, TX, 77002-5050, or his or its heirs, successors or assigns, hereafter called the Customer,

Witnesseth:

For and in consideration of the mutual covenants and agreements hereinafter contained, the parties hereto agree with each other as follows:

The Company agrees to furnish to the Customer, during the term of this Contract, and the Customer agrees to take from the Company, subject to Company's standard Terms and Conditions of Service as regularly filed with the <u>Public Service Commission of Kentucky</u>, all the electric energy of the character specified herein that shall be purchased by the Customer in the premises located at <u>Rt. 2</u>, <u>Box 296</u>, <u>Catlettsburg</u>, <u>KY 41129</u>.

The Company is to furnish and the Customer is to take electric energy under the terms of this Contract for an initial period of $\underline{2}$ month(s) from the time such service is commenced, and continuing thereafter until terminated upon $\underline{0}$ months' written notice given by either party of its intention to terminate the Contract. The date that service shall be deemed to have commenced under this Contract shall be the date service is energized.

The electric energy delivered hereunder shall be alternating current at approximately 345000 volts, 3-wire, 3-phase, and it shall be delivered at termination point of customers 345 kV circuit located in the AEP Baker 345 kV Station, which shall constitute the point of delivery under this Contract. The said electric energy shall be delivered at reasonably close maintenance to constant potential and frequency, and it shall be measured by a meter or meters owned and installed by the Company and located at AEP Baker 345 kV Electrical Station.

The Customer acknowledges that the Customer may be eligible to receive service under more than one of the Company's schedules and that such options have been explained to the Customer. The Customer and Company agree that the Customer has chosen to receive service under the provisions of the Company's Tariff **QUANTITY POWER - TRANSMISSION**, code **360**. The Customer agrees to pay the Company monthly for electric energy delivered hereunder at the rates and under the provisions of the Company's Tariff **QUANTITY POWER - TRANSMISSION**, code **360**, as regularly filed with the **Public Service Commission of Kentucky**, as long as that schedule is in effect. In the event that the tariff chosen by the Customer is replaced by a new or revised tariff incorporating different rates or provisions, or both, the Company and Customer understand and agree that the Company will continue to provide service, and the Customer will continue to take service, under this Contract, subject to such changed provisions, and that the Customer will pay for such service at the new rates on and after the date such rates become effective.

The Customer's contract capacity under the tariff named herein is hereby fixed at 2.300kW. If a time-of-day demand is available under the tariff and is selected by the Customer, the reservation of capacity aforementioned shall be the peak period reservation of capacity and shall determine the tariff's minimum monthly billing demand. The amount of capacity requested during the off-peak period is 2300 kW.

There are no unwritten understandings or agreements relating to the service hereinabove provided. This Contract cancels and supersedes all previous agreements, relating to the purchase by Customer and sale by Company of electric energy at Customer's premises as referred to above, on the date that service under this Contract commences. This Contract shall be in full force and effect when signed by the authorized representatives of the parties hereto.

An addendum for temporary service is attac	ched hereto and is part of this Contract.
Kentucky Power Company	Riverside Generating Company, LLC
Ву:	Ву:
Mark A. Gundelfinger	
Title: Manager	Title:
Date:	Date:


KPSC Case No. 2017-00472 Riverside's First Set of Data Requests Dated May 18, 2018 Item No. 3 Attachment 1 Page 16 of 89

ADDENDUM TO CONTRACT FOR ELECTRICAL SERVICE

Application of this agreement under tariff QP is for temporary service only, with expiration date not to exceed customer specified commercial 'in service' date for facility.

Kentucky Power Company	Riverside Generating Company, LLC
Ву:	Ву:
Mark A. Gundelfinger	· · · · · · · · · · · · · · · · · · ·
Title: Manager	Title:
Date:	Date:

KPSC Case No. 2017-00472 Riverside's First Set of Data Requests Dated May 18, 2018 Item No. 3 Attachment 1 Page 17 of 89

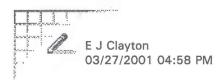

To:

Errol K Wagner/AS1/AEPIN@AEPIN, David M Roush/OR3/AEPIN@AEPIN

cc:

Subject: Riverside Generating(Dynergy)


Temporary Service Agreement

Draft copy of temporary agreement.



Riverside Generating Service Agreement.

KPSC Case No. 2017-00472 Riverside's First Set of Data Requests
Dated May 18, 2018 Item No. 3 Attachment 1 Page 18 of 89

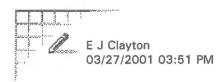

To:

Robert W Wells/AS1/AEPIN@AEPIN

cc:

Subject: Riverside Generating LLC
Please enter metering information for billing per the following order. This customer is requesting service by March 30 and will be served under QP Transmission(Tariff 360). TRKI OSP953 03 01011 TRK SUMMARY INQ 03/27/01 14:30:06 S90GSX66 SUB 013 ORDER 032705681 TYPE NI02 NEW INST - METER ONLY XREF CC STATUS PR APPROVED CS MKTG ENGN LINE MTR L LNK RMK CUST NM: RIVERSIDE GENERATING COMPANY, LLC ACCT NO 034 873 686 0 RM SERV ADDR: RT 2 BOX 296 CITY CATLETTSBURG PH 606 686 1098 B WORK ORDER/TYPE / CUST CONTACT NM BILL HANLEY PHONE NBR 713 767 8635 W EST CNSTR COST TOTAL E.A.R. EST TOTAL COST INCREASED E.A.R. PRINT STATUS PROP LOC/POLE # REQUESTED / READY DATE 03/30/01 LAST PRINT LOC ORDER ORIG BY / DATE CLAYTOE / 03/27/01 ORDER UPDATED BY / DATE CLAYTOE / 03/27/01 ORDER COMPLTD BY / DATE / SCHD ST DATE ACTUAL ST DATE COMPL DATE LINE METER PHYS WORK COMPL DATE SERVICE EFFECT DATE DESC: INPUT METER FOR AEP BILLING SYSTEM UNDER CONTRACT QP RATE(2300 KW) }
NEXT DATAO9-REQ 10-TRACKDTL 11-TRKPRMPT 12-CANCEL

Page: 1 Document Name: untitled

09-REQ

Item No. 3 Attachment 1

TRKI OSP953 03 01011 TRK SUMMARY INQ 03/27/01 14:30:06 S90GSX66 Page 19 of 89
B 013 ORDER 032705681 TYPE NIO2 NEW INST - METER ONLY XREF CC
STATUS PR APPROVED CS MKTG ENGN LINE MTR L LNK RMK
CUST NM: RIVERSIDE GENERATING COMPANY, LLC ACCT NO 034 873 686 0 RM
SERV ADDR: RT 2 BOX 296 CITY CATLETTSBURG
PH 606 686 1098 B WORK ORDER/TYPE /
CUST CONTACT NM BILL HANLEY PHONE NBR 713 767 8635 W
EST CNSTR COST TOTAL E.A.R.
EST TOTAL COST INCREASED E.A.R.
PRINT STATUS PROP LOC/POLE #
REQUESTED / READY DATE 03/30/01 LAST PRINT LOC
ORDER ORIG BY / DATE CLAYTOE / 03/27/01
ORDER UPDATED BY / DATE CLAYTOE / 03/27/01
ORDER COMPLTD BY / DATE /
SCHD ST DATE ACTUAL ST DATE COMPL DATE
LINE
METER SUMMER SOLER BATE
PHYS WORK COMPL DATE
SERVICE EFFECT DATE
DESC: INPUT METER FOR AEP BILLING SYSTEM UNDER CONTRACT QP RATE(2300 KW
)
EVT DATA

10-TRACKDTL 11-TRKPRMPT 12-CANCEL

Date: 3/27/ 1 Time: 02:30:09 PM

KPSC Case No. 2017-00472 Riverside's First Set of Data Requests Dated May 18, 2018 Item No. 3 Attachment 1 Page 20 of 89

Status: Submitted For Approval

DRAFT

This Contract, entered into this 27th day of March 2001, by and between Kentucky Power Company dba American Electric Power, hereafter call the Company, and Riverside Generating Company, LLC, 1000 Louisiana Street, Suite 5800, Houston, TX, 77002-5050, or his or its heirs, successors assigns, hereafter called the Customer,

Witnesseth:

For and in consideration of the mutual covenants and agreements hereinafter contained, the parties hereto agree with each other as follows:

The Company agrees to furnish to the Customer, during the term of this Contract, and the Customer agrees to take from the Company, subject to Company's standard Terms and Conditions of Service as regularly filed with the <u>Public Service Commission of Kentucky</u>, all the electric energy of the character specified herein that shall be purchased by the Customer in the premises located at <u>Rt. 2</u>, <u>Box 296</u>, <u>Catlettsburg</u>, <u>KY 41129</u>.

The Company is to furnish and the Customer is to take electric energy under the terms of this Contract for an initial period of $\underline{2}$ month(s) from th time such service is commenced, and continuing thereafter until terminated upon $\underline{0}$ months' written notice given by either party of its intention to terminat Contract. The date that service shall be deemed to have commenced under this Contract shall be $\underline{the date service is energized}$.

The electric energy delivered hereunder shall be alternating current at approximately 345000 volts, 3-wire, 3-phase, and it shall be delivered at termination point of customers 345 kV circuit located in the AEP Baker 345 kV Station, which shall constitute the point of delivery under this Contra The said electric energy shall be delivered at reasonably close maintenance to constant potential and frequency, and it shall be measured by a meter or met owned and installed by the Company and located at AEP Baker 345 kV Electrical Station.

The Customer acknowledges that the Customer may be eligible to receive service under more than one of the Company's schedules and that suc options have been explained to the Customer. The Customer and Company agree that the Customer has chosen to receive service under the provisions of t Company's Tariff **QUANTITY POWER - TRANSMISSION**, code 360. The Customer agrees to pay the Company monthly for electric energy delivere hereunder at the rates and under the provisions of the Company's Tariff **QUANTITY POWER - TRANSMISSION**, code 360, as regularly filed with the **Public Service Commission of Kentucky**, as long as that schedule is in effect. In the event that the tariff chosen by the Customer is replaced by a new or revised tariff incorporating different rates or provisions, or both, the Company and Customer understand and agree that the Company will continue to prov service, and the Customer will continue to take service, under this Contract, subject to such changed provisions, and that the Customer will pay for such se at the new rates on and after the date such rates become effective.

The Customer's contract capacity under the tariff named herein is hereby fixed at 2,300kW. If a time-of-day demand is available under the tariff is selected by the Customer, the reservation of capacity aforementioned shall be the peak period reservation of capacity and shall determine the tariff's minimum monthly billing demand. The amount of capacity requested during the off-peak period is 2300 kW.

There are no unwritten understandings or agreements relating to the service hereinabove provided. This Contract cancels and supersedes all pre agreements, relating to the purchase by Customer and sale by Company of electric energy at Customer's premises as referred to above, on the date that ser under this Contract commences. This Contract shall be in full force and effect when signed by the authorized representatives of the parties hereto.

An addendum for temporary service is attached hereto and is part of this Contract.

Kentucky Power Company	Riverside Generating Company, LLC
Ву:	Ву:
Mark A. Gundelfinger	
Title: Manager	Title:
Date:	Date:

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ADDENDUM TO CONTRACT FOR ELECTRICAL SERVICE

Application of this agreement under tariff QP is for temporary service only, with expiration date not to exceed customer specified commercial 'in service' date for facility.

Kentucky Power Company	Riverside Generating Company, LLC
Ву:	Ву:
Mark A. Gundelfinger	
Title: Manager	Title:
Date:	Date:

KPSC Case No. 2017-00472 Riverside's First Set of Data Requests Dated May 18, 2018 Item No. 3 Attachment 1 Page 22 of 89



Bill.Hanley@dynegy.com on 03/27/2001 03:34:16 PM

To:

ejclayton@aep.com

Subject: Re: Issue of Start-up Power and Station Power-Riverside Generating

No special tax status.

ejclayton@aep.com on 03/27/2001 01:12:40 PM

Bill.Hanley@dynegy.com

cc:

Subject: Re: Issue of Start-up Power and Station Power-Riverside Generating

I am including the account within the Lawrence County Kentucky Tax District. Please notify if special tax status is applicable.

Bill.Hanley@dynegy.com on 03/27/2001 02:50:39 PM

To: ejclayton@aep.com

CC:

Subject: Re: Issue of Start-up Power and Station Power-Riverside Generating

EJ,

Local contact for Riverside - Dariusz Rekowski (Plant Supervisor) 606-686-1098. I am awaiting a call back from my engineer on separating existing construction electrical service from the back up power service. I'll call you as soon as I hear back from him today.

Bill

ejclayton@aep.com on 03/27/2001 12:31:56 PM

To: Bill.Hanley@dynegy.com

CC:

KPSC Case No. 2017-00472 Riverside's First Set of Data Requests Dated May 18, 2018 Item No. 3 Attachment 1 Page 23 of 89

Subject: Re: Issue of Start-up Power and Station Power-Riverside Generating

Bill

I need a local contact and phone number for the facility, to use in our billing system.

Also, please provide brief explanation for separating the existing construction electrical service and the 345 kV service used for back-up power.

Bill.Hanley@dynegy.com on 03/26/2001 09:58:43 AM

To: Jim.Berra@dynegy.com

cc: deguill@aep.co, doho@dynegy.com, ejclayton@aep.com,

mksachdeva@aep.com, dgcipriany@aep.com, mchau2@aep.com,

pbjohnson@aep.com, lchutchison@aep.com

Subject: Re: Issue of Start-up Power and Station Power-Riverside Generating

Jim,

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Bill Hanley 713-767-8635

From: Jim Berra on 03/23/2001 04:53 PM

To: Bill Hanley/HOU/Dynegy@Dynegy

cc:

Subject: Issue of Start-up Power and Station Power-Riverside Generating


Bill -

Can you write an email of where we stand and where we are going on this issue, so that I can forward it back.

Or, preferably, go ahead and send a status update to all of the addressees on the below email.

Thanks, JB.

KPSC Case No. 2017-00472 Riverside's First Set of Data Requests Dated May 18, 2018 Item No. 3 Attachment 1

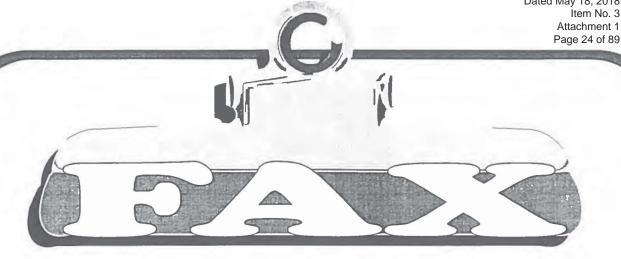

600-1335 Pax

0	ro	m	• E	5	Clayton	
			_			

Pages (with cover):___

Our FAX Number is 606/327-1246.

Message: Agreement requires customer signature be
Connection.
Estimated minimum monthly bill bosed on 750 KUA
Contract capacity is \$1,464 + applicable surcharges.
John-Unless I hear otherwise, I will assume you
are collection temporary CIAC, underground changes &
applicable agreement.
AEP AMERICAN
Problems? Call ELECTRIC POWER

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DRAFT

This Contract, entered into this <u>27th</u> day of <u>July 2001</u>, by and between <u>Kentucky Power Company</u> dba American Electric Power, hereafter called the Company, and <u>Riverside Generating Company</u>, <u>LLC</u>, <u>1000 Louisiana Street</u>, <u>Suite 5800</u>, <u>Houston</u>, <u>TX</u>, <u>77002-5050</u>, or his or its heirs, successors or assigns, hereafter called the Customer.

Witnesseth:

For and in consideration of the mutual covenants and agreements hereinafter contained, the parties hereto agree with each other as follows:

The Company agrees to furnish to the Customer, during the term of this Contract, and the Customer agrees to take from the Company, subject to Company's standard Terms and Conditions of Service as regularly filed with the <u>Public Service Commission of Kentucky</u>, all the electric energy of the character specified herein that shall be purchased by the Customer in the premises located at <u>Rt. 2</u> <u>Box 296, Catlettsburg, KY 41129</u>.

The Company is to furnish and the Customer is to take electric energy under the terms of this Contract for an initial period of $\underline{2}$ month(s) from the time such service is commenced, and continuing thereafter until terminated upon $\underline{1}$ months' written notice given by either party of its intention to terminate the Contract. The date that service shall be deemed to have commenced under this Contract shall be $\underline{the \ date \ service \ is \ energized}$.


The electric energy delivered hereunder shall be alternating current at approximately <u>7200/12470</u> volts, <u>4</u>-wire, <u>3</u>-phase, and it shall be delivered <u>?????</u>, which shall constitute the point of delivery under this Contract. The said electric energy shall be delivered at reasonably close maintenance to constant potential and frequency, and it shall be measured by a meter or meters owned and installed by the Company and located <u>?????</u>.

The Customer acknowledges that the Customer may be eligible to receive service under more than one of the Company's schedules and that such options have been explained to the Customer. The Customer and Company agree that the Customer has chosen to receive service under the provisions of the Company's Tariff LARGE GENERAL SERVICE - PRIMARY, code 244. The Customer agrees to pay the Company monthly for electric energy delivered hereunder at the rates and under the provisions of the Company's Tariff LARGE GENERAL SERVICE - PRIMARY, code 244, as regularly filed with the Public Service Commission of Kentucky, as long as that schedule is in effect. In the event that the tariff chosen by the Customer is replaced by a new or revised tariff incorporating different rates or provisions, or both, the Company and Customer understand and agree that the Company will continue to provide service, and the Customer will continue to take service, under this Contract, subject to such changed provisions, and that the Customer will pay for such service at the new rates on and after the date such rates become effective.

The Customer's contract capacity under the tariff named herein is hereby fixed at <u>750kVA</u>. If a time-of-day demand is available under the tariff and is selected by the Customer, the reservation of capacity aforementioned shall be the peak period reservation of capacity and shall determine the tariff's minimum monthly billing demand.

There are no unwritten understandings or agreements relating to the service hereinabove provided. This Contract cancels and supersedes all previous agreements, relating to the purchase by Customer and sale by Company of electric energy at Customer's premises as referred to above, on the date that service under this Contract commences. This Contract shall be in full force and effect when signed by the authorized representatives of the parties hereto.

Kentucky Power Company	Riverside Generating Company, LLC
Ву:	Ву:
Mark A. Gundelfinger	
Title: Manager	Title:
Date:	Date:

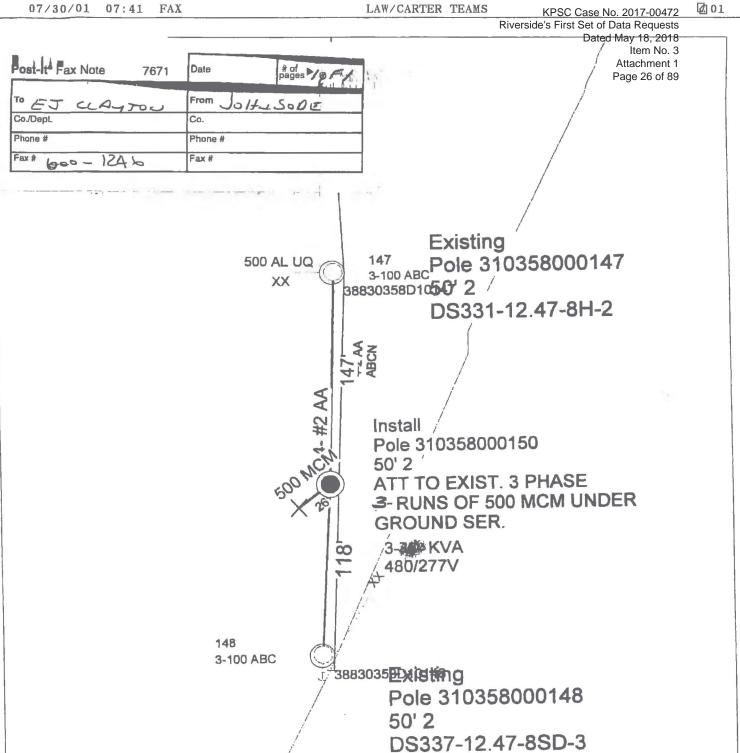

An LD-Pro® Worksketch Job Name: RIVERSIDE GENE. LLC. US ROUTE 23 CATLETTSBURG						Bucket Truck?: Y
						Truck to Site?; Y
						4 WD?: N
Location:						
Co: 03	Work Order: 011557			Sta/Circuit Name:		
OPS Order(s): SC01#039707688				Sta/Circuit Number: 0002 02		County: LAWRENCE
JU Proposal(s):			3	Voltage: 12KV		Map: 358
RW#:				Phases: 3 PHASE		Quad: 83
TWEEN.				Date: 6/22/01	Print #:	Scale: NTS
				Drawn By: JOHN SO	DDF	Page: 1 of 1

Page: 1 Document Name: untitled

Item No. 3

Attachment 1 Page 27 of 89 CNTA MCSIB1 03 01011 CONTRACT SCREEN 07/27/01 10:25:42 S90GSX66 10/30/00 037-831-184-0 ACTIVE Y B & K CONSTRUCTION CATLETTSBU 211 240 LGS SEC LC&I 17 53 CONTR EFF 10/31/00 CONTR EXPR 10/31/02 SPEC MIN AMT CD **CUST CNCT** SPEC ADDN AMT ORIG CONTR DT IRP-FIRM LD EFF BILL PER 07/24/01 TAR CD 240 ENGR NO 220 MIN BILNG DEM EXPR BIL PER 10/31/02 CANCEL NOTIF 01 MO MUL PLANT EXCLUSION ONP/TOT OFP LST CHG DT ORIG MIN BILNG DEM RIDER CONTR CAP 200.0 TRAN MTR KW **HPD** HPD CD * * MISC AGREEMENTS * * OFP **EDR'S** ONP/TOT CNTR EDR DT CD AGR NO AGR EFF DT E1 BASE DEM E2 BASE DEM ORIG AMT 0.00 E3 BASE DEM EDR TOD CD EDR NEW CUST **RURAL LINE EXT** EDR OPTION

RE MOS RE AGR NO RE MIN

SEND BILL N ACTN M

RMK REVIEW CONTRACT

PREP YOUNGK APR

REJ RSN RMK

NEXT DATA 09-APPROVE 11-REJECT 12-CANCEL

> Contact GENE Formy dural to see if they intend to Keep Service. This one of (2) existing service's at site.

Date: 7/27/ 1 Time: 10:37:40 AM

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David M Roush

03/26/2001 11:41:09 AM

To:

E J Clayton/CH1/AEPIN@AEPIN Errol K Wagner/AS1/AEPIN@AEPIN

Subject: Re: Issue of Start-up Power and Station Power-Riverside Generating



I agree that temporary QP service is what should be used for the next few months until commercial operation / the in-service date.

The contract for "black start"/station power after commercial operation (early June) may or may not have an interruptible feature. Interruptibility has not even been discussed internally.

E J Clayton



E J Clayton 03/26/2001 09:55 AM

To:

Errol K Wagner/AS1/AEPIN@AEPIN, David M Roush/OR3/AEPIN@AEPIN

CC!

Subject: Re: Issue of Start-up Power and Station Power-Riverside Generating

As per the note below, the customer is assuming that we are proceeding with the temporary QP service effective by the end of this week. If there are no issues with providing this service, please let me know and I will input the appropriate information for metering, billing, etc., and pursue customer authorization of an agreement.

E. J. aud 600-1137

----- Forwarded by E J Clayton/CH1/AEPIN on 03/26/2001 09:52 AM ----------------



Bill.Hanley@dynegy.com on 03/26/2001 09:58:43 AM

To: Jim.Berra@dvnegv.com

CC:

deguill@aep.co, doho@dynegy.com, ejclayton@aep.com, mksachdeva@aep.com, dgcipriany@aep.com, mchau2@aep.com, pbjohnson@aep.com, lchutchison@aep.com

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Bill Hanley 713-767-8635

From: Jim Berra on 03/23/2001 04:53 PM

To: Bill Hanley/HOU/Dynegy@Dynegy

CC:

Subject: Issue of Start-up Power and Station Power-Riverside Generating

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Thanks, JB.

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cc: doho@dynegy.com, JMbe@dynegy.com, ejclayton@aep.com, mksachdeva@aep.com, dgcipriany@aep.com, mchau2@aep.com, pbjohnson@aep.com, lchutchison@aep.com

Subject: Issue of Start-up Power and Station Power-Riverside Generating

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05:12 PM ------

Mohan K Sachdeva 03/14/2001 03:18 PM

To: doho@dynegy.com, JMbe@dynegy.com

cc: David_hastings@illinoispower.com, Darrell G Cipriany/OR4/AEPIN@AEPIN,
 Jay H Johnson/RO1/AEPIN@AEPIN, Max Chau/OR4/AEPIN@AEPIN, Paul B
 Johnson/OR4/AEPIN@AEPIN, E J Clayton/CH1/AEPIN@AEPIN, Larry C
 Hutchison/OR3/AEPIN@AEPIN

Subject: Issue of Start-up Power and Station Power-Riverside Generating

Section 3.2 (e) of the Interconnection and Operation Agreement between Kentucky Power Company and Riverside Generating Company, LLC states "Company shall have no obligation under this Agreement to provide construction, backup or start-up power for the Facility Site. This Agreement does not provide for the sale or purchase of Energy from

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Generating Company's Facility. Generating Company shall have the right, when permitted under state or federal law, to purchase construction, backup, maintenance or startup power from third-party supplier(s)".

Since, the delivery to provide start-up and station power to a generator, is considered a retail service, prior to the energization and testing of the Facility, Riverside Generating Company, LLC must enter into a contract for retail service with the local utility for delivery of power TO the Riverside Generating Plant for Station Power and for Start-up energy as described in the outline. The following principles are applicable to electric service for station auxiliaries and start-up load at new generating station. These principles apply equally during pre-commercial and commercial operations of the generating facility.

In areas where consumers do not have retail supplier choice, the electric power for the generating station service (power deliveries To the station during periods of non-production, herein "Station Power") shall be taken under an applicable retail electric service tariff or pursuant to a bi-lateral agreement with the local utility. This requirement will apply whether the Station Power is taken from the local electric utility's distribution facility or through the interconnection point to the transmission system, e.g., through the Generator Step-Up Transformer (GSU). The local utility must be contacted regarding rates and terms and conditions for such service. If Station Service is taken through the Transmission System interconnection facilities, and the generating company provides the metering facilities, the portion of the retail rate designed to recover meter-related costs will be waived, if such retail service is provided by one of the AEP Operating Companies.

Pursuant to state utility regulatory requirements, retail consumers that have retail supplier choice, still must take retail service from the local distribution utility for delivery of electric power To their facility, even when the facility is connected to the transmission system. Generating facilities have not been exempted from this requirement.

If retail electricity consumers in the area where the new generator is located have supplier choice, pursuant to a state-sponsored retail access program, Station Power may be purchased from any approved retail Provider and delivered TO the new generating station through wholesale transmission service transactions, complying with state specific and local electric utility provisions and tariffs for customer classes. Specifically, in such cases, Station Power may be delivered to the site, either through the local distribution system or the Transmission System interconnection and GSU facilities, provided that such deliveries (to the distribution utility company or interconnection point) are made pursuant to pre-arranged power delivery schedules. All such schedules must be made in the form specified by the Transmission Provider, consistent with NERC protocols for electronic scheduling (e-Tagging), and must also be valid transactions under a Transmission Service Reservation of Point-to-Point or Network Integration Transmission Service Agreements pursuant to the AEP Companies' (or successor Transmission Provider's) Open Access Transmission Tariff (OATT).

All power deliveries From the new generator must be arranged pursuant to valid energy delivery schedules, pre-arranged with the Transmission Provider under a Transmission Service agreement.

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All power deliveries To or From the generator that are made pursuant to schedules under the OATT will be subject to the provisions of Schedule 4 - Energy Imbalance Services of the Transmission Provider's OATT or the Interconnection Agreement, whichever is applicable.

Power taken through the interconnection for unit start-up and testing purposes will be counted as energy imbalance, if not scheduled in advance pursuant to a valid transmission service reservation transaction under the company's OATT. However, if retail consumers in the area of the generator do not have supplier choice, Start-Up Power must be taken under the applicable retail tariff or pursuant to a bi-lateral agreement with the local utility. The local utility must be consulted regarding rates and terms for such service.

For the specific case of Dynegy's Riverside Generating Company, LLC (Riverside), the local utility is Kentucky Power Company (KPCo). It is suggested that Riverside should contact KPCo to request retail service for Station Power and for start-up purposes prior to energization and testing of the generators. Please contact E. J. Clayton, AEP Customer Service Engineer to make such a request. His phone number is (606) 327-1137. You may also contact Jay H Johnson, AEP Project Manager for this project. His phone number is (540) 985-2565.


If you have any questions, please call.

Thanks and have a great day

Mohan Sachdeva

Transmission and Interconnection Services
American Electric Power
1 Riverside Plaza Columbus, OH 43215
PHONE: (614) 223-2375, FAX (614) 223-1555 OR 2399 E-MAIL:
MKSachdeva@aep.com

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To:

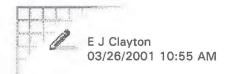Errol K Wagner/AS1/AEPIN@AEPIN, David M Roush/OR3/AEPIN@AEPIN

cc:

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To: Bill Hanley/HOU/Dynegy@Dynegy

cc:

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KPSC Case No. 2017-00472 Riverside's First Set of Data Requests Dated May 18, 2018 Item No. 3 Attachment 1 Page 35 of 89



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To: Jim.Berra@dynegy.com

cc: deguill@aep.co, doho@dynegy.com, ejclayton@aep.com, mksachdeva@aep.com, dgcipriany@aep.com, mchau2@aep.com, pbjohnson@aep.com, lchutchison@aep.com

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KPSC Case No. 2017-00472 Riverside's First Set of Data Requests Dated May 18, 2018 Item No. 3 Attachment 1 Page 36 of 89

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Mohan K Sachdeva 03/14/2001 03:18 PM

To: doho@dynegy.com, JMbe@dynegy.com

cc: David_hastings@illinoispower.com, Darrell G Cipriany/OR4/AEPIN@AEPIN, Jay H Johnson/RO1/AEPIN@AEPIN, Max Chau/OR4/AEPIN@AEPIN, Paul B Johnson/OR4/AEPIN@AEPIN, E J Clayton/CH1/AEPIN@AEPIN, Larry C Hutchison/OR3/AEPIN@AEPIN

Subject: Issue of Start-up Power and Station Power-Riverside Generating

Section 3.2 (e) of the Interconnection and Operation Agreement between Kentucky Power Company and Riverside Generating Company, LLC states "Company shall have no obligation under this Agreement to provide construction, backup or start-up power for the Facility Site. This Agreement does not provide for the sale or purchase of Energy from Generating Company's Facility. Generating Company shall have the right, when permitted under state or federal law, to purchase construction, backup, maintenance or startup power from third-party supplier(s)".

Since, the delivery to provide start-up and station power to a generator, is considered a retail service, prior to the energization and testing of the Facility, Riverside Generating Company, LLC must enter into a contract for retail service with the local utility for delivery of power TO the Riverside Generating Plant for Station Power and for Start-up energy as described in the outline. The following principles are applicable to electric service for station auxiliaries and start-up load at new generating station. These principles apply equally during pre-commercial and commercial operations of the generating facility.

In areas where consumers do not have retail supplier choice, the electric power for the generating station service (power deliveries To the station during periods of non-production, herein "Station Power") shall be taken under an applicable retail electric service tariff or pursuant to a bi-lateral agreement with the local utility. This requirement will apply whether the Station Power is taken from the local electric utility's distribution facility or through the interconnection point to the transmission system, e.g., through the Generator Step-Up Transformer (GSU). The local utility must be contacted regarding rates and terms and conditions for such service. If Station Service is taken through the Transmission System interconnection facilities, and the generating company provides the metering facilities, the portion of the retail rate designed to recover meter-related costs will be waived, if such retail service is provided by one of the AEP Operating Companies.

Pursuant to state utility regulatory requirements, retail consumers that have retail supplier choice, still must take retail service from the local distribution utility for delivery of electric power To their facility, even when the facility is connected to the transmission system. Generating facilities have not been exempted from this requirement.

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If retail electricity consumers in the area where the new generator is located have supplier choice, pursuant to a state-sponsored retail access program, Station Power may be purchased from any approved retail Provider and delivered TO the new generating station through wholesale transmission service transactions, complying with state specific and local electric utility provisions and tariffs for customer classes. Specifically, in such cases, Station Power may be delivered to the site, either through the local distribution system or the Transmission System interconnection and GSU facilities, provided that such deliveries (to the distribution utility company or interconnection point) are made pursuant to pre-arranged power delivery schedules. All such schedules must be made in the form specified by the Transmission Provider, consistent with NERC protocols for electronic scheduling (e-Tagging), and must also be valid transactions under a Transmission Service Reservation of Point-to-Point or Network Integration Transmission Service Agreements pursuant to the AEP Companies' (or successor Transmission Provider's) Open Access Transmission Tariff (OATT).

All power deliveries From the new generator must be arranged pursuant to valid energy delivery schedules, pre-arranged with the Transmission Provider under a Transmission Service agreement.

All power deliveries To or From the generator that are made pursuant to schedules under the OATT will be subject to the provisions of Schedule 4 - Energy Imbalance Services of the Transmission Provider's OATT or the Interconnection Agreement, whichever is applicable.

Power taken through the interconnection for unit start-up and testing purposes will be counted as energy imbalance, if not scheduled in advance pursuant to a valid transmission service reservation transaction under the company's OATT. However, if retail consumers in the area of the generator do not have supplier choice, Start-Up Power must be taken under the applicable retail tariff or pursuant to a bi-lateral agreement with the local utility. The local utility must be consulted regarding rates and terms for such service.

For the specific case of Dynegy's Riverside Generating Company, LLC (Riverside), the local utility is Kentucky Power Company (KPCo). It is suggested that Riverside should contact KPCo to request retail service for Station Power and for start-up purposes prior to energization and testing of the generators. Please contact E. J. Clayton, AEP Customer Service Engineer to make such a request. His phone number is (606) 327-1137. You may also contact Jay H Johnson, AEP Project Manager for this project. His phone number is (540) 985-2565.


If you have any questions, please call.

Thanks and have a great day

Mohan Sachdeva

Transmission and Interconnection Services
American Electric Power
1 Riverside Plaza Columbus, OH 43215
PHONE: (614) 223-2375, FAX (614) 223-1555 OR 2399 E-MAIL
MKSachdeva@aep.com

KPSC Case No. 2017-00472 Riverside's First Set of Data Requests Dated May 18, 2018 Item No. 3 Attachment 1 Page 38 of 89

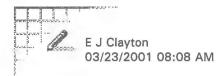

To:

David M Roush/OR3/AEPIN@AEPIN, Errol K Wagner/AS1/AEPIN@AEPIN

cc:

Subject: Re: address

Upon your confirmation, I will create a QP Service Agreement effective March 31 which is good for 2 months(until the customer begins commercial operation). I can include addendum comments on the service agreement, as necessary.

------ Forwarded by E J Clayton/CH1/AEPIN on 03/23/2001 07:45 AM -------

Bill.Hanley@dynegy.com on 03/22/2001 02:10:01 PM

To:

ejclayton@aep.com

cc:

Subject: Re: address

EJ,

My address at Dynegy is:

1000 Louisiana Street, Suite 5800 Houston, TX 77002-5050

Additionally, we want to contract for 2,250 kW under the temporary QP Tariff as that is the maximum load we would incur during testing. However, we want to contract for 4,500 kW under the interruptible tariff that we anticipate implementing once we are commercial in June.

Thanks,

Bill

ejclayton@aep.com on 03/22/2001 08:53:10 AM

To: Bill.Hanley@dynegy.com

cc:

Subject: Re: address

Bill

I will need your address for mailing the service agreement for authorization.

Also, I presume you want to contract for 2,500 kW. If the contract capacity is less, please note the QP rate specifies capacity terms in

KPSC Case No. 2017-00472 Riverside's First Set of Data Requests Dated May 18, 2018 Item No. 3 Attachment 1 Page 39 of 89

increments of 100 kW. I have included my address below for future reference.

American Electric Power 1701 Central Avenue Ashland, KY 41101

E. J. Clayton Customer Services Engineer (606) 327-1137 (606) 327-1246 fax

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Bill.Hanley@dynegy.com on 03/22/2001 02:10:01 PM

To:

ejclayton@aep.com

cc:

Subject: Re: address

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KPSC Case No. 2017-00472 Riverside's First Set of Data Requests Dated May 18, 2018 Item No. 3 Attachment 1 Page 41 of 89



To:

Errol K Wagner/AS1/AEPIN@AEPIN

cc:

Subject: Re: Request for Service

I was referring to the Special Terms Section of the Rate, stating customers having other energy sources can purchase backup electric service from the company based on a contracted maximum demand. Should the special agreement not work out, I would think the customer could purchase and be invoiced for any backup energy under the terms of this rate. This is what we discussed when I initially contacted you regarding this customer inquiry.

From: Errol K Wagner on 03/22/2001 10:25 AM

From: Errol K Wagner on 03/22/2001 10:25 AM

To: E J Clayton/CH1/AEPIN@AEPIN David M Roush/OR3/AEPIN@AEPIN

Subject: Re: Request for Service

EJ

This Customer can not commercially operate his plant under the filed QP tariff. The needs to understand that prior to generating energy for sale a special contract need to be in place and approved by the Commission. Therefore, your statement that you can change the contract expiration date and acquire customer approval of a standard QP contract is not appropriate for this customer.

E J Clayton

E J Clayton To: Errol K Wagner/AS1/AEPIN@AEPIN, David M Roush/OR3/AEPIN@AEPIN

cc: Mark A Gundelfinger/OR3/AEPIN@AEPIN 03/22/01 09:28 AM

Subject: Request for Service

Please verify approval to establish this customer on a temporary QP Rate for approximately 2 months, waiving the initial term of 2 years. I will process the service agreement with the customer with plans to convert the service after commission approval of a negotiated agreement. Should approval of the special agreement fail, I can change the contract expiration date and acquire customer approval of a standard QP contract.

--- Forwarded by E J Clayton/CH1/AEPIN on 03/22/2001 08:39 AM -------

Bill.Hanley@dynegy.com on 03/21/2001 02:49:36 PM

To:

eiclayton@aep.com

cc:

Subject: Request for Service

E.J.,

KPSC Case No. 2017-00472 Riverside's First Set of Data Requests Dated May 18, 2018 Item No. 3 Attachment 1 Page 42 of 89

Following up on our conference call this morning, I am writing to formally request aux/start-up power service for Riverside Generating Company, L.L.C. (partnership name for the Dynegy entity that owns the Riverside Generating Station).

The business address for Riverside is 1000 Louisiana Street, Suite 5800, Houston, TX 77002-5050. I will send you the plant address in a subsequent email.

Riverside normal operating profile will require approximately 100-200 kw's most of the time. When one of our turbines is running, the electricity needs for the balance of plant will be parasited from our generator rather than the aux power supply. When we are starting a turbine, the instantaneous demand for aux. power will be approximately 2,250 kW's for under a 15 minute period of time. We plan to start the 2nd and 3rd units off of electricity generated by the first unit started. There will be rare instances where we will start 2 units simultaneously off of aux. power requiring approximately 4,500 kW's instantaneously for less than 15 minutes. We anticipate starting our units once each business day from June - September and several times throughout the remaining months for an estimated total of 100 starts per year.

Please email me back any questions or specific information you need from me about Riverside.

As we discussed today, we would like to temporarily sign up under AEP's Tariff Q.P. by March 31st while we work towards agreeing on an interruptible power or special contract for aux. power and await approval from the commission.

Please email or fax me a copy of what we need to sign for the temporary Tariff Q.P. as soon as you have something you can give me.

I look forward to working with you and appreciate AEP's help with this matter.

Bill Hanley Asset Manager Dynegy Marketing & Trade 713-767-8635 fax 713-767-8506

------ Forwarded by E J Clayton/CH1/AEPIN on 03/22/2001 08:39 AM -------

Bill.Hanley@dynegy.com on 03/21/2001 04:09:07 PM

To: ejclayton@aep.com

Subject: Re: address

Below is the address for the Riverside plant:

Rt.2, Box 296

Catlettsburg, KY 41129

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E J Clayton 03/22/2001 09:28 AM

To: Errol K Wagner/AS1/AEPIN@AEPIN, David M Roush/OR3/AEPIN@AEPIN

cc: Mark A Gundelfinger/OR3/AEPIN@AEPIN

Subject: Request for Service

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----- Forwarded by E J Clayton/CH1/AEPIN on 03/22/2001 08:39 AM ----------------

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To: ejclayton@aep.com

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E J Clayton 03/22/2001 09:53 AM

To:

Bill.Hanley@dynegy.com

cc:

Subject: Re: address

Bill

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Also, I presume you want to contract for 2,500 kW. If the contract capacity is less, please note the QP rate specifies capacity terms in increments of 100 kW.

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E. J. Clayton Customer Services Engineer (606) 327-1137 (606) 327-1246 fax

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Bill.Hanley@dynegy.com on 03/21/2001 04:09:07 PM

To:

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cc:

Subject: Re: address

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KPSC Case No. 2017-00472 Riverside's First Set of Data Requests Dated May 18, 2018 Item No. 3 Attachment 1 Page 47 of 89



Bill.Hanley@dynegy.com on 03/21/2001 02:49:36 PM

To:

ejclayton@aep.com

cc:

Subject: Request for Service

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Riverside's First Set of Data Requests
Dated May 18, 2018
Item No. 3
Attachment 1
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FACSIMILE COVER



Date:	11-28-01		
To:	JIM Curre	nt	
Company:	Dynegy		
Phone:			
Fax:	(713)761-85	521	
From:	E. J. Clayton, P.E., C.E.M. Customer Services Engineer Customer Services 606 327 1137 Fax 606 327 1246	AEP	
Company:	Pager 606 32 0817 e-mail ejclayton@aep com	AMERICAN*	
Phone: Fax:	American Electric Power 1701 Central Avenue Ashland, KY 41101 www.aep.com	AEP: America's Energy Partner	
	Pages Including Th		
Comments			
JIM: Comple	ete item # 2	2 on attached	addendum form
16	Locasted in	Hais Kantucky -	Taciff
Wefor	will derive the starter	an applicable energy based	energy rate of terms on the operating information

KPSC Case No. 2017-00472 Riverside's First Set of Data Requests Dated May 18, 2018 Item No. 3 Attachment 1 Page 49 of 89

AMERICAN ELECTRIC POWER

CANCELING ORIGINAL SHEET NO. 28-1
SHEET NO. 7
PSC ELECTRIC NO. 7

TARIFF N.U.G. (Non-Utility Generator)

AVAILABILITY OF SERVICE.

This tariff is applicable to customers with generation facilities which have a total design capacity of over 1,000 kW that intend to schedule, deliver and sell the net electric output of the facility at wholesale, and who requiremmissioning Power, Startup Power and/or Station Power service from the Company.

Service to any load that is electrically isolated from the customers generator shall be separately metered and provided in accordance with the generally available demandatement tariff appropriate for such service to the customer.

This tariff is not available for standby, backup, maintenance, or supplemental service for wholesale or retail loads served by customers generator.

DEFINITIONS.

- Commissioning Power The electrical energy and capacity supplied to the customer prior to the commercial operation of the customer's generator, including initial construction and testing phases.
- Station Power The electrical energy and capacity supplied to the customer to serve theuailiary loads at the customers generation facilities, usually when the customer's generator is not operating. Station Power does not include Startup Power.
- Startup Power The electrical energy and capacity supplied to the customer following a planned forced outage of the customers generator for the purpose of returning the customers generator to synchronous operation.

COMMISSIONING POWER SERVICE.

Customers requiring Commissioning Power shall take service under Tariff T.S. or by special agreementitive the Company.

The customer shall coordinate its construction and testing with the Company to ensure that the customers operations do not cause any undue interference with the Companys obligations to provide service to its other customers or impose a burden on the Companys system or any system interconnected with the Company.

STATION POWER SERVICE.

Customers requiring Station Power shall take service under the generally available demandetered tariff appropriate for the customers Station Power requirements.

Station Contract Capacity – The customer shall contract for a definite amount of electrical capacity in kW sufficient to meet the maximum Station Power requirements that the Company is expected to supply under the generally available demandmetered tariff appropriate for the customer.

STARTUP POWER SERVICE.

Customers requiring Startup Power have the option of contracting for such service under the terms of this tariff or under the generally available demandmetered tariff appropriate for the astomer's Startup Power requirements.

Startup Contract Capacity – The customer shall contract for a definite amount of electrical capacity in kW sufficient to meet the maximum Startup Power requirements that the Company is expected to supply.

Startup Duration – The customer shall contract for a definite number of hours sufficient to meet the maximum period of time for which the Company is expected to supply Startup Power.

Startup Frequency – The customer shall contract for a definite number of startup eents sufficient to meet the maximum number of times per year that the Company is expected to supply Startup Power.

Other Startup Characteristics – The customer shall provide to the Company other information regarding the customers Startup Power requirements, including, but not limited to, anticipated timeof-use and seasonal characteristics

Notification Requirement - Whenever Startup Power is needed, the customer shall provide advance notice to the Company.

(Contd. on Sheet No. 28-2)

DATE OF ISSU	JEAugust 20, 2001	DATE EFFECTIVE	September 27, 2001	-
ISSUED BY _	E.K. WAGNER	DIRECTOR OF REGULATORY AFFAIRS	ASHLAND, KENTUCKY	
	NAME	TITLE	ADDRESS	
Issued by auth	nority of a letter by th	e Public Service Commission dated Octob	er 2, 2001	

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AMERICAN ELECTRIC POWER

	ORIGINAL	SHEET	NO.	28-2
CANCELING		SHEET	NO.	

PSC ELECTRIC NO. 7

TARIFF N.U.G.(Cont'd)
(Non-Utility Generator)

STARTUP POWER SERVICE. (contb)

Upon receipt of a request from the customer for Startup Power Service under the terms of this tariff, the Company will provide the customer a written offer containing the Notification Requiremengeneration rates (including demand and energy charges) and related terms and conditions of service under which service will be provided by the Company. Such offer shall be based upon the Startup Contract Capacity, Startup Duration, Startup Frequency,nd Other Startup Characteristics as specified by the customer. In no event shall the generation rates be less than the sum of the Tariff C.l.P. T.O.D. Energy Charge, the Fuel Adjustment Clause, the System Sales clause, the Experimental Demar@ide Management Adjustment Clause, and the Net Merger Savings Credit.

If the parties reach an agreement based upon the offer provided to the customer by the Company, a contract shall be executed that provides full disclosure of all rates, terms and conditions of seize under this tariff, and any and all agreements related thereto.

Monthly Transmission and Distribution Rates

	Se	rvice	Vol	Itage
--	----	-------	-----	-------

Tariff Code	Subtransmission 392	Transmission 393
Reservation Charge per kW	\$ 3.25	\$ 2.28
Reactive Demand Charge for ecc Leading or Lagging Reactive De 50% of the kW of monthly meters	0.60 per kVAR	

Delayed Payment Charge

This Tariff is net if account is paid in full within 15 days of date of bill. On all accounts not spaid, an additional charge of 5% of the unpaid balance will be made.

Monthly Billing Demand

The monthly billing demand in kW shall be taken each month as the highest single 16 inute Itegrated peak in kW as registered by a demand meter or indicator, lesthe Station Contract Capacity. The monthly billing demand so established shall in no event be less than the greater of (a) the Startup Contract Capacity or b) the customers highest previously established monthly billing demand during the past 11 months

Monthly Billing Energy

Interval billing energy shall be measured each 15minute interval of the month as the total kWh registered by an energy meter or meters less the quotient of the Station Contract Capacity and four (4). In no event shall the interval billing energy be less than zero (0). Monthly billing energy shall be the sum of the interval billing energy for all intervals of the billing month.

TRANSMISSION SERVICE.

Transmission Provider – The entity providing transmission service to customers the Company's service territory. Such entity may be the Company or a regional transmission entity.

Prior to taking service under this tariff, the customer must have a fully executed Interconnection and Operation Agreement with the Company and/or the ransmission Provider or an unexecuted agreement filed with the Federal Energy Regulatory Commission under applicable procedures.

Should the Transmission Provider implement charges for Transmission Congestion, the Company shall provide 30 days written ndice to the customer. Upon the expiration of such notice period, should the customers use of Startup Power result in any charges for Transmission Congestion from the Transmission Provider, such charges, including any applicable taxes or assessments, shalbe paid by or passed through to the customer without markup. Transmission Congestion is the condition that exists when market participants seek to dispatch in a pattern that would result in power flows that cannot be physically accommodated by the syste.

DATE OF ISSUE_	August 20, 2001	DATE EFFECTIVE September 2	27, 2001	-
ISSUED BY	E.K. WAGNER	DIRECTOR OF REGULATORY AFFAIRS	ASHLAND, KENTUCKY	_
	NAME	TITLE	ADDRESS	
Issued by authori	ty of a letter by the	Public Service Commission dated October	2. 2001	

KPSC Case No. 2017-00472 Riverside's First Set of Data Requests Dated May 18, 2018 Item No. 3 Attachment 1 Page 51 of 89

AMERICAN ELECTRIC POWER

	ORIGINAL	SHEET	NO.	28-3
CANCELING		SHEE	TNO	

PSC ELECTRIC NO. 7

TARIFF N.U.G. (Contd) (Non-Utility Generator

TERM OF CONTRACT

Contracts under this tariff will be made for an initial period of not less than one year and shall remain in effect thereafter until either paty shall give at least 6 months written notice to the other of the intention to terminate the contract. The Company reserves the right to require initial contracts for periods greater than one year.

A new initial contract period will nobe required for existing customers who change their contract requirements after the original initial period unless new or additional facilities are required.

The Company may not be required to supply capacity in excess of that contracted for except by mat agreement. Contracts will be made in multiples of 100 kW.

SPECIAL TERMS AND CONDITIONS.

This tariff is subject to the Company's Terms and Conditions of Service.

This tariff shall not obligate the Company to purchase or pay for any capacity or energroduced by the customer's generator.

Customers desiring to provide Startup and Station Power from commonly owned generation facilities that are not located on the site of the customers generator (remote selsupply), shall take service under the term and conditions contained within the applicable Open Access Transmission Tariff as filed with and accepted by the Federal Energy Regulatory Commission.

DATE OF ISS	DATE OF ISSUE August 20, 2001 DATE EFFECTIVE September 27, 2001			
ISSUED BY	E. K. Wagner NAME	DIRECTOR OF REGULATORY SERVICES TITLE	ASHLAND, KENTUCKY ADDRESS	
Issued by authority of a letter of Public Service Commission dated October 2, 2001				

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ADDENDUM ____ Startup Power Service

		(Custome	er) for service to the premises located at
II.	Th	e Customer elects to take Startup Power Se	rvice under the Company's Tariff N.U.G.
	In	accordance with Tariff N.U.G., the Custom	er hereby establishes the following:
	1.	Station Contract Capacity of	kW, as specified in the Contract for Station Power Service.
	2.	Startup Contract Capacity of	kW.
	3.		hours per event.
	4.	Startup Frequency of no more than	events per year.
	5.	Other Startup Characteristics of	
		*	
III.	No	tification Requirement:	
	_		
	_		
TX 7	0	D. A.	
IV.	Ge	neration Rates:	
	_		
		is Addendum shall be in full force and effecties hereto.	t when signed by the authorized representatives of the
	Рa	ties nereto.	
		ntucky Power Company	
	d/b/	/a American Electric Power	(Customer)
	By	•	By:
		: (Signature)	(Signature)
		(Printed Name)	(Printed Name)
	Tit	le:	Title:
	Dat	te:	Date:

KPSC Case No. 2017-00472
Riverside's First Set of Data Requests

Dated May 18, 2018

Item No. 3

Attachment 1

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50-150 days Summerz Start periodically through Winter for wheckout through Winter Predominant Load Starting motors

Startup tower LF = 30%

Transmission Charge - \$ 2.28 x 2000 KW = 4,560

Energy hrs/period

= LF

bill demand

Energy/month = (30%)(2000)(730) = 481,800 KWH

Privileged

Non-responsive Privileged

Dynegy is part of Illinois is affiliated with Illinois Hu Enviro Power - prompted NUG Agreement

Mon Utility Generator - Anybody having generation Riverside would gualify.

One benefit night be reduction in customer contract term.

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AMERICAN ELECTRIC POWER

CANCELING ORIGINAL SHEET NO. 28-1
SHEET NO. PSC ELECTRIC NO. 7

TARIFF N.U.G. (Non-Utility Generator)

AVAILABILITY OF SERVICE.

This tariff is applicable to customers with generation facilities which have a total design capacity of over 1,000 kW that intend to schedule, deliver and sell the net electric output of the facility at wholesale, and who requiremmissioning Power, Startup Power and/or Station Power service from the Company.

Service to any load that is electrically isolated from the customers generator shall be separately metered and provided in accordance with the generally available demanded teriff appropriate for such service to the customer.

This tariff is not available for standby, backup, maintenance, or supplemental service for wholesale or retail loads served by customers generator.

DEFINITIONS.

- Commissioning Power The electrical energy and capacity supplied to the customer prior to the commercial operation of the customers generator, including initial construction and testing phases.
- Station Power The electrical energy and capacity supplied to the customer to serve theuailiary loads at the customer's generation facilities, usually when the customer's generator is not operating. Station Power does not include Startup Power.
- 3. Startup Power The electrical energy and capacity supplied to the customer following a planned forced outage of the customers generator for the purpose of returning the customers apparation.

COMMISSIONING POWER SERVICE.

Customers requiring Commissioning Power shall Company.

The customer shall coordinate its construction operations do not cause any undue interference with the C impose a burden on the Companys system or any system in

Iff msg with Errol

ial agreementitw the

e that the customers its other customers or

STATION POWER SERVICE.

Customers requiring Station Power shall take service under the generally available demandetered tariff appropriate for the customers Station Power requirements.

Station Contract Capacity – The customer shall contract for a definite amount of electrical capacity in kW sufficient to meet the maximum Station Power requirements that the Company is expected to supply under the generally available demandmetered tariff appropriate for the customer.

STARTUP POWER SERVICE.

Customers requiring Startup Power have the option of contracting for such service under the terms of this tariff or under the generally available demandmentered tariff appropriate for the ostomers Startup Power requirements.

Startup Contract Capacity – The customer shall contract for a definite amount of electrical capacity in kW sufficient to meet the maximum Startup Power requirements that the Company is expected to supply.

Startup Duration – The customer shall contract for a definite number of hours sufficient to meet the maximum period of time for which the Company is expected to supply Startup Power.

Startup Frequency – The customer shall contract for a definite number of startup conts sufficient to meet the maximum number of times per year that the Company is expected to supply Startup Power.

Other Startup Characteristics – The customer shall provide to the Company other information regarding the customers Startup Power requirements, including, but not limited to, anticipated timeof-use and seasonal characteristics.

Notification Requirement - Whenever Startup Power is needed, the customer shall provide advance notice to the Company.

(Contd. on Sheet No. 28-2)

DATE OF ISSU	JEAugust 20, 2001_	DATE EFFECTIVE	September 27, 2001
ISSUED BY_	E.K. WAGNER	DIRECTOR OF REGULATORY AFFAIRS	ASHLAND, KENTUCKY
	NAME	TITLE	ADDRESS
Issued by aut	hority of a letter by th	e Public Service Commission, dated Octo	oher 2, 2001

KPSC Case No. 2017-00472 Riverside's First Set of Data Requests Dated May 18, 2018 Item No. 3 Attachment 1 Page 56 of 89

AMERICAN ELECTRIC POWER

	ORIGINAL	SHEET	NO.	28-2
CANCELING		SHEET	NO.	

PSC ELECTRIC NO. 7

TARIFF N.U.G.(Cont'd)
(Non-Utility Generator)

STARTUP POWER SERVICE. (contd)

Upon receipt of a request from the customer for Startup Power Service under the terms of this tariff, the Company will provide the customer a written offer containing the Notification Requiremengeneration rates (including demand and energy charges) and related terms and conditions of service under which service will be provided by the Company. Such offer shall be based upon the Startup Contract Capacity, Startup Duration, Startup Frequency, ne Other Startup Characteristics as specified by the customer. In no event shall the generation rates be less than the sum of the Tariff C.I.P. T.O.D. Energy Charge, the Fuel Adjustment Clause, the System Sales clause, the Experimental Demarstide Management Adjustment Clause, and the Net Merger Savings Credit.

If the parties reach an agreement based upon the offer provided to the customer by the Company, a contract shall be executed that provides full disclosure of all rates, terms and conditions of seize under this tariff, and any and all agreements related thereto.

Monthly Transmission and Distribution Rates

Service Voltage

| Subtransmission | Transmission | 392 | 393 |
| Reservation Charge per kW | \$ 3.25 | \$ 2.28 - Teservation | Charge for each kiloVAR of maximum | Charge for each kiloVAR of maximu

Leading or Lagging Reactive Demand in Excess of 50% of the kW of monthly metered demand......\$ 0,60 per kVAR

Delayed Payment Charge

This Tariff is net if account is paid in full within 15 days of date of bill. On all accounts not spaid, an additional charge of 5% of the unpaid balance will be made.

Monthly Billing Demand

The monthly billing demand in kW shall be taken each month as the highest single 15 inute Itegrated peak in kW as registered by a demand meter or indicator, lesthe Station Contract Capacity. The monthly billing demand so established shall in no event be less than the greater of (a) the Startup Contract Capacity or b) the customers highest previously established monthly billing demand during the past 11 months

Monthly Billing Energy

Interval billing energy shall be measured each 15 pinute interval of the month as the total kWh registered by an energy meter or meters less the quotient of the Station Contract Capacity and four (4). In no event shall the interval billing energy be less than zero (0). Monthly billing energy shall be the sum of the interval billing energy for all intervals of the billing month.

TRANSMISSION SERVICE.

Transmission Provider – The entity providing transmission service to customers the Company's service territory. Such entity may be the Company or a regional transmission entity.

Prior to taking service under this tariff, the customer must have a fully executed Interconnection and Operation Agreement with the Company and/or the ransmission Provider or an unexecuted agreement filed with the Federal Energy Regulatory Commission under applicable procedures.

Should the Transmission Provider implement charges for Transmission Congestion, the Company shall provide 30 days written notice to the customer. Upon the expiration of such notice period, should the customers use of Startup Power result in any charges for Transmission Congestion from the Transmission Provider, such charges, including any applicable taxes or assessments, shallbe paid by or passed through to the customer without markup. Transmission Congestion is the condition that exists when market participants seek to dispatch in a pattern that would result in power flows that cannot be physically accommodated by the systm.

DATE OF ISSUE_	August 20, 2001	DATE EFFECTIVE	September 27, 2001
ISSUED BY	E.K. WAGNER	DIRECTOR OF REGULATORY	AFFAIRS ASHLAND, KENTUCKY
	NAME	TITLE	ADDRESS
Issued by author	ity of a letter by the	Public Service Commission da	ited October 2, 2001

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AMERICAN ELECTRIC POWER

	ORIGINAL	SHEET NO	28-3
CANCELING		SHEET NO	D

PSC ELECTRIC NO. 7

TARIFF N.U.G. (Contd) (Non-Utility Generator

TERM OF CONTRACT

Contracts under this tariff will be made for an initial period of not less than one year and shall remain in effect thereafter until either paty shall give at least 6 months written notice to the other of the intention to terminate the contract. The Company reserves the right to require initial contracts for periods greater than one year.

A new initial contract period will nobe required for existing customers who change their contract requirements after the original initial period unless new or additional facilities are required.

The Company may not be required to supply capacity in excess of that contracted for except by α agreement. Contracts will be made in multiples of 100 kW

SPECIAL TERMS AND CONDITIONS.

This tariff is subject to the Company's Terms and Conditions of Service.

This tariff shall not obligate the Company to purchase or pay for any capacity or energroduced by the customer's generator.

Customers desiring to provide Startup and Station Power from commonly owned generation facilities that are not located on the site of the customers generator (remote selsupply), shall take service under the term and conditions contained within the applicable Open Access Transmission Tariff as filed with and accepted by the Federal Energy Regulatory Commission.

DATE OF IS	SUE August 20, 2001	DATE EFFECTIVE _S	eptember 27, 2001
ISSUED BY	E. K. Wagner	DIRECTOR OF REGULATORY SERVICES	ASHLAND, KENTUCKY
	NAME	TITLE	ADDRESS

KPSC Case No. 2017-00472 Riverside's First Set of Data Requests Dated May 18, 2018 Item No. 3 Attachment 1 Page 58 of 89

Dynegy Marketing and Trade 1000 Louisiana Street, Suite 5800 Houston, Texas 77002 Phone 713.507.6400 www.dynegy.com



November 19, 2001

American Electric Power 1701 Central Avenue Ashland, KY 4105-1428 Attn: E.J. Clayton

Dear E.J.

Enclosed you will find two (2) electrical services agreements executed by Dynegy. Please sign and send one (1) fully executed original back to me and keep one (1) fully executed original for your files.

Please feel free to call me with any questions at (713) 507-3935.

Jim Current

Sincerely

Asset Manager

KPSC Case No. 2017-00472 Riverside's First Set of Data Requests Dated May 18, 2018 Item No. 3 Attachment 1 Page 59 of 89

This Contract, entered into this <u>26th</u> day of <u>October 2001</u>, by and between <u>Kentucky Power Company</u> dba American Electric Power, hereafter called the Company, and <u>Riverside Generating Company</u>, <u>LLC</u>, <u>1000 Louisiana Street</u>, <u>Suite 5800</u>, <u>Houston</u>, <u>TX</u>, <u>77002-5050</u>, or his or its heirs, successors or assigns, hereafter called the Customer,

Witnesseth:

V--t--le- D---- C----

For and in consideration of the mutual covenants and agreements hereinafter contained, the parties hereto agree with each other as follows:

The Company agrees to furnish to the Customer, during the term of this Contract, and the Customer agrees to take from the Company, subject to Company's standard Terms and Conditions of Service as regularly filed with the <u>Public Service Commission of Kentucky</u>, all the electric energy of the character specified herein that shall be purchased by the Customer in the premises located at <u>Rt. 2</u>, <u>Box 296</u>, <u>Catlettsburg</u>, <u>KY 41129</u>.

The Company is to furnish and the Customer is to take electric energy under the terms of this Contract for an initial period of <u>24</u> month(s) from the time such service is commenced, and continuing thereafter until terminated upon <u>12</u> months' written notice given by either party of its intention to terminate the Contract. The date that service shall be deemed to have commenced under this Contract shall be <u>November 1, 2001</u>.

The electric energy delivered hereunder shall be alternating current at approximately 345000 volts, 3-wire, 3-phase, and it shall be delivered at termination point of customers 345 kV circuit located in the AEP Baker 345 kV Station, which shall constitute the point of delivery under this Contract. The said electric energy shall be delivered at reasonably close maintenance to constant potential and frequency, and it shall be measured by a meter or meters owned and installed by the Company and located at AEP Baker 345 kV Electrical Station.

The Customer acknowledges that the Customer may be eligible to receive service under more than one of the Company's schedules and that such options have been explained to the Customer. The Customer and Company agree that the Customer has chosen to receive service under the provisions of the Company's Tariff QUANTITY POWER - TRANSMISSION, code 360. The Customer agrees to pay the Company monthly for electric energy delivered hereunder at the rates and under the provisions of the Company's Tariff QUANTITY POWER - TRANSMISSION, code 360, as regularly filed with the Public Service Commission of Kentucky, as long as that schedule is in effect. In the event that the tariff chosen by the Customer is replaced by a new or revised tariff incorporating different rates or provisions, or both, the Company and Customer understand and agree that the Company will continue to provide service, and the Customer will continue to take service, under this Contract, subject to such changed provisions, and that the Customer will pay for such service at the new rates on and after the date such rates become effective.

The Customer's contract capacity under the tariff named herein is hereby fixed at 2,300kW. If a time-of-day demand is available under the tariff and is selected by the Customer, the reservation of capacity aforementioned shall be the peak period reservation of capacity and shall determine the tariff's minimum monthly billing demand. The amount of capacity requested during the off-peak period is 2300 kW.

There are no unwritten understandings or agreements relating to the service hereinabove provided. This Contract cancels and supersedes all previous agreements, relating to the purchase by Customer and sale by Company of electric energy at Customer's premises as referred to above, on the date that service under this Contract commences. This Contract shall be in full force and effect when signed by the authorized representatives of the parties hereto.

Divarrida Company I I C

Kentucky Fower Company	Riverside Generating Company, LLC
Ву:	By: Jessey Brock
Mark A. Gundelfinger	JESSEN BRADSHAW
Title: Manager	Title: VILE PRESIDENT
Date:	Date: November 11, 2001

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Dynegy Marketing and Trade 1000 Louisiana Street, Suite 5800 Houston, Texas 77002 Phone 713.507.6400 www.dynegy.com



November 19, 2001

American Electric Power 1701 Central Avenue Ashland, KY 4105-1428 Attn: E.J. Clayton


Dear E.J.

Enclosed you will find two (2) electrical services agreements executed by Dynegy. Please sign and send one (1) fully executed original back to me and keep one (1) fully executed original for your files.

Please feel free to call me with any questions at (713) 507-3935.

Sincerely

Jim Current Asset Manager

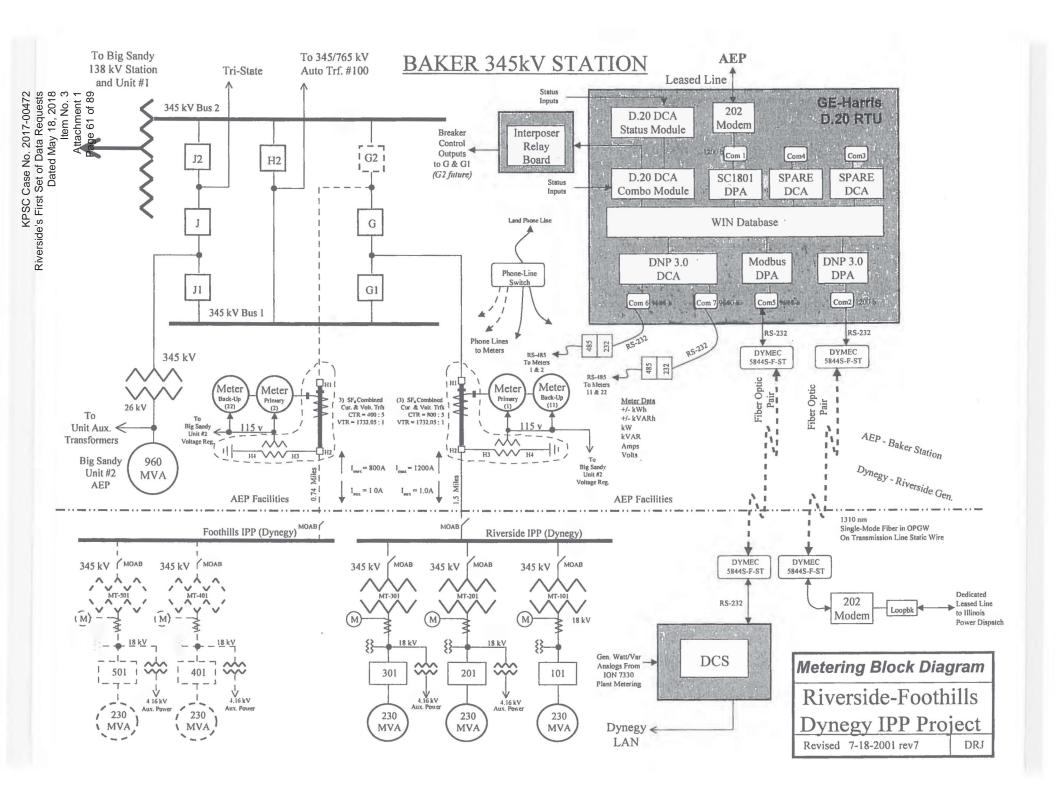

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E J Clayton

To: David M Roush/OR3/AEPIN

12/12/01 10:09 AM

cc: Errol K Wagner/AS1/AEPIN@AEPIN Subject: Re: NUG - Dynegy

The customer has confirmed that 3,300 kW is the total load which could be used at the facility during a startup event.

I have set them up on a QP Rate beginning Nov. 1 for their backup power requirements. This should suffice until terms for an optional NUG service request are completed.

David M Roush

David M Roush 12/07/01 11:12 AM

To: E J Clayton/CH1/AEPIN@AEPIN, Errol K Wagner/AS1/AEPIN@AEPIN

cc:

Subject: Re: NUG - Dynegy

We have to work with the wholesale structuring desk to develop a price proposal. Our experience on other projects is that they are not very rapid to respond. However, this is our first NUG/IPP request.

One clarifying question, during a startup event will the customer require a total of 2,500 kW or 3,300 kW. As written, I would assume 3,300 kW, since the first 800 kW of use would always be considered station use and billed at whichever tariff rate for station service. That may not be what the customer intended.

If timing is an issue, I think we could allow them to "go month to month" on QP, until we can finalize a proposal for them.

E J Clayton

E J Clayton

To: David M Roush/OR3/AEPIN@AEPIN, Errol K

Wagner/AS1/AEPIN@AEPIN

12/07/01 10:51 AM

cc:

Subject: NUG - Dynegy

The customer has called about an update on their request for applicable account information on the NUG Tariff.

Any updates on the tariff parameters?

---- Forwarded by E J Clayton/CH1/AEPIN on 12/07/01 10:56 AM ----

E J Clayton

To: David M Roush/OR3/AEPIN, errol Wagner

11/30/01 09:57 AM

cc: Subject: NUG - Dynegy

Jim Current, Asset Manager with Dynegy has provided the following information for the NUG Tariff Agreement.

Station Contract Capacity 800 kW Startup Contract Capacity 2,500 kW

Startup Duration of no more 0.5 hours per event Startup Frequency less than 150 events per year

Jim request the applicable tariff parameters for comparison of their existing rate(QP) versus this tariff.

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With regard to the station power, the contracted capacity of 800 kW falls into the KY-LGS load range, however, LGS has no applicable transmission rate. Would this customer's station power be served by the KY-QP Rate?

E. J. aud 600-1137

NOV. 29. 2001 3:26PM

DYNEGY

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NO. 5 Paled May 18,,2018
Item No. 3
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DYNEG

Dynegy Inc. 1000 Louisiana Street, Suite 5800 Houston, Texas 77002 Phone 713.507.6400

facsimile

Date: 11/29/01

To: E.J. Clayton

Company:

Fax:

Phone:

From: Jim Current

Phone:

Fax

Pages: (including fax cover page)

Service. Please contact the above person if the fax is not legible.

This message is intended only for the use of the individual or entity to which it is addressed and may contain information that is privileged and exempt from disclosure under applicable law. If the reader of this message is not the intended recipient, or the employee or agent responsible for delivering the message to the intended recipient, you are hereby notified that any dissemination, distribution, or copying of this communication is strictly prohibited. If you have received this communication in error, please notify us immediately by telephone, and return the original message to us at the address above via the United States Postal

KPSC Case No. 2017-00472
Riverside's First Set of Data Requests
NO. 5 Dated May 18/2018

DYNEGY

DYNEGY

DYNEGY

Repose

NO. 5 Dated May 18/2018

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ADDENDUM___ Startup Power Service

	I.	This Addendum supplements and amends the Contract for Station Power Service dated by and between Kentucky Power Company (Company), d/b/a American Electric Power, and (Customer) for service to the premises located at					
W.	П.	The Customer elects to take Startup Power Service under the Company's Tariff N.U.G.					
		In accordance with Tariff N.U.G., the Custo	mer hereby establish	es the following:			
		1. Station Contract Capacity of	800	kW, as specified in the Contract for Station Power Service.			
		2. Startup Contract Capacity of		_kW.			
		3. Startup Duration of no more than	1/2	hours per event.			
		4. Startup Frequency of no more than		_ events per year.			
		5. Other Startup Characteristics of					
	ПТ,	III. Notification Requirement:					
	I٧.	IV. Generation Rates:					
	V. This Addendum shall be in full force and effect, when signed by the authorized representati						
		parties hereto.					
		Kentucky Power Company					
		d/b/a American Electric Power	(Customer)				
		Por	P				
		By: (Signature)	By:(Signature				
		(Printed Name)	(Printed N	Jame)			
		Title:	Title:				
		Date:	Date:				

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Jay H Johnson 09/17/01 04:22 PM To: Don.Hoy@dynegy.com, Bryan.Johnson@Dynegy.com, Robert.C.Havelik@Dynegy.com

cc: Timothy V Strader/AS1/AEPIN@AEPIN, Ronald J
Wellman/OR2/AEPIN@AEPIN, T David Parrish/OR2/AEPIN@AEPIN,
Jeffrey A Barsch/CA1/AEPIN@AEPIN, Tony
Paragon/CH1/AEPIN@AEPIN, James M Cheek/CH1/AEPIN@AEPIN,
Harold L Webb/AS1/AEPIN@AEPIN, Anthony J
Boyd/AS1/AEPIN@AEPIN, Brent L Busch/AS1/AEPIN@AEPIN,
Dennis R Jones/CA1/AEPIN@AEPIN, Darrell E
Guill/RO1/AEPIN@AEPIN, E J Clayton/CH1/AEPIN@AEPIN, Mohan K

Sachdeva/OR4/AEPIN@AEPIN, Paul B Johnson/OR4/AEPIN@AEPIN

Subject: Baker Station Foothills Project

Attached are the schedules for subject project which have been updated per our meeting on 9/11/01 and latest events. The construction start date and steel delivery were delayed one week. The construction start date was delayed due to not having a signed interconnection agreement. It was agreed to proceed based on filing an unexecuted agreement with FERC. Most of the steel will be shop assembled which is what caused the delay but this time should be made up by less field assembly time.

Completion date for both phases of the project remain as originally scheduled:

- Complete assembly and erection of bay #5 by 11/15/01
- Complete installation of one 345kv CB "G2", associated equipment and place in service by 1/31/02

Our next scheduled meeting is 10/17/01





Baker Foothills add 345kV bay 9 17 0 Baker Foothills Add 345kV CB with baseline 9 17

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Jay H Johnson

09/18/01 01:43 PM

To: poconnor@psdohio.com

cc: Don.Hoy@dynegy.com, Bryan.Johnson@Dynegy.com,

Robert.C.Havlik@Dynegy.com, Timothy V

Strader/AS1/AEPIN@AEPIN, Ronald J Wellman/OR2/AEPIN@AEPIN,

T David Parrish/OR2/AEPIN@AEPIN, Jeffrey A

Barsch/CA1/AEPIN@AEPIN, Tony Paragon/CH1/AEPIN@AEPIN,

James M Cheek/CH1/AEPIN@AEPIN, Harold L

Webb/AS1/AEPIN@AEPIN, Anthony J Boyd/AS1/AEPIN@AEPIN,

Brent L Busch/AS1/AEPIN@AEPIN, Dennis R

Jones/CA1/AEPIN@AEPIN, Darrell E Guill/RO1/AEPIN@AEPIN, E J

Clayton/CH1/AEPIN@AEPIN, Mohan K

Sachdeva/OR4/AEPIN@AEPIN, Paul B Johnson/OR4/AEPIN@AEPIN

Subject: Re: Foothills Generating, LLC

The relay settings will be available by the end of November 2001 ----- Forwarded by Jay H Johnson/RO1/AEPIN on 09/18/2001 01:42 PM -----

Jay H Johnson

To: <poconnor@psdohio.com>

09/12/2001 10:20 AM

cc: "Bryan W. Johnson \(E-mail\)" < Bryan.Johnson@Dynegy.com>,
"Brian Tschanen \(E-mail\)" < btschanen@vaughnindustries.com>,
"Don Hoy \(E-mail\)" < Don.Hoy@Dynegy.com>, "Jay Johnson
\(E-mail\)" < jhjohnson@aep.com>, "Ron Wellman \(E-mail\)"

<rjwellman@aep.com>, "Robert C. Havlik \(E-mail\)"
<Robert.C.Havlik@Dynegy.com>, Timothy V

Strader/AS1/AEPIN@AEPIN

Subject: Re: Foothills Generating, LLC

Please note comments below in red "Paul O'Connor" < poconnor@psdohio.com>



"Paul O'Connor" <poconnor@psdohio. com>

09/08/2001 11:10 AM Please respond to poconnor To: "Jay Johnson \(E-mail\)" < jhjohnson@aep.com > , "Ron Wellman \(E-mail\)" < rjwellman@aep.com >

cc: "Bryan W. Johnson \(E-mail\)" < Bryan.Johnson@Dynegy.com>,
"Don Hoy \(E-mail\)" < Don.Hoy@Dynegy.com>, "Robert C. Havlik
\(E-mail\)" < Robert.C.Havlik@Dynegy.com>, "Brian Tschanen
\(E-mail\)" < btschanen@vaughnindustries.com>

Subject: Foothills Generating, LLC

KPSC Case No. 2017-00472 Riverside's First Set of Data Requests Dated May 18, 2018 Item No. 3 Attachment 1 Page 68 of 89

Gentlemen,

Some interface questions:

The Riverside Phase conductors do not move from their existing attachments in Bay #4 at any time.Correct

The Foothills Phase conductor attachments will be located in Bay #5 at the same elevation and relative attachments as the Riverside conductors in Bay #4. (we have not seen any revised structural drawings for Baker) Will be 6 ft higher than Riverside

The existing OPGWs will end up in essentially the same locations of their present attachments except the attachment point will move to the East face of the column rather than at the static peak. This would move the attachment point approximately 2' to the East Correct

The OPGWs attachments will need to be temporarily relocated during construction of the Bay #4 vertical additions. Originally AEP was going to handle the moves to and from the temporary attachment points. However in a recent conversation with Jay, he indicated that he might want PSD to handle these relocations. I honestly see this becoming a coordination problem in the field and respectfully suggest that this work should be performed by AEP. To date PSD has not purchased any additional materials associated with the relocations of the OPGWs.AEP will not perform

We have been assuming that AEP will develop protective relay settings for the line relays including the backup ground relays at the Foothills end of the line, just as was done for Riverside. Do you have an idea when those proposed settings will be available for review? Will advise

Finally, we are still on schedule to pour the S6A foundation on 9/15. Structure S6A will be on site 9/10 and all other line materials are presently on site. KYDOT and CSX are being notified of our plans to begin the line stringing outage on 10/15. We continue to assume that Bay #5 will be available to terminate the Foothills conductors during the planned outage schedule.

Please review and let me have your responses as soon as possible.

Thanks.

Best regards,

Paul O'Connor P.S.D., Inc.

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Jay H Johnson 09/05/2001 02:22 PM To: Masoud Rafiee/OR4/AEPIN@AEPIN, Ronald J
Wellman/OR2/AEPIN@AEPIN, Dennis R Jones/CA1/AEPIN@AEPIN,
Jeffrey A Barsch/CA1/AEPIN@AEPIN, T David
Parrish/OR2/AEPIN@AEPIN, Matthew S
Williams/OR2/AEPIN@AEPIN, Paul G Johnson
Jr/CH1/AEPIN@AEPIN, Roderick A Oberster/OR4/AEPIN@AEPIN,
Johnny R Garcia/OR2/AEPIN@AEPIN

cc: Ronald D Ryan/OR2/AEPIN@AEPIN, Timothy V
Strader/AS1/AEPIN@AEPIN, Donald F Lowry/OR3/AEPIN@AEPIN,
Mohan K Sachdeva/OR4/AEPIN@AEPIN, Anthony J
Boyd/AS1/AEPIN@AEPIN, Richard D Smelker/OR4/AEPIN@AEPIN,
Brent L Busch/AS1/AEPIN@AEPIN, Darrell E
Guill/RO1/AEPIN@AEPIN, Terry D Hutchinson/AS1/AEPIN@AEPIN,
Tony Paragon/CH1/AEPIN@AEPIN, John W
Shields/OR3/AEPIN@AEPIN, Paul B Johnson/OR4/AEPIN@AEPIN,
Mark G Majka/OR2/AEPIN@AEPIN, Kevin F
Duffy/OR2/AEPIN@AEPIN

cc: Ronald D Ryan/OR2/AEPIN@AEPIN, Timothy V
Strader/AS1/AEPIN@AEPIN, Donald F Lowry/OR3/AEPIN@AEPIN,
Mohan K Sachdeva/OR4/AEPIN@AEPIN, Anthony J
Boyd/AS1/AEPIN@AEPIN, Richard D Smelker/OR4/AEPIN@AEPIN,
Brent L Busch/AS1/AEPIN@AEPIN, Darrell E
Guill/RO1/AEPIN@AEPIN, Terry D Hutchinson/AS1/AEPIN@AEPIN,
Tony Paragon/CH1/AEPIN@AEPIN, John W
Shields/OR3/AEPIN@AEPIN, Paul B Johnson/OR4/AEPIN@AEPIN,
Mark G Majka/OR2/AEPIN@AEPIN, Kevin F
Duffy/OR2/AEPIN@AEPIN

Subject: Baker Station-Dynegy/Foothills Project

Privileged

Work began on September 4, 2001 on the installation of foundations for adding a 345kv bay, one 345kv CB and associated equipment. The new bay is scheduled to be erected by November 15, 2001 and the new CB is scheduled to be placed in service by January 31, 2002.

Privileged

Engineering, design and construction should proceed per attached schedules.

AEP legal and contracting


7/2



Baker Foothills-add 345kV bay.mBaker Foothills-Add 345kV CB.m

KPSC Case No. 2017-00472 Riverside's First Set of Data Requests Dated May 18, 2018

-								June	July	August		Octobe	
ID	0	Task Name	Duration	Start	Actual Start	Finish	Actual Finish	Jun	Jul	Aug	Sep	Oct	Nov
68 1 Jo 2 02 3									1				
₹ 2 С	12.	Baker Foothills Add 345kv Bay	100 days	Fri 06/29/01	Fri 06/29/01	Thu 11/15/01	NA						
N 3	1	Engineering & Design	31 days	Fri 06/29/01	Fri 06/29/01	Fri 08/10/01	Fri 08/10/01		20000000			1	
စ္တ တို့ 4	V	Preplanning	1 day	Fri 06/29/01	Fri 06/29/01	Fri 06/29/01	Fri 06/29/01						
5	V	Work Package	15 days	Fri 06/29/01	Fri 06/29/01	Thu 07/19/01	Thu 07/19/01		00000		: e		
6	1	Initiate Work Package	15 days	Fri 06/29/01	Fri 06/29/01	Thu 07/19/01	Thu 07/19/01		00000				
7	1	FWP Issued	17 days	Thu 07/19/01	Thu 07/19/01	Fri 08/10/01	Fri 08/10/01		E-C-1				
8	1	Structural Engineering	29 days	Tue 07/03/01	Tue 07/03/01	Fri 08/10/01	Fri 08/10/01		3000000			1	į
9	1	Foundation & Steel Issue	1 day	Fri 08/10/01	Fri 08/10/01	Fri 08/10/01	Fri 08/10/01				1 8	1 1 5	
10	1	Order structural steel	1 day	Fri 06/29/01	Fri 06/29/01	Fri 06/29/01	Fri 06/29/01		Į.	•		1 1 1	
11		Fabricate steel	70 days	Tue 07/03/01	Tue 07/03/01	Mon 10/08/01	NA						
12		Shop assemble steel	10 days	Mon 10/08/01	NA	Fri 10/19/01	NA						
13		Steel ready for delivery	1 day	Fri 10/19/01	NA	Fri 10/19/01	NA						:
14	in the second	Deliver structural steel	6 days	Fri 10/19/01	NA	Fri 10/26/01	NA						
15		Construction	53 days	Tue 09/04/01	Tue 09/04/01	Thu 11/15/01	NA						
16		Construction start	1 day	Tue 09/04/01	Tue 09/04/01	Tue 09/04/01	NA					1	i i
17		Install below grade	28 days	Tue 09/04/01	Tue 09/04/01	Thu 10/11/01	NA						
18	Total Inches	Install above grade	24 days	Mon 10/15/01	NA	Thu 11/15/01	NA						
19		Construction complete Bay #5 erected	1 day	Thu 11/15/01	NA	Thu 11/15/01	NA				1 :	1 12-1-1-1	

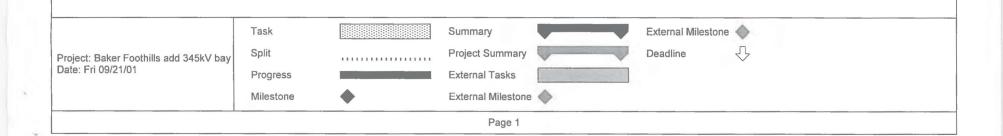


KPSC Case No. 2017-00472 Riverside's First Set of Data Requests Dated May 18, 2018 Item No. 3

	T T									
ID	Task Name		Duration	Start	Actual Start	Finish	Actual Finish	Qtr 4	Qtr 1	Qtr 2
ე 0	Baker_Foothills-Add_34	5kV_CB	362 days	Tue 01/02/01	Tue 01/02/01	Fri 06/07/02	NA		1	
₽ 1	Engineering & Design		252 days	Tue 01/02/01	Tue 01/02/01	Wed 01/02/02	NA	1		
~ 2	Pre Planning (SE01)		10 days	Tue 06/26/01	Tue 06/26/01	Wed 07/11/01	Wed 07/11/01			
Page 71 of 89	Work Package (SE02	2)	23 days	Wed 07/11/01	Wed 07/11/01	Fri 08/10/01	Fri 08/10/01			
4	Initiate Work Pac	kage IWP	16 days	Wed 07/11/01	Wed 07/11/01	Wed 08/01/01	Wed 08/01/01		-	
5	FWP Issued		17 days	Thu 07/19/01	Thu 07/19/01	Fri 08/10/01	Fri 08/10/01			
6	Order CT/PT		1 day	Wed 06/27/01	Wed 06/27/01	Wed 06/27/01	Wed 06/27/01			
7	Manufacture CT/PT		128 days	Wed 06/27/01	Wed 06/27/01	Wed 01/02/02	NA			
8	CT/PT Ready for Deliv	very	0 days	Mon 12/31/01	NA	Mon 12/31/01	NA			
9	Order CB's		1 day	Thu 06/28/01	Thu 06/28/01	Thu 06/28/01	Thu 06/28/01			
10	Manufacture CB's		91 days	Thu 06/28/01	Thu 06/28/01	Tue 11/06/01	NA			
11	CB's Ready for Delive	ery	0 days	Thu 11/01/01	NA	Thu 11/01/01	NA		1	
12	Order Steel		0.38 days	Fri 06/29/01	Fri 06/29/01	Fri 06/29/01	Fri 06/29/01			
13	Manufacture Steel		70 days	Fri 06/29/01	Fri 06/29/01	Tue 10/09/01	NA			
14	Steel Ready for Delive	ery	5 days	Mon 10/22/01	Mon 10/22/01	Fri 10/26/01	NA		1	
15	Physical Design (SE	06)	60 days	Fri 08/10/01	Fri 08/10/01	Fri 11/02/01	NA		1	
16	EA		2.5 days	Fri 08/10/01	Fri 08/10/01	Fri 11/02/01	NA			
17	EA Issued		0.13 days	Fri 11/02/01	NA	Fri 11/02/01	NA		;	
18	EA Repro To Fie	ld	0 days	Fri 11/02/01	NA	Fri 11/02/01	NA		*	
19	Elementary Design (SE07)	79 days	Tue 07/31/01	Tue 07/31/01	Mon 11/19/01	NA		1	
20	Elem Drawings		7.88 days	Tue 07/31/01	Tue 07/31/01	Fri 09/21/01	NA		1	
21	Front Views		1.5 days	Thu 09/20/01	NA	Fri 09/21/01	NA		1	
22	Elem Approval		0 days	Fri 09/21/01	NA	Fri 09/21/01	NA			
23	Order Swbd Pnls		1.5 days	Mon 09/24/01	NA	Tue 09/25/01	NA			
24	Fabricate Swbd I	Pnls	40 days	Tue 09/25/01	NA	Mon 11/19/01	NA		-	
25	Deliver Swbd Pr	nls	0 days	Mon 11/19/01	NA	Mon 11/19/01	NA			
26	Wiring Design (SE08	3)	15 days	Fri 10/26/01	NA	Fri 11/16/01	NA			
27	Wiring Drawings		0 days	Fri 10/26/01	NA	Fri 10/26/01	NA			
28	Control Wiring Is	sued	0 days	Fri 11/16/01	NA	Fri 11/16/01	NA			
		Task		Rolled Up	Task	Dro	ject Summary			
			(2273222222222222222222							
Droinet	Boker Footbille Add 245124 C	Split		Rolled Up	o Split	Ext	ernal Milestone	7		
	: Baker_Foothills-Add_345kV_C ri 09/21/01	Progress		Rolled Up	Milestone 🔷	Ext	ernal Milestone			
		Milestone		Rolled Up	Progress	Ext	ernal Milestone			
		Summary		External	Tasks	De	adline	}		
				D	age 1					

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CW Repro To Fiel Cable Schedule Issue Construction Issue Construction Foundation & Steel FND Repro To Fiel Order Struct Steel Fabricate Steel Steel Ready for Don Site on Site Intruction Review Issued Dwgs (Steel Construction Start Install Below Grade (Steel)	Dwgs I Issued (SE05) Id	0 days 0 days 0 days 196 days 0 days 0 days 0 days 0.75 days 70 days 19 days 0 days 207 days	Fri 11/16/01 Fri 11/16/01 Fri 11/16/01 Tue 01/02/01 Fri 08/10/01 Fri 08/10/01 Fri 06/29/01 Fri 06/29/01 Tue 01/02/01 Fri 11/30/01 Mon 10/08/01	NA NA NA Tue 01/02/01 Fri 08/10/01 NA Fri 06/29/01 Fri 06/29/01 NA	Fri 11/16/01 Fri 11/16/01 Fri 11/16/01 Tue 10/09/01 Fri 08/10/01 Fri 08/10/01 Fri 06/29/01 Tue 10/09/01 Fri 01/26/01 Fri 11/30/01	NA NA NA NA NA NA NA NA		NA NA	
Issue Construction Itructual Engineering Foundation & Steel FND Repro To Fie Order Struct Steel Fabricate Steel Steel Ready for Do on Site truction Review Issued Dwgs (Steel)	el Issued (SE05)	0 days 196 days 0 days 0 days 0.75 days 70 days 19 days 0 days 6 days	Fri 11/16/01 Tue 01/02/01 Fri 08/10/01 Fri 08/29/01 Fri 06/29/01 Tue 01/02/01 Fri 11/30/01 Mon 10/08/01	NA Tue 01/02/01 Fri 08/10/01 NA Fri 06/29/01 Fri 06/29/01 NA NA	Fri 11/16/01 Tue 10/09/01 Fri 08/10/01 Fri 08/10/01 Fri 06/29/01 Tue 10/09/01 Fri 01/26/01 Fri 11/30/01	NA NA NA NA NA NA	•	NA NA	
Foundation & Steel FND Repro To Fie Order Struct Steel Fabricate Steel Steel Ready for Don Site on Site truction Review Issued Dwgs (3)	el Issued (SE05)	196 days 0 days 0 days 0.75 days 70 days 19 days 0 days 207 days	Tue 01/02/01 Fri 08/10/01 Fri 08/10/01 Fri 06/29/01 Fri 06/29/01 Tue 01/02/01 Fri 11/30/01 Mon 10/08/01	Tue 01/02/01 Fri 08/10/01 NA Fri 06/29/01 Fri 06/29/01 NA NA	Tue 10/09/01 Fri 08/10/01 Fri 08/29/01 Fri 06/29/01 Tue 10/09/01 Fri 01/26/01 Fri 11/30/01	NA NA NA NA NA	•	NA NA	
Foundation & Stee FND Repro To Fie Order Struct Steel Fabricate Steel Steel Ready for Do on Site on Site truction Review Issued Dwgs (5	el Issued (SE05)	0 days 0 days 0.75 days 70 days 19 days 0 days 6 days	Fri 08/10/01 Fri 08/10/01 Fri 06/29/01 Fri 06/29/01 Tue 01/02/01 Fri 11/30/01 Mon 10/08/01	Fri 08/10/01 NA Fri 06/29/01 Fri 06/29/01 NA	Fri 08/10/01 Fri 08/10/01 Fri 06/29/01 Tue 10/09/01 Fri 01/26/01 Fri 11/30/01	NA NA NA NA	•	NA	
FND Repro To Fie Order Struct Steel Fabricate Steel Steel Ready for Do on Site on Site truction Review Issued Dwgs (Sonstruction Start	ld	0 days 0.75 days 70 days 19 days 0 days 6 days 207 days	Fri 08/10/01 Fri 06/29/01 Fri 06/29/01 Tue 01/02/01 Fri 11/30/01 Mon 10/08/01	NA Fri 06/29/01 Fri 06/29/01 NA NA	Fri 08/10/01 Fri 06/29/01 Tue 10/09/01 Fri 01/26/01 Fri 11/30/01	NA NA NA		■ NA	
Order Struct Steel Fabricate Steel Steel Ready for Don Site on Site truction Review Issued Dwgs (Steel)	elivery	0.75 days 70 days 19 days 0 days 6 days 207 days	Fri 06/29/01 Fri 06/29/01 Tue 01/02/01 Fri 11/30/01 Mon 10/08/01	Fri 06/29/01 Fri 06/29/01 NA NA	Fri 06/29/01 Tue 10/09/01 Fri 01/26/01 Fri 11/30/01	NA NA NA		■ NA	
Fabricate Steel Steel Ready for Don Site on Site truction Review Issued Dwgs (Steel)	alivery	70 days 19 days 0 days 6 days 207 days	Fri 06/29/01 Tue 01/02/01 Fri 11/30/01 Mon 10/08/01	Fri 06/29/01 NA NA	Tue 10/09/01 Fri 01/26/01 Fri 11/30/01	NA NA		NA NA	
Steel Ready for Don Site on Site truction Review Issued Dwgs (Steel Construction Start		19 days 0 days 6 days 207 days	Tue 01/02/01 Fri 11/30/01 Mon 10/08/01	NA NA	Fri 01/26/01 Fri 11/30/01	NA		NA NA	
on Site on Site truction Review Issued Dwgs (S Construction Start		0 days 6 days 207 days	Fri 11/30/01 Mon 10/08/01	NA	Fri 11/30/01			NA NA	
on Site truction Review Issued Dwgs (S Construction Start	SC12)	6 days 207 days	Mon 10/08/01			NA			
truction Review Issued Dwgs (S Construction Start	SC12)	207 days		NA				1	
Review Issued Dwgs (S Construction Start	SC12)		Mon 08/13/01		Mon 10/15/01	NA		1	
Construction Start	SC12)	14 days	181011 00/13/01	Mon 08/13/01	Fri 06/07/02	NA			
		14 days	Mon 08/13/01	Mon 08/13/01	Thu 08/30/01	NA			
nstall Below Grade (S		1 day	Tue 09/04/01	Tue 09/04/01	Tue 09/04/01	Tue 09/04/01			
	C14)	70 days	Tue 09/04/01	Tue 09/04/01	Wed 12/12/01	NA		1	
nstall Above Grade (S	C15) (Structu	30 days	Mon 10/08/01	NA	Fri 11/16/01	NA			
quip Set / Assemble	SC16) (Inc. C	68 days	Thu 09/20/01	NA	Fri 12/28/01	NA			
Breaker Inst. Prep		6 days	Fri 12/07/01	NA	Fri 12/14/01	NA		}	
Panel Fabr / Wiring (SC17)	25 days	Mon 09/10/01	NA	Fri 10/26/01	NA			
Electrical Control Wirin	g (SC18)	5 days	Mon 10/29/01	NA	Fri 11/02/01	NA			
Equipt Testing		5 days	Fri 12/28/01	NA	Fri 01/04/02	NA			
Stoning		20 days	Wed 01/02/02	NA	Tue 01/29/02	NA			
PC Test & Check Out	SC19)	15 days	Fri 01/11/02	NA	Thu 01/31/02	NA			
n Service		0 days	Thu 01/31/02	NA	Thu 01/31/02	NA			
MP return to DSN Of	ice (SC22)	32 hrs	Mon 02/25/02	NA	Thu 02/28/02	NA		}	
Project Closure (SE0	9)	11 days	Thu 05/23/02	NA	Fri 06/07/02	NA			
Rev. FMP Dwg's	ssued	9.75 days	Thu 05/23/02	NA	Thu 06/06/02	NA		:	
Project Closure		4 days	Tue 06/04/02	NA	Fri 06/07/02	NA		}	
	Panel Fabr / Wiring (S Electrical Control Wirin Equipt Testing Stoning PC Test & Check Out (In Service FMP return to DSN Off Project Closure (SE0)	Panel Fabr / Wiring (SC17) Electrical Control Wiring (SC18) Equipt Testing Stoning PC Test & Check Out (SC19) In Service FMP return to DSN Office (SC22) Project Closure (SE09) Rev. FMP Dwg's Issued	Panel Fabr / Wiring (SC17) 25 days Electrical Control Wiring (SC18) 5 days Equipt Testing 5 days Stoning 20 days PC Test & Check Out (SC19) 15 days In Service 0 days FMP return to DSN Office (SC22) 32 hrs Project Closure (SE09) 11 days Rev. FMP Dwg's Issued 9.75 days	Panel Fabr / Wiring (SC17) 25 days Mon 09/10/01 Electrical Control Wiring (SC18) 5 days Mon 10/29/01 Equipt Testing 5 days Fri 12/28/01 Stoning 20 days Wed 01/02/02 PC Test & Check Out (SC19) 15 days Fri 01/11/02 n Service 0 days Thu 01/31/02 FMP return to DSN Office (SC22) 32 hrs Mon 02/25/02 Project Closure (SE09) 11 days Thu 05/23/02 Rev. FMP Dwg's Issued 9.75 days Thu 05/23/02	Panel Fabr / Wiring (SC17) 25 days Mon 09/10/01 NA Electrical Control Wiring (SC18) 5 days Mon 10/29/01 NA Equipt Testing 5 days Fri 12/28/01 NA Stoning 20 days Wed 01/02/02 NA PC Test & Check Out (SC19) 15 days Fri 01/11/02 NA n Service 0 days Thu 01/31/02 NA FMP return to DSN Office (SC22) 32 hrs Mon 02/25/02 NA Project Closure (SE09) 11 days Thu 05/23/02 NA Rev. FMP Dwg's Issued 9.75 days Thu 05/23/02 NA	Panel Fabr / Wiring (SC17) 25 days Mon 09/10/01 NA Fri 10/26/01 Electrical Control Wiring (SC18) 5 days Mon 10/29/01 NA Fri 11/02/01 Equipt Testing 5 days Fri 12/28/01 NA Fri 01/04/02 Stoning 20 days Wed 01/02/02 NA Tue 01/29/02 PC Test & Check Out (SC19) 15 days Fri 01/11/02 NA Thu 01/31/02 In Service 0 days Thu 01/31/02 NA Thu 01/31/02 FMP return to DSN Office (SC22) 32 hrs Mon 02/25/02 NA Thu 02/28/02 Project Closure (SE09) 11 days Thu 05/23/02 NA Fri 06/07/02 Rev. FMP Dwg's Issued 9.75 days Thu 05/23/02 NA Thu 06/06/02	Panel Fabr / Wiring (SC17) 25 days	Panel Fabr / Wiring (SC17) 25 days Mon 09/10/01 NA Fri 10/26/01 NA Electrical Control Wiring (SC18) 5 days Mon 10/29/01 NA Fri 11/02/01 NA Equipt Testing 5 days Fri 12/28/01 NA Fri 01/04/02 NA Stoning 20 days Wed 01/02/02 NA Tue 01/29/02 NA PC Test & Check Out (SC19) 15 days Fri 01/11/02 NA Thu 01/31/02 NA In Service 0 days Thu 01/31/02 NA Thu 01/31/02 NA FMP return to DSN Office (SC22) 32 hrs Mon 02/25/02 NA Thu 02/28/02 NA Project Closure (SE09) 11 days Thu 05/23/02 NA Thu 06/06/02 NA Rev. FMP Dwg's Issued 9.75 days Thu 05/23/02 NA Thu 06/06/02 NA	Panel Fabr / Wiring (SC17) 25 days Mon 09/10/01 NA Fri 10/26/01 NA Electrical Control Wiring (SC18) 5 days Mon 10/29/01 NA Fri 11/02/01 NA Equipt Testing 5 days Fri 12/28/01 NA Fri 01/04/02 NA Stoning 20 days Wed 01/02/02 NA Tue 01/29/02 NA PC Test & Check Out (SC19) 15 days Fri 01/11/02 NA Thu 01/31/02 NA PService 0 days Thu 01/31/02 NA Thu 01/31/02 NA FMP return to DSN Office (SC22) 32 hrs Mon 02/25/02 NA Thu 02/28/02 NA Project Closure (SE09) 11 days Thu 05/23/02 NA Thu 06/06/02 NA Rev. FMP Dwg's Issued 9.75 days Thu 05/23/02 NA Thu 06/06/02 NA

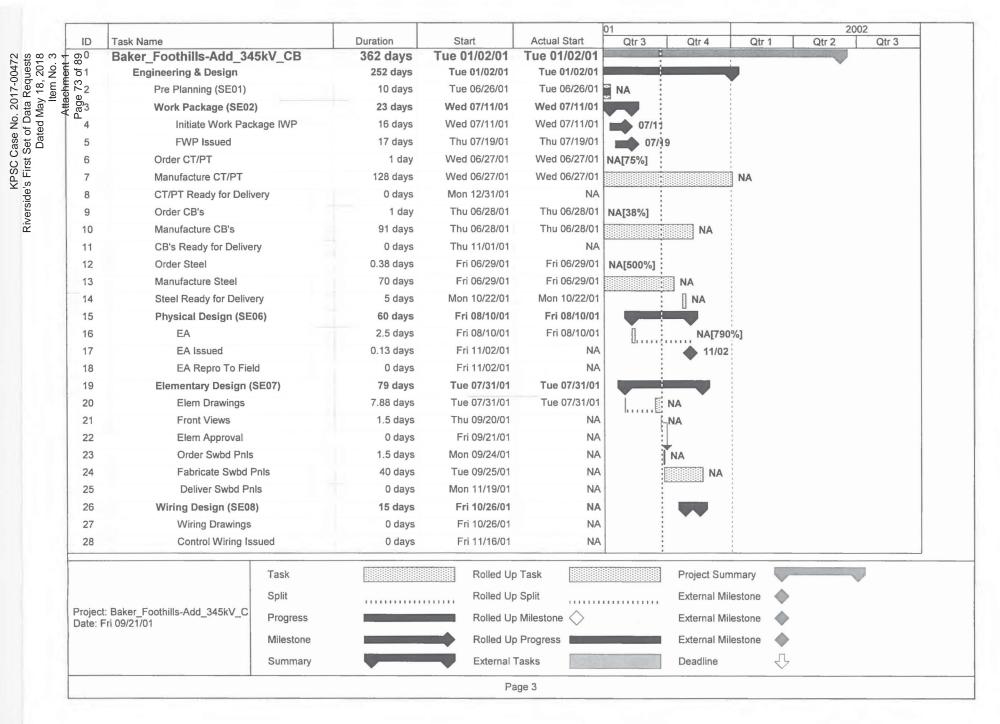

						01				2002	
ID	Task Name		Duration	Start	Actual Start	Qtr 3	Qtr 4	Qtr 1	Qtr 2	Qtr 3	
29	CW Repro To Fie	eld	0 days	Fri 11/16/01	NA			1			
5 30	Cable Schedule		0 days	Fri 11/16/01	NA						
31 D	Issue Construction	n Dwgs	0 days	Fri 11/16/01	NA			1			
5 30 - 31 - 32	Structual Engineerin	9	196 days	Tue 01/02/01	Tue 01/02/01						
33	Foundation & Ste	el Issued (SE05)	0 days	Fri 08/10/01	Fri 08/10/01						
34	FND Repro To Fi	eld	0 days	Fri 08/10/01	NA		•				
35	Order Struct Stee	el	0.75 days	Fri 06/29/01	Fri 06/29/01	NA	•	İ			
36	Fabricate Steel		70 days	Fri 06/29/01	Fri 06/29/01		NA	t t			
37	Steel Ready for D	Delivery	19 days	Tue 01/02/01	NA						
38	CB's on Site		0 days	Fri 11/30/01	NA						
39	Steel on Site		6 days	Mon 10/08/01	NA		NA NA				
40	Construction		207 days	Mon 08/13/01	Mon 08/13/01						
41	Review Issued Dwgs	(SC12)	14 days	Mon 08/13/01	Mon 08/13/01	■ N	A[171%]		•		
42	Construction Start		1 day	Tue 09/04/01	Tue 09/04/01		×Α				
43	Install Below Grade (S	SC14)	70 days	Tue 09/04/01	Tue 09/04/01			09/04			
44	Install Above Grade (S	SC15) (Structu	30 days	Mon 10/08/01	NA		10/0	08			
45	Equip Set / Assemble	(SC16) (Inc. C	68 days	Thu 09/20/01	NA			09/20			
46	Breaker Inst. Prep		6 days	Fri 12/07/01	NA		. IN	İΑ			
47	Panel Fabr / Wiring	(SC17)	25 days	Mon 09/10/01	NA		09/10	ļ			
48	Electrical Control Wiri	ng (SC18)	5 days	Mon 10/29/01	NA		10/29				
49	Equipt Testing		5 days	Fri 12/28/01	NA			NA			
50	Stoning		20 days	Wed 01/02/02	NA			NA NA			
51	PC Test & Check Out	(SC19)	15 days	Fri 01/11/02	NA			01/1	11		
52	In Service		0 days	Thu 01/31/02	NA						
53	FMP return to DSN O	ffice (SC22)	32 hrs	Mon 02/25/02	NA			l N	IA		
54	Project Closure (SE	09)	11 days	Thu 05/23/02	NA		*	:			
55	Rev. FMP Dwg's	Issued	9.75 days	Thu 05/23/02	NA			:	1	AV	
56	Project Closure		4 days	Tue 06/04/02	NA				[]	NA	
56	Project Closure		4 days	Tue 06/04/02	NA			:	[333]		
		Task		Rolled Up	Task		Project Sun	nmary			
		Split		Rolled Up	Split		External Mil	lestone 🬗	>		
Project: Date: F	Baker_Foothills-Add_345kV_C ri 09/21/01	Progress		Rolled Up	Milestone 🔷		External Mil	lestone 🤚	>		
		Milestone		Rolled Up	Progress	-	External Mi	lestone 🤚	>		
		Summary		External T	asks		Deadline	£	}		
				Pag	ge 4						

KPSC Case No. 2017-00472 Riverside's First Set of Data Requests Dated May 18, 2018 Item No. 3 Attachment 1 Page 75 of 89



To: E J Clayton/CH1/AEPIN@AEPIN, Errol K Wagner/AS1/AEPIN@AEPIN

cc:

Subject: NUG Addendum

FYI ...

Basically, they would fill in II. and we would fill in III. and IV. based upon that information.



NUG Addendum - 7-30-2001.

KPSC Case No. 2017-00472
Riverside's First Set of Data Requests
Dated May 18, 2018
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ALCARIC Attachment 1
LICENTE Page 76 of 89

FAX Transmission

From:

E. J. Clayton

American Electric Power

Questions?

Call (606) 327-1137

1701 Central Avenue

Fax (606) 327-1246

Ashland, KY 41105

To:

Jim Current

(713) 507-3935

Company:

Dynegy Marketing and

Trade

Address:

1000 Louisiana Street, Suite Fax: (713) 767-8521

5800

Houston, TX

Date:

February 8, 2002

Time:

11:50AM

:Pages (including this one)

Jim

Included is the revised service agreement. Changes include description in service delivery point, meter equipment, and contracted capacity. Because new AEP Facilities were required for this service, a new initial term of 2 years is required per the QP Tariff.

I have included the QP Tariff Terms for your review. An additional security deposit will not be required, based on our recent discussions and the proactive measures you have implemented to resolve recent payment problems. Maintaining good credit history is essential in avoiding future request for adjustment, of account security deposit.

Please note that totalizing two meters for this one account does restrict recall of certain meter data. Specifically, the peak reactive demand for each meter will only be recorded and displayed on your bill invoice, as a totalized value. Other bill parameters are unaffected, and will be displayed on your totalized bill invoice with assigned meter ID's and energy usage listed.

Please authorize the fax copy of the agreement and return to my attention at fax number (606-327-1246). The original agreement forms have been mailed to your attention. Please complete these original forms and return in the envelope provided.

Upon confirmation of the proposed service agreement, I will notify AEP Personnel and confirm scheduling of your requested service connection date.

E. J. Clayton (606) 327-1137

KPSC Case No. 2017-00472 Riverside's First Set of Data Requests Dated May 18, 2018 2ND REVISED SHEET NOtem No13

CANCELING 1ST REVISED SHEETAHOCHMERT

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TARIFF Q.P. (Quantity Power)

AVAILABILITY OF SERVICE.

Available for commercial and industrial customers with demands less than 7,500 KW. Customers shall contract for a definite amount of electrical capacity in kilowatts which shall be sufficient to meet normal maximum requirements, but in no case shall the contract capacity be less than 1,000 KW.

RATE.

	_		Service	Voltage		
	Primary	Subtrans	mission	Transmiss	sion	
Tariff Code		358		359		360
Service Charge per Month	\$	276.00	\$	662.00	\$	1,353.00
Demand Charge per KW						
Of monthly on-peak billing demand	\$	9.29	\$	8.51	\$	7.88
Of monthly off-peak excess						
Billing demand	\$	0.90	\$	0.86	\$	0.85
Energy Charge per KWH		1.220¢		1.171¢		1.155¢
Reactive Demand Charge for each kilovar of maxil Leading or Lagging reactive Demand in Excess of 50 percent of the KW of monthly metered demand				.\$ 0.57 KVAR		

MINIMUM CHARGE.

This tariff is subject to a minimum charge equal to the Service Charge plus the Demand Charge multiplied by the billing demand.

FUEL ADJUSTMENT CLAUSE.

Bills computed according to the rates set forth herein will be increased or decreased by a Fuel Adjustment Factor per KWH calculated in compliance with the Fuel Adjustment Clause contained in Sheet Nos. 5-1 and 5-2 of this Tariff Schedule.

SYSTEM SALES CLAUSE.

Bills computed according to the rates set forth herein will be increased or decreased by a System Sales Factor per KWH calculated in compliance with the System Sales Clause contained in Sheet Nos. 19-1 and 19-2 of this Tariff Schedule.

EXPERIMENTAL DEMAND-SIDE MANAGEMENT ADJUSTMENT CLAUSE.

Bills computed according to the rates set forth herein will be increased or decreased by an Experimental Demand-Side Management Adjustment Clause Factor per KWH calculated in compliance with the Experimental Demand-Side Management Adjustment Clause contained in Sheet Nos. 22-1 and 22-2 of this Tariff Schedule. Unless the customer is an industrial who has elected to opt-out in accordance with the terms pursuant to the Commission's Order in Case No. 95-427.

ENVIRONMENTAL SURCHARGE.

Bills computed according to the rates set forth herein will be increased or decreased by an Environmental Surcharge Adjustment based on a percent of revenue in compliance with the Environmental Surcharge contained in Sheet Nos. 23-1 and 23-2 of this Tariff Schedule.

NET MERGER SAVINGS CREDIT.

Bills computed according to the rates set forth herein will be decreased by a Net Merger Savings Credit Factor per KWH calculated in compliance with the Net Merger Savings Credit contained in Sheet No. 25-1 of this Tariff Schedule.

(Cont'd. On Sheet No. 10-2)

DATE OF ISSUE _	July 2, 1999	DATE EFFECTIVE	Bills rendered on and after May 27, 1997
ISSUED BY	E. K. WAGNER	DIRECTOR OF REGULATORY AFFA	AIRS ASHLAND, KENTUCKY
	NAME	TITLE	ADDRESS
Issued by authority	of an Order of the Public Se	ervice Commission in Case No. 99-149 dat	ted June 14, 1999

KPSC Case No. 2017-00472
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Dated May 18, 2018
ORIGINAL
SHEET NO. Item No. 3
SHEET NAttachment 1

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TERMS AND CONDITIONS OF SERVICE (Cont'd.)

DEPOSITS.

The Company may require a minimum cash deposit or other guaranty to secure payment of bills except for customer's qualifying for service reconnection pursuant to 807 KAR 5:006, Section 15, Winter Hardship Reconnection. Service may be refused or discontinued for failure to pay the requested deposit. Upon request from a residential customer the deposit will be returned after 18 months if the customer has established a satisfactory payment record; but commercial deposits will be retained during the entire time that the account remains active.

A. Interest

Interest will be paid on all sums held on deposit at the rate indicated in KRS 278.460. The interest will be applied as a credit to the Customer's bill or will be paid to the Customer on an annual basis. If the deposit is refunded or credited to the Customer's bill prior to the deposit anniversary date, interest will be paid or credited to the Customer's bill on a pro-rated basis.

CANCELING

The Company will not pay interest on deposits after discontinuance of service to the Customer. Retention by the Company, prior to final settlement of any deposit or guaranty is not a payment or part payment of any bill for service. The Company shall have a reasonable time in which to obtain a final reading and to ascertain that the obligations of the Customer have been fully performed before being required to return any deposits.

B. Criteria for Waiver of Deposit Requirement

The Company may waive any deposit requirement based upon the following criteria which shall be considered by the Company cumulatively.

- Satisfactory payment history.
- 2. Statement from another utility showing satisfactory payment history.
- Another customer with satisfactory payment history is willing to sign as a guarantor for an amount equal to the required deposit.
- 4. Providing evidence of Surety Bond.

C. Method of Determination

- Calculated Deposits
 - a. Residential customers shall pay a calculated amount based upon actual usage data of the customer at the same or similar premises for the most recent 12-month period, if such information is available. If the actual usage data is not available, the deposit amount shall be based on the average bills of similar customers and premises in the customer class. The deposit shall not exceed 2/12 of the customer's actual or estimated annual bill.
 - b. Commercial customers shall pay a calculated amount based upon actual usage data of the customer at the same or similar premises for the most recent 12-month period, if such information is available. If the actual usage data is not available, the deposit amount shall be based on the typical bills of similar customers and premises in the customer class. The deposit shall not exceed 2/12 of the customer's actual or estimated annual bill.

D. Additional Deposit Requirement

If a deposit has been waived or returned and the customer fails to maintain a satisfactory payment record, the customer may be required to pay a deposit. If a change in usage or classification of service has occurred, the customer may be required to pay an additional deposit up to 2/12 of the annual usage.

E. Recalculation of Customers Deposit

When a deposit is held longer than 18 months, the customer may request that the deposit be recalculated based on the customer's actual usage. If the amount of deposit on the account differs from the recalculated amount by more than \$10.00 for a residential customer or 10 percent for a non-residential customer, the Company may collect any underpayment and shall refund any overpayment by check or credit to the customer's bill. No refund will be made if the customer's bill is delinquent at the time of the recalculation.

(Cont'd on Sheet No. 2-3)

DATE OF ISSUE _	January 30, 1996	DATE EFFECTIV	E February 26, 1992	
ISSUED BY	E. K. WAGNER	DIRECTOR OF RATES	ASHLAND, KENTUCKY	
1330ED B1	NAME	TITLE	ADDRESS	
Issued pursuant to F	Public Service Commission	Regulation 807KAR5:006 effective	February 26, 1992	

KPSC Case No. 2017-00472 Riverside's First Set of Data Requests

Dated May 18, 2018

CANCELING

3RD REVISED SHEET NO. __11em No. 3 2ND REVISED SHEET NO. _Attachment 1

Page 79 of 89 P.S.C. ELECTRIC NO. 7

TARIFF Q.P. (Cont'd.) (Quantity Power)

DELAYED PAYMENT CHARGE.

This tariff is net if account is paid in full within 15 days of date of bill. On all accounts not so paid, an additional charge of 5% of the unpaid balance will be made.

MONTHLY BILLING DEMAND.

The on-peak billing demand in KW shall be taken each month as the single highest 15-minute integrated peak in KW as registered during the month by a demand meter or indicator, or, at the Company's option, as the highest registration of a thermal type demand meter or indicator, but the monthly on-peak billing demand so established shall in no event be less than 60% of the greater of (a) the customer's contract capacity or (b) the customer's highest previously established monthly billing demand during the past 11 months.

Off-peak excess billing demand in any month shall be the amount of KW by which the off-peak billing demand exceeds the on-peak billing demand for the month.

The reactive demand in KVARs shall be taken each month as the highest single 15-minute integrated peak in KVARs as registered during the month by a demand meter or indicator, or, at the Company's option, as the highest registration of a thermal type demand meter or indicator.

For the purpose of this provision, the on-peak billing period is defined as 7:00A.M. to 9:00 P.M., Monday through Friday. The off-peak billing period is defined as 9:00 P.M. to 7:00A.M. for all weekdays and all hours of Saturday and Sunday.

TERM OF CONTRACT.

Contracts under this tariff will be made for an initial period of not less than two years and shall remain in effect thereafter until either party shall give at least 12 months' written notice to the other of the intention to terminate the contract. The Company reserves the right to require initial contracts for periods greater than two years. The Company may not be required to supply capacity in excess of that contracted for except by mutual agreement. Contracts will be made in multiples of 100 KW.

A new initial contract period will not be required for existing customers who change their contract requirements after the original initial period unless new or additional facilities are required.

SPECIAL TERMS AND CONDITIONS.

This tariff is subject to the Company's Terms and Conditions of Service.

This tariff is available for resale service to mining and industrial customers who furnish service to customer-owned camps or villages where living quarters are rented to employees and where the customer purchases power at a single point for both his power and camp requirements.

This tariff is also available to customers having other sources of energy supply, but who desire to purchase standby or back-up electric service from the Company. Where such conditions exist the customer shall contract for the maximum amount of demand in KW which the Company might be required to furnish, but not less than 1,000 KW. The Company shall not be obligated to supply demands in excess of that contracted for. Where service is supplied under the provisions of this paragraph, the billing demand each month shall be the highest determined for the current and previous two billing periods, and the minimum charge shall be as set forth under paragraph "Minimum Charge" above.

A customer's plant is considered as one or more buildings which are served by a single electrical distribution system provided and operated by customer. When the size of the customer's load necessitates the delivery of energy to the customer's plant over more than one circuit, the Company may elect to connect its circuits to different points on the customer's system irrespective of contrary provisions in Terms and Conditions of Service.

Customers with PURPA Section 210 qualifying cogeneration and/or small power production facilities shall take service under Tariff COGEN/SPP II or by special agreement with the Company.

DATE OF ISSU	JE <u>July 2, 1999</u>	DATE EFFECTIVE	Bills rendered on and September 29, 1997	
ISSUED BY _	E. K. WAGNER	DIRECTOR OF REGULATORY AFFAIR	RS ASHLAND, KENTUCKY	
	NAME	TITLE	ADDRESS	
Issued by author	ority of an Order of the Public	Service Commission in Case No. 99-149 dated	June 14, 1999	

KPSC Case No. 2017-00472 Riverside's First Set of Data Requests Dated May 18, 2018 Item No. 3 Attachment 1 Page 80 of 89

This Contract, entered into this 8th day of February 2002, by and between Kentucky Power Company dba American Electric Power, hereafter called the Company, and Riverside Generating Company, LLC, 1000 Louisiana Street, Suite 5800, Houston, TX, 77002-5050, or his or its heirs, successors or assigns, hereafter called the Customer,

Witnesseth:

For and in consideration of the mutual covenants and agreements hereinafter contained, the parties hereto agree with each other as follows:

The Company agrees to furnish to the Customer, during the term of this Contract, and the Customer agrees to take from the Company, subject to Company's standard Terms and Conditions of Service as regularly filed with the <u>Public Service Commission of Kentucky</u>, all the electric energy of the character specified herein that shall be purchased by the Customer in the premises located at <u>Rt. 2</u>, <u>Box 296</u>, <u>Catlettsburg</u>, <u>KY 41129</u>.

The Company is to furnish and the Customer is to take electric energy under the terms of this Contract for an initial period of 24 month(s) from the time such service is commenced, and continuing thereafter until terminated upon 12 months' written notice given by either party of its intention to terminate the Contract. The date that service shall be deemed to have commenced under this Contract shall be February 14, 2002.

The electric energy delivered hereunder shall be alternating current at approximately 345000 volts, 3-wire, 3-phase, and it shall be delivered at termination point of two customer owned 345 kV circuits at the AEP Baker 345 kV Station, which shall constitute the point of delivery under this Contract. The said electric energy shall be delivered at reasonably close maintenance to constant potential and frequency, and it shall be measured by a meter or meters owned and installed by the Company and located at AEP Baker 345 kV Electrical Station(2 meters).

The Customer acknowledges that the Customer may be eligible to receive service under more than one of the Company's schedules and that such options have been explained to the Customer. The Customer and Company agree that the Customer has chosen to receive service under the provisions of the Company's Tariff **QUANTITY POWER - TRANSMISSION**, code **360**. The Customer agrees to pay the Company monthly for electric energy delivered hereunder at the rates and under the provisions of the Company's Tariff **QUANTITY POWER - TRANSMISSION**, code **360**, as regularly filed with the **Public Service Commission of Kentucky**, as long as that schedule is in effect. In the event that the tariff chosen by the Customer is replaced by a new or revised tariff incorporating different rates or provisions, or both, the Company and Customer understand and agree that the Company will continue to provide service, and the Customer will continue to take service, under this Contract, subject to such changed provisions, and that the Customer will pay for such service at the new rates on and after the date such rates become effective.

The Customer's contract capacity under the tariff named herein is hereby fixed at 4.000kW. If a time-of-day demand is available under the tariff and is selected by the Customer, the reservation of capacity aforementioned shall be the peak period reservation of capacity and shall determine the tariff's minimum monthly billing demand. The amount of capacity requested during the off-peak period is 4000 kW.

There are no unwritten understandings or agreements relating to the service hereinabove provided. This Contract cancels and supersedes all previous agreements, relating to the purchase by Customer and sale by Company of electric energy at Customer's premises as referred to above, on the date that service under this Contract commences. This Contract shall be in full force and effect when signed by the authorized representatives of the parties hereto.

Kentucky Power Company	Riverside Generating Company, LLC
Ву:	By:
Mark A. Gundelfinger	
Title: Manager	Title:
Date:	Date:
Account Number: 034-873-686-0	

KPSC Case No. 2017-00472 Riverside's First Set of Data Requests Dated May 18, 2018 Item No. 3 Attachment 1 Page 81 of 89



Jim.Current@dynegy.c om 02/07/02 05:38 PM To: ejclayton@aep.com

cc: Dariusz.Rekowski@dynegy.com, Don.Hoy@dynegy.com,

Bryan.Johnson@dynegy.com

Subject: Foothills/Riverside Station Power Agreement Information

EJ,

Per our previous conversation, Dynegy would like, with respect to station power, to combine the meter data for the two meters at the Baker substation that would measure the power consumed at the Foothills facility and the Riverside facility. This combined bill would go to the same address as the Riverside bill is going, presently.

Also, I would like to set the contract capacity for the combined facility at 4000 KW. This is up from 2300 kw.

Sincerely, Jim Current

KPSC Case No. 2017-00472 Riverside's First Set of Data Requests Dated May 18, 2018 Item No. 3 Attachment 1 Page 82 of 89



To: Jim.Current@dynegy.com

cc:

Subject: Re: Billing

Jim

I previously requested correction from our billing group, on the highest recorded peak demand which you note below.

The billing group will replace the high previous demands with the correct values and credit the account accordingly.

I will send you notification when the correction is complete.

Regarding the contract capacity, the metered demand data is correct as shown on the report. You should be able

to use this information to identify your capacity requirements. If you notice, the peak demand was significantly higher in January

as compared to the other months. This peak demand occurred on January 02, 2002, between 5:45 and 6:00 pm.

Please let me know your combined capacity requirements, if the meters are totalized, and the individual capacity requirements

with the meters and accounts billed separately.

E. J. Clayton (606)327-1137 Jim.Current@dynegy.com



Jim.Current@dynegy.c

To: ejclayton@aep.com

CC:

02/07/02 12:11 PM Subject: Billing

EJ,

I was looking at the customer history record usage report that you faxed me to determine what our hi on peak usage has been to date. I intend to base our contract capacity going forward on that number. While doing so I noticed that the Dec 01 and Jan 01 Hi Prev Demand was 3696 and 4299, respectively. I could not find these peak demands on any of the previous months. Please take a look and give me a call to discuss. Here is what I think the money effect is.

The data shows that the 12/31/01 read date showed a hi previous of 3696 when I think it should be 2548 (from July 22 01 reading). 60% of 3696 = 2218 which is what our billing demand is for the 12/31/01 billing. If I am right, the 12/31 bill should be reduced by $(2218-1882) \times 7.88 = \2647.68

If you could explain where I am wrong that would be great.

Once I have the right data for the peak demand I will send you another e-mail as we discussed on the phone today.

Regards, Jim Current 713 507 3935

KPSC Case No. 2017-00472
Riverside's First Set of Data Requests
Dated May 18, 2018
Item No. 3

AMERIC Attachment 1

LICINI Page 83 of 89

FAX Transmission

From: E. J. Clayton American Electric Power

Questions? Call (606) 327-1137 1701 Central Avenue Fax (606) 327-1246 Ashland, KY 41105

To: Jim Current (713) 507-3935

Company: Dynegy Marketing and

Trade

Address: 1000 Louisiana Street, Suite Fax:(713) 767-8521

5800

Houston, TX

Date: February 7, 2002

Time: 10:31AM :Pages (including this one)

Customer history report

KPSC Case No. 2017-00472 Riverside's First Set of Data Requests Dated May 18, 2018 Item No. 3 Attachment 1 Page 84 of 89

E J Clayton 01/28/02 04:56 PM To: Jim.Current@dynegy.com

cc:

Subject: Foothills Project

Jim

Will you need a retail service agreement for the Foothills Project for the auxiliary power requirements?

E. J. Clayton (606) 327-1137

REPORT NO: MCSR0270 OFFICE CD: 01011 OFFICE : ASHLAND AMERICAN ELECTRIC POWER CUSTOMER HISTORY RECORD USAGE REP

AMERICAN ELECTRIC POWER

CUSTOMER HISTORY RECORD USAGE REPORT

DATE PREPARED: 02/07/02

TIME PREPARED: 10:37:26

PAGE: 1

ENGINEER NO 012


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01/31/02	0 2300.0		4299.0	3427.800	1054.220		3428.0		23.2	173	1145.0	
12/31/01	U 2300.0		3696.0	1882.220	1885.150		2218.0		44.6	332	1322.0	
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TOTAL :				7043.940	4708.320		7380.0	35.0	97.3	710	3553.0	
AVERAGE:				2347.980	1569.440		2460.0	11.6	32.4	237	1184.3	
READ	ME	TERED KWH	REACTIVE	E PF		BILLING	KWH	CENT	rs/		TAXES	
DATE	ONP	OFP	HOURS	CONST	ONP	OFP	TARIFF E	SILL KWI	Н	FR	SA	SC
01/31/02	593292		8118		593292		35961	30 6.00	6		2222.41 1	078.84
12/31/01	626512		8920		626512		28138.	88 4.49	9		1738.98	844.17
11/30/01	363477		4820		363477		20186.	37 5.59	5		1247.52	605.59
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REPORT NO:	MCSR0271	AMERICAN	ELECTR:	C POWER		
OFFICE CD:	01011	CUSTOMER HISTORY	RECORD	DOLLARS	REPORT	
OFFICE :	ASHLAND					

DATE PREPARED: 02/07/02 TIME PREPARED: 10:37:26 PAGE: 1

ENGINEER NO 012

CSERVE WANTE ST	RIVERSIDE GENE	RATING COMPANY	LLC ACCOUNT	NO 034 873 686	1 TARIFF 360		
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O 6412T105	1,353.00	6,852.52	27,012.64		207.65	535.49	
Ŭ 12/31/01	1,353.00	7,236.21	17,477.84	216.26	1,014.95	840.62	
12/30/01 × 12/30/01 TOTAL :	1,353.00	4,198.16	13,693.67	114.86	72.70	753.98	
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TOTAL :	4,059.00	18,286.89	58,184.15	331.12	1,295.30	2,130.09	
ATERAGE:	1,353.00	6,095.63	19,394.72	110.37	431.77	710.03	
READ		B&0		DISTRIBUTION	GENERATION	TRANSMISSION	CENTS/
DATE	TAXES	TAXES	TOTAL BILL	SERVICES	SERVICES	SERVICES	KWH
01/31/02	6,602.50		39,262.55				6.06
12/31/01	5,166.30		30,722.03				4.49
11/30/01	3,706.22		22,039.48				5.55
	=========	=======================================					======
TOTAL :	15,475.02		92,024.06				16.10
AVERAGE:	5,158.34		30,674.69				5.37



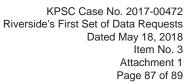

E J Clayton/CH1/AEPIN 03/22/2006 01:05 PM

To Errol K Wagner/AS1/AEPIN

cc

bcc

Subject fyi... Billing/Metering Data, Electric Account 034-873-686-1

fyi...Errol, I received the following questions from the Dynegy Company, owner of Riverside Generating LLC, an IPP located near the Big Sandy Power Plant. The first customer email defines some questions they had about the way their billing data was processed. By my response, they indicate I have satisfied their questions with regard to bill processing.

My last response in the note below, answers their question regarding application of the NUG tariff. I wanted to copy you on this note just in case I have misstated application of the NUG tariff to this customer. I believe I am correct in the application of NUG station power as utilizing the local utility demand meter tariff for the customer's service. Please notify me if I am incorrect in my assumption.

Thanks E. J. aud 600-1453 (606) 929-1453

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---- Forwarded by E J Clayton/CH1/AEPIN on 03/22/2006 12:57 PM ----



E J Clayton/CH1/AEPIN

03/22/2006 12:57 PM

To dan_roethemeyer@dynegy.com

CC

Subject Re: Billing/Metering Data, Electric Account 034-873-686-1

Dan,

Service is extended to the Riverside Site based on the Station Power provision defined with the NUG tariff. This provision specifies the customer is to contract for their maximum power needs to be supplied by the generally available utility demand metered tariff. For this location, with contract power requirements of approximately 4,000 kW, the QP KY Power Company Tariff would be applicable.

If you want to contract only for Startup Power at this site, there is a separate rate defined with Tariff NUG. We can discuss this in more detail if you are interested in changing the service at this site from Station Power service, to Startup Power service.

Don't hesitate to call should you have questions.

E. J. Clayton (606) 929-1453 (606) 929-1510 fax

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KPSC Case No. 2017-00472 Riverside's First Set of Data Requests Dated May 18, 2018 Item No. 3 Attachment 1 Page 88 of 89

dan_roethemeyer@dynegy.com



dan_roethemeyer@dynegy.c 03/22/2006 12:29 PM

To ejclayton@aep.com

CC

Subject Re: Billing/Metering Data, Electric Account 034-873-686-1

E.J.,

Thanks for the explanation. I agree with it and don't have a problem with it.

On another semi-related item, did you happen to look into whether the plant may qualify (or whether it even makes sense) for the Non-Utility Generator tariff?

Thanks!!

ejclayton@aep.com

To:

dan roethemeyer@dynegy.com

03/15/2006 03:27

PM Subject: Billing/Metering

Data, Electric Account 034-873-686-1

Per your recent inquiry I wanted to provide the following information in addition to our recent conversation regarding processing the metering data for the auxiliary power requirements at your Riverside and Foothills KY

You questioned why there are repetitive energy readings for various billing months on this electric account. As I stated in our discussion, the bill constant for both plants (Riverside and Foothills) is very large. One plant location has a billing constant of 277,128. This constant is derived as the product of the voltage and current instrument transformer ratio. As an example, for one plant, the delivery voltage is 345 kV with a VT ratio of 1732.05 and a CT ratio of 160. The product of these two numbers equates to a 277,128 bill constant used to determine the energy consumption for one plant. The other plant service also includes a large billing constant of 138,564 calculated similarly to the above example. Energy consumption for both sites (Riverside and Foothills) are combined each month to determine the total energy usage in kWH.

Normally energy consumption is several meter register units for both plant sites. As example, your most recent bill with meter readings recorded

KPSC Case No. 2017-00472 Riverside's First Set of Data Requests Dated May 18, 2018 Item No. 3 Attachment 1 Page 89 of 89

through February 28th, the meter for one plant site registered 2 units and the other plant site registered 3 units. Using the bill constants identified above for these two meter locations, results in the total energy consumption for the account.

Example - Bill issued March 2, 2006

 $2 \times 277,128 = 554,256 \text{ kWH}$ $3 \times 138,564 = 415,692 \text{ kWH}$ Total Energy Consumed = 969,948 kWH (554,256 + 415,692)

If you should have remaining questions or comments regarding your Companies electric account, please don't hesitate to contact me.

Sincerely,
E. J. Clayton
Engineer - Customer Services
(606) 929-1453
(606) 929-1510 fax

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KPSC Case No. 2017-00472 Riverside's First Set of Data Requests Dated May 18, 2018

DATA REQUEST

4

Please provide a copy of all records (specifically including, but not limited to, memoranda, e-mails, notes, and similar documents) prepared or reviewed by Kentucky Power following Riverside's initial and subsequent 2017 inquiries regarding the self-supply of power.

RESPONSE

Kentucky Power objects to this request to the extent it seeks documents or information protected by the attorney-client privilege or the attorney work product doctrine. Without waiving these objections, see KPCO_R_Riverside_1_4_Attachment1.pdf for non-privileged information identified as responsive to this request. See also the information provided in KPCO_R_Riverside_1_3_Attachment1.pdf.

Witness: Ranie K. Wohnhas

KPSC Case No. 2017-00472 Riverside's First Set of Data Requests, Dated May 18, 2018 Item No. 4 - Attachment 1 Page 1 of 29

From:

Kenneth L Borders

Sent:

Friday, February 03, 2017 5:02 PM

To: Cc: John A Rogness III; Terry L Hemsworth Delinda K Borden (dkborden@aep.com)

Subject:

Riverside Generation LLC - Possible switch to a net metering tariff

All:

I received a call from the gentleman below indicating he has been in discussions with PJM and it appears that Riverside is considering their options to try and lower their payments to Kentucky Power. It appears he may be interested in our Tariff N.U.G. or the Net Metering Service – Level 2.

I am asking who would be qualified in our organization to discuss options available to Riverside and work with me to make contact with Mr. Scienski. He would like us to contact him by next week.

I need to be kept in the loop with these discussions as much as possible.

The account # for Riverside Generating is 034-873-686-1.

Ken Borders – Customer Service Engineer

Kentucky Power Company 12333 Kevin Avenue Ashland, KY 41102 Telephone – (606) 929-1453 AEP AUDINET 600-1453 www.kentuckypower.com



A unit of American Electric Power

From: George Scienski [mailto:GScienski@LSPower.com]

Sent: Friday, February 03, 2017 4:43 PM

To: Kenneth L Borders

Subject: [EXTERNAL] GScienski Contact

This is an EXTERNAL email. STOP. THINK before you CLICK links or OPEN attachments.

George		

KPSC Case No. 2017-00472 Riverside's First Set of Data Requests, Dated May 18, 2018 Item No. 4 - Attachment 1 Page 2 of 29

George S. Scienski LS Power Development, LLC One Tower Center, 21st Floor East Brunswick, NJ 08816 office phone (NJ): 732-867-5860

office phone (SCES): 254-896-4218

cell phone: **732-354-7641**

fax: 732-249-7290 gscienski@lspower.com

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KPSC Case No. 2017-00472 Riverside's First Set of Data Requests, Dated May 18, 2018 Item No. 4 - Attachment 1 Page 3 of 29

From:

John A Rogness III

Sent:

Friday, February 03, 2017 5:13 PM

To:

Kenneth L Borders; Terry L Hemsworth

Cc:

Del Borden

Subject:

RE: Riverside Generation LLC - Possible switch to a net metering tariff

I would think that Terry would at least be in on it. He does the net metering. I'm not sure who would do the N.U.G.

From: Kenneth L Borders

Sent: Friday, February 03, 2017 5:02 PM **To:** John A Rogness III; Terry L Hemsworth

Cc: Del Borden

Subject: Riverside Generation LLC - Possible switch to a net metering tariff

AII:

I received a call from the gentleman below indicating he has been in discussions with PJM and it appears that Riverside is considering their options to try and lower their payments to Kentucky Power. It appears he may be interested in our Tariff N.U.G. or the Net Metering Service – Level 2.

I am asking who would be qualified in our organization to discuss options available to Riverside and work with me to make contact with Mr. Scienski. He would like us to contact him by next week.

I need to be kept in the loop with these discussions as much as possible.

The account # for Riverside Generating is 034-873-686-1.

<u>Ken Borders – Customer Service Engineer</u>

Kentucky Power Company 12333 Kevin Avenue Ashland, KY 41102 Telephone – (606) 929-1453 AEP AUDINET 600-1453 www.kentuckypower.com



A unit of American Electric Power

From: George Scienski [mailto:GScienski@LSPower.com]

Sent: Friday, February 03, 2017 4:43 PM

To: Kenneth L Borders

Subject: [EXTERNAL] GScienski Contact

This is an EXTERNAL email. STOP. THINK before you CLICK links or OPEN attachments.

George

George S. Scienski LS Power Development, LLC One Tower Center, 21st Floor East Brunswick, NJ 08816 office phone (NJ): 732-867-5860 office phone (SCES): 254-896-4218

cell phone: 732-354-7641

fax: 732-249-7290 gscienski@lspower.com

This message is intended only for the designated recipient(s). It may contain confidential, privileged or proprietary information. If you are not a designated or intended recipient, you may not review, copy, distribute, use, or take any action in reliance upon this message or any attachments. If you receive this message in error, please notify the sender by reply email and delete this message and any attachments.

This Contract, entered into this 2nd day of December, 2011 by and between Kentucky Power Company, hereafter called the Company, and Riverside Generating Company Lic, 25038 HIGHWAY 23, CATLETTSBURG, KY, 41129-8635, or his or its heirs, successors or assigns, hereafter called the Customer,

Witnesseth:

For and in consideration of the mutual covenants and agreements hereinafter contained, the parties hereto agree with each other as follows:

The Company agrees to furnish to the Customer, during the term of this Contract, and the Customer agrees to take from the Company, subject to Company's standard Terms and Conditions of Service as regularly filed with the Public Service Commission of Kentucky, all the electric energy of the character specified herein that shall be purchased by the Customer in the premises located at Rt. 2, Box 296, Catlettsburg, KY 41129.

The Company is to furnish and the Customer is to take electric energy under the terms of this Contract for an initial period of 12 month(s) from the time such service is commenced, and continuing thereafter until terminated upon 12 months' written notice given by either party of its intention to terminate the Contract. The date that service shall be deemed to have commenced under this Contract shall be 12/1/2011.

The electric energy delivered hereunder shall be alternating current at approximately volts, 3-wire, 3-phase, and it shall be delivered at termination point of two customer owned 345 kV circuits at the AEP Baker 345 kV Station, which shall constitute the point of delivery under this Contract. The said electric energy shall be delivered at reasonably close maintenance to constant potential and frequency, and it shall be measured by a meter or meters owned and installed by the Company and located at AEP Baker 345 kV Electrical Station(2 meters).

The Customer acknowledges that the Customer may be eligible to receive service under more than one of the Company's schedules and that such options have been explained to the Customer. The Customer and Company agree that the Customer has chosen to receive service under the provisions of the Company's Tariffs 360 QUANTITY POWER TRANSMISSION and 360 QUANTITY POWER TRANSMISSION, Codes 360. The Customer agrees to pay the Company monthly for electric energy delivered hereunder at the rates and under the provisions of the Company's Tariffs 360 QUANTITY POWER TRANSMISSION and 360 QUANTITY POWER TRANSMISSION, Codes 360, as regularly filed with the Public Service Commission of Kentucky, as long as those schedules are in effect. In the event that the Tariffs chosen by the Customer are replaced by new or revised Tariffs incorporating different rates or provisions, or both, the Company and Customer understand and agree that the Company will continue to provide service, and the Customer will continue to take service, under this Contract, subject to such changed provisions, and that the Customer will pay for such service at the new rates on and after the date such rates become effective.

The Customer's contract capacity under the Tariffs named herein is hereby fixed at 3,100 kW. If a time-of-day demand is available under the Tariffs and is selected by the Customer, the reservation of capacity aforementioned shall be the peak period reservation of capacity and shall determine the Tariffs minimum monthly billing demand. The amount of capacity requested during the off-peak period is 3,100 kW.

There are no unwritten understandings or agreements relating to the service hereinabove provided. This Contract cancels and supersedes all previous agreements, relating to the purchase by Customer and sale by Company of electric energy at Customer's premises as referred to above, on the date that service under this Contract commences. This Contract shall be in full force and effect when signed by the authorized representatives of the parties hereto.

An addendum for Consolidation is attached hereto and is part of this Contract.

Kentucky Power Company

Delinda Borden

Title: Manager, Customer Services

Date: 2-9-12

Riverside Generating Company Lic

Dariusz Rekowski

By:

Title: Plant Willinger

Date: 3Jan 2012

Account Number: 0348736861

KPSC Case No. 2017-00472 Riverside's First Set of Data Requests, Dated May 18, 2018 Item No. 4 - Attachment 1 Page 6 of 29

From:

Kenneth L Borders

Sent:

Thursday, March 09, 2017 10:27 AM

To:

Terry L Hemsworth; John A Rogness III

Subject:

FW: Station Power Netting

I received this from Riverside Generation. By the way the account number is 034-873-686-1.

Ken Borders – Customer Service Engineer

Kentucky Power Company 12333 Kevin Avenue Ashland, KY 41102 Telephone – (606) 929-1453 AEP AUDINET 600-1453 www.kentuckypower.com



A unit of American Electric Power

From: George Scienski [mailto:GScienski@LSPower.com]

Sent: Thursday, March 09, 2017 10:21 AM

To: Kenneth L Borders

Cc: sgreene@riversidegeneration.com

Subject: [EXTERNAL] FW: Station Power Netting

This is an EXTERNAL email. STOP. THINK before you CLICK links or OPEN attachments.

Ken:

Attached below per our discussion is the overview provided by PJM regarding station power netting and the contact information for the Riverside client representative.

Thanks for your help, and I look forward to a follow-up in the coming weeks.

George

George S. Scienski LS Power Development, LLC One Tower Center, 21st Floor East Brunswick, NJ 08816

office phone (NJ): 732-867-5860 office phone (SCES): 254-896-4218

cell phone: 732-354-7641

fax: 732-249-7290

gscienski@lspower.com

From: Burnley, Helen M. [mailto:Helen.Burnley@pjm.com]

Sent: Tuesday, January 24, 2017 2:59 PM

To: George Scienski

Subject: RE: Station Power Netting

Hi George:

Per my response back to you in case #34396":

The mechanics of PJM's Station Power settlements are documented in Manual 28, Section 13 as well as in the PJM Tariff, Attachment K - Appendix, Section 1.7.10. Station Power Settlements occur are on a one-month lag.

As part of PJM's station power settlements, PJM determines if a generator self-supplied its Station Power or obtained Station Power from third-party providers.

A generator may self-supply Station Power for its generation facility during any month (1) when the net output of such facility is positive, or (2) when the net output of such facility is negative and the generator during the same month has available at other of its generation facilities positive net output in an amount at least sufficient to offset fully negative net output.

PJM station power settlements is controlled by what is or is not submitted to PJM via the Power Meter tool.

If the generator has a wholesale station service arrangement, a negative MWh value should be reported in Power Meter when the unit is off-line and consuming energy.

If the generator has a superseding retail station service arrangement, a zero (0) MWh value should be reported in Power Meter when the unit is off-line and consuming energy. In this case, compensation for station power consumption is handled bilaterally between the EDCs and generation owners and PJM billing adjustments for station power are not applicable.

Regardless of which party actually controls the submission of values into Power Meter, it is both the EDC and Generation Owner's mutual responsibility to ensure values are submitted into Power Meter as accurately as possible by the established submission deadlines.

For example, the Generation Owner should not submit Station Power negatives into Power Meter during offline hours if they have a superseding retail agreement with the EDC or another third party.

Similarly, the EDC would want to make sure Station Power negatives are submitted into Power Meter if they have no retail Station Power agreement with the generator.

If a participant needs information on contacts at a given EDC regarding Station Power arrangements, you can give PJM permission to forward your contact information and inquiry to the given EDC's registered Power Meter users.

For the PJM weekly and monthly bills, PJM market settlements are based on generator values as reported to Power Meter. Positive Generation reported in Power Meter would result in a credit (MWh * LMP) on the PJM Bill. Negative Generation (i.e. consumption) reported in Power Meter would result in a charge (MWh * LMP) on the PJM Bill.

KPSC Case No. 2017-00472 Riverside's First Set of Data Requests, Dated May 18, 2018 Item No. 4 - Attachment 1

After the given month's bill is issued, PJM evaluates if a generator (or group of generators) has net negative generation for the month.

The generators that have a net negative amount of MWs for the month will then be classified into two categories.

If a group of generators had net positive total generation for the calendar month but had one or more individual generators each had a total negative generation for the month, the negative generators had Remote Self-Supply. Remote self-supply indicates station power at a particular generator was supplied from another generator in its portfolio.

Remote Self-Supply

For those generators which received Station Power through Remote Self-Supply, the PJM member needs to be charged non-firm point-to-point transmission service. This amount is based on the non-firm point-to-point transmission service rate multiplied by the negative MW amount.

If a generator or group of generators had net negative total generation for the month, those generators which had a negative net generation amount were served station power by retail supply/third party supply. Retail supply means the local EDC or other third party needed to serve the station power load of a generator and will therefore charge the generator owner the appropriate retail rates.

Retail Supply (Third-Party Supply)

In situations of Retail Supply, the generator is charged the wholesale rate for station service (the LMP for the generator bus) during the original wholesale market settlements. However, since those generators actually received Station Power through Retail Supply, the generator actually received the needed power from the local EDC or third party at the retail rate. This amount will be charged to the generator owner by the EDC, and the original wholesale LMP charge needs to be 'backed-out' - not charged to the generator. Thus the generator owner gets a credit, and the EDC will receive a charge, both of which are to balance the original wholesale charge which was made earlier in the settlements process.

Generators can group together to form a single station service netting portfolio. A portfolio is defined by generators which share the same lowest level corporate entity ownership. If a generator has defined itself as it is own LLC, it cannot net with other generators, even if they are "owned" in the PJM Market by a common member. For example, if unit A and unit B are "owned" in the PJM Energy Market settlements by Power Marketer X. If there is a Unit A LLC and a Unit B LLC, these two units cannot net relative to the Station Service netting evaluation. Conversely, if two units are "owned" in the PJM Energy Market settlements by two different PJM Members but their lowest level corporate parent is the same company, then they can net relative to the station service netting evaluation.

As long as the portfolio is net Generation to the Grid for the month, then there is no retail billing. However, if a Unit within the portfolio is net negative, then PJM charges 67 Cents per MWh of net negative for the transmission service to remote supply from unit A to unit B.

Additional details can be found in PJM Manual 28, Section 13 at (Home > Library > Manuals) http://www.pjm.com/library/manuals.aspx

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Remote Self-Supply

For those generators which received Station Power through Remote Self-Supply, the PJM member needs to be charged non-firm point-to-point transmission service. This amount is based on the non-firm point-to-point transmission service rate multiplied by the negative MW amount.

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Additional details can be found in PJM Manual 28, Section 13 at (Home > Library > Manuals) http://www.pjm.com/library/manuals.aspx

Best,

Helen Burnley Sr. Client Manager **Client Management and Services**

(610) 635-3468 | C: (610) 960-2128 | Helen.Burnley@pjm.com PJM Interconnection | 2750 Monroe Blvd. | Audubon, PA 19403



KPSC Case No. 2017-00472 Riverside's First Set of Data Requests, Dated May 18, 2018 Item No. 4 - Attachment 1 Page 11 of 29

From:

Kenneth L Borders

Sent:

Tuesday, June 27, 2017 4:49 PM

To:

John A Rogness III; Del Borden; Ranie K Wohnhas

Subject:

Fwd: [EXTERNAL] RE: Kentucky Power - Question about station netting - Riverside

Generation

Attachments:

170627-RGC-KPC Riverside-Station Power Netting under Tariff N.U.G..pdf;

ATT00001.htm

Our customer, Riverside Generation is going to challenge our position that they must pay for electricity at retail rates. They believe they qualify for remote self supply provisions. I will reply that we will review his proposal and contact him for more details. I am not in the office this week but plan to be back next week.

Sent from my iPhone

Begin forwarded message:

From: "George Scienski" < GScienski@LSPower.com>

To: "Kenneth L Borders" < klborders@aep.com>

Cc: "sgreene@riversidegeneration.com" <sgreene@riversidegeneration.com>

Subject: [EXTERNAL] RE: Kentucky Power - Question about station netting - Riverside

Generation

This is an EXTERNAL email. STOP. THINK before you CLICK links or OPEN attachments.

Ken:

Riverside has spent some time reviewing your email and researching the issue of station service netting. For the reasons detailed within the attached, we believe that we qualify for the remote self-supply provisions described in the tariff and summarized in your email.

Please review the attached (hardcopy sent via FedFy). We look forward to discussing and

Please review the attached (hardcopy sent via FedEx). We look forward to discussing and resolving the matter.

Thanks,

George

George S. Scienski
LS Power Development, LLC
One Tower Center, 21st Floor
East Brunswick, NJ 08816

office phone (NJ): 732-867-5860 office phone (SCES): 254-896-4218

cell phone: 732-354-7641

fax: 732-249-7290 gscienski@lspower.com

KPSC Case No. 2017-00472 Riverside's First Set of Data Requests, Dated May 18, 2018 Item No. 4 - Attachment 1 Page 12 of 29

----Original Message----

From: Ken Borders [mailto:klborders@aep.com]

Sent: Friday, March 17, 2017 3:28 PM

To: George Scienski

Subject: Kentucky Power - Question about station netting - Riverside Generation

Mr. Scienski,

A few weeks ago you inquired about the possibility of "netting" station power in order to obtain power at a wholesale rate for the Riverside facility in Lawrence County, Kentucky. Kentucky Power offers the response to your question below.

As an independent power producer within Kentucky Power Company's retail service territory, the Riverside generating facility is required to obtain station power at retail from Kentucky Power under the PSC-approved Tariff N.U.G. (Non-Utility Generator), as Riverside has done for many years. Tariff N.U.G., which is attached, does not permit an IPP to obtain station power at wholesale under the PJM Open Access Transmission Tariff unless the IPP can "provide Startup and Station Power from commonly owned generation facilities that are not located on the site of the customer's generator (remote self-supply)." Our understanding is that there are no other "commonly owned generation facilities" in the same corporate entity as the Riverside generating facility, and therefore Riverside is not eligible for remote self-supply and may not obtain station power at wholesale under the PJM tariff. Rather, Riverside must continue to obtain station power at retail from Kentucky Power under Tariff N.U.G.

Please note the Station Contract Capacity referred to in Tariff N.U.G. is supplied under the Industrial General Service tariff 360.

Tariff N.U.G. is attached along with Tariff I.G.S. (Industrial General Service). Should you have additional questions or need additional information please feel free to contact me.

Sincerely,

Ken Borders - Customer Service Engineer Kentucky Power Company 12333 Kevin Avenue Ashland, KY 41102 Phone (606) 929-1453 klborders@aep.com June 27, 2017

VIA EMAIL (klborders@aep.com)

Mr. Ken Borders Customer Service Engineer Kentucky Power Company 12333 Kevin Avenue Ashland, KY 41102

RE: Riverside Generation / Station Power Netting under Tariff N.U.G.

Dear Mr. Borders:

Reference is made to your email of March 17, 2017, in which you provided initial guidance regarding the terms of Kentucky Power Company's Tariff N.U.G. and its applicability to the electric service received by Riverside Generating Company, LLC ("Riverside"), at its facilities located in Lawrence County, Kentucky. I appreciate your invitation to further discuss this matter and hope I can provide additional clarity with respect to the relevant facts.

Riverside's power production facilities in Kentucky include a total of five (5) generating units located at two (2) proximate, though distinct, generation sites. Riverside's Units 1-3, which are identified and classified by PJM Interconnection, LLC ("PJM"), as comprising the "Zelda" site, are located on real estate originally acquired in the year 2000 and were placed into operation in the year 2001. Riverside's Units 4 and 5, which are identified and classified by PJM as comprising the "Foothills" site, are located on real estate originally acquired in the year 2001 and were placed into operation in the year 2002. Riverside wholly owns both sites and each of the units found upon them.

As you are aware, Riverside is presently exploring the options available to it for satisfying its station power needs at both the Zelda and Foothills sites. Because both sites are interconnected with the wholesale transmission grid and consistently produce significantly more energy than consumed for their operation, Riverside is examining with particularity its ability to "net" its station power in accordance with the terms of PJM's Open Access Transmission Tariff. At this time, and in light of the relevant facts elucidated herein, Riverside continues to believe this avenue represents the most sensible solution to the situation under scrutiny.

In your email of March 17th, you indicated that a "netting" arrangement like that summarized above would not be available to Riverside under the terms of Kentucky Power's existing retail Tariff N.U.G. which states, in relevant part, that "[c]ustomers desiring to provide Startup and Station Power from commonly owned generation facilities that are not located on the

¹ For your reference, a copy of this email is included herewith.

site of the customer's generator (remote self-supply) shall take service under the terms and conditions contained within the applicable Open Access Transmission Tariff as filed with and accepted by the Federal Energy Regulatory Commission." In reaching your initial conclusion, you expressed your understanding that Riverside has just one (1) generating site in its portfolio, and thus "is not eligible for remote self-supply...." The relevant facts clearly show, however, that Riverside's Zelda and Foothills generators are located on separate and distinct "sites" for purposes of complying with the Tariff N.U.G. and the PJM Open Access Transmission Tariff.

As mentioned above, the Zelda site and the Foothills site sit upon unique parcels of real estate that were acquired at different times. While the two (2) sites share a common property line, that same border is marked by fencing and other barriers that provide apparent and actual partitioning. Each site is individually identified by PJM for various purposes and is uniquely reported to PJM. Each site is uniquely metered, has its own infrastructure and connections to the nearby Baker Switchyard. There is no cross feed/tie-breaker between the sites, no parasitic load, and no need for the respective units to operate in unison. Indeed, for nearly every relevant intent and purpose, the Zelda site and the Foothills site may as well be located ten, twenty, or even hundreds of miles from each other. Based on these facts, it is both logical and reasonable to conclude that Riverside's Units 1-3 are not located on the same "site" as Riverside's Units 4-5. Instead, these distinct sites house "commonly owned generation facilities" capable of remotely supplying station power to Riverside when necessary. Therefore, consistent with the Special Terms and Conditions of Kentucky Power's Tariff N.U.G., Riverside appears eligible to take its station power service under PJM's Open Access Transmission Tariff.

It is my hope that the additional detail provided in this correspondence will permit you to reconsider the earlier conclusion reflected in your March 17th email. Because Riverside remains committed to working with Kentucky Power to realize a fair and appropriate resolution of these issues, I would be happy to answer any questions or further confer at your convenience. In any event, I ask that you please confirm Kentucky Power's agreement with the discussion/conclusion contained herein on or before July 7, 2017.

Again, I appreciate your willingness to discuss this matter and look forward to your response.

Sincerely,

George Scienski

Attachment

KPSC Case No. 2017-00472 Riverside's First Set of Data Requests, Dated May 18, 2018 Item No. 4 - Attachment 1 Page 15 of 29

From: Ken Borders
To: George Scienski

Subject: Kentucky Power - Question about station netting - Riverside Generation

Date: Friday, March 17, 2017 3:27:47 PM
Attachments: 2017 JAN 31 KPCO NUG TARIFF.pdf

2015 SEP 29 INDUSTRIAL GENERAL SERVICE pdf

Mr. Scienski,

A few weeks ago you inquired about the possibility of "netting" station power in order to obtain power at a wholesale rate for the Riverside facility in Lawrence County, Kentucky. Kentucky Power offers the response to your question below.

As an independent power producer within Kentucky Power Company's retail service territory, the Riverside generating facility is required to obtain station power at retail from Kentucky Power under the PSC-approved Tariff N.U.G. (Non-Utility Generator), as Riverside has done for many years. Tariff N.U.G., which is attached, does not permit an IPP to obtain station power at wholesale under the PJM Open Access Transmission Tariff unless the IPP can "provide Startup and Station Power from commonly owned generation facilities that are not located on the site of the customer's generator (remote self-supply)." Our understanding is that there are no other "commonly owned generation facilities" in the same corporate entity as the Riverside generating facility, and therefore Riverside is not eligible for remote self-supply and may not obtain station power at wholesale under the PJM tariff. Rather, Riverside must continue to obtain station power at retail from Kentucky Power under Tariff N.U.G.

Please note the Station Contract Capacity referred to in Tariff N.U.G. is supplied under the Industrial General Service tariff 360.

Tariff N.U.G. is attached along with Tariff I.G.S. (Industrial General Service). Should you have additional questions or need additional information please feel free to contact me.

Sincerely,

Ken Borders - Customer Service Engineer Kentucky Power Company 12333 Kevin Avenue Ashland, KY 41102 Phone (606) 929-1453 klborders@aep.com

Item No. 4 - Attachment 1
P.S.C. KY. NO. 10 ORIGINAL SHEET NO. 2829e 16 of 29
CANCELLING P.S.C. KY. NO. 10
SHEET NO. 26-1

TARIFF N.U.G. (Non-Utility Generator)

AVAILABILITY OF SERVICE.

This tariff is applicable to customers with generation facilities which have a total design capacity of over 1,000 kW that intends to schedule, deliver and sell the net electric output of the facility at wholesale, and who require Commissioning Power, Startup Power and/or Station Power service from the Company.

Service to any load that is electrically isolated from the Customer's generator shall be separately metered and provided in accordance with the generally available demand-metered tariff appropriate for such service to the Customer.

This tariff is not available for standby, backup, maintenance, or supplemental service for wholesale or retail loads served by customer's generator.

DEFINITIONS.

- Commissioning Power The electrical energy and capacity supplied to the customer prior to the commercial operation
 of the customer's generator, including initial construction and testing phases.
- Station Power The electrical energy and capacity supplied to the customer to serve the auxiliary loads at the
 customer's generation facilities, usually when the customer's generator is not operating. Station Power does not include
 Startup Power.
- Startup Power The electrical energy and capacity supplied to the customer following a planned or forced outage of the
 customer's generator for the purpose of returning the customer's generator to synchronous operation.

COMMISSIONING POWER SERVICE.

Customers requiring Commissioning Power shall take service under Tariff T.S. or by special agreement with the Company,

The Customer shall coordinate its construction and testing with the Company to ensure that the customer's operations do not cause any undue interference with the Company's obligations to provide service to its other customers or impose a burden on the Company's system or any system interconnected with the Company.

STATION POWER SERVICE.

Customers requiring Station Power shall take service under the generally available demand-metered tariff appropriate for the customer's Station Power requirements.

Station Contract Capacity – The Customer shall contract for a definite amount of electrical capacity in kW sufficient to meet the maximum Station Power requirements that the Company is expected to supply under the generally available demand-metered tariff appropriate for the customer.

STARTUP POWER SERVICE.

Customers requiring Startup Power have the option of contracting for such service under the terms of this tariff or under the generally available demand-metered tariff appropriate for the customer's Startup Power requirements.

Startup Contract Capacity – The Customer shall contract for a definite amount of electrical capacity in kW sufficient to meet the maximum Startup Power requirements that the Company is expected to supply.

Startup Duration – The Customer shall contract for a definite number of hours sufficient to meet the maximum period of time for which the Company is expected to supply Startup Power.

(Cont'd on Sheet No. 26-2)

DATE OF ISSUE: July 10, 2015

DATE EFFECTIVE: Service Rendered On And After June 30, 2015

ISSUED BY: JOHN A. ROGNESS III

TITLE: Director Regulatory Services

By Authority Of An Order By The Public Service Commission

In Case No. 2014-00396 Dated June 22, 2015

KENTUCKY

PUBLIC SERVICE COMMISSION

JEFF R. DEROUEN EXECUTIVE DIRECTOR

TARIFF BRANCH

EFFECTIVE

6/30/2015

PURSUANT TO 807 KAR 5:011 SECTION 9 (1)

P.S.C. KY. NO. 10 ORIGINAL SHEET 9NU. 26-2
CANCELLING P.S.C. KY. NO. 10 SHEET NO. 26-2

TARIFF N.U.G. (Cont'd) (Non-Utility Generator)

STARTUP POWER SERVICE. (cont'd)

Startup Duration – The Customer shall contract for a definite number of hours sufficient to meet the maximum period of time for which the Company is expected to supply Startup Power.

Startup Frequency – The Customer shall contract for a definite number of startup events sufficient to meet the maximum number of times per year that the Company is expected to supply Startup Power.

Other Startup Characteristics – The customer shall provide to the Company other information regarding the customer's Startup Power requirements, including, but not limited to, anticipated time-of-use and seasonal characteristics.

Notification Requirement - Whenever Startup Power is needed, the Customer shall provide advance notice to the Company.

Upon receipt of a request from the Customer for Startup Power Service under the terms of this tariff, the Company will provide the Customer a written offer containing the Notification Requirement, generation, transmission and distribution rates (including demand and energy charges) and related terms and conditions of service under which service will be provided by the Company. Such offer shall be based upon the Startup Contract Capacity, Startup Duration, Startup Frequency, and Other Startup Characteristics as specified by the customer. In no event shall the rates be less than the sum of the Tariff I.G.S. Energy Charge, the Fuel Adjustment Clause, the System Sales Clause, the Demand-Side Management Adjustment Clause, Asset Transfer Rider, Big Sandy Retirement Rider, Big Sandy 1 Operation Rider, Purchase Power Rider, KY Economic Development Surcharge, Environmental Surcharge, and the Capacity Charge.

If the parties reach an agreement based upon the offer provided to the customer by the Company, a contract shall be executed that provides full disclosure of all rates, terms and conditions of service under this tariff, and any and all agreements related thereto.

DELAYED PAYMENT CHARGE.

This tariff is due and payable in full on or before the due date stated on the bill. On all accounts not so paid, an additional charge of 5% of the unpaid balance will be made.

DATE OF ISSUE: July 10, 2015

DATE EFFECTIVE: Service Rendered On And After June 30, 2015

ISSUED BY: JOHN A. ROGNESS III

TITLE: Director Regulatory Services

By Authority Of an Order of the Public Service Commission

In Case No. 2014-00396 Dated June 22, 2015

KENTUCKY
PUBLIC SERVICE COMMISSION

JEFF R. DEROUEN EXECUTIVE DIRECTOR

TARIFF BRANCH

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6/30/2015

PURSUANT TO 807 KAR 5:011 SECTION 9 (1)

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KPSC Case No. 2017-00472 Riverside's First Set of Data Requests, Dated May 18, 2018

KENTUCKY POWER COMPANY

Item No. 4 - Attachment 1
P.S.C. KY. NO. 10 ORIGINAL SHEET NO. 26-29
CANCELLING P.S.C. KY. NO. 10
SHEET NO. 26-3

TARIFF N.U.G. (Cont'd) (Non-Utility Generator)

MONTHLY BILLING DEMAND.

The monthly billing demand in kW shall be taken each month as the highest single 15-minute integrated peak in kW as registered by a demand meter or indicator, less the Station Contract Capacity. The monthly billing demand so established shall in no event be less than the greater of (a) the Startup Contract Capacity or b) the customer's highest previously established monthly billing demand during the past 11 months.

MONTHLY BILLING ENERGY.

Interval billing energy shall be measured each 15-minute interval of the month as the total KWH registered by an energy meter or meters less the quotient of the Station Contract Capacity and four (4). In no event shall the interval billing energy be less than zero (0). Monthly billing energy shall be the sum of the interval billing energy for all intervals of the billing month.

TRANSMISSION SERVICE.

Transmission Provider – The entity providing transmission service to customers in the Company's service territory. Such entity may be the Company or a regional transmission entity.

Prior to taking service under this tariff, the Customer must have a fully executed Interconnection and Operation Agreement with the Company and/or the Transmission Provider or an unexecuted agreement filed with the Federal Energy Regulatory Commission under applicable procedures.

Should the Transmission Provider implement charges for Transmission Congestion, the Company shall provide 30 days written notice to the customer. Upon the expiration of such notice period, should the customer's use of Startup Power result in any charges for Transmission Congestion from the Transmission Provider, such charges, including any applicable taxes or assessments, shall be paid by or passed through to the customer without markup. Transmission Congestion is the condition that exists when market participants seek to dispatch in a pattern that would result in power flows that cannot be physically accommodated by the system.

TERM OF CONTRACT.

Contracts under this tariff will be made for an initial period of not less than one year and shall remain in effect thereafter until either party shall give at least 6 months' written notice to the other of the intention to terminate the contract. The Company reserves the right to require initial contracts for periods greater than one year.

A new initial contract period will not be required for existing customers who change their contract requirements after the original initial period unless new or additional facilities are required.

The Company may not be required to supply capacity in excess of that contracted for except by mutual agreement. Contracts will be made in multiples of 100 kW.

SPECIAL TERMS AND CONDITIONS.

This tariff is subject to the Company's Terms and Conditions of Service.

This tariff shall not obligate the Company to purchase or pay for any capacity or energy produced by the Customer's generator.

Customers desiring to provide Startup and Station Power from commonly owned generation facilities that are not located on the site of the customer's generator (remote self-supply), shall take service under the terms and conditions contained within the applicable Open Access Transmission Tariff as filed with and accepted by the Federal Energy Regulatory Commission.

DATE OF ISSUE: July 10, 2015

DATE EFFECTIVE: Service Rendered On And After June 30, 2015

ISSUED BY: JOHN A. ROGNESS (III

TITLE: Director Regulatory Services

By Authority Of Order By The Public Service Commission

In Case No. 2014-00396 Dated June 22, 2015

KENTUCKYPUBLIC SERVICE COMMISSION

JEFF R. DEROUEN EXECUTIVE DIRECTOR

TARIFF BRANCH

EFFECTIVE

6/30/2015

PURSUANT TO 807 KAR 5:011 SECTION 9 (1)

P.S.C. KY. NO. 10 1ST REVISED SHEET NO. 10-1 CANCELLING P.S.C. KY. NO. 10 ORIGINAL SHEET NO. 10-1

TARIFF I.G.S. (Industrial General Service)

AVAILABILITY OF SERVICE.

Available for commercial and industrial customers with contract demands of at least 1,000 KW. Customers shall contract for a definite amount of electrical capacity in kilowatts, which shall be sufficient to meet normal maximum requirements.

RATE.

	Secondary	Primary	Service Voltage Subtransmission	Transmission
Tariff Code	356	358/370	359/371	360/372
Scrvice Charge per month Demand Charge per KW Of monthly on-peak billing	\$ 276.00	\$ 276.00	\$ 794.00	\$ 1,353.00
demand Of monthly off-peak	\$ 18.23	\$ 15.21	\$ 10.02	\$ 9.75
billing demand Energy Charge per KWH	\$ 1.10 3.242 ¢	\$ 1.07 3.126 ¢	\$ 1.05 3.090 ¢	\$ 1.04 3.052 ¢

RRRR

Reactive Demand Charge for each kilovar of maximum leading or lagging reactive demand in excess of

For the purpose of this tariff, the on-peak billing period is defined as 7:00 AM to 9:00 PM for all weekdays, Monday through Friday. The off-peak billing period is defined as 9:00 PM to 7:00 AM for all weekdays and all hours of Saturday and Sunday.

MINIMUM DEMAND CHARGE.

The minimum demand charge shall be equal to the minimum billing demand times the following minimum demand rates;

Secondary	Primary	Subtransmission	1 Transmission	
\$19.59/KW	\$16.53 /KW	\$11.32/KW	\$11.03/KW	

The minimum billing demand shall be the greater of 60% of the contract capacity set forth on the contract for electric service or 60% of the highest billing demand, on-peak or off-peak, recorded during the previous eleven months.

MINIMUM CHARGE.

This tariff is subject to a minimum charge equal to the Service Charge plus the Minimum Demand Charge.

FUEL ADJUSTMENT CLAUSE.

Bills computed according to the rates set forth herein will be increased or decreased by a Fuel Adjustment Factor per KWH calculated in compliance with the Fuel Adjustment Clause contained in Sheet Nos. 5-1 and 5-2 of this Tariff Schedule.

SYSTEM SALES CLAUSE.

Bills computed according to the rates set forth herein will be increased or decreased by a System Sales Factor per KWH calculated in compliance with the System Sales Clause contained in Sheet Nos. 19-1 and 19-2 of this Tariff Schedule,

(Cont'd on Sheet No. 10-2)

DATE OF ISSUE: August 27, 2015

DATE EFFECTIVE: Bills Rendered On And After September 29, 2015

ISSUED BY: JOHN A. ROGNESS III

TITLE: Director Regulatory Services

By authority of an Order by the Public Service Commission

In Case No. 2014-00450 Dated August 11, 2015

KENTUCKY PUBLIC SERVICE COMMISSION

JEFF R. DEROUEN

EXECUTIVE DIRECTOR

PURSUANT TO 807 KAR 5:011 SECTION 9 (1)

P.S.C. KY. NO. 10 ORIGINAL SHEET NO. 10-2 CANCELLING P.S.C. KY. NO. 10 SHEET NO. 10-2

TARIFF I.G.S. (Industrial General Service)

DEMAND-SIDE MANAGEMENT ADJUSTMENT CLAUSE.

Bills computed according to the rates set forth herein will be increased or decreased by a Demand-Side Management Adjustment Clause Factor per KWH calculated in compliance with the Demand-Side Management Adjustment Clause contained in Sheet Nos. 22-1 through 22-15 of this Tariff Schedule, unless the customer is an industrial who has elected to opt-out in accordance with the terms pursuant to the Commission's Order in Case No. 95-427.

ASSET TRANSFER RIDER.

Bills computed according to the rates set forth herein will be increased or decreased by an Asset Transfer Adjustment Factor based on a percent of revenue in compliance with the Asset Transfer Rider contained in Sheet No. 36-1 through 36-2 of this Tariff Schedule. The Asset Transfer Adjustment Factor will be applied to bills until such time as the pro rata amount (computed on a 365-day annual basis) authorized to be recovered via Tariff A.T.R. in the Stipulation and Settlement Agreement, approved as modified by the Commission by its order dated October 7, 2013 in Case No. 2012-00578, has been recovered.

BIG SANDY RETIREMENT RIDER.

Bills computed according to the rates set forth herein will be increased or decreased by a Big Sandy Retirement Rider Adjustment Factor based on a percent of revenue in compliance with the Big Sandy Retirement Rider contained in Sheet No. 38-1 through 38-2 of this Tariff Schedule.

BIG SANDY I OPERATION RIDER.

Bills computed according to the rates set forth herein will be increased or decreased by a Big Sandy 1 Operation Rider Adjustment Factor per kW and/or kWh calculated in compliance with the Big Sandy 1 Operation Rider contained in Sheet Nos. 39-1 through 39-2 of this Tariff Schedule.

PURCHASE POWER ADJUSTMENT.

Bills computed according to the rates set forth herein will be increased or decreased by a Purchase Power Adjustment Factor based on a percent of revenue in compliance with the Purchase Power Adjustment contained in Sheet No. 35-1 of this Tariff Schedule.

ENVIRONMENTAL SURCHARGE.

Bills computed according to the rates set forth herein will be increased or decreased by an Environmental Surcharge adjustment based on a percent of revenue in compliance with the Environmental Surcharge contained in Sheet Nos. 29-1through 29-7 of the Tariff Schedule.

CAPACITY CHARGE.

Bills computed according to the rates set forth herein will be increased by a Capacity Charge Factor per KWH calculated in compliance with the Capacity Charge Tariff contained in Sheet No. 28-1 through 28-2 of this Tariff Schedule.

(Cont'd on Sheet No. 10-3)

DATE OF ISSUE: July 10, 2015

DATE EFFECTIVE: Service Rendered On And After June 30, 2015

ISSUED BY: JOHN A. ROGNESS III

TITLE: Director Regulatory Services

By Authority Of An Order By The Public Service Commission

In Case No. 2014-00396 Dated June 22, 2015

KENTUCKY

PUBLIC SERVICE COMMISSION

JEFF R. DEROUEN EXECUTIVE DIRECTOR

TARIFF BRANCH

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PURSUANT TO 807 KAR 5:011 SECTION 9 (1)

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P.S.C. KY. NO. 10 ORIGINAL SHEET NO. 10-3 CANCELLING P.S.C. KY. NO. 10 ______ SHEET NO. 10-3

TARIFF I.G.S. (Industrial General Service)

KENTUCKY ECONOMIC DEVELOPMENT SURCHARGE.

Applicable to all customers. Bills computed according to the rates set forth herein shall be increased by a KEDS charge of \$0.15 per month and shall be shown on the customers' bills as a separate line item. The KEDS charge will be applied to all customer electric bills rendered during the billing cycles commencing July 2015 and continue until otherwise directed by the Public Service Commission.

DELAYED PAYMENT CHARGE.

Bills under this tariff are due and payable within fifteen (15) days of the mailing date. On all accounts not paid in full by the next billing date, an additional charge of 5% of the unpaid portion will be made.

METERED VOLTAGE.

The rates set forth in this tariff are based upon the delivery and measurement of energy at the same voltage, thus measurement will be made at or compensated to the delivery voltage. At the sole discretion of the Company, such compensation may be achieved through the use of loss compensating equipment, the use of formulas to calculate losses or the application of multipliers to the metered quantities. In such cases, the metered KWII and KVA values will be adjusted for billing purposes. If the Company elects to adjust KWH and KW based on multipliers, the adjustment shall be in accordance with the following:

- (1) Measurements taken at the low-side of a Customer-owned transformer will be multiplied by 1.01.
- (2) Measurements taken at the high-side of a Company-owned transformer will be multiplied by 0.98.

MONTHLY BILLING DEMAND.

The monthly on-peak and off-peak billing demands in KW shall be taken each month as the highest single 15-minute integrated peak in KW as registered by a demand meter during the on-peak and off-peak billing periods, respectively.

The reactive demand in KVARs shall be taken each month as the highest single 15-minute integrated peak in KVARs as registered during the month by a demand meter or indicator.

(Cont'd on Sheet No. 10-4)

DATE OF ISSUE: July 10, 2015

DATE EFFECTIVE: Service Rendered On And After June 30, 2015

ISSUED BY: JOHN A. ROGNESS III

TITLE: Director Regulatory Services

By Authority Of An Order By The Public Service Commission

In Case No. 2014-00396 Dated June 22, 2015

KENTUCKY
PUBLIC SERVICE COMMISSION

JEFF R. DEROUEN EXECUTIVE DIRECTOR

TARIFF BRANCH

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6/30/2015

PURSUANT TO 807 KAR 5:011 SECTION 9 (1)

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P.S.C. KY. NO. 10 ORIGINAL SHEET NO. 10-4 CANCELLING P.S.C. KY. NO. 10 SHEET NO. 10-4

TARIFF I.G.S. (Industrial General Service)

TERM OF CONTRACT.

Contracts under this tariff will be made for an initial period of not less than two years and shall remain in effect thereafter until cither party shall give at least 12 months' written notice to the other of the intention to terminate the contract. The Company reserves the right to require initial contracts for periods greater than two years.

A new initial contract period will not be required for existing customers who change their contract requirements after the original initial period unless new or additional facilities are required.

CONTRACT CAPACITY

The Customer shall set forth the amount of capacity contracted for ("the contract capacity") in an amount equal to or greater than 1,000 KW in multiplies of 100 KW. The Company is not required to supply capacity in excess of such contract capacity except with express written consent of the Company.

SPECIAL TERMS AND CONDITIONS.

This tariff is subject to the Company's Terms and Conditions of Service.

This tariff is available for resale service to mining and industrial Customers who furnish service to Customer-owned camps or villages where living quarters are rented to employees and where the Customer purchases power at a single point for both the power and camp requirements.

This tariff is also available to Customers having other sources of energy supply, but who desire to purchase standby or back-up electric service from the Company. Where such conditions exist the Customer shall contract for the maximum amount of demand in KW which the Company might be required to furnish, but not less than 1,000 KW. The Company shall not be obligated to supply demands in excess of that contracted capacity. Where service is supplied under the provisions of this paragraph, the billing demand each month shall be the highest determined for the current and previous two billing periods, and the minimum charge shall be as set forth under paragraph "Minimum Charge" above.

A Customer's plant is considered as one or more buildings, which are served by a single electrical distribution system provided and operated by the Customer. When the size of the Customer's load necessitates the delivery of energy to the Customer's plant over more than one circuit, the Company may elect to connect its circuits to different points on the Customer's system irrespective of contrary provisions in Terms and Conditions of Service.

Customer with PURPA Section 210 qualifying cogeneration and/or small power production facilities shall take service under Tariff COGEN/SPP II or by special agreement with the Company.

DATE OF ISSUE: July 10, 2015

DATE EFFECTIVE: Service Rendered On And After June 30, 2015

ISSUED BY: JOHN A. ROGNESS III

TITLE: Director Regulatory Services

By Authority Of An Order By The Public Service Commission

In Case No. 2014-00396 Dated June 22, 2015

KENTUCKY

PUBLIC SERVICE COMMISSION

JEFF R. DEROUEN EXECUTIVE DIRECTOR

TARIFF BRANCH

EFFECTIVE

6/30/2015

PURSUANT TO 807 KAR 5:011 SECTION 9 (1)

From: George Scienski [mailto: GScienski@LSPower.com]

Sent: Tuesday, June 27, 2017 3:43 PM

To: Kenneth L Borders

Cc: <u>sgreene@riversidegeneration.com</u>

Subject: [EXTERNAL] RE: Kentucky Power - Question about station netting

- Riverside Generation

This is an EXTERNAL email. STOP. THINK before you CLICK links or OPEN attachments.

Ken:

Riverside has spent some time reviewing your email and researching the issue of station service netting. For the reasons detailed within the attached, we believe that we qualify for the remote self-supply provisions described in the tariff and summarized in your email. Please review the attached (hardcopy sent via FedEx). We look forward to discussing and resolving the matter.

Thanks,

George

George S. Scienski LS Power Development, LLC One Tower Center, 21st Floor East Brunswick, NJ 08816 office phone (NJ): 732-867-5860

office phone (SCES): 254-896-4218

cell phone: 732-354-7641

fax: 732-249-7290 gscienski@lspower.com

-----Original Message-----

From: Ken Borders [mailto:klborders@aep.com]

Sent: Friday, March 17, 2017 3:28 PM

To: George Scienski

Subject: Kentucky Power - Question about station netting - Riverside

Generation

Mr. Scienski,

A few weeks ago you inquired about the possibility of "netting" station power in order to obtain power at a wholesale rate for the Riverside facility in Lawrence County, Kentucky. Kentucky Power offers the response to your question below.

As an independent power producer within Kentucky Power Company's retail service territory, the Riverside generating facility is required to obtain station power at retail from Kentucky Power under the PSC-approved Tariff N.U.G. (Non-Utility Generator), as Riverside has done for many years. Tariff N.U.G., which is attached, does not permit an IPP to obtain station power at wholesale under the PJM Open Access Transmission Tariff unless the IPP can "provide Startup and Station Power from commonly owned generation facilities that are not located on the site of the customer's generator (remote self-supply)." Our understanding is that there are no other "commonly owned generation facilities" in the same corporate entity

KPSC Case No. 2017-00472 Riverside's First Set of Data Requests, Dated May 18, 2018 Item No. 4 - Attachment 1 Page 24 of 29

as the Riverside generating facility, and therefore Riverside is not eligible for remote self-supply and may not obtain station power at wholesale under the PJM tariff. Rather, Riverside must continue to obtain station power at retail from Kentucky Power under Tariff N.U.G.

Please note the Station Contract Capacity referred to in Tariff N.U.G. is supplied under the Industrial General Service tariff 360.

Tariff N.U.G. is attached along with Tariff I.G.S. (Industrial General Service). Should you have additional questions or need additional information please feel free to contact me.

Sincerely,

Ken Borders - Customer Service Engineer Kentucky Power Company 12333 Kevin Avenue Ashland, KY 41102 Phone (606) 929-1453 klborders@aep.com

KPSC Case No. 2017-00472 Riverside's First Set of Data Requests, Dated May 18, 2018 Item No. 4 - Attachment 1 Page 25 of 29

To: George Scienski Re: [EXTERNAL] RE: Kentucky Power - Question about station netting - Riverside Subject: Generation Thanks for your feedback, George. I have forwarded your email to others within our company and we will review. I am not in the office this week, but we will make plans to contact you in the near future. Sent from my iPhone > On Jun 27, 2017, at 2:46 PM, George Scienski <GScienski@LSPower.com> wrote: > This is an EXTERNAL email. STOP. THINK before you CLICK links or OPEN attachments. > Ken: > Riverside has spent some time reviewing your email and researching the issue of station service netting. For the reasons detailed within the attached, we believe that we qualify for the remote self-supply provisions described in the tariff and summarized in your email. > Please review the attached (hardcopy sent via FedEx). We look forward to discussing and resolving the matter. > Thanks, > George > George S. Scienski > LS Power Development, LLC > One Tower Center, 21st Floor > East Brunswick, NJ 08816 > office phone (NJ): 732-867-5860 > office phone (SCES): 254-896-4218 > cell phone: 732-354-7641 > fax: 732-249-7290 > gscienski@lspower.com > > -----Original Message-----> From: Ken Borders [mailto:klborders@aep.com] > Sent: Friday, March 17, 2017 3:28 PM > To: George Scienski > Subject: Kentucky Power - Question about station netting - Riverside > Generation > Mr. Scienski,

Kenneth L Borders

Tuesday, June 27, 2017 4:51 PM

From:

Sent:

KPSC Case No. 2017-00472 Riverside's First Set of Data Requests, Dated May 18, 2018 Item No. 4 - Attachment 1

> A few weeks ago you inquired about the possibility of "netting" station power in order to obtain power at the Riverside facility in Lawrence County, Kentucky. Kentucky Power offers the response to your question below.

> As an independent power producer within Kentucky Power Company's retail service territory, the Riverside generating facility is required to obtain station power at retail from Kentucky Power under the PSC-approved Tariff N.U.G. (Non-Utility Generator), as Riverside has done for many years. Tariff N.U.G., which is attached, does not permit an IPP to obtain station power at wholesale under the PJM Open Access Transmission Tariff unless the IPP can "provide Startup and Station Power from commonly owned generation facilities that are not located on the site of the customer's generator (remote self-supply)." Our understanding is that there are no other "commonly owned generation facilities" in the same corporate entity as the Riverside generating facility, and therefore Riverside is not eligible for remote self-supply and may not obtain station power at wholesale under the PJM tariff. Rather, Riverside must continue to obtain station power at retail from Kentucky Power under Tariff N.U.G.

> Please note the Station Contract Capacity referred to in Tariff N.U.G. is supplied under the Industrial General Service tariff 360.

> Tariff N.U.G. is attached along with Tariff I.G.S. (Industrial General Service). Should you have additional questions or need additional information please feel free to contact me.

> Sincerely,

> Silicele

>

- > Ken Borders Customer Service Engineer Kentucky Power Company
- > 12333 Kevin Avenue
- > Ashland, KY 41102
- > Phone (606) 929-1453
- > klborders@aep.com
- > <170627-RGC-KPC Riverside-Station Power Netting under Tariff
- > N.U.G..pdf>

KPSC Case No. 2017-00472 Riverside's First Set of Data Requests, Dated May 18, 2018 Item No. 4 - Attachment 1 Page 27 of 29

From: David Samford [mailto:david@gosssamfordlaw.com]

Sent: Monday, August 07, 2017 5:03 PM

To: Gish, Jr., Kenneth J. Cc: Overstreet, Mark R. Subject: Re: Riverside

Mark or Ken,

Can you please advise when Riverside will be receiving the response to its June 27th letter? Nothing has been received to date and it has been nearly six weeks since the letter was sent and ten days since we were advised that a response would be forthcoming shortly. Thank you.

Have a good day,

David Samford

Sent from my iPhone

On Jul 28, 2017, at 1:21 PM, Gish, Jr., Kenneth J. < kgish@stites.com > wrote:

David,

Mark, who is traveling, asked me to forward along to you that Kentucky Power will not be removing its request to change the Special Terms and Conditions section of Tariff N.U.G. in Case 2017-00179. Kentucky Power is currently working on a response to Riverside's June 27, 2017 letter.

Please let me know if you have any questions.

Thanks, Ken

Kenneth J. Gish, Jr.

Membei

Direct: 859-226-2293 Fax: 859-425-7996 kgish@stites.com

STITES & HARBISON PLLC

250 West Main Street, Suite 2300, Lexington, KY 40507-1758

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Please consider the environment before printing this email.

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From: Kenneth L Borders

Sent: Friday, August 11, 2017 3:03 PM

To: George Scienski (GScienski@LSPower.com)

Subject: Kentucky Power - Question about station netting - Riverside Generation

Mr. Scienski,

Thank you for your letter dated June 27, 2017 that provided additional detail for Kentucky Power's consideration with respect to Riverside Generating Company LLC's request to terminate retail service under Tariff I.G.S. (Industrial General Service) and receive station power service directly from PJM under a remote self-supply arrangement. Because Riverside's units are located on a single site, a remote self-supply arrangement is not available.


Although Riverside contends that "the Zelda site and the Foothills site may as well be located ten, twenty or even hundreds of miles from each other," the fact remains that they are not. The Riverside site is interconnected with Kentucky Power's grid at the Baker Substation and is served under a single retail billing account with Kentucky Power. An aerial photo demonstrating that Riverside's generating units are located on the same site connected to Kentucky Power's grid at the Baker Substation is attached as Exhibit A.

Further, separate identification and reporting at PJM is not sufficient to divide Riverside's single site into two separate sites. It is not uncommon for individual units of a multiple unit facility to be identified and reported separately at PJM, and this is often the case for a facility with multiple units that have been put in service at different times, as was the case with the Zelda and Foothills generators.

Because Riverside's Zelda and Foothills generators are located on the same site, they do not qualify for the remote self-supply provision of Kentucky Power's Tariff N.U.G (Non-Utility Generator). Accordingly, Kentucky Power will continue to bill Riverside's single retail billing account for the station power it receives under Tariff I.G.S.

Should you have additional questions or need additional information, please feel free to contact me.

Ехнівіт А

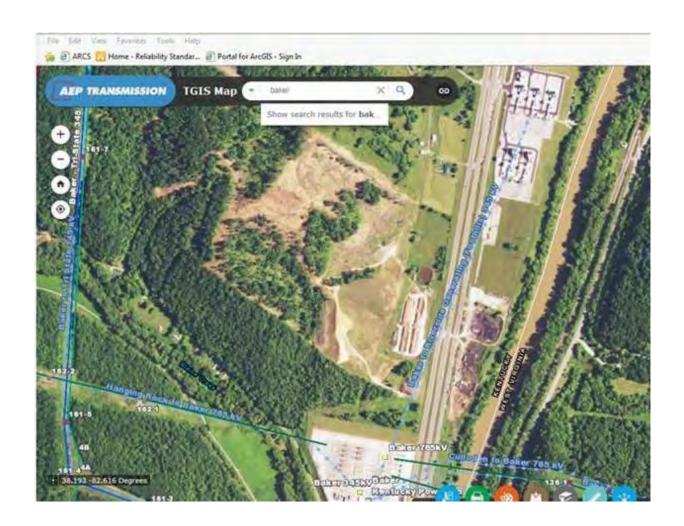

KENNETH L BORDERS | CUSTOMER SVCS ENGINEER PRIN

KLBORDERS@AEP.COM | D:606.929.1453 12333 KEVIN AVENUE, ASHLAND, KY 41102



KPSC Case No. 2017-00472 Riverside's First Set of Data Requests Dated May 18, 2018

DATA REQUEST

5

To the extent Kentucky Power objects to responding to all or any part of a Request for Information herein on the grounds of privilege, please provide a log identifying the full grounds of such privilege, including the factual predicate for invoking the privilege, and, in the case of any communications (whether oral or written), the persons who heard and/or read such communication.

RESPONSE

Please refer to KPCO_R_Riverside_1_5_Attachment1.pdf for the requested privilege log.

Witness: Ranie K. Wohnhas

Reference	Date	Basis	Description
Riverside 1-3 -	July 6, 2001	Attorney-Client	Discussion regarding legal and regulatory
KPCO_R_Riverside_1_3_Attachment1.pdf	' '	privileged	frameworks and applicability to specific factual
at 6 of 89 (redaction).		communication	predicate in connection with service to Dynegy at
			the Riverside Generating Facility and temporary
			auxiliary power from Illinois Power. Author: Errol
			K. Wagner. Recipients: Kevin F. Duffy, Esq., Edgar
			J. Clayton, David M. Roush.
Riverside 1-3 -	July 6, 2001	Attorney-Client	Discussion regarding legal and regulatory
KPCO_R_Riverside_1_3_Attachment1.pdf	' '	privileged	frameworks and applicability to specific factual
at 6 of 89 (redaction).		communication	predicate in connection with service to Dynegy at
, ,			the Riverside Generating Facility and temporary
			auxiliary power from Illinois Power. Author: David
			M. Roush. Recipients: Errol K. Wagner, Kevin F.
			Duffy, Esq., Edgar J. Clayton, Daniel R. Kinney.
Riverside 1-3 -	July 6, 2001	Attorney-Client	Discussion regarding legal and regulatory
KPCO_R_Riverside_1_3_Attachment1.pdf	,	privileged	frameworks and applicability to specific factual
at 6 of 89 (redaction).		communication	predicate in connection with service to Dynegy at
, ,			the Riverside Generating Facility and temporary
			auxiliary power from Illinois Power. Author: Kevin
			F. Duffy, Esq. Recipients: Errol K. Wagner, David
			M. Roush, Edgar J. Clayton.
Riverside 1-3 -	June 6, 2001	Attorney-Client	Discussion regarding legal and regulatory
KPCO_R_Riverside_1_3_Attachment1.pdf		privileged	frameworks and applicability to specific factual
at 6-7 of 89 (redaction).		communication	predicate in connection with service to Dynegy at
·			the Riverside Generating Facility and temporary
			auxiliary power from Illinois Power. Author: David
			M. Roush, Kevin F. Duffy, Esq., Edgar J. Clayton
Riverside 1-3 -	September 5,	Attorney-Client	Discussion regarding anticipated regulatory legal
KPCO_R_Riverside_1_3_Attachment1.pdf	2001	privileged	proceedings and related regulatory and legal
at 69 of 89 (redaction).		communication;	frameworks and applicability to specific factual
·		Attorney Work	predicate related to the electric transmission
		Product	interconnection of Dynegy's expansion of the
			Riverside Generating Facility. Author: Jay H.
			Johnson. Recipients: Jeffrey A. Barsch; Anthony J.
			Boyd; Brent L. Bush; Kevin F. Duffy; Esq. Johnny R.
			Garcia; Darrell E. Guill; Terry D. Hutchinson; Paul
			G. Johnson; Dennis R. Jones; Donald F. Lowry;
			Mark G. Majka; Roderick A. Oberster; Tony
			Paragon; David Parrish; Masoud Rafiee; Ronald D.
			Ryan; Mohan K. Sachdeva; John W. Shields;
			Richard D. Smelker; Timothy V. Straders; Ronald J.
			Wellman; Matthew S. Williams.
Riverside 1-3 -	November 28,	Attorney-Client	Notes prepared in anticipation of regulatory legal
KPCO_R_Riverside_1_3_Attachment1.pdf	2001	privileged	filing and reflecting matters discussed with and
at 54 of 89 (redaction).		communication;	matters to be discussed with legal counsel related
		Attorney Work	to providing electric service to Dynegy at the
		Product	Riverside Generating Facility, as well as notes
			pertaining to other unrelated legal matters and
			ongoing regulatory litigation reflecting
			communications with legal counsel. Author:
			Edgar J. Clayton
Riverside 1-4	March 9, 2017	Attorney-Client	Communication pertaining to client's request for
		privileged	legal advice and legal counsel's advice regarding
		communication	Riverside's retail service under Kentucky Power's
			Tariff N.U.G., applicability of station power remote
			self-supply provisions in PJM's OATT, and related
			legal strategy considerations. Author: Terry L.
			Hemsworth. Recipients: Kenneth L. Borders;
			Hector Garcia, Esq.; John A. Rogness III.

Reference	Date	Basis	Description
Riverside 1-4	March 9, 2017	Attorney-Client privileged communication	Communication pertaining to client's request for legal advice and legal counsel's advice regarding Riverside's retail service under Kentucky Power's Tariff N.U.G., applicability of station power remote self-supply provisions in PJM's OATT, and related legal strategy considerations. Author: Kenneth L. Borders. Recipients: Hector Garcia, Esq.; Terry L. Hemsworth; John A. Rogness III.
Riverside 1-4	March 9, 2017	Attorney-Client privileged communication	Follow-up communication pertaining to client's request for legal advice and legal counsel's advice regarding Riverside's retail service under Kentucky Power's Tariff N.U.G., applicability of station power remote self-supply provisions in PJM's OATT, and related legal strategy considerations. Author: Hector Garcia, Esq. Recipients: Kenneth L. Borders; Terry L. Hemsworth; John A. Rogness III.
Riverside 1-4	March 10, 2017	Attorney-Client privileged communication	Communication pertaining to client's request for legal advice and legal counsel's advice regarding Riverside's retail service under Kentucky Power's Tariff N.U.G., applicability of station power remote self-supply provisions in PJM's OATT, and related legal strategy considerations. Author: Stephen J. Globeck. Recipients: Kenneth L. Borders; David M. Canter; John C. Crespo, Esq.; Amanda R. Conner, Esq.; Hector Garcia, Esq.; Terry L. Hemsworth; Matthew S. McKenzie, Esq.; Robert Pennybaker; John A. Rogness III; David M. Roush; Daniel L. Snider.
Riverside 1-4	March 16, 2017	Attorney-Client privileged communication	Discussion pertaining to client's request for legal advice and legal counsel's advice regarding Riverside's retail service under Kentucky Power's Tariff N.U.G., applicability of station power remote self-supply provisions in PJM's OATT, and related legal strategy considerations. Author: Matthew S. McKenzie, Esq. Recipients: Amanda R. Conner, Esq.; John C. Crespo, Esq.; Stephen J. Globeck; Steven T. Nourse, Esq.; David M. Roush.
Riverside 1-4	March 17, 2017	Attorney-Client privileged communication	Discussion pertaining to client's request for legal advice and legal counsel's advice regarding Riverside's retail service under Kentucky Power's Tariff N.U.G., applicability of station power remote self-supply provisions in PJM's OATT, and related legal strategy considerations. Author: Matthew S. McKenzie, Esq. Recipients: Kenneth L. Borders; David M. Canter; Amanda R. Conner, Esq.; John C. Crespo, Esq.; Hector Garcia, Esq.; Stephen J. Globeck; Terry L. Hemsworth; Robert Pennybaker; John A. Rogness III; David M. Roush; Daniel L. Snider.

Reference	Date	Basis	Description
Riverside 1-4	March 17, 2017	Attorney-Client privileged communication	Discussion pertaining to client's request for legal advice and legal counsel's advice regarding Riverside's retail service under Kentucky Power's Tariff N.U.G., applicability of station power remote self-supply provisions in PJM's OATT, and related legal strategy considerations. Author: Hector Garcia, Esq. Recipients: Kenneth L. Borders; David M. Canter; Amanda R. Conner, Esq.; John C. Crespo, Esq.; Stephen J. Globeck; Terry L. Hemsworth; Matthew S. McKenzie, Esq.; Robert Pennybaker; John A. Rogness III; David M. Roush; Daniel L. Snider.
Riverside 1-4	July 3, 2017	Attorney-Client privileged communication	Discussion pertaining to client's request for legal advice and legal counsel's advice regarding Riverside's retail service under Kentucky Power's Tariff N.U.G., applicability of station power remote self-supply provisions in PJM's OATT, and related legal strategy considerations. Author: Kenneth L. Borders. Recipients: Del Borden; David M. Canter; John C. Crespo, Esq.; Amanda R. Conner, Esq.; Hector Garcia, Esq.; Stephen J. Globeck; Terry L. Hemsworth; Robert Pennybaker; John A. Rogness III; David M. Roush; Daniel L. Snider.
Riverside 1-4	July 3, 2017	Attorney-Client privileged communication	Communication reflecting discussion pertaining to client's request for legal advice and legal counsel's advice regarding Riverside's retail service under Kentucky Power's Tariff N.U.G., applicability of station power remote self-supply provisions in PJM's OATT, and related legal strategy considerations. Author: Hector Garcia, Esq. Recipients: Kenneth L. Borders; Matthew S. McKenzie, Esq.
Riverside 1-4	July 14, 2017	Attorney-Client privileged communication between representatives of the client for the purpose of facilitating the rendition of professional legal services to the client.	Communication reflecting discussions between inhouse counsel and representatives of client pertaining to client's request for legal advice and legal counsel's advice regarding Riverside's retail service under Kentucky Power's Tariff N.U.G., applicability of station power remote self-supply provisions in PJM's OATT, and related legal strategy considerations. Author: Kenneth L. Borders. Recipients: Del Borden; Alex E. Vaughan; Ranie K. Wohnhas.
Riverside 1-4	July 26, 2017	Attorney-Client privileged communication between representatives of the client for the purpose of facilitating the rendition of professional legal services to the client.	Communication reflecting discussions between inhouse counsel and representatives of client pertaining to client's request for legal advice and legal counsel's advice regarding Riverside's retail service under Kentucky Power's Tariff N.U.G., applicability of station power remote self-supply provisions in PJM's OATT, and related legal strategy considerations' for the purpose of facilitating the rendition of professional legal services to the client. Author: Kenneth L. Borders. Recipients: Del Borden; Alex E Vaughan: Ranie K Wohnhas.

Reference	Date	Basis	Description
Riverside 1-4	July 26, 2017	Attorney-Client privileged communication	Discussion pertaining to client's request for legal advice and legal counsel's advice regarding Riverside's retail service under Kentucky Power's Tariff N.U.G., applicability of station power remote self-supply provisions in PJM's OATT, and related legal strategy considerations, for the purpose of facilitating the rendition of professional legal services to the client. Author: Del Borden. Recipients: Kenneth L Borders; Mark R. Overstreet, Esq.; David M Roush; Matthew J. Satterwhite; Alex E. Vaughan; Ranie K. Wohnhas.
Riverside 1-4	August 7, 2017	Attorney-Client privileged communication	Communication reflecting discussion pertaining to client's request for legal advice and legal counsel's advice regarding Riverside's retail service under Kentucky Power's Tariff N.U.G., applicability of station power remote self-supply provisions in PJM's OATT, and related legal strategy considerations. Author: Mark R. Overstreet, Esq. Recipients: Kenneth L. Borders; Amy J. Elliott; Hector Garcia, Esq.; Kenneth J. Gish, Esq.; Alex E. Vaughan; Ranie K. Wohnhas.
Riverside 1-4	August 7, 2017	Attorney-Client privileged communication between representatives of the client for the purpose of facilitating the rendition of professional legal services to the client.	Communication reflecting discussion with Hector Garcia, Esq.; Kenneth J. Gish, Esq.; Mark Overstreet, Esq., and representatives of client, pertaining to client's request for legal advice and legal counsel's advice regarding Riverside's retail service under Kentucky Power's Tariff N.U.G., applicability of station power remote self-supply provisions in PJM's OATT, and related legal strategy considerations, for the purpose of facilitating the rendition of professional legal services to the client. Author: Alex E. Vaughan. Recipients: David M. Roush.
Riverside 1-4	August 8, 2017	Attorney-Client privileged communication	Communication reflecting discussion pertaining to client's request for legal advice and legal counsel's advice regarding Riverside's retail service under Kentucky Power's Tariff N.U.G., applicability of station power remote self-supply provisions in PJM's OATT, and related legal strategy considerations. Author: Alex E. Vaughan. Recipients: Kenneth L. Borders; Amy J. Elliott; Hector Garcia, Esq.; Kenneth J. Gish, Esq.; Matthew S. McKenzie, Esq.; Mark Overstreet, Esq.; Ranie K. Wohnhas.
Riverside 1-4	August 8, 2017	Attorney-Client privileged communication	Follow up communication reflecting discussion pertaining to client's request for legal advice and legal counsel's advice regarding Riverside's retail service under Kentucky Power's Tariff N.U.G., applicability of station power remote self-supply provisions in PJM's OATT, and related legal strategy considerations. Author: Alex E. Vaughan. Recipients: Kenneth L. Borders; Amy J. Elliott; Hector Garcia, Esq.; Kenneth J. Gish, Esq.; Matthew S. McKenzie, Esq.; Mark Overstreet, Esq.; Ranie K. Wohnhas.

Reference	Date	Basis	Description
Riverside 1-4	August 8, 2017	Attorney-Client privileged communication	Communication reflecting discussion pertaining to client's request for legal advice and legal counsel's advice regarding Riverside's retail service under Kentucky Power's Tariff N.U.G., applicability of station power remote self-supply provisions in PJM's OATT, and related legal strategy considerations. Author: Ranie K. Wohnhas. Recipients: Kenneth L. Borders; Amy J. Elliott; Hector Garcia, Esq.; Kenneth J. Gish, Esq.; Matthew S. McKenzie, Esq.; Mark R. Overstreet, Esq.; Alex E. Vaughan.
Riverside 1-4	August 8, 2017	Attorney-Client privileged communication; Attorney Work Product.	Discussion pertaining to client's request for legal advice and legal counsel's advice regarding Riverside's retail service under Kentucky Power's Tariff N.U.G., applicability of station power remote self-supply provisions in PJM's OATT, and related legal strategy considerations. Author: Mark R. Overstreet, Esq. Recipients: Del Borden; Kenneth L. Borders; Amy J. Elliott; Hector Garcia, Esq.; Kenneth J. Gish, Esq.; Matthew S. McKenzie, Esq.; David M. Roush; Matthew J. Satterwhite; Alex E. Vaughan; Ranie K. Wohnhas.
Riverside 1-4	August 8, 2017	Attorney-Client privileged communication	Discussion pertaining to client's request for legal advice and legal counsel's advice regarding Riverside's retail service under Kentucky Power's Tariff N.U.G., applicability of station power remote self-supply provisions in PJM's OATT, and related legal strategy considerations. Author: Hector Garcia, Esq. Recipients: Del Borden; Kenneth L. Borders; Amy J. Elliott; Kenneth J. Gish, Esq.; Matthew S. McKenzie, Esq.; Mark R. Overstreet, Esq.; David M. Roush; Matthew J. Satterwhite; Alex E. Vaughan; Ranie K. Wohnhas.
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Riverside 1-4	August 8, 2017	Attorney-Client privileged communication	Discussion pertaining to client's request for legal advice and legal counsel's advice regarding Riverside's retail service under Kentucky Power's Tariff N.U.G., applicability of station power remote self-supply provisions in PJM's OATT, and related legal strategy considerations. Author: Alex E. Vaughan. Recipients: Del Borden; Kenneth L. Borders; Amy J. Elliott; Hector Garcia, Esq.; Kenneth J. Gish, Esq.; Matthew S. McKenzie, Esq.; Mark R. Overstreet, Esq.; David M. Roush; Matthew J. Satterwhite; Ranie K. Wohnhas.

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Riverside 1-4	August 8, 2017	Attorney-Client privileged communication between representatives of the client for the purpose of facilitating the rendition of professional legal services to the client.	Communication reflecting discussion with Hector Garcia, Esq.; Kenneth J. Gish, Esq.; Mark Overstreet, Esq., and representatives of client, pertaining to client's request for legal advice and legal counsel's advice regarding Riverside's retail service under Kentucky Power's Tariff N.U.G., applicability of station power remote self-supply provisions in PJM's OATT, and related legal strategy considerations, for the purpose of facilitating the rendition of professional legal services to the client. Author: Alex E. Vaughan. Recipients: Stephen J. Globeck, David M. Roush.
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Reference	Date	Basis	Description
Riverside 1-4	August 9, 2017	Attorney-Client privileged communication	Follow-up discussion pertaining to client's request for legal advice and legal counsel's advice regarding Riverside's retail service under Kentucky Power's Tariff N.U.G., applicability of station power remote self-supply provisions in PJM's OATT, and related legal strategy considerations. Author: Alex E. Vaughan. Recipients: Del Borden; Kenneth L. Borders; Amy J. Elliott; Hector Garcia, Esq.; Kenneth J. Gish, Esq.; Matthew S. McKenzie, Esq.; David M. Roush; Mark R. Overstreet, Esq.; Matthew J. Satterwhite; Ranie K. Wohnhas.
Riverside 1-4	August 9, 2017	Attorney-Client privileged communication	Follow-up discussion pertaining to client's request for legal advice and legal counsel's advice regarding Riverside's retail service under Kentucky Power's Tariff N.U.G., applicability of station power remote self-supply provisions in PJM's OATT, and related legal strategy considerations. Author: Mark R. Overstreet, Esq. Recipients: Del Borden; Kenneth L. Borders; Amy J. Elliott; Hector Garcia, Esq.; Kenneth J. Gish, Esq.; Matthew S. McKenzie, Esq.; David M. Roush; Matthew J. Satterwhite; Alex E. Vaughan; Ranie K. Wohnhas.
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Riverside 1-4	August 10, 2017	Attorney-client privileged communication	Communication pertaining to client's request for legal advice and legal counsel's advice regarding Riverside's retail service under Kentucky Power's Tariff N.U.G., and related negotiations between Kentucky Power and Riverside. Author: Amy J. Elliott. Recipients: Del Borden; Kenneth L. Borders; Matthew J. Satterwhite; Hector Garcia, Esq.; Kenneth Gish, Esq.; Matthew McKenzie, Esq.; Mark Overstreet, Esq.; David M. Roush.
Riverside 1-4	August 10, 2017	Attorney-client privileged communication	Discussion pertaining to client's request for legal advice and legal counsel's advice regarding Riverside's retail service under Kentucky Power's Tariff N.U.G., and related negotiations between Kentucky Power and Riverside. Author: David M. Roush. Recipients: Del Borden; Kenneth L. Borders; Amy J. Elliott; Hector Garcia, Esq.; Kenneth J. Gish, Esq.; Matthew S. McKenzie, Esq.; Mark Overstreet, Esq.; Matthew J. Satterwhite.
Riverside 1-4	August 10, 2017	Attorney-client privileged communication	Discussion pertaining to client's request for legal advice and legal counsel's advice regarding Riverside's retail service under Kentucky Power's Tariff N.U.G., and related negotiations between Kentucky Power and Riverside. Author: Mark Overstreet, Esq. Recipients: Amy J. Elliott; Hector Garcia, Esq.; Kenneth J. Gish, Esq.; David M. Roush; Matthew J. Satterwhite.

Reference	Date	Basis	Description
Riverside 1-4	August 10, 2017 August 10, 2017	Attorney-client privileged communication	Discussion pertaining to client's request for legal advice and legal counsel's advice regarding Riverside's retail service under Kentucky Power's Tariff N.U.G., and related negotiations between Kentucky Power and Riverside. Author: Hector Garcia, Esq. Recipients: Del Borden; Kenneth L. Borders; Amy J. Elliott; Kenneth J. Gish, Esq.; Matthew McKenzie, Esq.; Mark Overstreet, Esq.; David M. Roush; Matthew J. Satterwhite. Continuing follow-up discussion pertaining to
		privileged communication	client's request for legal advice and legal counsel's advice regarding Riverside's retail service under Kentucky Power's Tariff N.U.G., and related negotiations between Kentucky Power and Riverside. Author: Kenneth J. Gish, Esq. Recipients: Del Borden; Kenneth L. Borders; Amy J. Elliott; Hector Garcia, Esq.; Matthew McKenzie, Esq.; Mark Overstreet, Esq.; David M. Roush; Matthew J. Satterwhite.
Riverside 1-4	August 10, 2017	Attorney-client privileged communication	Follow-up discussion pertaining to client's request for legal advice and legal counsel's advice regarding Riverside's retail service under Kentucky Power's Tariff N.U.G., and related negotiations between Kentucky Power and Riverside. Author: Hector Garcia, Esq. Recipients: Del Borden; Kenneth L. Borders; Amy J. Elliott; Kenneth J. Gish, Esq.; Matthew McKenzie, Esq.; Mark Overstreet, Esq.; David M. Roush; Matthew J. Satterwhite.
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Riverside 1-4	August 10, 2017	Attorney-client privileged communication	Communication pertaining to client's request for legal advice and legal counsel's advice regarding Riverside's retail service under Kentucky Power's Tariff N.U.G., and related negotiations between Kentucky Power and Riverside. Author: Amy J. Elliott. Recipients: Del Borden; Kenneth L. Borders; Matthew J. Satterwhite; Hector Garcia, Esq.; Kenneth Gish, Esq.; Matthew McKenzie, Esq.; Mark Overstreet, Esq.; David M. Roush; Ranie K. Wohnhas.

Reference	Date	Basis	Description
Riverside 1-4	August 11, 2017	Attorney-client privileged communication	Discussion pertaining to client's request for legal advice and legal counsel's advice regarding Riverside's retail service under Kentucky Power's Tariff N.U.G., and related negotiations between Kentucky Power and Riverside. Author: Amy J. Elliott. Recipients: Del Borden; Kenneth L. Borders; Hector Garcia, Esq.; Kenneth Gish, Esq.; Matthew McKenzie, Esq.; Mark Overstreet, Esq.; David M. Roush; Matthew J. Satterwhite; Ranie K. Wohnhas.
Riverside 1-4	August 11, 2017	Attorney-client privileged communication	Discussion pertaining to client's request for legal advice and legal counsel's advice regarding Riverside's retail service under Kentucky Power's Tariff N.U.G., and related negotiations between Kentucky Power and Riverside. Author: Ranie K. Wohnhas. Recipients: Del Borden; Kenneth L. Borders; Amy J. Elliott; Hector Garcia, Esq.; Kenneth Gish, Esq.; Matthew McKenzie, Esq.; Mark Overstreet, Esq.; David M. Roush; Matthew J. Satterwhite.
Riverside 1-4	August 11, 2017	Attorney-client privileged communication between representatives of the client for the purpose of facilitating the rendition of professional legal services to the client.	Follow up discussion between representatives of client pertaining to client's request for legal advice and legal counsel's advice regarding Riverside's retail service under Kentucky Power's Tariff N.U.G., and related negotiations between Kentucky Power and Riverside, for the purpose of facilitating the rendition of professional legal services to the client. Author: Kenneth L. Borders. Recipients: Del Borden; Amy J. Elliott.
Riverside 1-4	August 11, 2017	Attorney-client privileged communication	Discussion pertaining to client's request for legal advice and legal counsel's advice regarding Riverside's retail service under Kentucky Power's Tariff N.U.G., and related negotiations between Kentucky Power and Riverside. Author: Kenneth J. Gish, Esq. Recipients: Del Borden; Kenneth L. Borders; Amy J. Elliott; Hector Garcia, Esq.; Matthew McKenzie, Esq.; Mark Overstreet, Esq.; David M. Roush; Matthew J. Satterwhite.
Riverside 1-4	August 14, 2017	Attorney-Client privileged communication between representatives of the client for the purpose of facilitating the rendition of professional legal services to the client.	Communication pertaining to client's request for legal advice and legal counsel's advice regarding Riverside's retail service under Kentucky Power's Tariff N.U.G., and related negotiations between Kentucky Power and Riverside. Author: Amy J. Elliott. Recipients: Kenneth J. Gish, Esq.; Matthew S. McKenzie; Mark R. Overstreet, Esq.; David M. Roush; Matthew J. Satterwhite; Stephen L. Sharp, Jr.; Alex E. Vaughan; Ranie K. Wohnhas.
Riverside 1-4	August 14, 2017	Attorney-Client privileged communication between representatives of the client for the purpose of facilitating the rendition of	Communication pertaining to client's request for legal advice and legal counsel's advice regarding Riverside's retail service under Kentucky Power's Tariff N.U.G., and related negotiations between Kentucky Power and Riverside' for the purpose of facilitating the rendition of professional legal services to the client. Author: Kenneth L. Borders. Recipients: Amy J. Elliott.

Reference	Date	Basis	Description
		professional legal	
		services to the client.	
Riverside 1-4	December 6, 2017	Attorney-Client privileged communication; confidential attorney work product.	Discussion pertaining to client's request for legal advice and legal counsel's advice regarding Riverside's retail service under Kentucky Power's Tariff N.U.G., and related anticipate litigation. Author: Hector Garcia, Esq. Recipients: Bill Allen; James R. Bacha; Amanda R. Conner, Esq.; John C. Crespo; Matthew A. Horeled; Melva J. Lutton; Matthew S. McKenzie, Esq.; David M. Roush; Betsy Sekula; Alex E. Vaughan; Ranie K Wohnhas.
Riverside 1-4	December 7, 2017	Attorney-Client privileged communication between representatives of the client for the purpose of facilitating the rendition of professional legal services to the client. Document protected by the attorney work product doctrine.	Communication pertaining to client's request for legal advice and legal counsel's advice regarding Riverside's retail service under Kentucky Power's Tariff N.U.G., and related negotiations between Kentucky Power and Riverside' for the purpose of facilitating the rendition of professional legal services to the client. Author: Kenneth L. Borders. Recipients: Alex E. Vaughan, Ranie K. Wohnhas, Delinda Borden
Riverside 1-4	December 7, 2017	Attorney-Client privileged communication; document protected by the attorney work product doctrine.	Follow-up communication pertaining to client's request for legal advice and legal counsel's advice regarding Riverside's retail service under Kentucky Power's Tariff N.U.G., and related anticipated regulatory litigation. Author: Ranie K. Wohnhas. Recipients: Amy J. Elliott; Kenneth L. Borders; Mark R. Overstreet, Esq.; Matthew J. Satterwhite; Alex E. Vaughan.
Riverside 1-4	December 7, 2017	Attorney-Client privileged communication; document protected by the attorney work product doctrine.	Follow-up communication pertaining to client's request for legal advice and legal counsel's advice regarding Riverside's retail service under Kentucky Power's Tariff N.U.G., and related anticipated regulatory litigation. Author: Alex E. Vaughan. Recipients: Amy J. Elliott; Kenneth L. Borders; Mark R. Overstreet, Esq.; Matthew J. Satterwhite; Ranie K. Wohnhas.
Riverside 1-4	December 7, 2017	Attorney-Client privileged communication; document protected by the attorney work product doctrine.	Follow-up communication pertaining to client's request for legal advice and legal counsel's advice regarding Riverside's retail service under Kentucky Power's Tariff N.U.G., and related anticipated regulatory litigation. Author: Alex E. Vaughan. Recipients: Amy J. Elliott; Kenneth L. Borders; Mark R. Overstreet, Esq.; Matthew J. Satterwhite; Ranie K. Wohnhas.

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DATA REQUEST

6

Refer to Kentucky Power's Answer. Please state all facts and identify all documents relied upon in support of Kentucky Power's Third Defense, and particularly Kentucky Power's statement that "...the facts as alleged in the Complaint, even if proven by Riverside, do not entitle Riverside to self-supply remotely and take service under PJM's OATT.

RESPONSE

The Company's Third Defense recognizes that Riverside is not entitled to self-supply remotely and take service under PJM's OATT even assuming the Zelda and Foothills generating units were distinct and remote facilities (which they are not) as alleged in paragraphs three, eight, nine, and 10 of Riverside's complaint. Remote self-supply under PJM's OATT requires that the generating facilities are owned by the same legal entity. Moreover, remote self-supply under PJM's OATT, by its own terms, is not available to displace a generator's obligation to pay for retail service related to station power served by retail supply.

The facts and documents Kentucky Power relies upon in raising this defense include:

- (a) Riverside's responses to KPSC 1-1(a); KPSC 1-1(b); KPSC 1-4; KPSC 1-7; KPSC 1-8; KPCo 1-1; KPCO 1-6; KPCo 1-7; KPCo 1-8; KPCo 1-9; KPCo 1-10; KPCo 1-11; KPCo 1-12; and KPCo 1-13.
- (b) The following PJM OATT sections and materials:

TRANSMISSION TARIFF --> OATT VI. ADMINISTRATION AND STUDY OF NEW SERVICE

REQUESTS; R --> OATT ATTACHMENT K – APPENDIX --> OATT ATTACHMENT K APPENDIX SECTION 1 - MARKET OPERATIONS --> OATT Attachment K Appendix Sec 1.7 General – 1.7

Intra-PJM Tariffs --> OPEN ACCESS TRANSMISSION TARIFF --> OATT VI. ADMINISTRATION AND STUDY OF NEW SERVICE

REQUESTS; R --> OATT ATTACHMENT O --> OATT ATTACHMENT O APPENDIX 2 --> OATT ATTACHMENT O.A2.2

Interconnection Service --> OATT ATTACHMENT O.A2.2.3 No Transmission Services:

PJM Manual 28: Operating Agreement Accounting; Revision 79; Section 13: Station Power Accounting

Please see KPCO_R_Riverside_1_6_Attachment1.pdf for PJM Member Community Whitepaper.

(c) Riverside Response to KPSC 1-6, page 3-4 of 27 (January 24, 2017 e-mail from Helen M. Burnley (PJM) to George Scienski (Riverside):

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Generators can group together to form a single station service netting portfolio. A portfolio is defined by generators that share the same lowest level of corporate ownership.

If a generator has defined itself as its own LLC, it cannot net with other generators, even if they are "owned" in the PJM market by a common member. For example, if Unit A and Unit B are owned in the PJM Energy Market settlements by Power Marketer X. If there is a Unit A LLC and a Unit B LLC, these two units cannot net relative to the Station Service netting evaluation.

Conversely, if the two units are "owned" in the PJM Energy Market settlements by two different PJM Members but their lowest level corporate parent is the same company, they can net relative to the station service netting evaluation.

KPSC 1-6 pages 6-14, 18-27 (e-mails from Ken Borders (Kentucky Power) to George Scienski (Riverside).

(d) Testimony of Ranie K. Wohnhas at pages 10-15

Witness: Ranie K. Wohnhas

Item No. 6 Page 1 of 3

PJM Station Power Settlements

Solution Details

Article Type Solution Article

Knowledge Manager

Expiration Date 9/1/2017

Article Content

The mechanics of PJM's Station Power settlements are documented in Manual 28, Section 13 as well as in the PJM Tariff, Attachment K - Appendix, Section 1.7.10. Station Power Settlements occur are on a one-month lag.

As part of PJM's station power settlements, PJM determines if a generator self-supplied its Station Power or obtained Station Power from third-party providers.

A generator may self-supply Station Power for its generation facility during any month (1) when the net output of such facility is positive, or (2) when the net output of such facility is negative and the generator during the same month has available at other of its generation facilities positive net output in an amount at least sufficient to offset fully negative net output.

PJM station power settlements is controlled by what is or is not submitted to PJM via the Power Meter tool.

- If the generator has a wholesale station service arrangement, a negative MWh value should be reported in Power Meter when the unit is off-line and consuming energy.
- If the generator has a superseding retail station service arrangement, a zero (0) MWh value should be reported in Power Meter when the unit is off-line and consuming energy. In this case, compensation for station power consumption is handled bilaterally between the EDCs and generation owners and PJM billing adjustments for station power are not applicable.
- Regardless of which party actually controls the submission of values into Power Meter, it is both the EDC and Generation Owner's mutual responsibility to ensure values are submitted into Power Meter as accurately as possible by the established submission deadlines.
 - For example, the Generation Owner should not submit Station Power negatives into Power Meter during offline hours if they have a superseding retail agreement with the EDC or another third party.
 - Similarly, the EDC would want to make sure Station Power negatives are submitted into Power Meter if they have no retail Station Power agreement with the generator.
 - If a participant needs information on contacts at a given EDC regarding Station Power arrangements, you can give PJM permission to forward your contact information and inquiry to the given EDC's registered Power Meter users.

For the PJM weekly and monthly bills, PJM market settlements are based on generator values as reported to Power Meter. Positive Generation reported in Power Meter would result in a credit (MWh * LMP) on the PJM Bill. Negative Generation (i.e. consumption) reported in Power Meter would result in a charge (MWh * LMP) on the PJM Bill.

After the given month's bill is issued, PJM evaluates if a generator (or group of Dated May 18, 2018 generators) has net negative generation for the month.

The generators that have a net negative amount of MWs for the month will then be

classified into two categories.

If a group of generators had net positive total generation for the calendar month but had one or more individual generators each had a total negative generation for the month, the negative generators had Remote Self-Supply. Remote self-supply indicates station power at a particular generator was supplied from another generator in its portfolio.

Remote Self-Supply

For those generators which received Station Power through Remote Self-Supply, the PJM member needs to be charged non-firm point-to-point transmission service. This amount is based on the non-firm point-to-point transmission service rate multiplied by the negative MW amount.

If a generator or group of generators had net negative total generation for the month, those generators which had a negative net generation amount were served station power by retail supply/third party supply. Retail supply means the local EDC or other third party needed to serve the station power load of a generator and will therefore charge the generator owner the appropriate retail rates.

Retail Supply (Third-Party Supply)

In situations of Retail Supply, the generator is charged the wholesale rate for station service (the LMP for the generator bus) during the original wholesale market settlements. However, since those generators actually received Station Power through Retail Supply, the generator actually received the needed power from the local EDC or third party at the retail rate. This amount will be charged to the generator owner by the EDC, and the original wholesale LMP charge needs to be 'backed-out' - not charged to the generator. Thus the generator owner gets a credit, and the EDC will receive a charge, both of which are to balance the original wholesale charge which was made earlier in the settlements process.

Generators can group together to form a single station service netting portfolio. A portfolio is defined by generators which share the same lowest level corporate entity ownership.

- If a generator has defined itself as it is own LLC, it cannot net with other generators, even if they are "owned" in the PJM Market by a common member. For example, if unit A and unit B are "owned" in the PJM Energy Market settlements by Power Marketer X. If there is a Unit A LLC and a Unit B LLC, these two units cannot net relative to the Station Service netting evaluation.
- Conversely, if two units are "owned" in the PJM Energy Market settlements by two different PJM Members but their lowest level corporate parent is the same company, then they can net relative to the station service netting evaluation.
- As long as the portfolio is net Generation to the Grid for the month, then there
 is no retail billing. However, if a Unit within the portfolio is net negative, then
 PJM charges 67 Cents per MWh of net negative for the transmission service to
 remote supply from unit A to unit B.

Additional details can be found in PJM Manual 28, Section 13 at (Home > Library > Manuals) http://www.pjm.com/library/manuals.aspx

Last Published Date

12/12/2016 10:59 AM

Last Modified By Glenn Weiss

Item No. 6 Page 3 of 3

Information

First Published Date 8/29/2014 1:48 PM

Created By Bill Walker

KPSC Case No. 2017-00472 Riverside's First Set of Data Requests Dated May 18, 2018

DATA REQUEST

7

Refer to the Wohnhas Testimony, page 4, wherein Mr. Wohnhas discusses the initial appearance of Tariff N.U.G. - Non-Utility Generator ("Tariff N.U.G.") as part of Kentucky Power's Tariff.

- (a) Please explain why Kentucky Power added Tariff N.U.G. to its tariff in or around October of 2001.
- (b) Please describe in detail each time Kentucky Power has sought to amend its Tariff N.U.G.
- (c) Please provide a copy of each version of Tariff N.U.G. that has been approved by the Commission and indicate the timeframe during which each version was valid.
- (d)Please identify and describe each customer Kentucky Power has served under its Tariff N.U.G., as well as the terms and conditions of the service provided.

RESPONSE

a. The tariff was intended to address the Company's understanding of then-existing FERC regulations and the advent of independent power producers.

b and c. Kentucky Power sought to amend Tariff N.U.G. in Case Nos. 2005-00341, 2009-00459, 2014-00396, and 2017-00179. The approved Company modifications can be found in KPCO_R_Riverside_1_7_Attachment1.pdf.

d. No customer other than Riverside is or has been served under Tariff N.U.G.

Witness: Ranie K. Wohnhas

KPSC Case No. 2017-00472 Riverside's First Set of Data Requests SHEET NO. — Dated May 18, 2018 SHEET NO. Item No. 7 P.S.C. ELECTRIC NO. 7 Page 1 of 15

CANCELING

TARIFF N.U.G. (Non-Utility Generator)

AVAILABILITY OF SERVICE.

This tariff is applicable to customers with generation facilities which have a total design capacity of even 1,000 kW. that intend to schedule, deliver and sell the net electric output of the facility at wholesale, and who require Commuscionana Power, Startup Power and/or Station Power service from the Company.

Service to any load that is electrically isolated from the customer's generator shall be separately metered and provided in accordance with the generally available demand-metered tariff appropriate for such service to the customer.

This tariff is not available for standby, backup, maintenance, or supplemental service for wholesale or retail loads served by customer's generator.

DEFINITIONS.

- Commissioning Power The electrical energy and capacity supplied to the customer prior to the commercial operation of the customer's generator, including initial construction and testing phases.
- Station Power The electrical energy and capacity supplied to the customer to serve the auxiliary loads at the customer's generation facilities, usually when the customer's generator is not operating. Station Power does not include Startup Power.
- Startup Power The electrical energy and capacity supplied to the customer following a planned or forced outage of the customer's generator for the purpose of returning the customer's generator to synchronous operation.

COMMISSIONING POWER SERVICE.

Customers requiring Commissioning Power shall take service under Tariff T.S. or by special agreement with the Company.

The customer shall coordinate its construction and testing with the Company to ensure that the customer's operations do not cause any undue interference with the Company's obligations to provide service to its other customers or impose a burden on the Company's system or any system interconnected with the Company.

STATION POWER SERVICE.

CAMCELLED Customers requiring Station Power shall take service under the generally available demand-metered tariff appropriate for the customer's Station Power requirements.

Station Contract Capacity - The customer shall contract for a definite amount of electrical capacity in kW sufficient to meet the maximum Station Power requirements that the Company is expected to supply under the generally available demand-metered tariff appropriate for the customer.

STARTUP POWER SERVICE.

Customers requiring Startup Power have the option of contracting for such service under the terms of this tariff or under the generally available demand-metered tariff appropriate for the customer's Startup Power requirements.

Startup Contract Capacity - The customer shall contract for a definite amount of electrical capacity in kW sufficient to meet the maximum Startup Power requirements that the Company is expected to supply.

Startup Duration - The customer shall contract for a definite number of hours sufficient to meet the maximum period of time for which the Company is expected to supply Startup Power.

Startup Frequency – The customer shall contract for a definite number of startup events sufficient to meet the maximum number of times per year that the Company is expected to supply startup Power COMMISSION OF KENTUCKY

Other Startup Characteristics - The customer shall provide to the Company o使声通荷胸虹ion regarding the customer's Startup Power requirements, including, but not limited to, anticipated time-of-use and seasonal characteristics.

Notification Requirement - Whenever Startup Power is needed, the customer shall provide advance notice to the Company.

PURSUANT TO 807 KAR 5:011, SECTION 9 (1)

(Cont'd. on Sheet No. 28-2)

SECRETARY OF THE COMMISSION

DATE OF ISSUE August 20, 2001

DATE EFFECTIVE September 27, 2001

WAGNER

DIRECTOR OF REGULATORY SERVICES

FRANKFORT, KENTUCKY

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		Riverside's Firs	st Set of Data Requests
	ORIGINAL	SHEET NO.	Dated May 18, 2018
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		PSC FLECT	RIC NO 7 Page 2 of 15

TARIFF N.U.G. (Cont'd) (Non-Utility Generator)

STARTUP POWER SERVICE. (cont'd)

Upon receipt of a request from the customer for Startup Power Service under the terms of this tariff, the Company will provide the customer a written offer containing the Notification Requirement, generation rates (including demand and energy charges) and related terms and conditions of service under which service will be provided by the Company. Such offer shall be based upon the Startup Contract Capacity, Startup Duration, Startup Frequency, and Other Startup Characteristics as specified by the customer. In no event shall the generation rates be less than the sum of the Tariff C.I.P.-T.O.D. Energy Charge, the Fuel Adjustment Clause, the System Sales clause, the Experimental Demand-Side Management Adjustment Clause, and the Net Merger Savings Credit.

If the parties reach an agreement based upon the offer provided to the customer by the Company, a contract shall be executed that provides full disclosure of all rates, terms and conditions of service under this tariff, and any and all agreements related thereto.

Monthly Transmission and Distribution Rates

Service Voltage

CAMCELLED

Subtransmission Transmission Tariff Code 392 393 Reservation Charge per kW \$ 3.25 \$ 2.28

Reactive Demand Charge for each kiloVAR of maximum Leading or Lagging Reactive Demand in Excess of 50% of the kW of monthly metered demand\$ 0.60 per kVAR

Delayed Payment Charge

This Tariff is net if account is paid in full within 15 days of date of bill. On all accounts not so paid, an additional charge of 5% of the unpaid balance will be made.

Monthly Billing Demand

The monthly billing demand in kW shall be taken each month as the highest single 15-minute integrated peak in kW as registered by a demand meter or indicator, less the Station Contract Capacity. The monthly billing demand so established shall in no event be less than the greater of (a) the Startup Contract Capacity or (b) the customer's highest previously established monthly billing demand during the past 11 months.

Monthly Billing Energy

Interval billing energy shall be measured each 15-minute interval of the month as the total kWh registered by an energy meter or meters less the quotient of the Station Contract Capacity and four (4). In no event shall the interval billing energy be less than zero (0). Monthly billing energy shall be the sum of the interval billing energy for all intervals of the billing month.

TRANSMISSION SERVICE.

Transmission Provider - The entity providing transmission service to customers in the Company's service territory. Such entity may be the Company or a regional transmission entity.

Prior to taking service under this tariff, the customer must have a fully executed Interconnecting and/or the Transmission Provider or an unexecuted agreement filed with the Figure Energy Regulatory Commission under applicable procedures. Regulatory Commission under applicable procedures. **EFFECTIVE**

Should the Transmission Provider implement charges for Transmission Congestion, the Company shall provide 30 days written notice to the customer. Upon the expiration of such notice period, should the customer's use of Startup Power result in any charges for Transmission Congestion from the Transmission Provider, such Spines including any applicable taxes or assessments, shall be paid by or passed through to the customer without markup. Transmission Congestion is the condition that exists when market participants seek to dispatch in a pattern that would result in power of the physically accommodated by the system. flows that cannot be physically accommodated by the system. SECTION 9 (1)

SECRETARY OF THE COMMISSION

DATE OF ISSUE August 20 K WAGNER

DATE EFFECTIVE September 27, 2001

FRANKFORT, KENTUCKY DIRECTOR OF REGULATORY SERVICES

Issued by authority of an Order at the Public Service Commission in Case No

KPSC Case No. 2017-00472					
Riverside's First Set of Data Requests					
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CANCELING

ORIGINAL

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Item No. 7

N

P.S.C. ELECTRIC NO. 7 Page 3 of 15

(Cont'd. on Sheet No. 28-3)

TARIFF N.U.G. (Cont'd) (Non-Utility Generator)

TERM OF CONTRACT

Contracts under this tariff will be made for an initial period of not less than one year and shall remain in effect thereafter until either party shall give at least 6 months' written notice to the other of the intention to terminate the contract. The Company reserves the right to require initial contracts for periods greater than one year.

A new initial contract period will not be required for existing customers who change their contract requirements after the original initial period unless new or additional facilities are required.

The Company may not be required to supply capacity in excess of that contracted for except by mutual agreement. Contracts will be made in multiples of 100 kW.

SPECIAL TERMS AND CONDITIONS.

This tariff is subject to the Company's Terms and Conditions of Service.

This tariff shall not obligate the Company to purchase or pay for any capacity or energy produced by the customer's generator.

Customers desiring to provide Startup and Station Power from commonly owned generation facilities that are not located on the site of the customer's generator (remote self-supply), shall take service under the terms and conditions contained within the applicable Open Access Transmission Tariff as filed with and accepted by the Federal Energy Regulatory Commission.





PUBLIC SERVICE COMMISSION OF KENTUCKY EFFECTIVE

SEP 27 2001

PURSUANT TO 807 KAR 5:011, SECTION 9 (1) SECRETARY OF THE COMMISSION

DATE EFFECTIVE September 27, 2001

DIRECTOR OF REGULATORY SERVICES Issued by authority of an Order at the Public Sentice Commission in Cose No

FRANKFORT, KENTUCKY ADDRESS

DATE OF ISSUE August

Original Sheet No. 26-1
Canceling Sheet No. 26-1

P.S.C. ELECTRIC NO. 8

TARIFF N.U.G. (Non-Utility Generator)

AVAILABILITY OF SERVICE.

This tariff is applicable to customers with generation facilities which have a total design capacity of over 1,000 kW that intend to schedule, deliver and sell the net electric output of the facility at wholesale, and who require Commissioning Power, Startup Power and/or Station Power service from the Company.

Service to any load that is electrically isolated from the Customer's generator shall be separately metered and provided in accordance with the generally available demand-metered tariff appropriate for such service to the Customer.

This tariff is not available for standby, backup, maintenance, or supplemental service for wholesale or retail loads served by customer's generator.

DEFINITIONS.

- Commissioning Power The electrical energy and capacity supplied to the customer prior to the
 customer's generator, including initial construction and testing phases.
- Station Power The electrical energy and capacity supplied to the customer to serve the auxiliary loads at the customer's generation facilities, usually when the customer's generator is not operating. Station Power does not include Startup Power.
- Startup Power The electrical energy and capacity supplied to the customer following a planned or forced outage of the
 customer's generator for the purpose of returning the customer's generator to synchronous operation.

COMMISSIONING POWER SERVICE.

Customers requiring Commissioning Power shall take service under Tariff'f.S. or by special agreement with the Company.

The Customer shall coordinate its construction and testing with the Company to ensure that the customer's operations do not cause any undue interference with the Company's obligations to provide service to its other customers or impose a burden on the Company's system or any system interconnected with the Company.

STATION POWER SERVICE.

Customers requiring Station Power shall take service under the generally available demand-metered tariff appropriate for the customer's Station Power requirements.

Station Contract Capacity - The Customer shall contract for a definite amount of electrical capacity in kW sufficient to meet the maximum Station Power requirements that the Company is expected to supply under the generally available demandmentered tariff appropriate for the customer.

STARTUP POWER SERVICE.

Customers requiring Startup Power have the option of contracting for such service under the terms of this tariff or under the generally available demand-metered tariff appropriate for the customer's Startup Power requirements.

Startup Contract Capacity - The Customer shall contract for a definite amount of electrical capacity in kW sufficient to meet the maximum Startup Power requirements that the Company is expected to supply.

Startup Duration - The Customer shall contract for a definite number of hours sufficient to meet the maximum period of time for which the Company is expected to supply Startup Power.

Startup Frequency - The Customer shall contract for a definite number of startup events sufficient to meet the maximum number of times per year that the Company is expected to supply Startup Power.

Other Startup Characteristics - The customer shall provide to the Company other information regarding the customer's Startup Power requirements, including, but not limited to, anticipated time of use and seasonal characteristics.

Notification Requirement - Whenever Startup Power is needed, the Customer shall provide advance native to the Company.

By

(Cont'd. on Sheet No. 26-2)

EFFECTIVE 3/30/2006

DATE OF ISSUE	March 20, 2006	DATE EFFECTIVE	Service rendered on and priet Howh 30, 12006
ISSUED BY	E.K. WAGNER		DRY SERVICES EDANKERDT KENTICKY
	NAME	TITLE	57800

Issued by authority of an Order by the Public Service Commission in Case No. 2003-00341 dated Market Market 12000 Director

ORIGINAL SHEET NO. 26-2 CANCELING SHEET NO. 26-2

PSC ELECTRIC NO. 8

TARIFF N.U.G. (Cont'd) (Non-Utility Generator)

STARTUP POWER SERVICE, (cont'd)

Upon receipt of a request from the Customer for Startup Power Service under the terms of this tariff, the Company will provide the Customer a written offer containing the Notification Requirement, generation rates (including demand and energy charges) and related terms and conditions of service under which service will be provided by the Company. Such offer shall be based upon the Startup Contract Capacity, Startup Duration, Startup Frequency, and Other Startup Characteristics as specified by the customer. In no event shall the generation rates be less than the sum of the Tariff C.I.P.-T.O.D. Energy Charge, the Fuel Adjustment Clause, the System Sales clause, the Experimental Demand-Side Management Adjustment Clause, the Net Merger Savings Credit, Environmental Surcharge and the Capacity Charge.

If the parties reach an agreement based upon the offer provided to the customer by the Company, a contract shall be executed that provides full disclosure of all rates, terms and conditions of service under this tariff, and any and all agreements related thereto.

Monthly Transmission and Distribution Rates

Service Voltage

Subtransmission Transmission Tariff Code 392 393

Reservation Charge per kW

\$4.16

\$2.31

Reactive Dernand Charge for each kiloVAR of maximum leading or lagging reactive demand in excess of 50% of the KW of monthly metered demand ... \$ 0.67 per KVAR



Delayed Payment Charge

This Tariff is net if account is paid in full within 15 days of date of bill. On all accounts not so paid, an additional charge of 5% of the unpaid balance will be made.

Monthly Billing Demand

The monthly billing demand in kW shall be taken each month as the highest single 15-minute integrated peak in kW as registered by a demand meter or indicator, less the Station Contract Capacity. The monthly billing demand so established shall in no event be less than the greater of (a) the Startup Contract Capacity or b) the customer's highest previously established monthly billing demand during the past 11 months.

Monthly Billing Energy

DATE OF ISSUE

Interval billing energy shall be measured each 15-minute interval of the month as the total KWH registered by an energy meter or meters less the quotient of the Station Contract Capacity and four (4). In no event shall the interval billing energy be less than zero (0). Monthly billing energy shall be the sum of the interval billing energy for all intervals of the billing month.

(Cont'd on Sheet 26-3)

PUBLIC SERVICE COMMISSION OF KENTUCKY

EFFECTIVE 3/30/2006

PURSUANT TO 807 KAR 5:011

SECTION 9 (1) DATE EFFECTIVE Service rendered on and after March 30, 2006

March 20, 2006 DIRECTOR OF REGULATORY AFF. ISSUED BY

TITLE

Executive Director

Issued by authority of an Order of the Public Service Commission in Case No. 2005-00341 dated March 14, 2006

By

KENTUCKY POWER COMPANY

Original Sheet No. 26-3
Canceling Sheet No. 26-3

P.S.C. ELECTRIC NO 8

TARIFF N.U.G. (Cont'd) (Non-Utility Generator)

TRANSMISSION SERVICE.

Transmission Provider - The entity providing transmission service to customers in the Company's service territory. Such entity may be the Company or a regional transmission entity.

Prior to taking service under this tariff, the Customer must have a fully executed Interconnection and Operation Agreement with the Company and/or the Transmission Provider or an unexecuted agreement filed with the Federal Energy Regulatory Commission under applicable procedures.

Should the Transmission Provider implement charges for Transmission Congestion, the Company shall provide 30 days written notice to the customer. Upon the expiration of such notice period, should the customer's use of Startup Power result in any charges for Transmission Congestion from the Transmission Provider, such charges, including any applicable taxes or assessments, shall be paid by or passed through to the customer without markup. Transmission Congestion is the condition that exists when market participants seek to dispatch in a pattern that would result in power flows that cannot be physically accommodated by the system.

TERM OF CONTRACT.

Contracts under this tariff will be made for an initial period of not less than one year and shall remain in effect thereafter until either party shall give at least 6 months' written notice to the other of the intention to terminate the contract. The Company reserves the right to require initial contracts for periods greater than one year.

A new initial contract period will not be required for existing customers who change their contract requirements after the original initial period unless new or additional facilities are required.

The Company may not be required to supply capacity in excess of that contracted for except by mutual agreement. Contracts will be made in multiples of 100 kW.

SPECIAL TERMS AND CONDITIONS.

This tariff is subject to the Company's Terms and Conditions of Service.

This tariff shall not obligate the Company to purchase or pay for any capacity or energy produced by the Customer's generator.

Customers desiring to provide Startup and Station Power from commonly owned generation facilities that are not located on the site of the customer's generator (remote self-supply), shall take service under the terms and conditions contained within the applicable Open Access Transmission Tariff as filed with and accepted by the Federal Energy Regulatory Commission.

PUBLIC SERVICE COMMISSION OF KENTUCKY

JUN 2 9 2010

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SERVICE COMMISSION

3/30/2006

DATE OF ISSUE March 20, 2006 DATE EFFECTIVE Service rendered on and after March 20, 2006

EK Wogner

ISSUED BY E.K. WAGNER DIRECTOR OF REGULATORY SERVICES FRANKFORT KENTLICKY
NAME TITLE

Issued by authority of an Order of the Public Service Commission in Case No. 2001 - 00341 dated Marga dated

KPSC Case No. 2017-00472 Riverside's First Set of Data Requests Dated May 18, 2018 Item No. 7 Page 7 of 15

KENTUCKY POWER COMPANY



Original Sheet No. 26-1 Canceling_ Sheet No. 26-1

P.S.C. ELECTRIC NO. 9

TARIFF N.U.G. (Non-Utility Generator)

AVAILABILITY OF SERVICE.

This tariff is applicable to customers with generation facilities which have a total design capacity of over 1,000 kW that intend to schedule, deliver and sell the net electric output of the facility at wholesale, and who require Commissioning Power, Startup Power and/or Station Power service from the Company

Service to any load that is electrically isolated from the Customer's generator shall be separately metered and provided in accordance with the generally available demand-metered tariff appropriate for such service to the Customer.

This tariff is not available for standby, backup, maintenance, or supplemental service for wholesale or retail loads served by customer's generator.

DEFINITIONS.

- Commissioning Power The electrical energy and capacity supplied to the customer prior to the commercial operation of the customer's generator, including initial construction and testing phases.
- Station Power The electrical energy and capacity supplied to the customer to serve the auxiliary loads at the customer's generation facilities, usually when the customer's generator is not operating. Station Power does not include Startup Power.
- Startup Power The electrical energy and capacity supplied to the customer following a planned or forced untage of the customer's generator for the purpose of returning the customer's generator to synchronous operation

COMMISSIONING POWER SERVICE.

Customers requiring Commissioning Power shall take service under Tariff T.S. or by special agreement with the Company,

The Customer shall coordinate its construction and testing with the Company to ensure that the customer's operations do not cause any undue interference with the Company's obligations to provide service to its other customers or impose a burden on the Company's system or any system interconnected with the Company.

STATION POWER SERVICE.

Customers requiring Station Power shall take service under the generally available demand-metered tariff appropriate for the customer's Station Power requirements.

Station Contract Capacity - The Customer shall contract for a definite amount of electrical capacity in kW sufficient to meet the maximum Station Power requirements that the Company is expected to supply under the generally available demandmetered tariff appropriate for the customer.

STARTUP POWER SERVICE.

Customers requiring Startup Power have the option of contracting for such service under the terms of this tariff or under the generally available demand-metered tariff appropriate for the customer's Startup Power requirements.

Startup Contract Capacity - The Customer shall contract for a definite amount of electrical capacity in kW sufficient to meet the maximum Startup Power requirements that the Company is expected to supply.

Startup Duration - The Customer shall contract for a definite number of hours sufficient to meet the maximum period of time for which the Company is expected to supply Startup Power.

Startup Frequency - The Customer shall contract for a definite number of startup events sufficient to meet the maximum number of times per year that the Company is expected to supply Startup Power

Other Startup Characteristics - The customer shall provide to the Company other information regarding the customer's Startup Power requirements, including, but not limited to, anticipated time-of-use and seasonal characteristics

Notification Requirement - Whenever Startup Power is needed, the Customer shall provide adva ERVICE COMMISSION (Cont'd on Sheet No. 26-2) JEFF R. DEROUEN EXECUTIVE DIRECTOR DATE EFFECTIVE _Service rendered on and after Tune 29 2010 DATE OF ISSUE July 16, 2010 FRANKFORT. DIRECTOR OF REGULATORY SERVICES ISSUED BY TITLE ADDRE Issued by authority of an Order by the Public Service Commission in Case No. 2009-04459 dated June 28. \$\textit{BIQ9/2010}

PURSUANT TO 807 KAR 5:011 SECTION 9 (1)

KPSC Case No. 2017-00472 Riverside's First Set of Data Requests Dated May 18, 2018 Item No. 7 Page 8 of 15

KENTUCKY POWER COMPANY



Canceling

Original Sheet No. 26-2 Sheet No. 26-2

PSC ELECTRIC NO. 9

TARIFF N.U.G. (Cont'd) (Non-Utility Generator)

STARTUP POWER SERVICE. (cont'd)

Upon receipt of a request from the Customer for Startup Power Service under the terms of this tariff, the Company will provide the Customer a written offer containing the Notification Requirement, generation rates (including demand and energy charges) and related terms and conditions of service under which service will be provided by the Company. Such offer shall be based upon the Startup Contract Capacity, Startup Duration, Startup Frequency, and Other Startup Characteristics as specified by the customer. In no event shall the generation rates be less than the sum of the Tariff C.E.P.-F.O.D. Energy Charge, the Fuel Adjustment Clause, the System Sales clause, the Demand-Side Management Adjustment Clause, Environmental Surcharge and the Capacity Charge.

(T)

If the parties reach an agreement based upon the offer provided to the customer by the Company, a contract shall be executed that provides full disclosure of all rates, terms and conditions of service under this tariff, and any and all agreements related thereto.

Monthly Transmission and Distribution Rates

Service Voltage

Tariff Code	Subtransmission 392	<u>Transmission</u> <u>393</u>	
Reservation Charge per kW	\$3.65	\$2.30	(R)
Reactive Demand Charge for each	th kiloVAR of maximum		

Reactive Demand Charge for each kiloVAR of maximum leading or lagging reactive demand in excess of 50% of the KW of monthly metered demand... \$0.69 per KVAR

(I)

DELAYED PAYMENT CHARGE.

This tariff is due and payable in full on or before the due date stated on the bill. On all accounts not so paid, an additional charge of 5% of the unpaid balance will be made.

(T)

MONTHLY BILLING DEMAND.

The monthly billing demand in kW shall be taken each month as the highest single 15-minute integrated peak in kW as registered by a demand meter or indicator, less the Station Contract Capacity. The monthly billing demand so established shall in no event be less than the greater of (a) the Startup Contract Capacity or b) the customer's highest previously established monthly billing demand during the past 11 months.

MONTHLY BILLING ENERGY.

Interval billing energy shall be measured each 15-minute interval of the month as the total KWH registered by an energy meter or meters less the quotient of the Station Contract Capacity and four (4). In no event shall the interval billing energy be less than zero (0). Monthly billing energy shall be the sum of the interval billing energy for all intervals of the billing month.

	(Cont'd on Sheet No. 26-3)	KENTUCKY PUBLIC SERVICE COMMISSION
		JEFF R. DEROUEN EXECUTIVE DIRECTOR
		TARIFF BRANCH
DATE OF ISSUE July 16, 2010	DATE EFFECTIVE Service rend	ered on and afte Bunt Kirtley

KPSC Case No. 2017-00472 Riverside's First Set of Data Requests Dated May 18, 2018 Item No. 7 Page 9 of 15

KENTUCKY POWER COMPANY



Original Sheet No. 26-3
Canceling Sheet No. 26-3

P.S.C. ELECTRIC NO. 9

KENTUCKY
PUBLIC SERVICE COMMISSION

PURSUANT TO 807 KAR 5:011 SECTION 9 (1)

TARIFF N.U.G. (Cont'd) (Non-Utility Generator)

TRANSMISSION SERVICE.

Transmission Provider - The entity providing transmission service to customers in the Company's service territory. Such entity may be the Company or a regional transmission entity.

Prior to taking service under this tariff, the Customer must have a fully executed Interconnection and Operation Agreement with the Company and/or the Transmission Provider or an unexecuted agreement filed with the Federal Energy Regulatory Commission under applicable procedures.

Should the Transmission Provider implement charges for Transmission Congestion, the Company shall provide 30 days written notice to the customer. Upon the expiration of such notice period, should the customer's use of Startup Power result in any charges for Transmission Congestion from the Transmission Provider, such charges, including any applicable taxes or assessments, shall be paid by or passed through to the customer without markup. Transmission Congestion is the condition that exists when market participants seek to dispatch in a pattern that would result in power flows that cannot be physically accommodated by the system.

TERM OF CONTRACT.

Contracts under this tariff will be made for an initial period of not less than one year and shall remain in effect thereafter until either party shall give at least 6 months' written notice to the other of the intention to terminate the contract. The Company reserves the right to require initial contracts for periods greater than one year.

A new initial contract period will not be required for existing customers who change their contract requirements after the original initial period unless new or additional facilities are required.

The Company may not be required to supply capacity in excess of that contracted for except by mutual agreement. Contracts will be made in multiples of 100 kW.

SPECIAL TERMS AND CONDITIONS.

This tariff is subject to the Company's Terms and Conditions of Service.

This tariff shall not obligate the Company to purchase or pay for any capacity or energy produced by the Customer's generator.

Customers desiring to provide Startup and Station Power from commonly owned generation facilities that are not located on the site of the customer's generator (remote self-supply), shall take service under the terms and conditions contained within the applicable Open Access Transmission Tariff as filed with and accepted by the Federal Energy Regulatory Commission.

DATE OF ISSUE July 16, 2010 DATE EFFECTIVE Service ren lered on and aft.

ISSUED BY E.K. WAGNER DIRECTOR OF REGULATORY SERVICES FRANKFOR Sunt Kulley

NAME TITLE ADDRESSEFFECTIVE

ISSUED by authority of an Order of the Public Service Commission in Case No. 2009-00459 dated June 28. 6629/2010

Page 10 of 15

TARIFF N.U.G. (Non-Utility Generator)

AVAILABILITY OF SERVICE.

This tariff is applicable to customers with generation facilities which have a total design capacity of over 1,000 kW that intends to schedule, deliver and sell the net electric output of the facility at wholesale, and who require Commissioning Power, Startup Power and/or Station Power service from the Company.

Service to any load that is electrically isolated from the Customer's generator shall be separately metered and provided in accordance with the generally available demand-metered tariff appropriate for such service to the Customer.

This tariff is not available for standby, backup, maintenance, or supplemental service for wholesale or retail loads served by customer's generator.

DEFINITIONS.

- Commissioning Power The electrical energy and capacity supplied to the customer prior to the commercial operation
 of the customer's generator, including initial construction and testing phases.
- Station Power The electrical energy and capacity supplied to the customer to serve the auxiliary loads at the
 customer's generation facilities, usually when the customer's generator is not operating. Station Power does not include
 Startup Power.
- Startup Power The electrical energy and capacity supplied to the customer following a planned or forced outage of the
 customer's generator for the purpose of returning the customer's generator to synchronous operation.

COMMISSIONING POWER SERVICE.

Customers requiring Commissioning Power shall take service under Tariff T.S, or by special agreement with the Company.

The Customer shall coordinate its construction and testing with the Company to ensure that the customer's operations do not cause any undue interference with the Company's obligations to provide service to its other customers or impose a burden on the Company's system or any system interconnected with the Company.

STATION POWER SERVICE.

Customers requiring Station Power shall take service under the generally available demand-metered tariff appropriate for the customer's Station Power requirements.

Station Contract Capacity – The Customer shall contract for a definite amount of electrical capacity in kW sufficient to meet the maximum Station Power requirements that the Company is expected to supply under the generally available demand-metered tariff appropriate for the customer.

STARTUP POWER SERVICE.

Customers requiring Startup Power have the option of contracting for such service under the terms of this tariff or under the generally available demand-metered tariff appropriate for the customer's Startup Power requirements.

Startup Contract Capacity – The Customer shall contract for a definite amount of electrical capacity in kW sufficient to meet the maximum Startup Power requirements that the Company is expected to supply.

Startup Duration – The Customer shall contract for a definite number of hours sufficient to meet the maximum period of time for which the Company is expected to supply Startup Power.

(Cont'd on Sheet No. 26-2)

DATE OF ISSUE: July 10, 2015

DATE EFFECTIVE: Service Rendered On And After June 30, 2015

ISSUED BY: JOHN A. ROGNESS III

TITLE: Director Regulatory Services

By Authority Of An Order By The Public Service Commission

In Case No. 2014-00396 Dated June 22, 2015

KENTUCKYPUBLIC SERVICE COMMISSION

JEFF R. DEROUEN EXECUTIVE DIRECTOR

TARIFF BRANCH

EFFECTIVE

6/30/2015

PURSUANT TO 807 KAR 5:011 SECTION 9 (1)

KENTUCKY POWER COMPANY

P.S.C. KY. NO. 10 ORIGINAL SHEET NO. 26-2 Item No. 7
CANCELLING P.S.C. KY. NO. 10 SHEET NO. 26-2 Page 11 of 15

TARIFF N.U.G. (Cont'd) (Non-Utility Generator)

STARTUP POWER SERVICE. (cont'd)

Startup Duration – The Customer shall contract for a definite number of hours sufficient to meet the maximum period of time for which the Company is expected to supply Startup Power.

Startup Frequency – The Customer shall contract for a definite number of startup events sufficient to meet the maximum number of times per year that the Company is expected to supply Startup Power.

Other Startup Characteristics – The customer shall provide to the Company other information regarding the customer's Startup Power requirements, including, but not limited to, anticipated time-of-use and seasonal characteristics.

Notification Requirement - Whenever Startup Power is needed, the Customer shall provide advance notice to the Company.

Upon receipt of a request from the Customer for Startup Power Service under the terms of this tariff, the Company will provide the Customer a written offer containing the Notification Requirement, generation, transmission and distribution rates (including demand and energy charges) and related terms and conditions of service under which service will be provided by the Company. Such offer shall be based upon the Startup Contract Capacity, Startup Duration, Startup Frequency, and Other Startup Characteristics as specified by the customer. In no event shall the rates be less than the sum of the Tariff I.G.S. Energy Charge, the Fuel Adjustment Clause, the System Sales Clause, the Demand-Side Management Adjustment Clause, Asset Transfer Rider, Big Sandy Retirement Rider, Big Sandy 1 Operation Rider, Purchase Power Rider, KY Economic Development Surcharge, Environmental Surcharge, and the Capacity Charge.

If the parties reach an agreement based upon the offer provided to the customer by the Company, a contract shall be executed that provides full disclosure of all rates, terms and conditions of service under this tariff, and any and all agreements related thereto.

DELAYED PAYMENT CHARGE.

This tariff is due and payable in full on or before the due date stated on the bill. On all accounts not so paid, an additional charge of 5% of the unpaid balance will be made.

DATE OF ISSUE: July 10, 2015

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By Authority Of an Order of the Public Service Commission

In Case No. 2014-00396 Dated June 22, 2015

KENTUCKY
PUBLIC SERVICE COMMISSION

JEFF R. DEROUEN EXECUTIVE DIRECTOR

TARIFF BRANCH

EFFECTIVE

6/30/2015

PURSUANT TO 807 KAR 5:011 SECTION 9 (1)

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KENTUCKY POWER COMPANY

P.S.C. KY. NO. 10 ORIGINAL SHEET NO. 26-3 CANCELLING P.S.C. KY. NO. 10 SHEET NO. 26-3

TARIFF N.U.G. (Cont'd) (Non-Utility Generator)

MONTHLY BILLING DEMAND.

The monthly billing demand in kW shall be taken each month as the highest single 15-minute integrated peak in kW as registered by a demand meter or indicator, less the Station Contract Capacity. The monthly billing demand so established shall in no event be less than the greater of (a) the Startup Contract Capacity or b) the customer's highest previously established monthly billing demand during the past 11 months.

MONTHLY BILLING ENERGY.

Interval billing energy shall be measured each 15-minute interval of the month as the total KWH registered by an energy meter or meters less the quotient of the Station Contract Capacity and four (4). In no event shall the interval billing energy be less than zero (0). Monthly billing energy shall be the sum of the interval billing energy for all intervals of the billing month.

TRANSMISSION SERVICE.

Transmission Provider – The entity providing transmission service to customers in the Company's service territory. Such entity may be the Company or a regional transmission entity.

Prior to taking service under this tariff, the Customer must have a fully executed Interconnection and Operation Agreement with the Company and/or the Transmission Provider or an unexecuted agreement filed with the Federal Energy Regulatory Commission under applicable procedures.

Should the Transmission Provider implement charges for Transmission Congestion, the Company shall provide 30 days written notice to the customer. Upon the expiration of such notice period, should the customer's use of Startup Power result in any charges for Transmission Congestion from the Transmission Provider, such charges, including any applicable taxes or assessments, shall be paid by or passed through to the customer without markup. Transmission Congestion is the condition that exists when market participants seek to dispatch in a pattern that would result in power flows that cannot be physically accommodated by the system.

TERM OF CONTRACT.

Contracts under this tariff will be made for an initial period of not less than one year and shall remain in effect thereafter until either party shall give at least 6 months' written notice to the other of the intention to terminate the contract. The Company reserves the right to require initial contracts for periods greater than one year.

A new initial contract period will not be required for existing customers who change their contract requirements after the original initial period unless new or additional facilities are required.

The Company may not be required to supply capacity in excess of that contracted for except by mutual agreement. Contracts will be made in multiples of 100 kW.

SPECIAL TERMS AND CONDITIONS.

This tariff is subject to the Company's Terms and Conditions of Service.

This tariff shall not obligate the Company to purchase or pay for any capacity or energy produced by the Customer's generator.

Customers desiring to provide Startup and Station Power from commonly owned generation facilities that are not located on the site of the customer's generator (remote self-supply), shall take service under the terms and conditions contained within the applicable Open Access Transmission Tariff as filed with and accepted by the Federal Energy Regulatory Commission.

DATE OF ISSUE: July 10, 2015

DATE EFFECTIVE: Service Rendered On And After June 30, 2015

ISSUED BY: JOHN A. ROGNESS III

TITLE: Director Regulatory Services

By Authority Of Order By The Public Service Commission

In Case No. 2014-00396 Dated June 22, 2015

PUBLIC SERVICE COMMISSION

JEFF R. DEROUEN EXECUTIVE DIRECTOR

TARIFF BRANCH

EFFECTIVE

6/30/2015

PURSUANT TO 807 KAR 5:011 SECTION 9 (1)

TARIFF N.U.G. (Non-Utility Generator)

AVAILABILITY OF SERVICE.

This tariff is applicable to customers with generation facilities which have a total design capacity of over 1,000 kW that intends to schedule, deliver and sell the net electric output of the facility at wholesale, and who require Commissioning Power, Startup Power and/or Station Power service from the Company.

Service to any load that is electrically isolated from the Customer's generator shall be separately metered and provided in accordance with the generally available demand-metered tariff appropriate for such service to the Customer.

This tariff is not available for standby, backup, maintenance, or supplemental service for wholesale or retail loads served by customer's generator.

DEFINITIONS.

- Commissioning Power The electrical energy and capacity supplied to the customer prior to the
 operation of the customer's generator, including initial construction and testing phases.
- Station Power The electrical energy and capacity supplied to the customer to serve the auxiliary loads at the
 customer's generation facilities, usually when the customer's generator is not operating. Station Power does not
 include Startup Power.
- Startup Power The electrical energy and capacity supplied to the customer following a planned or forced outage
 of the customer's generator for the purpose of returning the customer's generator to synchronous operation.

COMMISSIONING POWER SERVICE.

Customers requiring Commissioning Power shall take service under Tariff T.S. or by special agreement with the Company.

The Customer shall coordinate its construction and testing with the Company to ensure that the customer's operations do not cause any undue interference with the Company's obligations to provide service to its other customers or impose a burden on the Company's system or any system interconnected with the Company.

STATION POWER SERVICE.

Customers requiring Station Power shall take service under the generally available demand-metered tariff appropriate for the customer's Station Power requirements.

Station Contract Capacity — The Customer shall contract for a definite amount of electrical capacity in kW sufficient to meet the maximum Station Power requirements that the Company is expected to supply under the generally available demand-metered tariff appropriate for the customer.

STARTUP POWER SERVICE.

Customers requiring Startup Power have the option of contracting for such service under the terms of this tariff or under the generally available demand-metered tariff appropriate for the customer's Startup Power requirements.

Startup Contract Capacity – The Customer shall contract for a definite amount of electrical capacity in kW sufficient to meet the maximum Startup Power requirements that the Company is expected to supply.

Startup Duration – The Customer shall contract for a definite number of hours sufficient to meet the maximum period of time for which the Company is expected to supply Startup Power.

(Cont'd on Sheet No. 26-2)

DATE OF ISSUE: February 7, 2018


DATE EFFECTIVE: Service Rendered On And After January 19, 2018

ISSUED BY: /s/ Ranie K. Wohnhas

TITLE: Managing Director, Regulatory & Finance

By Authority Of an Order of the Public Service Commission

In Case No. 2017-00179 Dated January 18, 2018

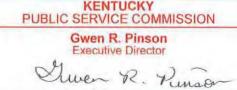

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1/19/2018

PURSUANT TO 807 KAR 5:011 SECTION 9 (1)

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TARIFF N.U.G. (Cont'd) (Non-Utility Generator)

STARTUP POWER SERVICE. (cont'd)

Startup Duration – The Customer shall contract for a definite number of hours sufficient to meet the maximum period of time for which the Company is expected to supply Startup Power.

Startup Frequency – The Customer shall contract for a definite number of startup events sufficient to meet the maximum number of times per year that the Company is expected to supply Startup Power.

Other Startup Characteristics – The customer shall provide to the Company other information regarding the customer's Startup Power requirements, including, but not limited to, anticipated time-of-use and seasonal characteristics.

Notification Requirement - Whenever Startup Power is needed, the Customer shall provide advance notice to the Company.

Upon receipt of a request from the Customer for Startup Power Service under the terms of this tariff, the Company will provide the Customer a written offer containing the Notification Requirement, generation, transmission and distribution rates (including demand and energy charges) and related terms and conditions of service under which service will be provided by the Company. Such offer shall be based upon the Startup Contract Capacity, Startup Duration, Startup Frequency, and Other Startup Characteristics as specified by the customer. In no event shall the rates be less than the sum of the Tariff I.G.S. Energy Charge, the Fuel Adjustment Clause, the System Sales Clause, the Demand-Side Management Adjustment Clause, Decommissioning Rider, Purchase Power Adjustment, KY Economic Development Surcharge, Environmental Surcharge, and the Capacity Charge.

If the parties reach an agreement based upon the offer provided to the customer by the Company, a contract shall be executed that provides full disclosure of all rates, terms and conditions of service under this tariff, and any and all agreements related thereto.

DELAYED PAYMENT CHARGE.

This tariff is due and payable in full on or before the due date stated on the bill. On all accounts not so paid, an additional charge of 5% of the unpaid balance will be made.

(Cont'd on Sheet No. 26-3)

DATE OF ISSUE: February 7, 2018

DATE EFFECTIVE: Service Rendered On And After January 19, 2018

ISSUED BY: /s/ Ranie K. Wohnhas

TITLE: Managing Director, Regulatory & Finance

By Authority Of an Order of the Public Service Commission

In Case No. 2017-00179 Dated January 18, 2018



CANCELLING P.S.C. KY, NO. 10 ORIGINAL SHEET NO. 26-Page 15 of 15

TARIFF N.U.G. (Cont'd) (Non-Utility Generator)

MONTHLY BILLING DEMAND.

The monthly billing demand in kW shall be taken each month as the highest single 15-minute integrated peak in kW as registered by a demand meter or indicator, less the Station Contract Capacity. The monthly billing demand so established shall in no event be less than the greater of (a) the Startup Contract Capacity or b) the customer's highest previously established monthly billing demand during the past 11 months.

MONTHLY BILLING ENERGY.

Interval billing energy shall be measured each 15-minute interval of the month as the total KWH registered by an energy meter or meters less the quotient of the Station Contract Capacity and four (4). In no event shall the interval billing energy be less than zero (0). Monthly billing energy shall be the sum of the interval billing energy for all intervals of the billing month,

TRANSMISSION SERVICE.

Transmission Provider - The entity providing transmission service to customers in the Company's service territory. Such entity may be the Company or a regional transmission entity.

Prior to taking service under this tariff, the Customer must have a fully executed Interconnection and Operation Agreement with the Company and/or the Transmission Provider or an unexecuted agreement filed with the Federal Energy Regulatory Commission under applicable procedures.

Should the customer's use of Startup Power result in any charges for Transmission Congestion from the Transmission Provider, such charges, including any applicable taxes or assessments, shall be paid by or passed through to the customer without markup. Transmission Congestion is the condition that exists when market participants seek to dispatch in a pattern that would result in power flows that cannot be physically accommodated by the system.

TERM OF CONTRACT.

Contracts under this tariff will be made for an initial period of not less than one year and shall remain in effect thereafter until either party shall give at least 6 months' written notice to the other of the intention to terminate the contract. The Company reserves the right to require initial contracts for periods greater than one year.

A new initial contract period will not be required for existing customers who change their contract requirements after the original initial period unless new or additional facilities are required.

The Company may not be required to supply capacity in excess of that contracted for except by mutual agreement. Contracts will be made in multiples of 100 kW.

SPECIAL TERMS AND CONDITIONS.

This tariff is subject to the Company's Terms and Conditions of Service.

This tariff shall not obligate the Company to purchase or pay for any capacity or energy produced by the Customer's generator.

Customers desiring to provide Startup and Station Power from other generation facilities, owned by the same individual business entity that are not located on the site of the customer's generator (remote self-supply), shall take service under the terms and conditions contained within the applicable Open Access Transmission Tariff as filed with and accepted by the Federal Energy Regulatory

Commission.

DATE OF ISSUE: February 7, 2018

DATE EFFECTIVE: Service Rendered On And After January 19, 2018

ISSUED BY: /s/ Ranie K. Wohnhas

TITLE: Managing Director, Regulatory & Finance

By Authority Of an Order of the Public Service Commission

In Case No. 2017-00179 Dated January 18, 2018

T T

KENTUCKY PUBLIC SERVICE COMMISSION

> Gwen R. Pinson **Executive Director**

> > **EFFECTIVE**

1/19/2018

PURSUANT TO 807 KAR 5:011 SECTION 9 (1)

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DATA REQUEST

8

Refer to Tariff N.U.G., and specifically its opening sentence which reads, "[t]his tariff is applicable to customers with generation facilities which have a total design capacity of over 1,000 kW that intends to schedule, deliver and sell the net electric output of the facility at wholesale, and who require Commissioning Power, Startup Power and/or Station Power service from the Company." What does Kentucky Power mean by "net electric output"?

RESPONSE

"Net Electric Output" means the power generated in excess of power consumed during the generation process. Net electric output does not include power consumed when not generating.

DATA REQUEST

9 When did Kentucky Power join PJM Interconnection, L.L.C. ("PJM")?

RESPONSE

October 1, 2004.

DATA REQUEST

Does Kentucky Power's tariff conflict with or differ from PJM's Open

Access Transmission Tariff ("OATT") with respect to the netting of

station and start-up power? Explain in detail.

RESPONSE

Yes. Tariff N.U.G. differs from the PJM OATT. The PJM OATT does not govern retail service. Kentucky Power is a Kentucky utility providing retail service in the Commonwealth.

DATA REQUEST

Please provide a copy of all records which reflect any challenge

Kentucky Power has considered or made to the reasonableness of PJM's

OATT self-supply provisions.

RESPONSE

Kentucky Power objects to this request to the extent it seeks documents or information protected by the attorney-client privilege or the attorney work product doctrine. Without waiving these objections, Kentucky Power states it has no records responsive to this request. Kentucky Power further states that it has not filed a complaint at FERC regarding the reasonableness of PJM's OATT self-supply provisions.

DATA REQUEST

For each of the three (3) most recent calendar years, provide by month:

(a) the amount of money paid by Riverside to Kentucky Power for retail,

wholesale, transmission, or any other service or good; and

(b) the amount of money Kentucky Power was paid for transmitting the

power generated by Riverside and sold into PJM.

RESPONSE

(a) See KPCO_R_Riverside_1_12_Redacted_Attachment1.pdf for Riverside's payments to Kentucky Power from 2015-2018.

(b) Kentucky Power is not paid for transmitting the power generated by Riverside. Kentucky Power's transmission revenue does not depend on and is not affected by whether Riverside generates or sells power into PJM, or by how much power Riverside generates or sells.

2018	13-Apr	98,172.46-
2018	14-Mar	97,826.31-
2018	21-Feb	1,975.87-
2018	13-Feb	87,733.79-
2018	9-Jan	81,582.59-
2017	21-Dec	128,565.77-
2017	21-Nov	82,069.33-
2017	21-Dec	128,565.77-
2017	21-Nov	82,069.33-
2017	13-Oct	97,774.61-
2017	22-Sep	89,942.24-
2017	17-Aug	90,836.91-
2017	3-Aug	109,388.98-
2017	20-Jun	83,783.82-
2017	17-May	81,453.40-
2017	18-Apr	82,514.43-
2017	20-Mar	82,528.14-
2017	21-Feb	83,370.81-
2017	20-Jan	84,586.56-
2016	21-Dec	82,205.61-
2016	28-Nov	
2016	20-Oct	
2016	12-Sep	
2016	12-Aug	
2016	28-Jul	
2016	21-Jun	
2016	20-May	
2016	18-Apr	
2016	16-Mar	
2016	11-Feb	
2016	19-Jan	
2015	17-Dec	
2015	12-Nov	
2015	9-Oct	
2015	11-Sep	
2015	11-Aug	
2015	23-Jul	
2015	16-Jun	
2015	15-May	
2015	17-Apr	
2015	16-Mar	
2015	17-Feb	
2015	13-Jan	

DATA REQUEST

13 Refer to the Wohnhas Testimony, page 8, wherein Mr. Wohnhas

discusses metering at the Zelda and Foothills sites. Explain in detail any netting of usage and generation that occurs and the basis for same.

RESPONSE

Activity at the Zelda and Foothills portions of the Riverside site is captured for each portion of the facility through the use of two meters (one for the Foothills portion and one for the Zelda portion). Each meter measures both inflows (usage) and outflows (generation) which is accumulated and billed for each meter in 15 minute increments. In real time any generation measured by the meter first offsets usage before outflow is registered on the same meter. Please also refer to the Company response to Riverside 1-8.

DATA REQUEST

14

Refer to Tariff N.U.G., and specifically the sentence therein, "[u]pon receipt of a request from the Customer for Startup Power Service under the terms of this tariff, the Company will provide the Customer a written offer containing the Notification Requirement, generation, transmission and distribution rates (including demand and energy charges) and related terms and conditions of service under which service will be provided by the Company."

- (a) Explain in detail the process by which Kentucky Power creates a written offer.
- (b) Explain whether Kentucky Power has ever provided Riverside a written offer.
- (c) Provide a sample written offer based on the historical operations at the Zelda and Foothills sites and such other reasonable assumptions as necessary (and identify each such assumption).

RESPONSE

- (a) The quoted tariff provision applies only to request for Start-up Power Service. Kentucky Power creates a written offer under Tariff N.U.G. in response to a request by an eligible customer requesting special Startup Power service under Tariff N.U.G. instead of service under the generally available demand-metered tariff appropriate for such service. It is important to note that the written offer only applies to Start-Up Power.
- (b) Yes. Please see, for example, KPCO_R_Riverside_1_3_Attachment1.pdf at pages 48-52. Unless otherwise agreed in conformity with Tariff N.U.G., Startup Power Service is provided under the generally available demand metered tariff appropriate for such service.
- (c) Please see responses to (a) and (b). Kentucky Power objects to this request to the extent it purports to require the Company to create a hypothetical offer to Riverside based on Riverside's historical operations when such operations do not qualify for remote self-supply.

DATA REQUEST

15

Refer to the Wohnhas Testimony, page 18, wherein Mr. Wohnhas states as follows: "[f]inally, if the Commission were to conclude that the remote self-supply provision of Tariff N.U.G. should be interpreted as Riverside urges, and it should not, the remote self-supply provision of Tariff N.U.G. should be eliminated to eliminate any free-riding by Riverside and thereby protect the interests of the other Kentucky Power customers."

- (a) Is it Kentucky Power's position that the remote self-supply provision of its Tariff N.U.G. is only acceptable so long as no generator-customer seeks to proceed in accordance with its terms?
- (b) How is the so-called "remote self-supply provision" of Tariff N.U.G. supposed to work? Stated another way, assume a customer-generator is indisputably in compliance with the special terms and conditions of Tariff N.U.G.; explain in detail the service provided by Kentucky Power to that customer-generator, the amounts Kentucky Power would expect to be paid, any agreements that would be advisable or necessary involving the customer-generator and Kentucky Power, and any other relevant information.

RESPONSE

- (a) No.
- (b) The "remote self-supply provision" details are as stated in Tariff N.U.G. The physical usage of the Kentucky Power system by Riverside would not be altered in any way. Energy Settlements for Riverside site usage would not be billed under Kentucky Power retail service, but settled via PJM processes. Kentucky Power would not receive any direct compensation. There are no additional agreements that are necessary or advisable in addition to the clear language already provided in the tariff.

Dated May 18, 2018 **Page 1 of 3**

DATA REQUEST

16

Refer to the Wohnhas Testimony, pages 3-4, wherein Mr. Wohnhas discusses Kentucky Power's amendment of Tariff N.U.G. - Non-Utility Generator ("Tariff N.U.G.") as part of Case No. 2017-00179.

- (a) Explain in detail each and every amendment made or intended to be made to Tariff N.U.G. by Kentucky Power in Case No. 2017-00179. Include the basis for and impact of each amendment, specifically describing Kentucky Power's opinion as to the meaning of the tariff both before and after amendment.
- (b) Please provide a copy of all documents arising from or relating to the Company's decision to amend Tariff N.U.G.
- (c) Please provide the date when the Company first considered amending Tariff N.U.G. and explain what caused the Company to consider an amendment.
- (d) Describe and reproduce any and all portions of the record of Case No. 2017- 00179 where Kentucky Power explained the reasoning behind, and/or impact of, its proposed amendments to Tariff N.U.G.

RESPONSE

(a) Adjustment #1

This adjustment reflected changes in various surcharges related to Tariff N.U.G. Further information can be found in Case No. 2017-00179 at Company Witness Sharp's testimony on page 30 and Company Witness Vaughan's testimony on page 6. Additional information can be found in Company Witness Wohnhas' testimony starting at the bottom of page 2.

https://psc.ky.gov/pscecf/2017-

00179/slsharp%40aep.com/06282017125401/KPCO_APP_Section_III_Testimony_Volume_4_Rogness_Ross_Sharp_Vaughan_Walsh_Wohnhas.

Notification Requirement - Whenever Startup Power is needed, the Customer shall provide advance notice to the Company. Upon receipt of a request from the Customer for Startup Power Service under the terms of this tariff, the Company will provide the Customer a written offer containing the Notification Requirement, generation, transmission and distribution rates (including demand and energy charges) and related terms and conditions of service under which service will be provided by the Company. Such offer shall be based upon the Startup Contract Capacity, Startup Duration, Startup Frequency, and Other Startup Characteristics as specified by the customer. In no event shall the rates be less than the sum of the Tariff I.G.S. Energy Charge, the Fuel Adjustment Clause, the System Sales Clause, the Demand-Side Management Adjustment Clause, Asset Transfer Charge, Big Sandy Decommissioning Retirement Rider, Big Sandy 1 Operation Rider, Purchase Power Adjustment, KY Economic Development Surcharge, Environmental Surcharge, and the Capacity Charge.

If the parties reach an agreement based upon the offer provided to the customer by the Company, a contract shall be executed that provides full disclosure of all rates, terms and conditions of service under this tariff, and any and all agreements related thereto.

Adjustment #2

This adjustment eliminated outdated language in its tariff that provided for a 30-day written notice to customers taking service under this tariff should a Transmission Provider implement charges for transmission congestion. After PJM created transmission congestion charges, the notice language relating to the creation of these charges was no longer necessary. Further information can be found in Case No. 2017-00179 at Company Witness Sharp's testimony starting on page 28 and Company Witness Vaughan's testimony on page 25.

https://psc.ky.gov/pscecf/2017-00179/slsharp%40aep.com/06282017125401/KPCO_APP_Section_III_Testimony_Volume_4_Rogness_Ross_Sharp_Vaughan_Walsh_Wohnhas.

TRANSMISSION SERVICE.

Transmission Provider - The entity providing transmission service to customers in the Company's service territory. Such entity may be the Company or a regional transmission entity.

Prior to taking service under this tariff the Customer must have a fully executed Interconnection and Operation Agreement with the Company and/or the Transmission Provider or an unexecuted agreement filed with the Federal Energy Regulatory Commission under applicable procedures.

Should the Transmission Provider implement changes for Transmission Congestion, the Company shall provide 30 days written notice to the customer. Sshould the customer's use of Startup Power result in any charges for Transmission Congestion from the Transmission Provider, such charges, including any applicable taxes or assessments, shall be paid by or passed through to the customer without markup. Transmission Congestion is the condition that exists when market participants seek to dispatch in a pattern that would result in power flows that cannot be physically accommodated by the system.

Adjustment #3

The edits were proposed to clarify the language regarding the provision of station power. Further information can be found in case No. 2017-00179 at Company Witness Sharp's testimony starting on page 28.

https://psc.ky.gov/pscecf/2017-00179/slsharp%40aep.com/06282017125401/KPCO_APP_Section_III_Testimony_Volume_4_Rogness_Ross_Sharp_Vaughan_Walsh_Wohnhas.pdf

SPECIAL TERMS AND CONDITIONS.

This tariff is subject to the Company's Terms and Conditions of Service.

This tariff shall not obligate the Company to purchase or pay for any capacity or energy produced by the Customer's generator.

Customers desiring to provide Startup and Station Power from commonly owned other generation facilities, owned by the same individual business entity that are not located on the site of the customer's generator (remote self-supply), shall take service under the terms and conditions contained within the applicable Open Access Transmission Tariff as filed with and accepted by the Federal Energy Regulatory Commission.

- (b) The Company objects to this question to the extent it seeks information and documents protected by the attorney-client privilege and the attorney work product doctrine. Without waiving this objection the Company states as follows: See the responses to subsections (a) and (c).
- (c) The Company objects to this question to the extent it seeks information and documents protected by the attorney-client privilege and the attorney work product doctrine. Without waiving this objection the Company states as follows that itconsidered amendments to its tariffs as part of its customary review of tariffs in the months preceding a rate case filing.
- (d) Please see the information publicly available on the Commission's website.

DATA REQUEST

17 Refer to the Wohnhas Testimony, pages 12-13, wherein Mr. Wohnhas

opines as to whether Riverside's Foothills generation facilities are on the same site as its Zelda generators.

(a) All else being equal, explain in detail whether and why Kentucky Power's position in this matter would be different if the Zelda and

Foothills facilities were:

i. across the street from each other;

ii. one (1) mile from each other; or

iii. fifty (50) miles from each other.

(b) Is Kentucky Power aware of technologies that allow remote operation of combustion turbines and other equipment? Does Kentucky Power or any of its affiliated entities have any remotely-operated combustion turbines or other equipment?

RESPONSE

- (a) Kentucky Power objects to this data request. The data request calls for speculation based on facts not in evidence and seeks information that is irrelevant to the matters presented in the Complaint. Without waiving this objection, the Company responds that the facts in evidence demonstrate that the Zelda and Foothills facilities are not owned by the same individual business entity and are located on a common site. Riverside is not eligible for the remote self-supply provision of Tariff N.U.G.
- (b) Yes, Kentucky Power is aware of remotely operated combustion turbines. Kentucky Power does not own, lease or operate any combustion turbines. Remote operation does not change physical location. The Company further states, affiliates of Kentucky Power are not parties to this proceeding, are not utilities subject to the jurisdiction of the Commission, and therefore information about their activities is not reasonably calculated to lead to the discovery of admissible evidence.

DATA REQUEST

18

Please explain whether Kentucky Power or any of its affiliated entities avails itself of self-supply/netting opportunities under PJM's OATT (or any other OATT or similar document) with respect to start-up and station power for owned generation resources. If so:

- (a) identify and describe the relevant generator, its location, and by whom it is owned; and
- (b) identify and describe any arrangements or agreements in place concerning the retail or wholesale rates to be paid by Kentucky Power or its affiliated entity for start-up or station power.

RESPONSE

- (a) Kentucky Power may avail itself of self-supply or netting opportunities under PJM's OATT to the extent such opportunities are available to Kentucky Power. Kentucky Power does not currently remote self-supply for the generators that it owns. Affiliates of Kentucky Power are not parties to this proceeding, are not utilities subject to the jurisdiction of the Commission, and therefore information about their activities is not reasonably calculated to lead to the discovery of admissible evidence. Moreover, station power self-supply under PJM's OATT requires common ownership of the multiple generation facilities involved, and therefore generation facilities other than those owned by Kentucky Power are not relevant to whether Kentucky Power is eligible to avail itself of self-supply or netting opportunities under PJM's OATT.
- (b) Kentucky Power does not pay retail rates for startup or station power at its plants. Any wholesale purchases for startup or station power are part of the Company's cost of providing service.

VERIFICATION

The undersigned, Ranie K. Wohnhas, being duly sworn, deposes and says he is the Managing Director of Regulatory & Finance for Kentucky Power, that he has personal knowledge of the matters set forth in the foregoing responses and the information contained therein is true and correct to the best of his information, knowledge, and belief.

		Ranie K. Wohnlas
Commonwealth of Kentucky)	Case No. 2017-00472
County of Boyd)	
Subscribed and sworn before 3 1 strain day of May, 201		a Notary Public, by Ranie K. Wohnhas this
1		

My Commission Expires 3-18-19

