COMMONWEALTH OF KENTUCKY BEFORE THE PUBLIC SERVICE COMMISSION

PUBLIC SERVICE COMMISSION

In the Matter of:

THE APPLICATION OF)
CAPITAL TELECOM HOLDINGS LLC)
AND KENTUCKY RSA NO. 1 PARTNERSHIP)
d/b/a VERIZON WIRELESS)
FOR ISSUANCE OF A CERTIFICATE OF PUBLIC) CASE NO.: 2019-00397
CONVENIENCE AND NECESSITY TO CONSTRUCT)
A WIRELESS COMMUNICATIONS FACILITY)
IN THE COMMONWEALTH OF KENTUCKY)
IN THE COUNTY OF FULTON)

SITE NAME: CRUTCHFIELD

* * * * * * *

NOTICE OF UPDATE TO WIRELESS COMMUNICATIONS FACILITY CONSTRUCTION SPECIFICATIONS INCIDENT TO REPLACEMENT OF TOWER AND FOUNDATION DAMAGES BY WESTERN KENTUCKY TORNADO

Comes Capital Telecom Holdings LLC and Kentucky RSA No. 1 Partnership, a Delaware General Partnership, d/b/a Verizon Wireless ("Applicants"), and by this filing do hereby provide Notice to the Commission of the following:

- 1. On December 20, 2019, the Commission issued an Order granting a Certificate of Public Convenience and Necessity ("CPCN") approving construction of a wireless telecommunications facility, including a tower not to exceed 300 feet in height, with attached antennas, to be located at 1311 Clinton Moscow Road, Fulton County, Kentucky.
- 2. The subject wireless telecommunications facility, including tower, was constructed in June 2020.
- 3. On December 10, 2021, the subject tower and related wireless telecommunications facility ground equipment was catastrophically damaged by an EF4

tornado that devastated a large area across western Kentucky, including the wireless telecommunications facility site location.

- 4. Because of the damage, the subject wireless telecommunications facility, including tower, will need to be replaced to restore wireless communications service to the affected area.
- 5. Accordingly, the wireless telecommunications facility will be rebuilt in compliance with the CPCN issued on December 20, 2019.
- 6. Because of significant internal damage to the concrete pedestal foundation, a new tower foundation will be necessary in order to construct a replacement tower at the site. Additionally, the tornadic event caused the existing guyed anchors to move from their original location causing the overlaying soils to collapse/settle. Because of this, the existing guyed anchor locations are unsuitable for re-use and will need to be relocated.
- 7. A site development plan and a vertical profile sketch of the replacement wireless telecommunications facility, signed and sealed by a professional engineer registered in Kentucky, depicting the tower height and the proposed configuration for Verizon Wireless' antennas are attached as **Exhibit A**. **Exhibit A** replaces and supersedes the site development plan and vertical profile sketch submitted as part of the original application.
- 8. The practical changes to the site design, including relocation of the tower foundation and guyed anchors as described above and in **Exhibit A**, are necessary to accomplish reconstruction of the facility at the site location. Such changes are *de minimus* changes, with the foundation location being adjusted by less than 20 feet. Furthermore, all replacement structures will be located on the same parcel of property that was approved as

the construction location pursuant to the CPCN.

WHEREFORE, Applicants respectfully request that the Commission accept the foregoing Notice for filing to update the subject case record for the within case.

Respectfully submitted,

David A. Pike

Pike Legal Group, PLLC

1578 Highway 44 East, Suite 6

Lavid a Relse

P. O. Box 369

Shepherdsville, KY 40165-0369

Telephone: (502) 955-4400 Telefax: (502) 543-4410 Email: dpike@pikelegal.com

Attorney for Applicants

LIST OF EXHIBITS

A - Site Development Plan:

Legal Descriptions Flood Plain Certification Site Plan Vertical Tower Profile

EXHIBIT A SITE DEVELOPMENT PLAN



820 MORRIS TURNPIKE - STE 104 SHORT HILLS, NJ 07078

NEW 295' GUYED TOWER w/5' LIGHTNING ARRESTOR **TOTAL TOWER HEIGHT 300'**

DIAMOND COMMUTATIONS SITE

FULTON, KY (CRUTCHFIELD)

ERIZON WIRELESS SITE

EV CRUTCHFIELD PROJECT#: 20151215225 MARKET ID: KY RSA 1 LOCATION CODE: 382052

911 ADDRESS

1311 CLINTON MOSCOW RD FULTON, KY 42041 FULTON COUNTY

OWER OWNER

DIAMOND COMMUTATIONS LLC CONTACT: VINCE CASIERO PHONE: (973) 544-6836 MOBILE: (973) 769-2384

ROPERTY OWNER

GRAHAM FARM LAND, LLC 1758 STATE ROUTE 781 NORTH FULTON, KY 42041 CONTACT: IFRRY GRAHAM PHONE: (270) 627-0374

2216 MYRON CORY DR # 4 HICKMAN KY 42050 PHONE: (270) 236-2545

FULTON CITY FIRE DEPARTMENT 340 BROWDER ST FULTON, KY 42041 PHONE: (270) 472-1422

GENERAL INFORMATION

LATITUDE: 36° 34' 48.41" N LONGITUDE: 88° 58' 49.13" W 1983 (NAD83) ELEVATION: 435'± AMSL 1988 (NAVD88)

DIAMOND COMMUTATIONS LLC LEASE

70'-0" x 70'-0" (4,900 SF)

PROJECT TOTAL DISTURBED AREA

(8,527 SF) = (0.20 ACRE) ACCESS DRIVE:

NOTE: ALL ITEMS WITHIN THESE CONSTRUCTION DOCUMENTS ARE BY TOWER OWNER'S GENERAL CONTRACTOR AND HIS SUB-CONTRACTORS LINIESS NOTED AS (VZW GC) WHICH SHALL INCLLIDE VERIZI RELESS GENERAL CONTRACTOR AND HIS SUB-CONTRACTORS. GENERALLY DESCRIBED BELOV

- PERMANENT ELECTRIC POWER MUST BE AVAILABLE FOR VERIZON WIRELESS AT THE METER BASE

LOCATION MAP

- INSTALL VZW ELECTRIC SERVICE CONDUCTORS FROM UTILITY H-FRAME TO VZW ILC ENCLOSURE
- INSTALL NEW OUTDOOR OVE AND CABLING H-FRAME SUPPORT
- INSTALL (2) 1-1/4" & (1) 1" INNERDUCTS WITH PULL TAPES AND TRACER WIRE WITHIN OWNER INSTALLED "VERIZON WIRELESS ONLY" FIBER OPTIC CONDUITS

US-45 BYP S/JULIAN M. CARROLL PURCHASE PKWY S, FOLLOW SIGNS FOR FULTON (0.4 MI). CONTINUE ONTO JULIAN M. CARROLL PURCHASE PKWY S/PURCHASE PKWY S (19.4 MI). TAKE EXIT 1 FOR US-51 N TOWARD FULTON/CLINTON (0.2 MI). TURN RIGHT ONTO US-51 N (SIGNS FOR CLINTON) (2.4 MI). TURN LEFT ONTO KY-94 W (3.6 MI). TURN RIGHT ONTO JEFFRESS RD (2.1 MI). TURN LEFT ONTO CLINTON

DIAMOND COMMUTATIONS LLC SCOPE:

INSTALL A NEW 299' GUVED TOWER W, 5' LIGHTNING ROD (TOTAL 300')

INSTALL A NEW TOWER FOUNDATION SYSTEM

INSTALL A NEW 68'86' FENCED GRAVEL COMPOUND

INSTALL A NEW SITE H-FRAME

INSTALL A NEW TOWER LIGHTING AND TOWER LIGHTING CONTROLLER

INSTALL A NEW OF TOWER COMPOUND TOWER LIGHTNING CONTROLLER

INSTALL A NEW OF TOWER COMPOUND TOWER LIGHTNING CONTROLLER

INSTALL A NEW SECTION.

- NO WATER OR SEWAGE SERVICES RUN TO SITE
- INSTALL NEW TOWER & SITE GROUNDING SYSTEM
- RIZON WIRELESS SCOPE (VZW GC):

 INSTALL A NEW 11'-6"x14'-9" PREFABRICATED CANOPY ON EXISTING CONCRETE PAD FOUNDATION
- INSTALL VZW ANTENNA MOUNTING SUPPORT STRUCTURE ON TOWER INSTALL VZW ANTENNA MOTEN, COAK, OF SANTENNA AND RADIO EQUIPMENT INSTALL EXISTING SUBSURFACE GROUND LEADS TO VZW EQUIPMENT & FACILITIES
- INSTALL CIRCUITS FROM VZW ILC TO VZW EQUIPMENT ENCLOSURES

MOSCOW RD (0.5 MI). SITE WILL BE LOCATED ON LEFT (SOUTH) SIDE OF ROAD.

ALL WORK AND MATERIALS SHALL BE PERFORMED AND INSTALLED IN ACCORDANCE WITH THE CURRENT EDITIONS OF THE FOLLOWING CODES AS ADOPTED BY THE LOCAL GOVERNING AUTHORITIES. NOTHING IN THESE PLANS IS TO BE CONSTRUCTED TO PERMIT

> BUILDING CODE STRUCTURAL CODE MECHANICAL CODE PLUMBING CODE LECTRICAL CODE FIRE/LIFE SAFETY CODE NERGY CODE

> > GAS CODE

2018 KENTUCKY BUILDING CODE TIA/EIA-222 - REVISION G (INCLUDES ADDENDUM #2) 2012 INTERNATIONAL MECHANICAL CODE (IMC 2012) KENTUCKY STATE PLUMBING CODE (815 KAR CHAP. 20) 2014 NATIONAL ELECTRICAL CODE (NEC) - NFPA 70 2012 INTERNATIONAL FIRE CODE (2012 IFC) 2012 INTERNATIONAL ENERGY CODE (COMMERCIAL) 2009 NATIONAL FUEL GAS CODE (NFPA 54)

ARCHITECTURAL

POWER OF DESIGN GROUP, LLC

1311 CLINTON MOSCOW ROAD **FULTON, KY 42041 FULTON COUNTY**

TENANT: KENTUCKY RSA NO. 1 PARTNERSHIP d/b/a VERIZON WIRELESS **EV CRUTCHFIELD**

FROM EVANSVILLE MTSO: 800 RUSSELL ROAD CHANDLER, IN 47610: HEAD NORTH ON RUSSELL RD TOWARD GARDNER RD (0.2 MI). TURN LEFT ONTO GARDNER RD (1.6 MI). TURN LEFT ONTO IN-62 (4.2 MI).

TURN RIGHT ONTO THE I-164 S RAMP (0.3 MI). MERGE ONTO I-69 S (8.1 MI). TAKE EXIT 0 TO MERGE ONTO US-41 S TOWARD HENDERSON KY (7.1 MI). KEEP LEFT TO STAY ON US-41 S (2.4 MI). KEEP LEFT TO

CONTINUE ON PENNYRILE PKWY, FOLLOW SIGNS FOR OWENSBORO (1.1 MI). CONTINUE ONTO I-69/PENNYRILE PKWY (1.2 MI). CONTINUE ONTO PENNYRILE PKWY (39.1 MI). CONTINUE ONTO I-69/PENNYRILE PKWY (2.2 MI). KEEP RIGHT AT THE FORK TO STAY ON 1-69, FOLLOW SIGNS FOR PADUCAH (38.4 MI). TAKE EXIT 68B FOR INTERSTATE 24 W TOWARD PADUCAH (0.3 MI). MERGE ONTO 1-24 W/1-69 S (16.5 MI). TAKE EXIT 25A FOR PURCHASE PARKWAY S TOWARD FULTON (0.4 MI). MERGE ONTO PURCHASE PKWY S (26.9 MI). CONTINUE ONTO US-45 BYP S/PURCHASE PKWY S (3.0 MI). KEEP RIGHT TO CONTINUE ON

SHEET NUMBER

FACILITY IS UNMANNED AND NOT FOR HUMAN HABITATION. HANDICAPPED ACCESS REQUIREMENTS ARE NOT REQUIRED IN ACCORDANCE WITH THE 2009 IBC BUILDING CODE

APPLICABLE CODES

SURVEYOR

POWER OF DESIGN GROUP, LLC 11490 BLUEGRASS PARKWAY LOUISVILLE, KY 40299 PHONE: (502) 437-5252

11490 BLUEGRASS PARKWAY LOUISVILLE, KY 40299 PHONE: (502) 437-5252

GIBSON ELECTRIC MEMBERSHIP COOPERATIVE (GEMC) ADDRESS: 1702 MOSCOW AVI

HICKMAN, KY 42050 CONTACT: REX COFFEY PHONE: (270) 627-3312

EMAIL: RCOFFEY@GIBSONEMC.COM

PROJECT DESCRIPTION



CONSULTANT TEAM

DESCRIPTION PROJECT INFORMATION, SITE MAPS, SHEET INDEX B-1 TO B-1.2 SITE SURVEY REVISION LOG TOWER ELEVATION TOWER ELEVATION OVERALL SITE PLAN w/AERIAL OVERLAY OVERALL SITE PLAN w/DISTANCES TO PROPERTY LINES C-1A TOWER DISTANCE TO RESIDENTIAL STRUCTURES C-1B C-2 C-3 GRADING AND E&S CONTROL PLAN DETAILED SITE PLAN DIMENSIONED SITE PLAN C-4 DETAILED EQUIPMENT PAD PLAN C-5 C-6 GENERAL SITE CONSTRUCTION NOTES **BEST MANAGEMENT PRACTICES & EROSION CONTRO** DETAILS AND NOTES SITE DETAILS FENCE DETAILS AND NOTES SITE DETAILS EQUIPMENT PAD & CANOPY ELEVATIONS (REFERENCE SITE FENCE SIGNAGE (REFERENCE ONLY) STRUCTURAL FOUNDATION PLAN AND STRUCTURAL NOTES FOUNDATION DETAILS ICE BRIDGE DETAILS ELECTRICAL OVERALL UTILITY LAYOUT SITE LITILITY PLAN EQUIPMENT PAD UTILITY PLAN & EQUIPMENT PAD TRENCH SECTIONS PANEL SCHEDULE, ONE LINE DIAGRAM, ELECTRICAL NOTES AND DETAILS ELECTRICAL DETAILS OVP & ILC H-FRAME ELEVATIONS AND DETAILS **EQUIPMENT CABINET ELEVATIONS EQUIPMENT PAD LIGHTING PLAN** GROUNDING SITE PLAN GROUNDING NOTES G-1 G-2 G-3 VERIZON WIRELESS GROUNDING PLAN AND NOTES **GROUNDING DETAILS GROUNDING DETAILS** G-6 GROUNDING DETAILS REFERENCE DRAWINGS ANTENNA PLAN AND DETAILS (REFERENCE ONLY) TOWER (BY OTHERS) TOWER DETAILS (REFERENCE ONLY) TOWER DETAILS (REFERENCE ONLY) TOWER DETAILS (REFERENCE ONLY)

FULTON, KY (CRUTCHFIELD)



820 MORRIS TURNPIKE - STE 104 SHORT HILLS, NJ 07078

02/22/2022



CONSTRUCTION **DRAWINGS**

REV.	DATE	DESCRIPTION		
0	2.16.17	ISSUED AS FINAL		
1	3.1.18	UPDATED RFDS		
2	1.31.20	UPDATED STANDARDS		
3	1.21.22	TOWER REPLACEMENT		
4	2.21.22	CORRECTED COORDS		
SITE INFORMATION:				

FULTON, KY (CRUTCHFIELD) 1311 CLINTON MOSCOW RD

FULTON, KY 42041 FULTON COUNTY MOND COMMUNICATIONS SITE NUMB

KY007 VERIZON WIRELESS SITE NAME EV CRUTCHFIELD

POD NUMBER 21-118223


DRAWN BY POD CHECKED BY 01.17.17

SHEET TITLE:

PROJECT INFORMATION, SITE MAPS. SHEET INDEX REFERENCE ONLY





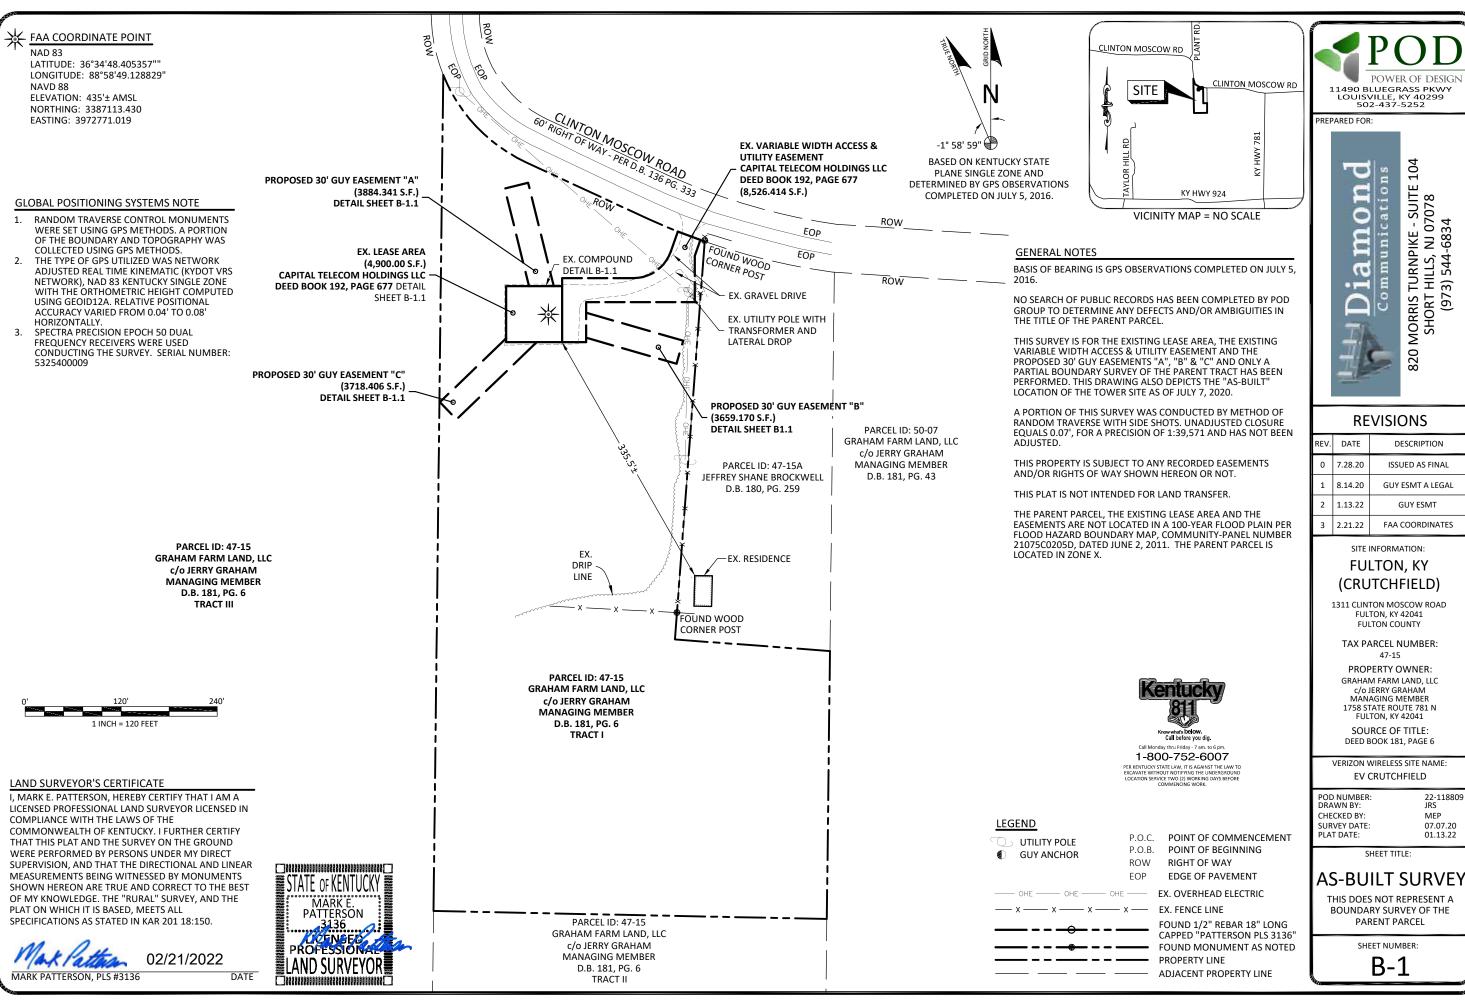

POWER OF DESIGN

104

MORRIS TURNPIKE - SUITE SHORT HILLS, NJ 07078 (973) 544-6834

820

DESCRIPTION

ISSUED AS FINAL

GUY ESMT A LEGAL

GUY ESMT

FAA COORDINATES

22-118809 JRS


07.07.20 01.13.22

MEP

47-15

SHEET TITLE:

B-1

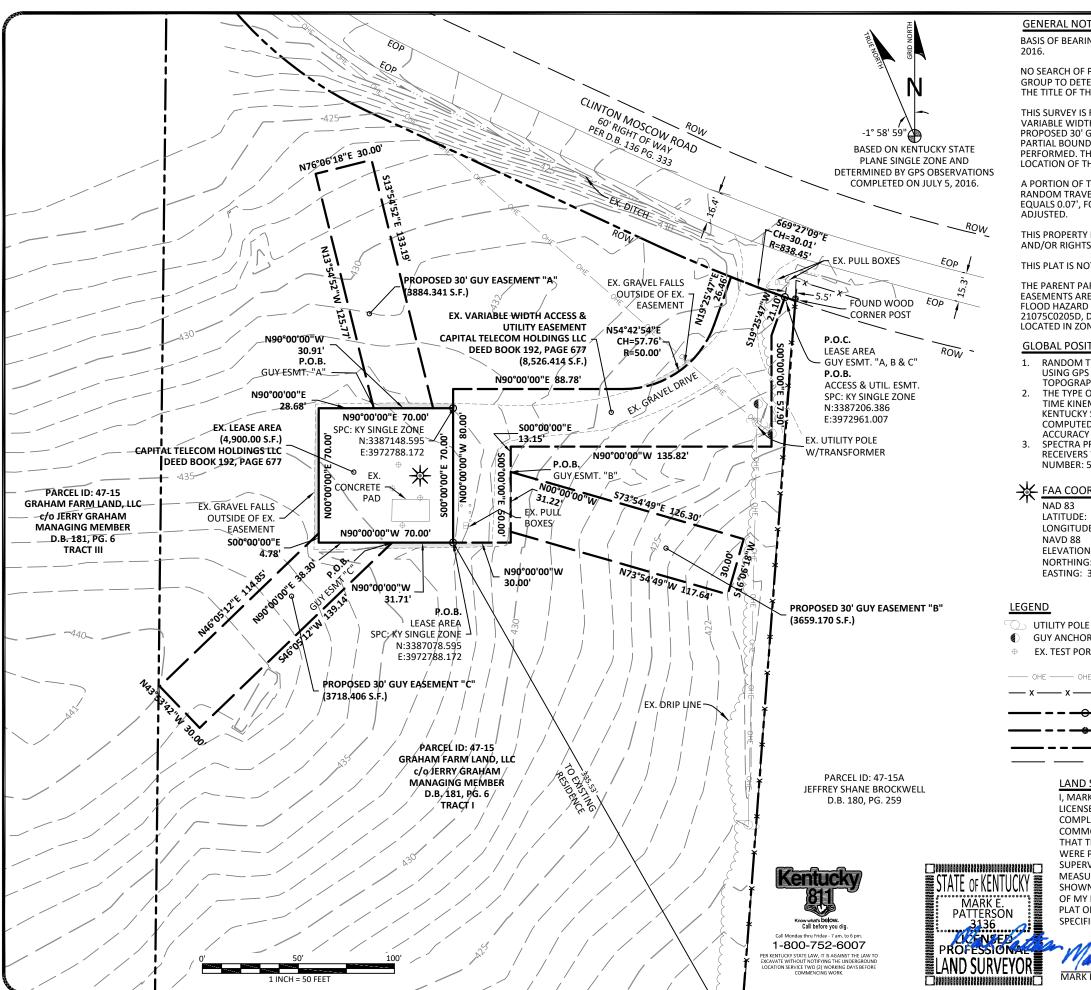

GENERAL NOTES

BASIS OF BEARING IS GPS OBSERVATIONS COMPLETED ON JULY 5,

NO SEARCH OF PUBLIC RECORDS HAS BEEN COMPLETED BY POD GROUP TO DETERMINE ANY DEFECTS AND/OR AMBIGUITIES IN THE TITLE OF THE PARENT PARCEL

THIS SURVEY IS FOR THE EXISTING LEASE AREA, THE EXISTING VARIABLE WIDTH ACCESS & UTILITY EASEMENT AND THE PROPOSED 30' GUY EASEMENTS "A", "B" & "C" AND ONLY A PARTIAL BOUNDARY SURVEY OF THE PARENT TRACT HAS BEEN PERFORMED. THIS DRAWING ALSO DEPICTS THE "AS-BUILT" LOCATION OF THE TOWER SITE AS OF JULY 7, 2020

A PORTION OF THIS SURVEY WAS CONDUCTED BY METHOD OF RANDOM TRAVERSE WITH SIDE SHOTS. UNADJUSTED CLOSURE EQUALS 0.07', FOR A PRECISION OF 1:39,571 AND HAS NOT BEEN

THIS PROPERTY IS SUBJECT TO ANY RECORDED EASEMENTS AND/OR RIGHTS OF WAY SHOWN HEREON OR NOT.

THIS PLAT IS NOT INTENDED FOR LAND TRANSFER.

THE PARENT PARCEL, THE EXISTING LEASE AREA AND THE EASEMENTS ARE NOT LOCATED IN A 100-YEAR FLOOD PLAIN PER FLOOD HAZARD BOUNDARY MAP, COMMUNITY-PANEL NUMBER 21075C0205D, DATED JUNE 2, 2011. THE PARENT PARCEL IS LOCATED IN ZONE X.

GLOBAL POSITIONING SYSTEMS NOTE

- RANDOM TRAVERSE CONTROL MONUMENTS WERE SET USING GPS METHODS. A PORTION OF THE BOUNDARY AND TOPOGRAPHY WAS COLLECTED USING GPS METHODS.
- THE TYPE OF GPS UTILIZED WAS NETWORK ADJUSTED REAL TIME KINEMATIC (KYDOT VRS NETWORK), NAD 83 KENTUCKY SINGLE ZONE WITH THE ORTHOMETRIC HEIGHT COMPUTED USING GEOID12A. RELATIVE POSITIONAL ACCURACY VARIED FROM 0.04' TO 0.08' HORIZONTALLY.
- SPECTRA PRECISION EPOCH 50 DUAL FREQUENCY RECEIVERS WERE USED CONDUCTING THE SURVEY. SERIAL NUMBER: 5325400009

FAA COORDINATE POINT

LATITUDE: 36°34'48.405357"'

LONGITUDE: 88°58'49.128829' NAVD 88

ELEVATION: 435'± AMSL NORTHING: 3387113.430 EASTING: 3972771.019

P.O.B. POINT OF BEGINNING **GUY ANCHOR** RIGHT OF WAY ROW **EX. TEST PORT** FOP **EDGE OF PAVEMENT** EX. OVERHEAD ELECTRIC FOUND 1/2" REBAR 18" LONG CAPPED "PATTERSON PLS 3136 FOUND MONUMENT AS NOTED PROPERTY LINE

LAND SURVEYOR'S CERTIFICATE

I, MARK E. PATTERSON, HEREBY CERTIFY THAT I AM A LICENSED PROFESSIONAL LAND SURVEYOR LICENSED IN COMPLIANCE WITH THE LAWS OF THE COMMONWEALTH OF KENTUCKY. I FURTHER CERTIFY THAT THIS PLAT AND THE SURVEY ON THE GROUND WERE PERFORMED BY PERSONS UNDER MY DIRECT SUPERVISION, AND THAT THE DIRECTIONAL AND LINEAR MEASUREMENTS BEING WITNESSED BY MONUMENTS SHOWN HEREON ARE TRUE AND CORRECT TO THE BEST OF MY KNOWLEDGE. THE "RURAL" SURVEY, AND THE PLAT ON WHICH IT IS BASED. MEETS ALL SPECIFICATIONS AS STATED IN KAR 201 18:150.



02/21/2022

P.O.C. POINT OF COMMENCEMENT

ADJACENT PROPERTY LINE

POWER OF DESIGN 11490 BLUEGRASS PKWY LOUISVILLE, KY 40299 502-437-5252

REPARED FOR:



REVISIONS

REV.	DATE	DESCRIPTION
0	7.28.20	ISSUED AS FINAL
1	8.14.20	GUY ESMT A LEGAL
2	1.13.22	GUY ESMT
3	2.21.22	FAA COORDINATES

SITE INFORMATION:

FULTON, KY (CRUTCHFIELD)

1311 CLINTON MOSCOW ROAD FULTON, KY 42041 FULTON COUNTY

TAX PARCEL NUMBER: 47-15

PROPERTY OWNER: GRAHAM FARM LAND, LLC c/o JERRY GRAHAM MANAGING MEMBER 1758 STATE ROUTE 781 N FULTON, KY 42041

SOURCE OF TITLE: DEED BOOK 181, PAGE 6

VERIZON WIRELESS SITE NAME: EV CRUTCHFIELD

22-118809 JRS POD NUMBER CHECKED BY: MEP 07.07.20 01.13.22 SURVEY DATE PLAT DATE:

SHEET TITLE:

AS-BUILT SURVEY

THIS DOES NOT REPRESENT A **BOUNDARY SURVEY OF THE** PARENT PARCEL

EXISTING LEASE AREA

THE FOLLOWING IS A DESCRIPTION OF THE EXISTING LEASE AREA GRANTED FROM THE PROPERTY OF GRAHAM FARM LAND, LLC c/o JERRY GRAHAM MANAGING MEMBER AS RECORDED IN DEED BOOK 181, PAGE 6, PARCEL ID: 47-15, WHICH IS MORE PARTICULARLY DESCRIBED AS FOLLOWS:

BEARING DATUM USED HEREIN IS BASED UPON KENTUCKY STATE PLANE COORDINATE SYSTEM, KENTUCKY SINGLE ZONE, NAD 83, FROM A REAL TIME KINEMATIC GLOBAL POSITIONING SYSTEM OBSERVATION USING THE KENTUCKY TRANSPORTATION CABINET REAL TIME GPS NETWORK COMPLETED ON 1111 Y 5, 2016.

COMMENCING AT A SET 1/2" REBAR 18" LONG CAPPED "PATTERSON PLS 3136", HEREAFTER REFERRED TO AS A "SET IPC", WITH A STATE PLANE COORDINATE, KENTUCKY STATE PLANE COORDINATE SYSTEM, KENTUCKY SINGLE ZONE, NORTH: 3387206.386 & EAST: 3972961.007 AND LYING ON THE SOUTHERLY RIGHT OF WAY OF CLINTON MOSCOW ROAD, WHICH HAS A 60' RIGHT OF WAY AS DESCRIBED IN DEED BOOK 136 PAGE 333 AND BEING IN THE NORTHERN LINE OF PROPERTY CONVEYED TO GRAHAM FARM LAND, LLC c/O JERRY GRAHAM MANAGING MEMBER AS RECORDED IN DEED BOOK 181, PAGE 6, PARCEL ID: 47-15, SAID POINT BEING THE NORTHEASTERLY CORNER OF THE VARIABLE WIDTH ACCESS AND UTILITY EASEMENT; THENCE LEAVING SAID RIGHT OF WAY AND TRAVERSING THE LAND OF SAID GRAHAM FARM \$19°25'47"W 21.10'; THENCE \$00°00'00"E 57.90'; THENCE N90°00'00"W 135.82'; THENCE \$00°00'00"E 50.00'; THENCE N90°00'00"W 30.00' TO A SET IPC IN THE SOUTHEAST CORNER OF THE LEASE AREA, WITH A STATE PLANE COORDINATE, KENTUCKY SINGLE ZONE, NORTH: 3387078.595 & EAST: 3972788.172; THENCE N90°00'00"W 70.00' TO A SET IPC; THENCE N00°00'00"E 70.00' TO A SET IPC; THENCE N00°00'00"E 70.00' TO A SET IPC; THENCE N00°00'00"E 70.00' TO THE POINT OF BEGINNING OF THE EXISTING LEASE AREA, CONTAINING 4,900.000 SQUARE FEET AS PER SURVEY BY MARK E. PATTERSON, PLS #3136 DATED JULY 5. 2016

EXISTING VARIABLE WIDTH ACCESS & UTILITY EASEMENT

THE FOLLOWING IS A DESCRIPTION OF THE EXISTING VARIABLE WIDTH ACCESS & UTILITY EASEMENT TO BE GRANTED FROM THE PROPERTY OF GRAHAM FARM LAND, LLC c/o JERRY GRAHAM MANAGING MEMBER AS RECORDED IN DEED BOOK 181, PAGE 6, PARCEL ID: 47-15, WHICH IS MORE PARTICULARLY DESCRIBED AS FOLLOWS:

BEARING DATUM USED HEREIN IS BASED UPON KENTUCKY STATE PLANE COORDINATE SYSTEM, KENTUCKY SINGLE ZONE, NAD 83, FROM A REAL TIME KINEMATIC GLOBAL POSITIONING SYSTEM OBSERVATION USING THE KENTUCKY TRANSPORTATION CABINET REAL TIME GPS NETWORK COMPLETED ON JULY 5, 2016.

COMMENCING AT A SET 1/2" REBAR 18" LONG CAPPED "PATTERSON PLS 3136", HEREAFTER REFERRED TO AS A "SET IPC", WITH A STATE PLANE COORDINATE, KENTUCKY STATE PLANE COORDINATE SYSTEM, KENTUCKY SINGLE ZONE, NORTH: 3387206.386 & EAST: 3972961.007 AND LYING ON THE SOUTHERLY RIGHT OF WAY OF CLINTON MOSCOW ROAD, WHICH HAS A 60' RIGHT OF WAY AS DESCRIBED IN DEED BOOK 136 PAGE 333 AND BEING IN THE NORTHERN LINE OF PROPERTY CONVEYED TO GRAHAM FARM LAND, LLC c/o JERRY GRAHAM MANAGING MEMBER AS RECORDED IN DEED BOOK 181, PAGE 6, PARCEL ID: 47-15, SAID POINT BEING THE NORTHEASTERLY CORNER OF THE VARIABLE WIDTH ACCESS AND UTILITY EASEMENT; THENCE LEAVING SAID RIGHT OF WAY AND TRAVERSING THE LAND OF SAID GRAHAM FARM \$19°25'47"W 21.10'; THENCE S00°00'00"E 57.90'; THENCE N90°00'00"W 135.82'; THENCE S00°00'00"E 50.00'; THENCE N90°00'00"W 30.00' TO A SET IPC IN THE SOUTHEAST CORNER OF THE LEASE AREA, WITH A STATE PLANE COORDINATE, KENTUCKY SINGLE ZONE, NORTH: 3387078.595 & EAST: 3972788.172; THENCE N00°00'00"W 80.00' (PASSING A SET IPC AT 70.00'); THENCE N90°00'00"E 88.78'; THENCE WITH THE CHORD OF A CURVE TO THE RIGHT HAVING A RADIUS OF 50.00', N54"42'54"E 57.76; THENCE N19°25'47"E 26.46' TO THE SOUTHERLY RIGHT OF WAY OF CLINTON MOSCOW ROAD; THENCE WITH SAID RIGHT OF WAY WITH THE CHORD OF A NON-TANGENT CURVE TO THE LEFT HAVING A RADIUS OF 838.45', \$69°27'09"E 30.01' TO THE POINT OF BEGINNING, CONTAINING 8,526.414 SQUARE FEET AS PER SURVEY BY MARK E. PATTERSON, PLS #3136 DATED JULY 5, 2016.

PROPOSED 30' GUY EASEMENT "A"

THE FOLLOWING IS A DESCRIPTION OF THE PROPOSED 30' GUY EASEMENT "A" TO BE GRANTED FROM THE PROPERTY OF GRAHAM FARM LAND, LLC C/O JERRY GRAHAM MANAGING MEMBER AS RECORDED IN DEED BOOK 181, PAGE 6, PARCEL ID: 47-15, WHICH IS MORE PARTICULARLY DESCRIBED AS FOLLOWS:

BEARING DATUM USED HEREIN IS BASED UPON KENTUCKY STATE PLANE COORDINATE SYSTEM, KENTUCKY SINGLE ZONE, NAD 83, FROM A REAL TIME KINEMATIC GLOBAL POSITIONING SYSTEM OBSERVATION USING THE KENTUCKY TRANSPORTATION CABINET REAL TIME GPS NETWORK COMPLETED ON JULY 5, 2016.

COMMENCING AT A SET 1/2" REBAR 18" LONG CAPPED "PATTERSON PLS 3136", HEREAFTER REFERRED TO AS A "SET IPC", WITH A STATE PLANE COORDINATE, KENTUCKY STATE PLANE COORDINATE, KENTUCKY SINGLE ZONE, NORTH: 3387206.386 & EAST: 3972961.007 AND LYING ON THE SOUTHERLY RIGHT OF WAY OF CLINTON MOSCOW ROAD, WHICH HAS A 60' RIGHT OF WAY AS DESCRIBED IN DEED BOOK 136 PAGE 333 AND BEING IN THE NORTHERN LINE OF PROPERTY CONVEYED TO GRAHAM FARM LAND, LLC C/O JERRY GRAHAM MANAGING MEMBER AS RECORDED IN DEED BOOK 181, PAGE 6, PARCEL ID: 47-15, SAID POINT BEING THE NORTHEASTERLY CORNER OF THE EXISTING VARIABLE WIDTH ACCESS AND UTILITY EASEMENT; THENCE LEAVING SAID RIGHT OF WAY AND TRAVERSING THE LAND OF SAID GRAHAM FARM \$19°25'47"W 21.10'; THENCE 500°00'00"E 57.90'; THENCE NO9°00'00"W 335.82'; THENCE S00°00'00"E 50.00'; THENCE N90°00'00"W 30.00' TO A SET IPC IN THE SOUTHEAST CORNER OF THE EXISTING LEASE AREA, WITH A STATE PLANE COORDINATE, KENTUCKY SINGLE ZONE, NORTH: 3387078.595 & EAST: 3972788.172; THENCE N90°00'00"W 70.00' TO A SET IPC; THENCE N90°00'00" TO THE POINT OF BEGINNING OF THE PROPOSED 30' GUY EASEMENT "A"; THENCE LEAVING SAID LEASE AREA, N13°54'52"W 125.77'; THENCE N76°06'18"E 30.00'; THENCE S13°54'52"E 133.19' TO THE NORTH LINE OF THE EXISTING LEASE AREA; THENCE N90°00'00"W 30.91' TO THE POINT OF BEGINNING, CONTAINING 3,884.341 SQUARE FEET AS PER SURVEY BY MARK E. PATTERSON, PLS #3136 DATED JULY 5, 2015.

LAND SURVEYOR'S CERTIFICATE

I, MARK E. PATTERSON, HEREBY CERTIFY THAT I AM A LICENSED PROFESSIONAL LAND SURVEYOR LICENSED IN COMPLIANCE WITH THE LAWS OF THE COMMONWEALTH OF KENTUCKY. I FURTHER CERTIFY THAT THIS PLAT AND THE SURVEY ON THE GROUND WERE PERFORMED BY PERSONS UNDER MY DIRECT SUPERVISION, AND THAT THE DIRECTIONAL AND LINEAR MEASUREMENTS BEING WITNESSED BY MONUMENTS SHOWN HEREON ARE TRUE AND CORRECT TO THE BEST OF MY KNOWLEDGE. THE "RURAL" SURVEY, AND THE PLAT ON WHICH IT IS BASED, MEETS ALL SPECIFICATIONS AS STATED IN KAR 201 18:150.





DATE

PROPOSED 30' GUY EASEMENT "B"

THE FOLLOWING IS A DESCRIPTION OF THE PROPOSED 30' GUY EASEMENT "B" TO BE GRANTED FROM THE PROPERTY OF GRAHAM FARM LAND, LLC c/o JERRY GRAHAM MANAGING MEMBER AS RECORDED IN DEED BOOK 181, PAGE 6, PARCEL ID: 47-15, WHICH IS MORE PARTICULIARLY DESCRIBED AS FOLLOWS:

BEARING DATUM USED HEREIN IS BASED UPON KENTUCKY STATE PLANE COORDINATE SYSTEM, KENTUCKY SINGLE ZONE, NAD 83, FROM A REAL TIME KINEMATIC GLOBAL POSITIONING SYSTEM OBSERVATION USING THE KENTUCKY TRANSPORTATION CABINET REAL TIME GPS NETWORK COMPLETED ON JULY 5, 2016.

COMMENCING AT A SET 1/2" REBAR 18" LONG CAPPED "PATTERSON PLS 3136", HEREAFTER REFERRED TO AS A "SET IPC", WITH A STATE PLANE COORDINATE, KENTUCKY STATE PLANE COORDINATE SYSTEM, KENTUCKY SINGLE ZONE, NORTH: 3387206.386 & EAST: 3972961.007 AND LYING ON THE SOUTHERLY RIGHT OF WAY OF CLINTON MOSCOW ROAD, WHICH HAS A 60' RIGHT OF WAY AS DESCRIBED IN DEED BOOK 136 PAGE 333 AND BEING IN THE NORTHERN LINE OF PROPERTY CONVEYED TO GRAHAM FARM LAND, LLC c/o JERRY GRAHAM MANAGING MEMBER AS RECORDED IN DEED BOOK 181, PAGE 6, PARCEL ID: 47-15, SAID POINT BEING THE NORTHEASTERLY CORNER OF THE VARIABLE WIDTH ACCESS AND UTILITY EASEMENT; THENCE LEAVING SAID RIGHT OF WAY AND TRAVERSING THE LAND OF SAID GRAHAM FARM S19°25'47"W 21.10'; THENCE S00°00'00"E 57.90'; THENCE N90°00'00"W 13.5.82'; THENCE S00°00'00"W 13.15 TO THE POINT OF BEGINNING OF THE PROPOSED 30' GUY EASEMENT "B'; THENCE LEAVING SAID ACCESS AND UTILITY EASEMENT, S73°54'49"E 126.30'; THENCE S16°06'18"W 30.00'; THENCE N73°54'49"W 117.64' TO SOUTHEASTERLY CORNER OF THE VARIABLE WIDTH ACCESS AND UTILITY EASEMENT; THENCE N00°00'00"W 31.22' TO THE POINT OF BEGINNING, CONTAINING 3,659.170 SQUARE FEET AS PER SURVEY BY MARK E. PATTERSON, PLS 3336 DATED JULY 5, 2016.

PROPOSED 30' GUY EASEMENT "C"

THE FOLLOWING IS A DESCRIPTION OF THE PROPOSED 30' GUY EASEMENT "C" TO BE GRANTED FROM THE PROPERTY OF GRAHAM FARM LAND, LLC c/o JERRY GRAHAM MANAGING MEMBER AS RECORDED IN DEED BOOK 181, PAGE 6, PARCEL ID: 47-15, WHICH IS MORE PARTICULARLY DESCRIBED AS FOLLOWS:

BEARING DATUM USED HEREIN IS BASED UPON KENTUCKY STATE PLANE COORDINATE SYSTEM, KENTUCKY SINGLE ZONE, NAD 83, FROM A REAL TIME KINEMATIC GLOBAL POSITIONING SYSTEM OBSERVATION USING THE KENTUCKY TRANSPORTATION CABINET REAL TIME GPS NETWORK COMPLETED ON JULY 5, 2016.

COMMENCING AT A SET 1/2" REBAR 18" LONG CAPPED "PATTERSON PLS 3136", HEREAFTER REFERRED TO AS A "SET IPC", WITH A STATE PLANE COORDINATE, KENTUCKY STATE PLANE COORDINATE SYSTEM, KENTUCKY SINGLE ZONE, NORTH: 3387206.386 & EAST: 3972961.007 AND LYING ON THE SOUTHERLY RIGHT OF WAY OF CLINTON MOSCOW ROAD, WHICH HAS A 60' RIGHT OF WAY AS DESCRIBED IN DEED BOOK 136 PAGE 333 AND BEING IN THE NORTHERN LINE OF PROPERTY CONVEYED TO GRAHAM FARM LAND, LLC C/O JERRY GRAHAM MANAGING MEMBER AS RECORDED IN DEED BOOK 181, PAGE 6, PARCEL ID: 47-15, SAID POINT BEING THE NORTHEASTERLY CORNER OF THE VARIABLE WIDTH ACCESS AND UTILITY EASEMENT; THENCE LEAVING SAID RIGHT OF WAY AND TRAVERSING THE LAND OF SAID GRAHAM FARM S19°25'47"W 21.10'; THENCE S00°00'00"E 57.90'; THENCE N90°00'00"W 135.82'; THENCE S00°00'00"E 50.00'; THENCE N90°00'00"W 30.00' TO A SET IPC IN THE SOUTHEAST CORNER OF THE LEASE AREA, WITH A STATE PLANE COORDINATE, KENTUCKY SINGLE ZONE, NORTH: 3387078.595 & EAST: 3972788.172; THENCE LEAVING SAID LEASE AREA, N90°00'00"W 31.71' TO THE POINT OF BEGINNING OF THE PROPOSED 30' GUY EASEMENT "C"; THENCE LEAVING SAID LEASE AREA, 546°05'12"W 139.14'; THENCE N90°00'00"E 38.30' TO THE POINT OF BEGINNING, CONTAINING 3,718.406 SQUARE FEET AS PER SURVEY BY MARK E. PATTERSON, PLS #3136 DATED JULY 5, 2016.



PREPARED FOR:



REVISIONS

REV.	DATE	DESCRIPTION
0	7.28.20	ISSUED AS FINAL
1	8.14.20	GUY ESMT A LEGAL
2	1.13.22	GUY ESMT
3	2.21.22	FAA COORDINATES

SITE INFORMATION:

FULTON, KY (CRUTCHFIELD)

1311 CLINTON MOSCOW ROAD FULTON, KY 42041 FULTON COUNTY

TAX PARCEL NUMBER: 47-15

PROPERTY OWNER: GRAHAM FARM LAND, LLC c/o JERRY GRAHAM MANAGING MEMBER 1758 STATE ROUTE 781 N FULTON. KY 42041

SOURCE OF TITLE: DEED BOOK 181, PAGE 6

VERIZON WIRELESS SITE NAME: EV CRUTCHFIELD

POD NUMBER: 22-118809
DRAWN BY: JRS
CHECKED BY: MEP
SURVEY DATE: 07.07.20
PLAT DATE: 01.13.22

SHEET TITLE:

AS-BUILT SURVEY

THIS DOES NOT REPRESENT A BOUNDARY SURVEY OF THE PARENT PARCEL

SHEET NUMBER

B-1.2

REVISION LOG


REV *	MM/DD/YY	SHEET NUMBER & NAME	DESCRIPTION OF REVISION
A	1/18/2017	ALL SHEETS	ISSUED FOR REVIEW
0	2/16/2017	ALL SHEETS	ISSUED AS FINAL
1	3/1/2018	T-1, TE-1, G-6, RF-1, AD-1, AD-3, AD-4, AD-5, & AD-6	MOUNT CHANGE REDLINES PER RFDS DATED 1/16/18
2	1/31/2020	T-1, TE-1, C-1, C-1A, C-1B, C-3, C-4, C-5, C-6, D-2, D-3, S-1, S-2, S-3, E-1, E-2, E-3, E-4, E-5, G-1, G-2, G-3, G-5, G-6, & RF-1	UPDATED STANDARDS
2	1/31/2020	S-4, E-0, E-6, & E-7	SHEETS ADDED
2	1/31/2020	AD SHEETS: T-1, AD-1, AD-2, AD-3, AD-4, AD-5, & AD-6	SHEETS DELETED
3	1/21/2022	ALL SHEETS	TOWER REPLACEMENT DUE TO TORNADO
4	2/21/2022	T-1, SURVEY	CORRECTED TOWER COORDINATES





820 MORRIS TURNPIKE - STE 104 SHORT HILLS, NJ 07078

02/22/2022

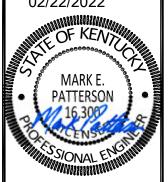

EN PERMIT: 3594

CONSTRUCTION **DRAWINGS**

REV.	DATE	DESCRIPTION
0	2.16.17	ISSUED AS FINAL
1	3.1.18	UPDATED RFDS
2	1.31.20	UPDATED STANDARDS
3	1.21.22	TOWER REPLACEMENT
4	2.21.22	CORRECTED COORDS

SITE INFORMATION: FULTON, KY (CRUTCHFIELD)

1311 CLINTON MOSCOW RD FULTON, KY 42041 FULTON COUNTY

DIAMOND COMMUNICATIONS SITE NUMBER

KY007 VERIZON WIRELESS SITE NAME:

EV CRUTCHFIELD

POD NUMBER:

DRAWN BY: CHECKED BY: DATE:

POD MEP 01.17.17


21-118223

SHEET TITLE:

REVISION LOG

SHEET NUMBER:

R-1

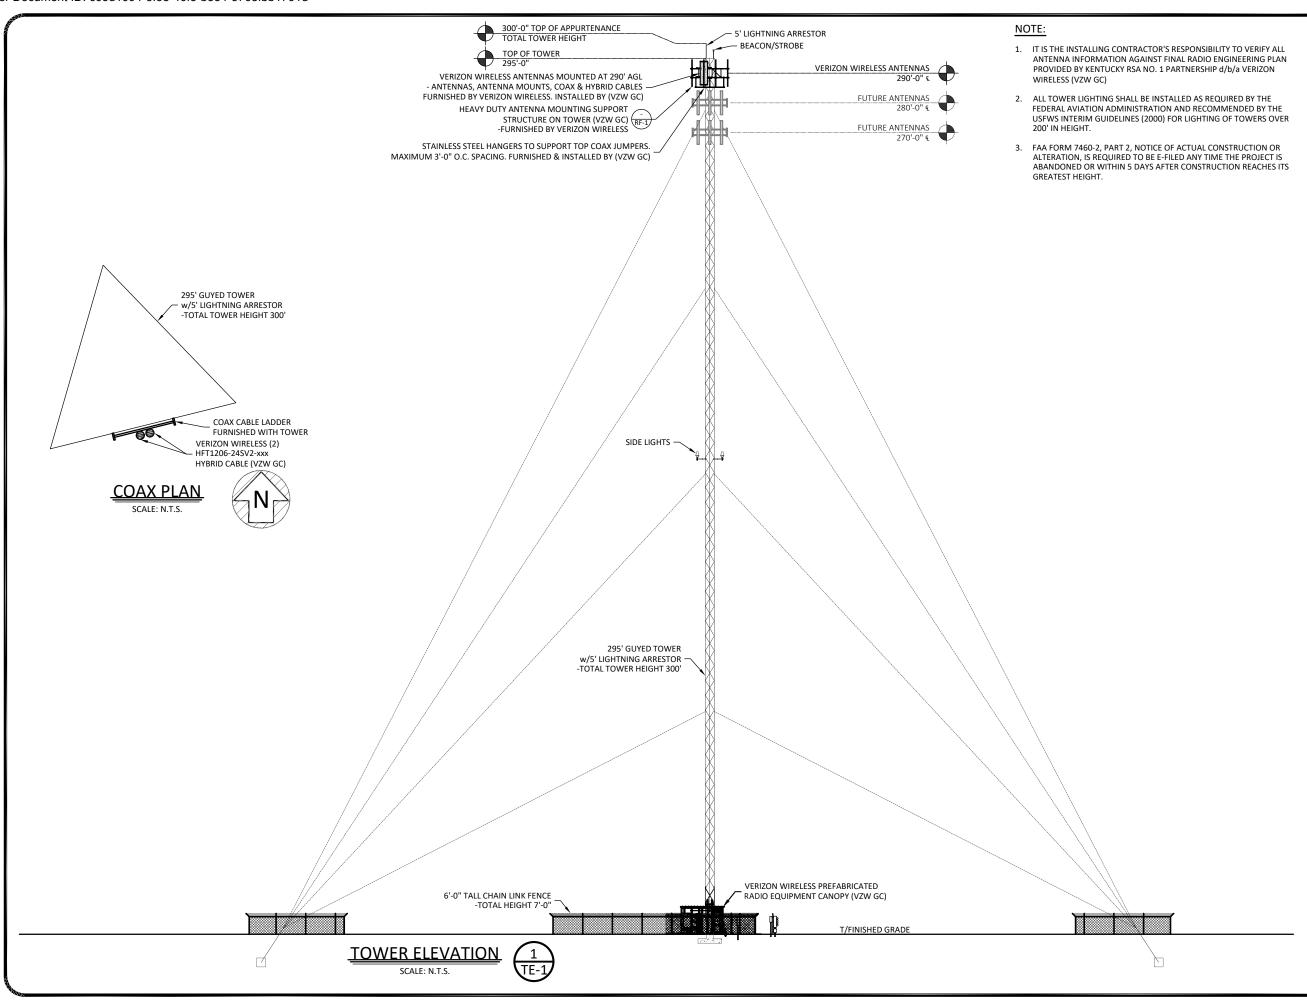





820 MORRIS TURNPIKE - STE 104 SHORT HILLS, NJ 07078

02/22/2022



EN PERMIT: 3594

CONSTRUCTION DRAWINGS

REV.	DATE	DESCRIPTION
0	2.16.17	ISSUED AS FINAL
1	3.1.18	UPDATED RFDS
2	1.31.20	UPDATED STANDARDS
3	1.21.22	TOWER REPLACEMENT
4	2.21.22	CORRECTED COORDS

FULTON, KY (CRUTCHFIELD)

1311 CLINTON MOSCOW RD

FULTON, KY 42041
FULTON COUNTY
DIAMOND COMMUNICATIONS SITE NUMBE

KY007

VERIZON WIRELESS SITE NAME:

EV CRUTCHFIELD

POD NUMBER: 21-118223

DRAWN BY:


CHECKED BY: DATE: POD MEP 01.17.17


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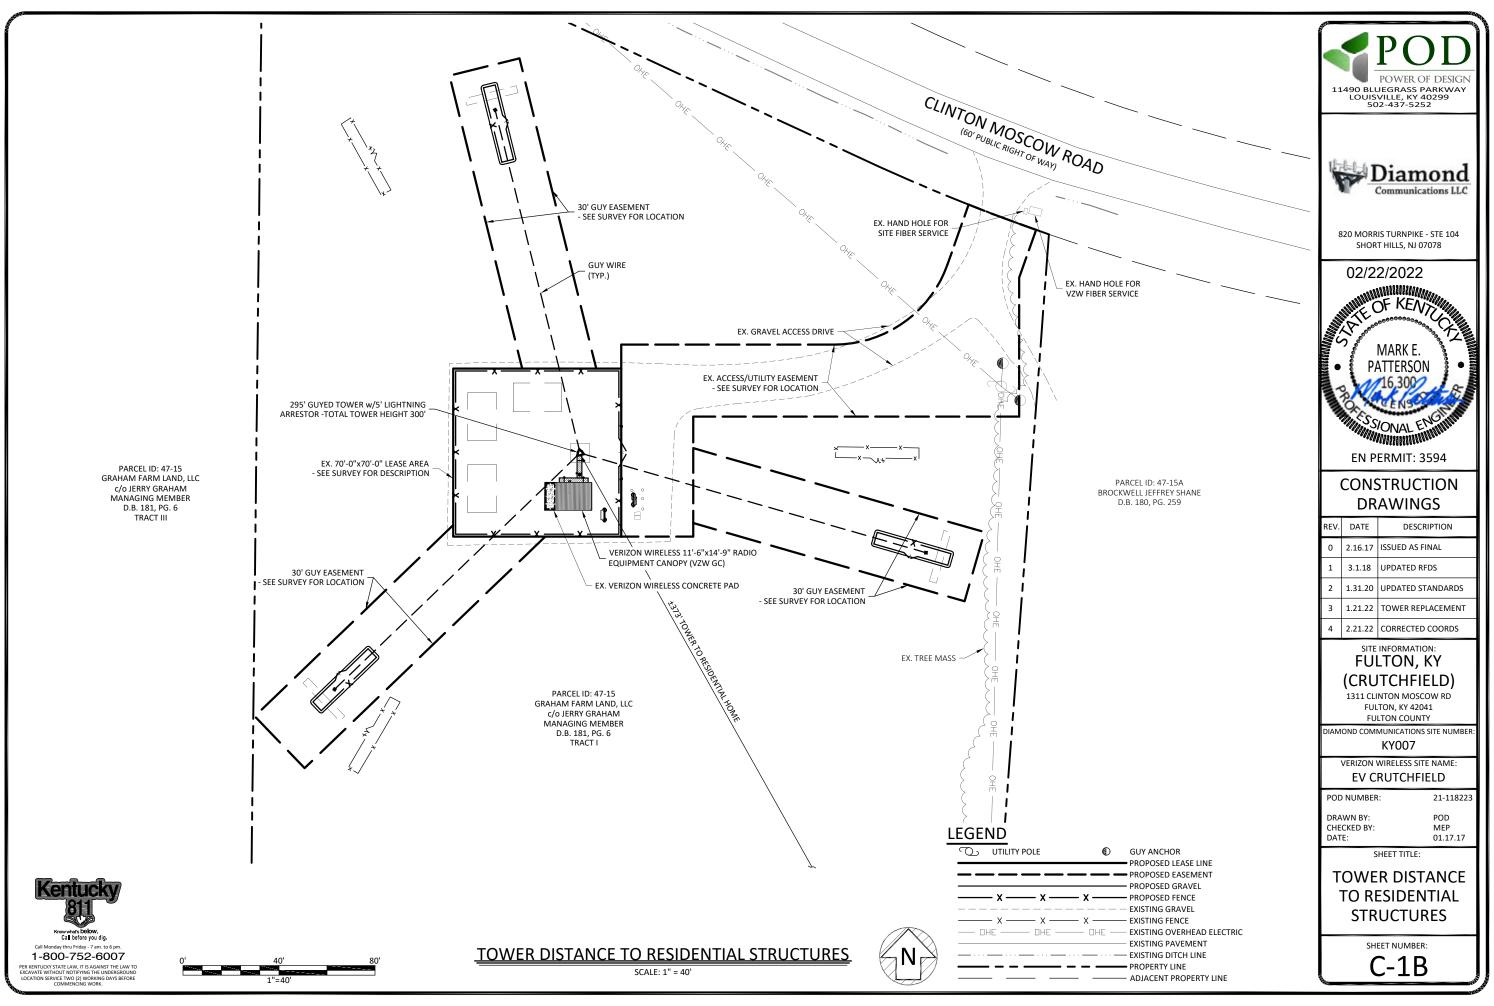
TOWER ELEVATION


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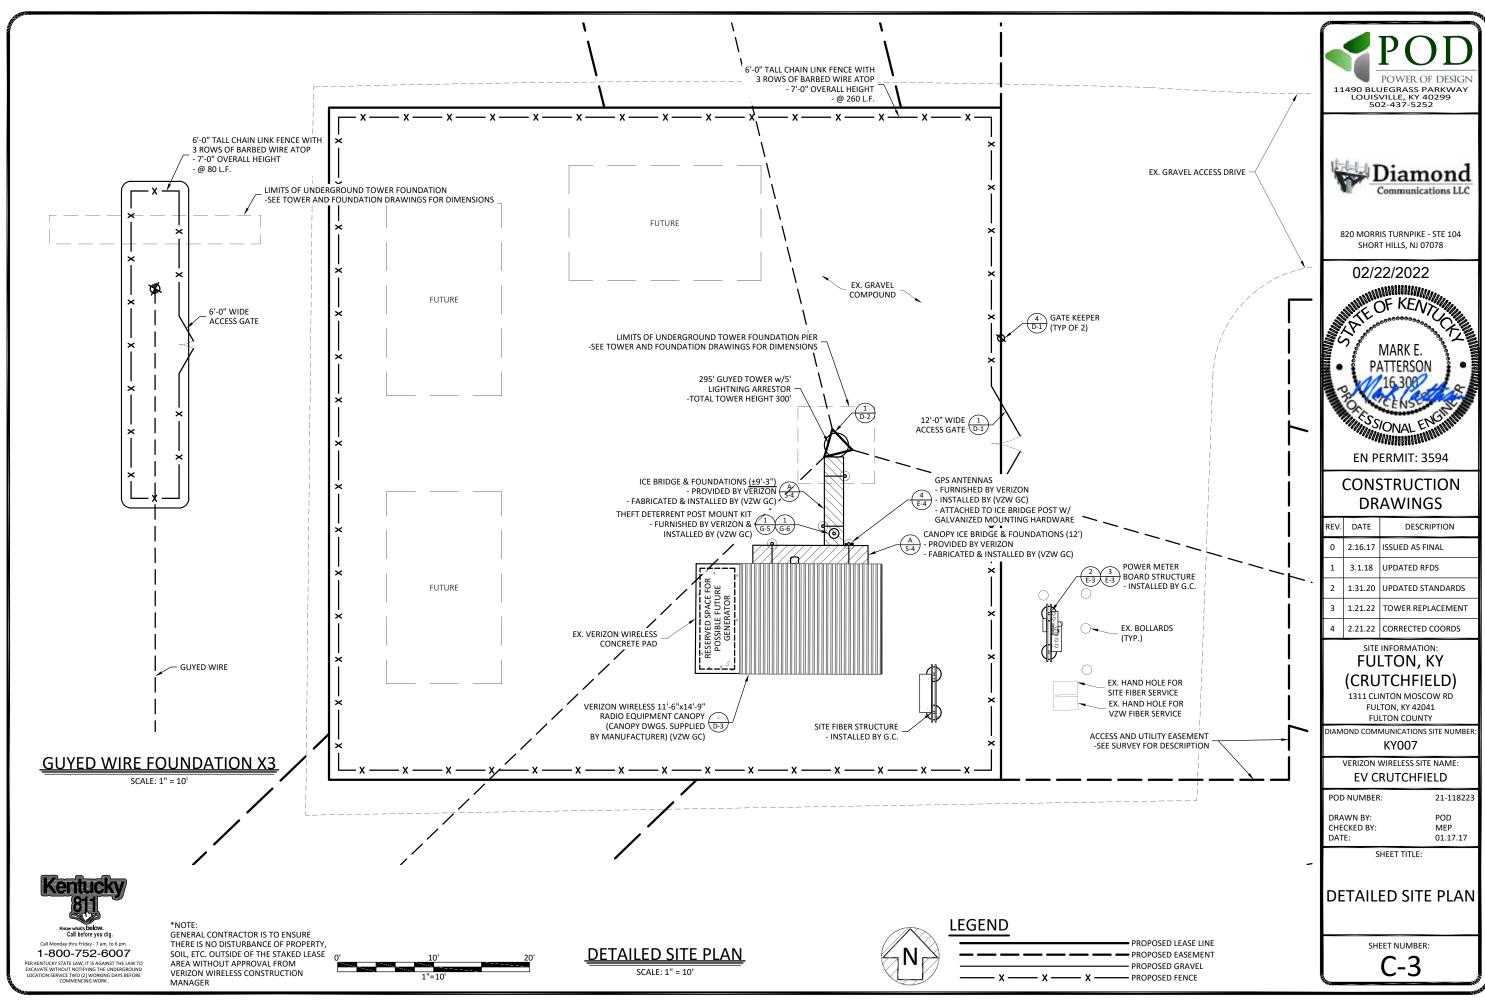
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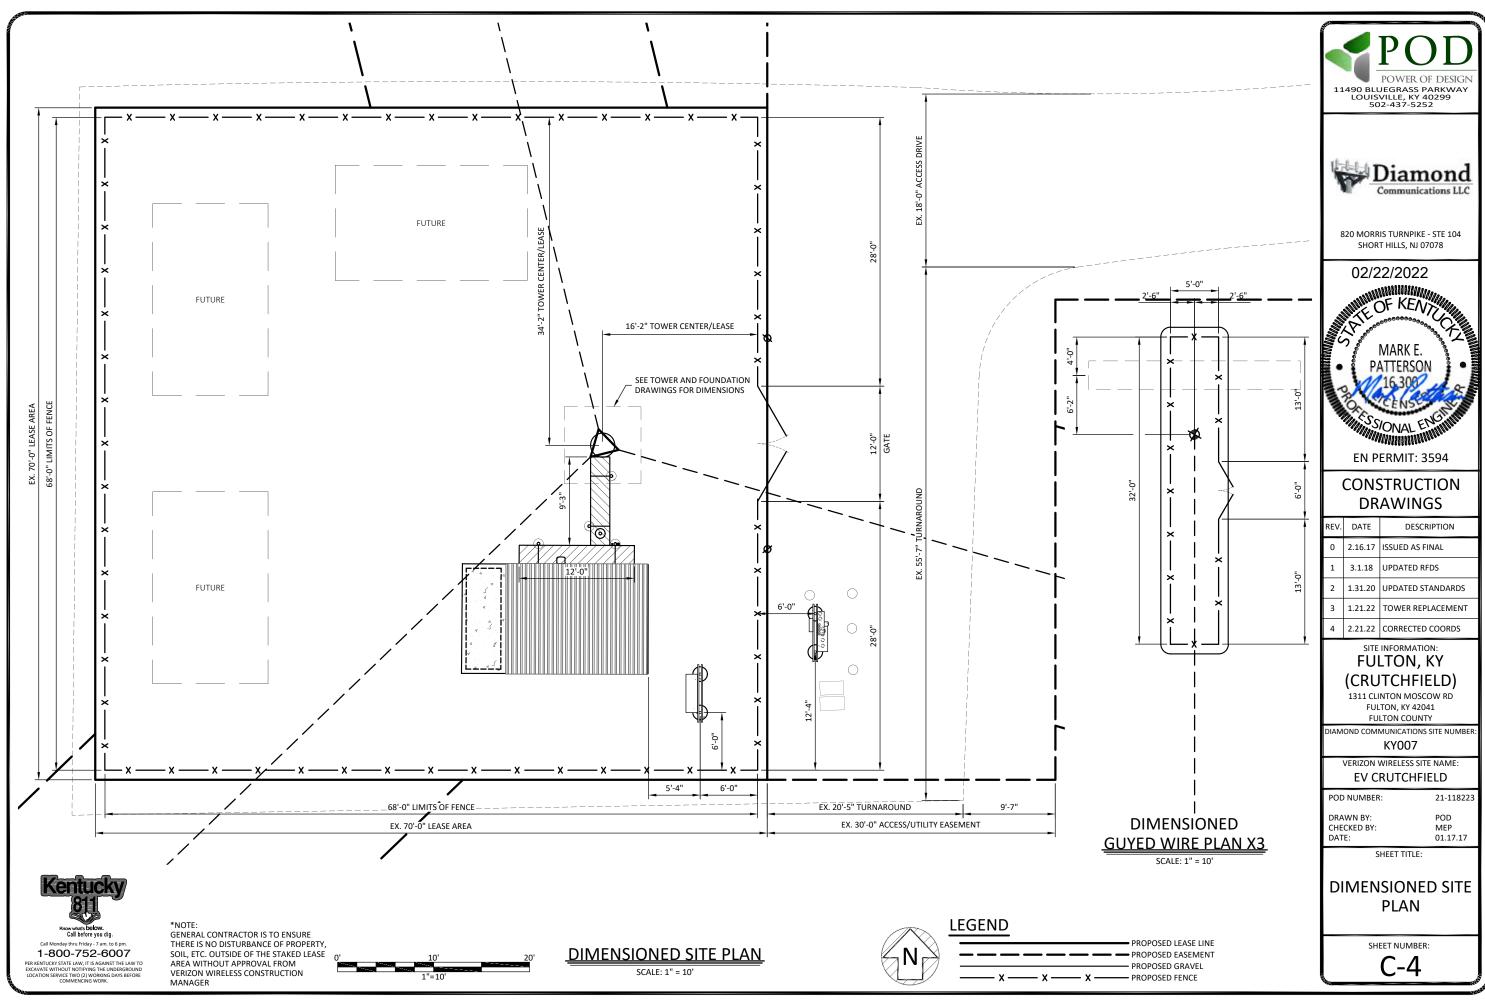








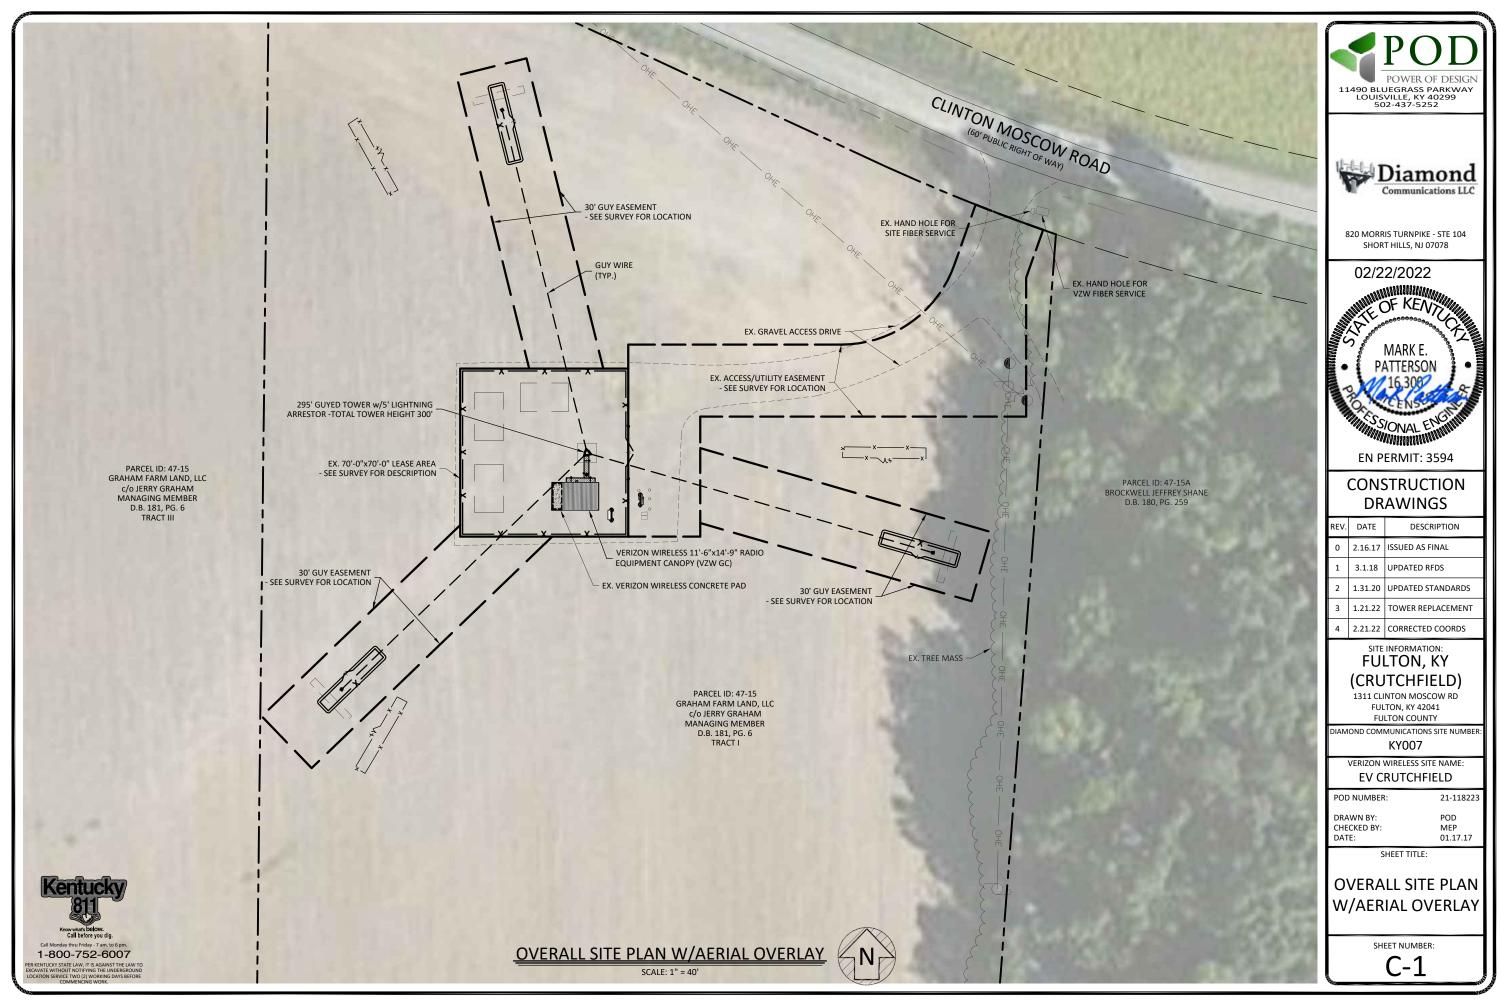

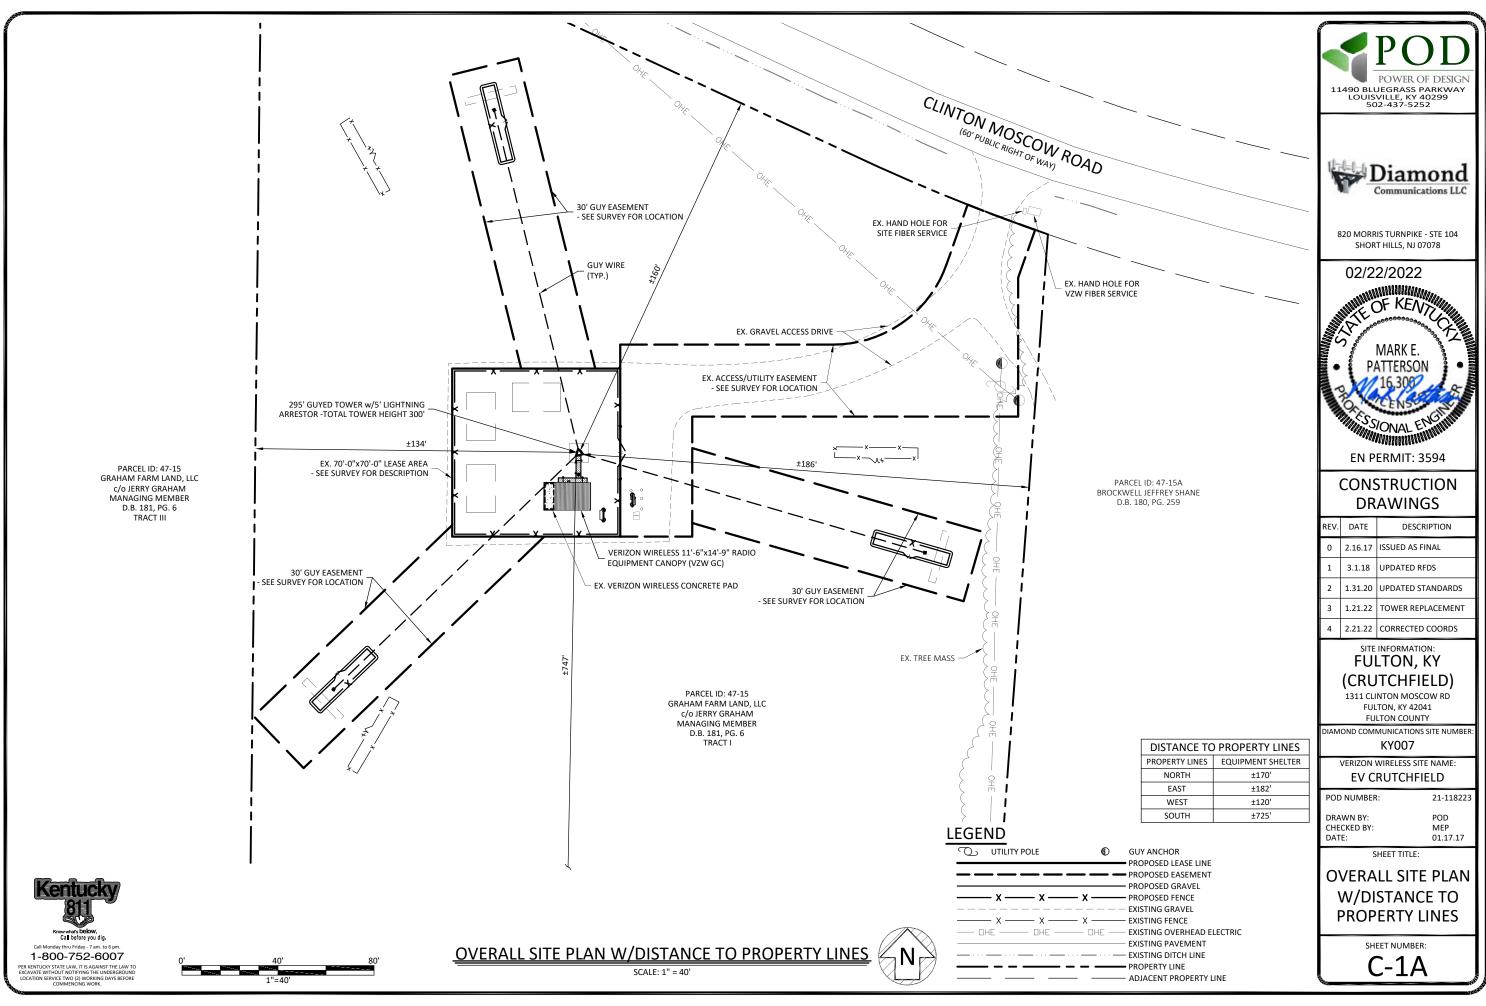

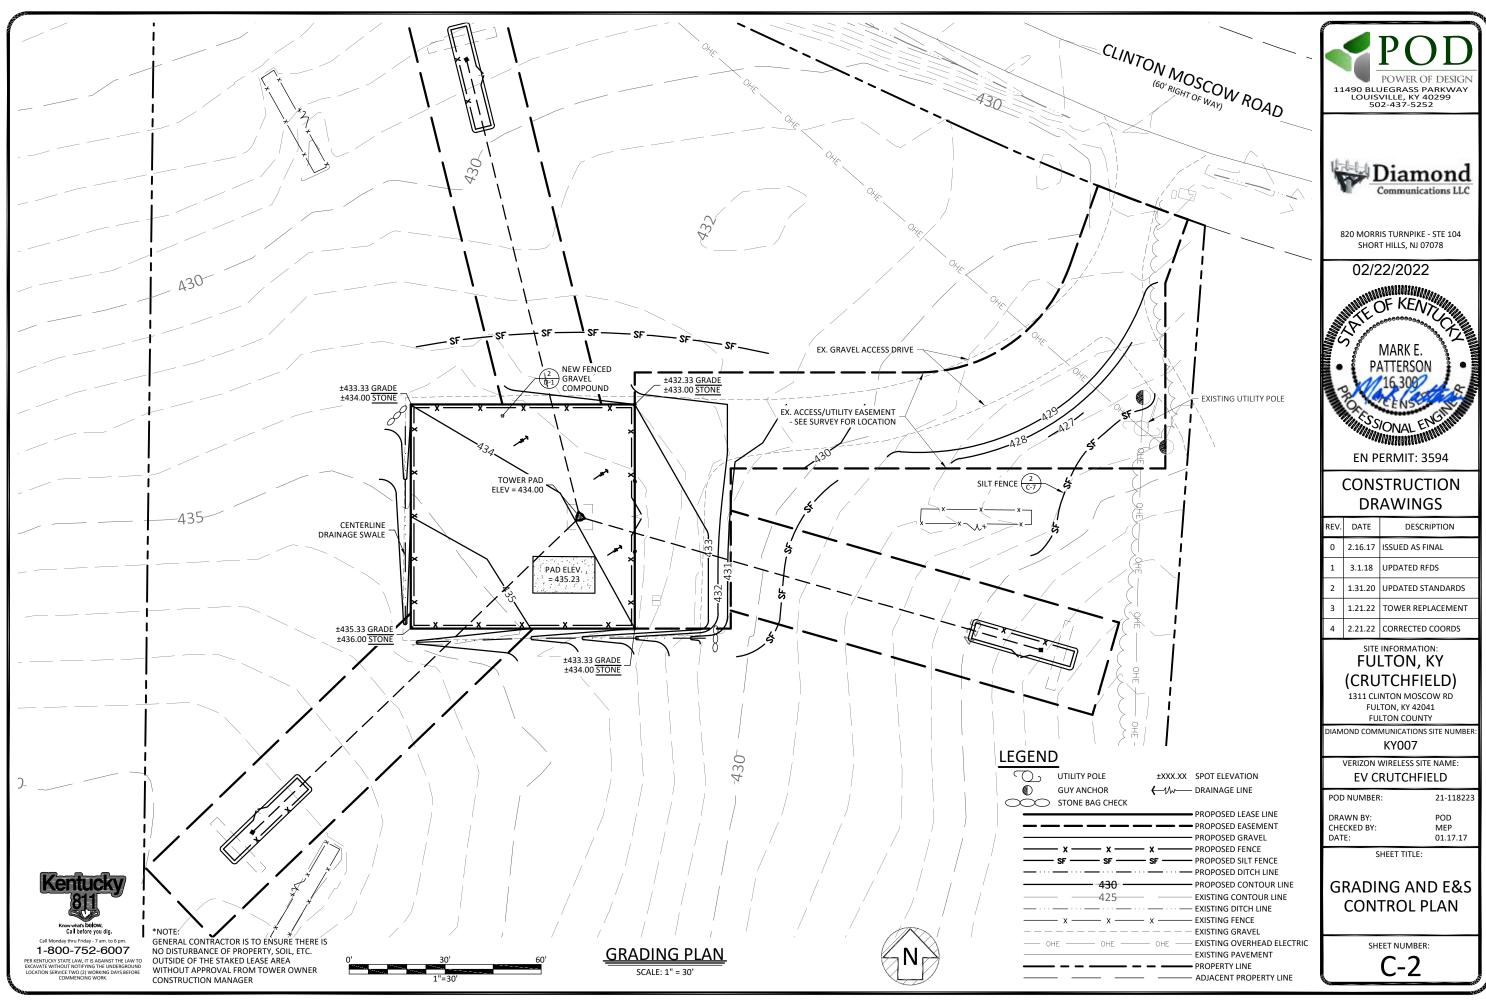

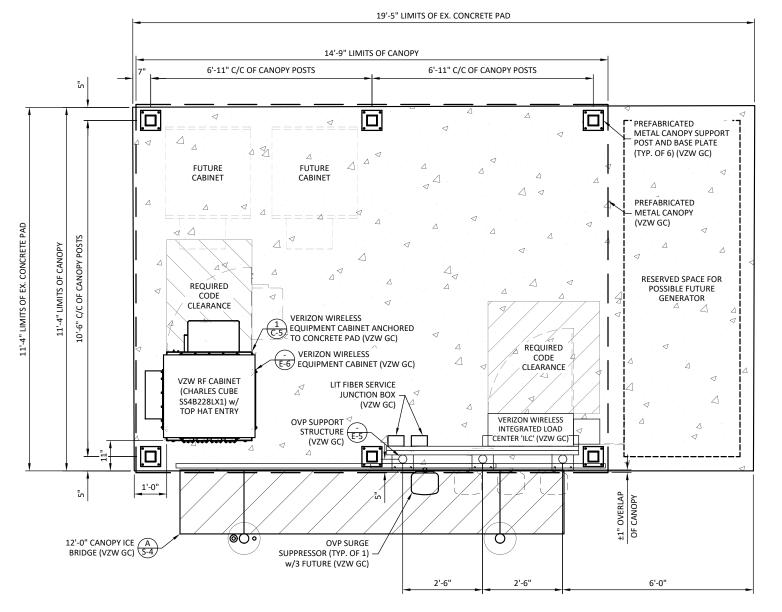

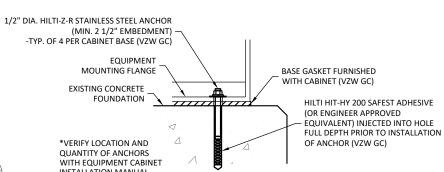

Kentucky
811
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ER KENTUCKY STATE LAW, IT IS AGAINST THE LAW TO XCAVATE WITHOUT NOTIFYING THE UNDERGROUND .OCATION SERVICE TWO (2) WORKING DAYS BEFORE *NOTE:
GENERAL CONTRACTOR IS TO ENSURE
THERE IS NO DISTURBANCE OF PROPERTY,
SOIL, ETC. OUTSIDE OF THE STAKED LEASE
AREA WITHOUT APPROVAL FROM
VERIZON WIRELESS CONSTRUCTION
MANAGER

DETAILED EQUIPMENT PAD PLAN

SCALE: 1" = 3'





AIL (1) C-5





820 MORRIS TURNPIKE - STE 104 SHORT HILLS, NJ 07078

02/22/2022



EN PERMIT: 3594

CONSTRUCTION DRAWINGS

REV.	DATE	DESCRIPTION
0	2.16.17	ISSUED AS FINAL
1	3.1.18	UPDATED RFDS
2	1.31.20	UPDATED STANDARDS
3	1.21.22	TOWER REPLACEMENT
4	2.21.22	CORRECTED COORDS

SITE INFORMATION: FULTON, KY (CRUTCHFIELD)

1311 CLINTON MOSCOW RD FULTON, KY 42041 FULTON COUNTY

NAME IN THE NUMBER IN THE NUMB

NTOO7

VERIZON WIRELESS SITE NAME:
EV CRUTCHFIELD

POD NUMBER: 21-118223
DRAWN BY: POD

CHECKED BY: MEP DATE: 01.17.17

SHEET TITLE:

DETAILED EQUIPMENT PAD PLAN

SHEET NUMBER:

C-5

GENERAL SITE CONSTRUCTION NOTES

SCHEDULE

THE CONSTRUCTION OF THE SITE REQUIRES A CERTAIN SEQUENCE OF EVENTS TO MINIMIZE CONSTRUCTION TIME REQUIRED UNTIL AVAILABILITY OF CELLULAR TELEPHONE SERVICE. VERIFY SCHEDULE DIRING BID WALK.

2. TOWER OWNER REPRESENTATIVE:

DIAMOND COMMUNICATIONS LLC 820 MORRIS TURNPIKE - STE 104 SHORT HILLS, NJ 07078 CONTACT: SCOTT VON REIN PHONE: (973) 544-6834 MOBILE: (973) 698-8725 PROPERTY OWNER REPRESENTATIVE: GRAHAM FARM LAND, LLC 1758 ST ROUTE 781 NORTH FULTON, KY 42041 CONTACT: JERRY GRAHAM PHONE: (270) 627-0374

E-MAIL: SVONREIN@DIAMONDCOMM.COM

3. ANTENNA INSTALLATION:

THE VERIZON WIRELESS CONTRACTOR (VZW GC) INSTALLING THE PLATFORM SHALL ENSURE THAT THE PLATFORM IS ALIGNED BASED ON THE VERIZON WIRELESS RF PLAN. DURING THIS WORK, THE GENERAL CONTRACTOR SHALL BE LIMITED TO THE WORK WHICH CAN BE PERFORMED OUTSIDE THE VICINITY OF THE TOWER

ACCESS DRIVEWAY

THE GENERAL CONTRACTOR SHALL CONSTRUCT THE ACCESS DRIVE PER THE ALIGNMENT AS SHOWN ON THESE DRAWINGS. IF ANY AREA OF CONSTRUCTION REQUIRES ADDITIONAL FILL OF AGGREGATE STONE THAN SHOWN ON THE DRAWINGS, THE GENERAL CONTRACTOR SHALL NOTIFY THE ENGINEER FOR APPROVAL OF THE SIZE, TYPE AND QUANTITY OF STONE/FILL NECESSARY AND SHALL NOT BE USED UNTIL APPROVAL BY THE ENGINEER. THE GENERAL CONTRACTOR SHALL ALSO OBTAIN DRIVE PERMIT FOR NEW ACCESS DRIVE.

5. PREFABRICATED EQUIPMENT CANOPY

THE VERIZON WIRELESS CONTRACTOR (VZW GC) SHALL PROVIDE ALL LABOR, EQUIPMENT AND MATERIALS FOR THE PROPER LIFTING, TRANSPORTING AND ASSEMBLY OF THE PREFABRICATED EQUIPMENT CANOPY FROM THE TRANSPORT TRUCK BED TO THE FINAL POSITION ON THE CONCRETE FOUNDATION. EXTREME CAUTION SHALL BE TAKEN IN THE INSTALLATION OF THE CANOPY TO AVOID CONTACT WITH EXISTING OVERHEAD UTILITY LINES. THE VERIZON WIRELESS CONTRACTOR (VZW GC) IS RESPONSIBLE FOR ATTACHING, SECURING OR ASSEMBLING ANY ACCESSORY OR LOOSE ITEMS THAT ARE SHIPPED WITH THE PREFABRICATED EQUIPMENT CANOPY SHALL INCLUDE THIS WORK IN THE CANOPY INSTALLATION PORTION OF THE BID.

THE VERIZON WIRELESS CONTRACTOR (VZW GC) IS RESPONSIBLE FOR ATTACHING, SECURING OR ASSEMBLING ANY ACCESSORY OR LOOSE ITEMS THAT ARE SHIPPED WITH THE PREFABRICATED EQUIPMENT CANOPY AND GENERATOR AND SHALL INCLUDE THIS WORK IN THE PAD INSTALLATION PORTION OF THE RID

UTILITIES

THE CONTRACTOR SHALL BE RESPONSIBLE FOR THE EXCAVATION AND PROPER BACKFILLING OF TRENCHES AND SUPPLY CONDUIT REQUIRED FOR UNDERGROUND TELEPHONE & ELECTRICAL UTILITIES. ALL TRENCHING SHALL BE COMPACTED TO 95% MAXIMUM DRY DENSITY IN ACCORDANCE W/ASTM D-1557.

THE CONTRACTOR SHALL RUN AN ELECTRICAL TRENCH WITH 2 1/2" CONDUIT AND DETECTABLE PULL TAPE FROM THE NEW RADIO EQUIPMENT PAD AND END AT THE NEW METER BOARD STRUCTURE. THE CONTRACTOR SHALL THEN RUN (2) TWO 3" CONDUIT WITH PULL TAPE FROM THE METER BOARD TO THE NEW POLE MOUNTED TRANSFORMER AND STUB UP 6" ABOVE GRADE. CONTACT REX COFFEY @ (270) 627-3312, WITH GIBSON ELECTRIC MEMBERSHIP COOPERATIVE (GEMC) BEFORE BEGINNING CONSTRUCTION TO VERIFY LOCATION OF CONDUIT AND TRANSFORMER. CONDUITS MUST HAVE A MINIMUM DEPTH OF 36". CONTRACTOR SHALL CONTACT ELECTRIC PROVIDER TO HAVE TRENCH AND CONDUIT INSPECTED BEFORE THE TRENCH IS COVERED, THE ELECTRIC PROVIDER SHALL SUPPLY SERVICE TO THE NEW METER BOARD STRUCTURE. THE CONTRACTOR SHALL CONTACT GEMC TO SETUP AN INSPECTION OF THE TRENCHES BEFORE THEY ARE BACKFILLED. THE CONTRACTOR SHALL PROPERLY BACKFILL THE TRENCHES AFTER INSPECTION AND SETTLEMENT. CONTACT LECTRIC PROVIDER THREE TO FOUR WEEKS PRIOR TO CONSTRUCTION FOR NEW SERVICE AND COORCINATION OF ACCESS TO SITE. THE CONTRACTOR SHALL CONTACT GEMC FOR A COPY OF THEIR SPECIFICATIONS BEFORE CONSTRUCTION

THE TOWER OWNER SHALL ENSURE PERMANENT ELECTRIC POWER IS AVAILABLE FOR VERIZON WIRELESS AT THE METER BASE PRIOR TO THE SITE BEING RELEASED TO VERIZON WIRELESS AS TENANT READY. THE VERIZON WIRELESS GENERAL CONTRACTOR (VZW GC) SHALL RUN ELECTRICAL CONDUCTORS FROM NEW METER CENTER TO NEW VZW INTEGRATED LOAD CENTER WITHIN TOWER OWNER INSTALLED 2 1/2" CONDUIT CONTACT GIBSON ELECTRIC MEMBERSHIP COOPERATIVE (GEMC) TO HAVE NEW METER INSTALLED. THE VERIZON WIRELESS GENERAL CONTRACTOR (VZW GC) SHALL BE RESPONSIBLE FOR THE ORDERING AND COORDINATING THE DELIVERY OF A FIBER OPTIC SERVICE LINE TO THE RADIO EQUIPMENT ENCLOSURE. COORDINATE WITH THE FIBER PROVIDER AND THE VERIZON WIRELESS FACILITY ENGINEER.

- A. THE CONTRACTOR SHALL RUN IN THE FIBER OPTIC TRENCH (1) "VERIZON ONLY" 4" PVC CONDUIT WITH PULL TAPE AND TRACER WIRE FROM THE NEW RADIO EQUIPMENT PAD TO THE NEW HAND HOLE OUTSIDE COMPOUND WITHIN EASEMENT, VERIZON WIRELESS GENERAL CONTRACTOR (VZW GC) WILL COORDINATE WITH FIBER PROVIDER (TBD BY VZW) TO VERIFY EXACT LOCATION OF CONDUIT AND HAND HOLE BEFORE CONSTRUCTION STARTS. (VZW GC) WILL THEN COORDINATE WITH THE CONTRACTOR FOR THIS INSTALLATION. THE FIBER PROVIDER WILL PROVIDE SERVICE TO THE TELCO RACK IN VERIZON WIRELESS EQUIPMENT CABINET.
- B. THE CONTRACTOR SHALL RUN IN THE FIBER OPTIC TRENCH (1) "VERIZON WIRELESS ONLY" 4" PVC CONDUIT WITH PULL TAPE FROM THE NEW HAND HOLE LOCATED OUTSIDE COMPOUND TO THE FUTURE FIBER PEDESTAL LOCATION AND STUB-UP. THE CONTRACTOR SHALL RUN 4" PVC CONDUIT WITH PULL TAPE FROM "VERIZON WIRELESS ONLY" HAND HOLE OUTSIDE COMPOUND TO NEW HAND HOLE AT RIGHT OF WAY. THE CONTRACTOR SHALL COORDINATE WITH THE VERIZON WIRELESS CONSTRUCTION MANAGER AND THE FIBER SERVICE PROVIDER ON THE FUTURE FIBER PEDESTAL LOCATION. THE CONTRACTOR SHALL PROPERLY BACKFILL THE TRENCHES AFTER SETTLEMENT. CONTACT FIBER PROVIDER (TBD BY VERIZON WIRELESS) FOR APPOINTMENT TO VISIT THE SITE, FOUR TO SIX WEEKS PRIOR TO CONSTRUCTION FOR NEW SERVICE.

ELECTRIC SERVICE PROVIDED BY:

GIBSON ELECTRIC MEMBERSHIP COOPERATIVE (GEMC)
ADDRESS: 1702 MOSCOW AVE

HICKMAN, KY 42050
CONTACT: REX COFFEY
PHONE: (270) 627-3312
EMAIL: RCOFFEY@GIBSONEMC.COM

FIBER OPTIC SERVICE PROVIDED BY: FIBER PROVIDER TO BE DETERMINED BY VERIZON WIRELESS 7. SITE GRADING:

- A. UNIFORMLY GRADE AREA TO BE SMOOTH SURFACE FREE FROM IRREGULAR SURFACE CHANGES. COMPLY WITH COMPACTION REQUIREMENTS AND GRADE TO CROSS SECTION, TOPO LINES AND ELEVATIONS INDICATED.
- COMPOUND SURFACE GRADES ARE TO BE SLOPED TO DIRECT WATER AWAY FROM EQUIPMENT PAD AND TOWER TO PREVENT STANDING. AND PONDING WATER
- COMPOUND SURFACE SHALL BE COMPACTED TO A 95% MAXIMUM DRY DENSITY TO ALLOW PROPER
 STERILIZATION FOR ACCESS TO ALL CUSTOMERS DENSITY TESTING MAY BE REQUIRED AT VERIZON
 WIRELESS' DISCRETION DUE TO QUESTIONABLE COMPACTION OF FINISH SURFACE GRADE OR
 SUB-GRADE
- DITCHES/SWALES AROUND THE COMPOUND AREA AND ALONG ACCESS ROAD SHALL BE CONSTRUCTED SO TO PROVIDE A SMOOTH TRANSITION BETWEEN EXISTING GRADES/SLOPE AND NEW PROPOSED GRADES
- SITE GRADING AND DRAINAGE SHOULD BE CONSTRUCTED TO PREVENT WATER FROM ENTERING THE COMPOUND SURFACE OR THE ACCESS ROAD SUB-GRADE.
- B. MOISTURE CONTROL UNIFORMLY MOISTEN OR AERATE SUB-GRADE AND EACH SUBSEQUENT FILL OR BACK FILL LAYER BEFORE COMPACTION TO WITHIN 90% OF OPTIMUM MOISTURE CONTENT. DO NOT PLACE BACK FILL OR FILL MATERIAL ON SURFACES THAT ARE MUDDY, FROZEN OR CONTAIN FROST, SNOW OR ICE.
- C. STOCKPILING MATERIAL (TOP SOIL OR FILL DIRT) SHOULD BE PLACED IN AN AREA THAT CAN BE CONTROLLED TO PREVENT WATER, SNOW, OR ICE FROM EFFECTING MOISTURE CONTENT. STOCKPILES MAY HAVE TO BE COVERED TO PREVENT ADDITIONAL MOISTURE FROM ACCUMULATING SO ACCEPTABLE BULL CAN BE LIST.
- D. <u>DE-WATERING</u> PREVENT SURFACE WATER AND SUBSURFACE OR GROUND WATER FROM ENTERING EXCAVATIONS, FROM PONDING ON PREPARED SUB-GRADE, AND FROM FLOODING PROJECT OR BUILD AREA.
- E. <u>BROJECT</u> MEASURES SHALL BE MAINTAINED THROUGHOUT THE DURATION OF THE
- ALL INLETS, DRAINS, PIPES, SWELLS, AND ROADS SHALL BE KEPT CLEAN AND FREE OF DIRT AND SILT.
- F. GEOTEXTILE FABRIC AFTER PLACEMENT AND COMPACTION OF FILL WITHIN THE WORK AREA AND BEFORE THE PLACEMENT OF LIMESTONE AGGREGATE, (SEE SITE AREA SURFACING DETAIL ON D-1), THE ENTIRE DISTURBED WORK AREA SHALL BE COVERED WITH A GEOTEXTILE FABRIC. THIS FABRIC SHALL BE "TENCATE (MIRAFI 500X) WOVEN BY ENGINEERING FABRIC" INSTALLED ACCORDING TO THE MANUFACTURERS RECOMMENDATIONS.

8. TRASH REMOVAL & SANITATION:

THE GENERAL CONTRACTOR AND VERIZON WIRELESS GENERAL CONTRACTOR (VZW GC) SHALL REMOVE ALL TRASH AS CREATED BY HIMSELF AND HIS SUBCONTRACTORS. TRASH SHALL BE REMOVED FROM THE SITE IN A TIMELY FASHION TO A LEGAL DISPOSAL AREA. THE GENERAL CONTRACTOR SHALL ALSO REMOVE ALL TRASH CREATED BY OTHER CONTRACTORS INCLUDING CABLE REELS, CARDBOARD BOXES AND PACKING. NO BURNING OR BURYING OF TRASH IS PERMITTED.

THE GENERAL CONTRACTOR SHALL PROVIDE AND MAINTAIN A PORTABLE TOILET FOR THE DURATION OF THE CONSTRUCTION PROJECT.

9 TOWE

- A. THE GENERAL CONTRACTOR SHALL VERIFY THE EQUIPMENT PAD FOUNDATION IS LOCATED CORRECTLY WITH RESPECT TO THE TOWER FOUNDATION. THE CONTRACTOR MUST NOTIFY THE ARCHITECT/ENGINEER OF ANY DISCREPANCIES PRIOR TO POURING CONC
- B. TOWER & FOUNDATION DESIGN ARE BY OTHERS FOR TOWER OWNER. PRIOR TO CONSTRUCTION THE CONTRACTOR SHALL VERIFY IN WRITING FROM TOWER OWNER THAT THE TOWER IS STRUCTURALLY SUFFICIENT TO SUPPORT ALL LOADINGS AS OUTLINED IN THESE DOCUMENTS. TOWER AND FOUNDATION DESIGN SHALL BE PERFORMED BY A LICENSED ENGINEER.
- C. THE GENERAL CONTRACTOR SHALL VERIFY THE TOP OF FOUNDATION MATCHES THE FAA APPROVAL LETTER.

10. EXCAVATION OF UTILITIES

- A. FIELD VERIFY THE LOCATION OF ANY EXISTING UNDERGROUND UTILITIES PRIOR TO EXCAVATING IN THE VICINITY OF THE SITE. ALL EXCAVATIONS SHALL BE MADE BY HAND OVER OR UNDER OR IMMEDIATELY ADJACENT TO ANY EXISTING UTILITIES & GROUNDING.
- B. ALL UTILITY COMPANIES SHALL BE NOTIFIED AT LEAST 48 HOURS PRIOR TO ANY CONSTRUCTION ON THIS PROJECT. CONTRACT UNDERGROUND UTILITY PROTECTION SERVICE BEFORE YOU DIG AT 1-800-752-6007 OR 811
- C. EXISTING UTILITIES ARE SHOWN FROM THE SURVEY AND ARE NOT NECESSARILY COMPLETE AND ACCURATE. THE CONTRACTOR SHALL BE RESPONSIBLE TO LOCATE, EXPOSE AND DETERMINE IF CONFLICTS EXIST WITH THE NEW IMPROVEMENTS. THE CONTRACTOR SHALL NOTIFY THE ENGINEER: POWER OF DESIGN GROUP, LLC IN ORDER TO RESOLVE ANY CONFLICTS.

11. CONTRACTOR'S LICENSE:

THE GENERAL CONTRACTOR, VERIZON WIRELESS GENERAL CONTRACTOR (VZW GC) AND ALL OF THEIR SUBCONTRACTORS THAT DO ANY WORK ON THIS PROJECT SHALL BE CURRENTLY LICENSED TO PERFORM WORK IN THE LOCATION OF THIS SITE. PROOF OF LICENSES SHALL BE SUPPLIED TO VERIZON WIRELESS PRIOR TO THE COMMENCEMENT OF ANY WORK.

12. SEEDING

ALL DISTURBED AREAS SHALL BE REPAIRED AND SEEDED BY THE GENERAL CONTRACTOR, UNLESS OTHERWISE NOTED. SEED DISTURBED AREAS W/4 POUNDS/1000 SQ. FT. - 60% KENTUCKY BLUEGRASS, 18% CREEPING RED FESCUE, 22% ANNUAL RYEGRASS.

13. TRAFFIC CONTROL:

THE CONTRACTOR SHALL FURNISH, INSTALL AND MAINTAIN ALL REQUIRED TRAFFIC CONTROL DEVICES IN ACCORDANCE WITH THE MANUAL OF UNIFORM TRAFFIC CONTROL DEVICES OR GOVERNING LOCAL AGENCIES.

14. CONSTRUCTION STAKIN

THE CONTRACTOR SHALL BE RESPONSIBLE FOR ALL CONSTRUCTION STAKING NEEDED TO COMPLETE ALL THE CONSTRUCTION SHOWN HEREON. CONTACT DESIGN ENGINEER TO SCHEDULE CONSTRUCTION STAKING.

- 15. THE CONTRACTOR SHALL BE RESPONSIBLE FOR ANY DAMAGE TO EXISTING PROPERTY RESULTING FROM THE CONSTRUCTION ACTIVITIES, INCLUDING BUT NOT LIMITED TO PAVEMENT, FINISHED GRADES, LANDSCAPING, BUILDINGS, SURVEY MARKERS, FIELD TILES, CULVERTS, ETC.
- 16. IN THE EVENT ANY DISCREPANCIES OR ERRORS ARE FOUND ON THESE PLANS OR ANY CONFLICT OR PROBLEMS ARE ENCOUNTERED DURING CONSTRUCTION, THE GENERAL CONTRACTOR OR VERIZON WIRELESS GENERAL CONTRACTOR (VZW GC) SHALL NOTIFY THE ENGINEER BEFORE PROCEEDING WITH THE WORK. NO ADDITIONAL COMPENSATION WILL BE PAID TO THE GENERAL CONTRACTOR OR VERIZON WIRELESS GENERAL CONTRACTOR (VZW GC) FOR WORK HAVING TO BE REDONE FOR GRADE OR GEOMETRIC DISCREPANCIES IF NOTICE TO THE ENGINEER HAS NOT BEEN PROVIDED. THE ENGINEER RESERVES THE RIGHT TO MAKE MINOR ADJUSTMENTS AS NECESSARY TO ACCOMPLISH THE INTENT OF THESE PLANS
- 17. ALL SITE WORK AND CONSTRUCTION SHALL CONFORM TO ANY AND ALL APPLICABLE CODES AND VERIZON WIRELESS STANDARDS AND SPECIFICATIONS.
- 8. ALL ELEVATIONS AND TOPOGRAPHIC INFORMATION WAS TAKEN FROM A SURVEY SUPPLIED TO POWER OF DESIGN GROUP, LLC BY POWER OF DESIGN GROUP, LLC. POWER OF DESIGN GROUP, LLC HAS NOT VERIFIED THIS INFORMATION AND DOES NOT WARRANT ANY INFORMATION SUPPLIED BY OTHERS.
- 19. THE GENERAL CONTRACTOR SHALL MAINTAIN A COMPLETE AS-BUILT SET OF PLANS AND CONDITIONS, AND SUBMIT SAME TO THE ENGINEER WITHIN 7 DAYS OF COMPLETION OF CONSTRUCTION. AS-BUILT PLANS SUBMITTED TO THE ENGINEER SHALL INCLUDE A DRAWING WITH DIMENSIONS SHOWING THE LOCATION OF THE UNDERGROUND UTILITIES, GROUNDING GRID, PLATFORM, TOWER FOUNDATION, TOWER PLATFORM ORIENTATION, AND FENCE WITHIN THE LEASE AREA OR PROPERTY AND BE CERTIFIED BY A LICENSED PROFESSIONAL SURVEYOR.
- THE GENERAL CONTRACTOR AND VERIZON WIRELESS GENERAL CONTRACTOR (VZW GC) SHALL BE RESPONSIBLE FOR NOTIFICATION OF ALL GOVERNING AGENCIES THAT REQUIRE SITE INSPECTION OF THE WORK AND/OR SIMPLY NOTIFICATION.
- 21. THE GENERAL CONTRACTOR AND VERIZON WIRELESS GENERAL CONTRACTOR (VZW GC) SHALL BE RESPONSIBLE FOR NOTIFICATION AND COORDINATION OF ALL TESTING AGENCIES THAT REQUIRE SITE INSPECTION OR TESTING OF THE WORK AS DIRECTED IN THESE PLANS, GOVERNING AGENCIES AND ALL APPLICABLE CODES.
- 22. PRIOR TO THE SUBMISSION OF BIDS, THE GENERAL CONTRACTOR AND HIS SUBCONTRACTORS SHALL VERIFY ALL DETAILS AND SCHEDULES ON THE DRAWINGS AND SPECIFICATIONS PROVIDED BY THE OWNER, FOR MEANING OF ABBREVIATIONS AND ADDITIONAL REQUIREMENTS AND INFORMATION. CHECK ALL CONSTRUCTION DOCUMENTS TO INCLUDE, BUT NOT LIMITED TO, GEOTECHNICAL REPORT, STRUCTURAL ANALYSIS, TOWER, MECHANICAL AND ELECTRICAL DRAWINGS, FOR SCALE, SPACE LIMITATIONS, DOOR SWINGS, ADJACENT CARRIER EQUIPMENT COORDINATION AND ADDITIONAL INFORMATION, ETC. REPORT ANY DISCREPANCIES, CONFLICTS, ETC. TO THE OWNER BEFORE SUBMITTING BIDS.

23. WORK SITE SAFETY:

- A. CONSTRUCTION WORK PRESENTS UNIQUE THREATS TO HEALTH AND SAFETY. THE CONTRACTOR AND VERIZON WIRELESS CONTRACTOR (VZW GC) ARE RESPONSIBLE TO EDUCATE THEIR WORK FORCE OF THESE DANGERS AND LIMIT THEIR EXPOSURE TO HAZARDS. THIS EDUCATION SHALL INCLUDE BUT NOT BE LIMITED TO APPLICABLE TRAINING COURSES AND CERTIFICATIONS, PROPER PERSONAL PROTECTIVE EQUIPMENT USAGE, DAILY TAILGATE MEETINGS AND ANY OTHER PREVENTATIVE MEASURES WHICH MAY BE REASONABLY EXPECTED. THE CONTRACTOR, VERIZON WIRELESS CONTRACTOR (VZW GC) AND ALL SUB-CONTRACTORS SHALL BE RESPONSIBLE FOR THE SAFETY OF THE WORK AREA, ADJACENT AREAS AND ANY PROPERTY OCCUPANTS WHO MAY BE AFFECTED BY THE WORK UNDER CONTRACT. ALL CONTRACTORS SHALL REVIEW ALL LANDOWNER, PRIME CONTRACTOR, CARRIER, OSHA, AND LOCAL SAFETY GUIDELINES AND AT ALL TIMES SHALL CONFORM TO THE MOST RESTRICTIVE OF THESE STANDARDS TO ENSURE A SAFE WORKPLACE.
- B. TOWER WORK PRESENTS ADDITIONAL THREATS TO HEALTH AND SAFETY. ALL TOWER WORKERS WORKING ON A TOWER MUST BE ADEQUATELY TRAINED AND MONITORED TO ENSURE THAT SAFE WORK PRACTICES ARE LEARNED AND FOLLOWED. AS REQUIRED BY OSHA, WHEN WORKING ON EXISTING COMMUNICATION TOWERS, EMPLOYEES MUST BE PROVIDED WITH APPROPRIATE FALL PROTECTION, TRAINED TO USE THIS FALL PROTECTION PROPERLY, AND THE USE OF FALL PROTECTION MUST BE CONSISTENTLY SUPERVISED AND ENFORCED BY THE CONTRACTOR.
- C. ALL SAFETY EQUIPMENT SHALL BE INSPECTED ACCORDING TO ALL OSHA AND INDUSTRY SCHEDULED INTERVALS AND ALL INSPECTIONS SHALL BE DOCUMENTED PER APPLICABLE CODES AND STANDARDS.



1-800-752-6007

PER KENTUCKY STATE LAW, IT IS AGAINST
THE LAW TO EXCAVATE WITHOUT
NOTIFYING THE UNDERGROUND
LOCATION SERVICE TWO (2) WORKING
DAYS BEFORE COMMENCING WORK.





820 MORRIS TURNPIKE - STE 104 SHORT HILLS, NJ 07078

02/22/2022



EN PERMIT: 3594

CONSTRUCTION DRAWINGS

	21011111100						
REV.	DATE	DESCRIPTION					
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3	1.21.22	TOWER REPLACEMENT					
4	2.21.22	CORRECTED COORDS					

SITE INFORMATION: FULTON, KY

(CRUTCHFIELD)

FULTON, KY 42041 FULTON COUNTY

AMOND COMMUNICATIONS SITE NUMBER

KY007

VERIZON WIRELESS SITE NAME

EV CRUTCHFIELD

POD NUMBER: 21-11822.

DRAWN BY: CHECKED BY:

CHECKED BY: MEP DATE: 01.17.17


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SHEET TITLE:

GENERAL SITE CONSTRUCTION NOTES

SHEET NUMBER:

C-6

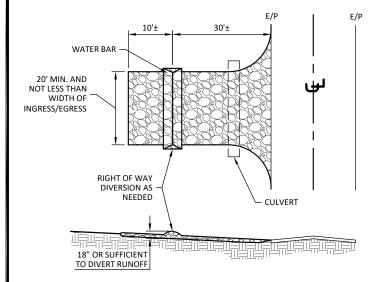

NOTES:


- STONE SIZE NO. 2 STONE SHALL BE USED, OR RECYCLED CONCRETE EQUIVALENT.
- THE CONSTRUCTION ENTRANCE SHALL COINCIDE WITH THE PROPOSED DRIVE AS SHOWN ON THE PLAN.
- PAVEMENT THICKNESS STONE LAYER SHALL BE AT LEAST 6" THICK DRIVEWAY WIDTH - THE ENTRANCE SHALL BE AT LEAST 10' WIDE, BUT NOT
- LESS THAN FULL WIDTH AT POINTS WHERE INGRESS/EGRESS OCCURS. BEDDING - A GEOTEXTILE SHALL BE PLACED OVER THE ENTIRE AREA PRIOR
- TO PLACING STONE. IT SHALL HAVE A GRAB TENSILE STRENGTH OF AT LEAST 200 LBS, AND A MULLEN BURST STRENGTH OF AT LEAST 190 LBS.
- CULVERT A PIPE OR CULVERT SHALL BE CONSTRUCTED UNDER THE ENTRANCE IF NEEDED TO PREVENT SURFACE WATER FLOWING ACROSS THE ENTRANCE FROM BEING DIRECTED OUT ONTO PAVED SURFACES.
- WATER BAR A WATER BAR SHALL BE CONSTRUCTED AS PART OF THE CONSTRUCTION ENTRANCE IF NEEDED TO PREVENT SURFACE RUNOFF FROM FLOWING THE LENGTH OF THE CONSTRUCTION ENTRANCE AND OUT ONTO PAVED SURFACES.
- MAINTENANCE TOP DRESSING OF ADDITIONAL STONE SHALL BE APPLIED AS CONDITIONS DEMAND, MUD SPILLED, DROPPED, WASHED OR TRACKED ONTO PUBLIC ROADS, OR ANY SURFACE WHERE RUNOFF OS NOT CHECKED BY SEDIMENT CONTROLS, SHALL BE REMOVED IMMEDIATELY, REMOVAL SHALL BE ACCOMPLISHED BY SCRAPING OR SWEEPING.
- CONSTRUCTIONS ENTRANCES SHALL NOT BE RELIED UPON TO REMOVE MUD FROM VEHICLES AND PREVENT OFF SITE TRACKING. VEHICLES THAT ENTER AND LEAVE THE CONSTRUCTION SHALL BE RESTRICTED FROM MUDDY AREAS






1-800-752-6007

PER KENTUCKY STATE LAW, IT IS AGAINST THE LAW TO EXCAVATE WITHOUT NOTIFYING THE UNDERGROUND LOCATION SERVICE TWO (2) WORKING DAYS BEFORE COMMENCING WORK.

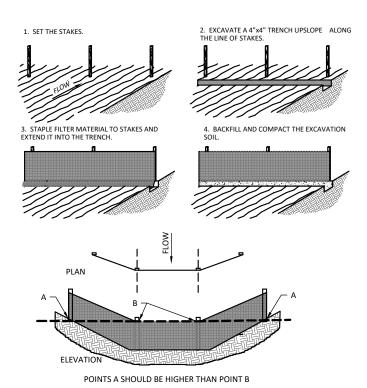



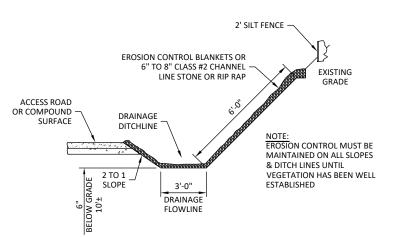

- WHEN FACED WITH SLOPES LESS THAN 2 TO 1 SLOPES, ALL SLOPES SHOULD BE DOZER TRACKED PRIOR TO SEEDING. ALL SLOPES SHOULD HAVE EROSION CONTROL BLANKETS OR RIP RAP EMBEDDED ON SLOPES SURFACES TO REDUCE
- ALL FLOWLINES MUST BE INSTALLED BELOW SUB-GRADE OF COMPOUND. (AT MINIMUM OF 6" BELOW)

DRAINAGE DITCHLINE DETAIL (SWALE)



EROSION & SEDIMENT CONTROL NOTES

- 1. ALL WORK SPECIFIED AS A/AN DOT ITEM SHALL BE GOVERNED BY THE STATE OF KENTUCKY OF DEPARTMENT OF TRANSPORTATION CONSTRUCTION AND MATERIAL SPECIFICATION HANDBOOK. IT IS CONTRACTORS RESPONSIBILITY TO POSSESS AND BE FAMILIAR WITH APPLICABLE SECTIONS
- THIS CONTRACT DRAWING SHALL BE MADE AVAILABLE ON SITE AT ALL TIMES AND PRESENTED UPON REQUEST. IF UNFORESEEN STORM WATER POLLUTION PREVENTION IS ENCOUNTERED, ADDITIONAL STORM WATER POLLUTION PREVENTION (SWPP) MEASURES MAY BE REQUESTED BY THE OWNER, COUNTY ENGINEER, PROJECT ENGINEER OR SOIL CONSERVATION SERVICE REPRESENTATIVE AT ANYTIME. SUCH REQUESTS SHALL BE IMPLEMENTED IMMEDIATELY AT CONTRACTOR'S EXPENSE.
- ALL STORM WATER POLLUTION PREVENTION ITEMS SHALL BE INSTALLED AS SHOWN OR NOTED ON THIS SHEET.
- PLANT TEMPORARY SEEDING AND MULCHING IN ALL AREAS THAT SHALL BE INACTIVE FOR 7 DAYS OR MORE. ALL DISTURBED AND ERODED EARTH SHALL BE REGRADED AND SEEDED WITHIN 14 DAYS WITH SEEDING, AS DEFINED ABOVE AND AS SHOWN ON THE TABLE BELOW. TO ESTABLISH STABILITY AND PROVIDE SEDIMENT CONTROL. WHERE POSSIBLE. TEMPORARY SEEDING GROWTH SHALL NOT BE MOWED UNTIL IT HAS GONE TO SEED FOR 1

JAN. FEB. MAR. APR. MAY JUN. JUL. AUG. SEP. OCT. NOV. DEC.

PERMANENT SEEDINGS		Α			-*	-*-		
DORMANT SEEDINGS	В	ł					В-	ľ
TEMPORARY SEEDINGS		J		-D-		1		
SODDING		E**-				ļ		
MULCHING	Ļ							ı

A. KENTUCKY BLUEGRASS 90 LBS./AC/MIXED BLUEGRASS) 150 LBS./ACRE

PERENNIAL RYEGRASS 30 LBS./ACRE

B. KENTUCKY BLUEGRASS 135 LBS./AC/MIXED PERENNIAL RYEGRASS 45 LBS./AC. 2 TON STRAW MULCH PER ACRE

C. SPRING OATS 100 LBS./ACRE

D. WHEAT OR CEREAL RYE 150 LBS./ACRE E. SOD (NURSERY CROWNA KENTUCKY)

- F. STRAW MULCH 2 TONS PER ACRE
- * IRRIGATION NEEDED DURING JUNE, JULY & SEPTEMBER
- ** IRRIGATION NEEDED FOR 2-3 WEEKS AFTER SODDING
- PERMANENT VEGETATION SHALL BE INSTALLED WITHIN 10 DAYS AT THE COMPLETION OF ANY GRADED AREAS,
- WEATHER PERMITTING. ALL PERMANENT VEGETATION SHALL CONSIST OF PLANTING AND SOD AT SUCH TIME ROUGH GRADING OF THE SITE IS COMPLETE AND DRAINAGE DIVERTS TO INLETS, INLET SEDIMENT FILTERS SHALL BE INSTALLED AT ALL INLET STRUCTURES TO KEEP PIPING SYSTEMS FREE OF SILTATION
- SILT BARRIERS SHALL BE INSTALLED AROUND ALL EXISTING OR NEW STORM INLETS, CATCH BASINS, AND YARD DRAINS. INSTALL ROCK CHECK DAMS FOR HEADWALL INLETS FOR STORM WATER POLLUTION PREVENTION.
- STORM WATER POLLUTION PREVENTION MEASURES SHALL BE INSTALLED OR TOPSOIL STOCKPILES AND OTHER TEMPORARILY DISTURBED AREAS AS SHOWN ON THESE PLANS AND AS DIRECTED BY THE ENGINEER.
- CONTRACTOR SHALL INSPECT ALL SWPP MEASURES DAILY AND REPAIR AS NECESSARY TO PREVENT FROSION SILTATION SHALL BE REMOVED FROM AREAS WHERE FAILURES HAVE OCCURRED AND CORRECTIVE ACTION TAKEN WITHIN 24 HOURS TO MAINTAIN ALL SWPP.
- 10. SILT BARRIERS, CONSTRUCTION ENTRANCES, AND SILT FENCES SHALL REMAIN IN PLACE UNTIL A GOOD STAND OF GRASS HAS BEEN OBTAINED AND/OR PAVING OPERATIONS ARE COMPLETE. CONTRACTOR SHALL KEEP SILT FROM ENTERING ANY STORM DRAINAGE SYSTEM. ONCE SITE HAS BEEN COMPLETELY STABILIZED, ANY SILT IN PIPES AND DRAINAGE SWALES SHALL BE REMOVED WITHIN 10 DAYS.
- 11. TEMPORARY SEDIMENTATION AND STORM WATER POLLUTION PREVENTION MEASURES MUST BE INSPECTED
- AND LOGGED BY THE CONTRACTOR FOR INSPECTION, LOGGING SHALL BE WEEKLY AND AFTER RAIN STORMS.

 12. UTILITY COMPANIES MUST COMPLY WITH ALL STORM WATER POLLUTION PREVENTION MEASURES AS DEFINED. ON THE STORM WATER PREVENTION PLANS, DETAILS AND NOTES.
- 13. ALL EXISTING WATER COURSES WITHIN THE PROJECT LIMITS SHALL BE TEMPORARILY PROTECTED DURING LAND CLEARING AND GRADING OPERATIONS. SOILS WITHIN 50 FEET OF SAID WATER COURSES SHALL BE STABILIZED WITHIN 2 DAYS OF THE INITIAL CLEARING / GRADING OPERATION AS SHOWN ON PLANS.

 14. ALL DISTURBED AREAS SHALL BE STABILIZED WITHIN 7 DAYS OF FINAL GRADING.
- 15. IT IS THE CONTRACTOR'S RESPONSIBILITY TO MAINTAIN ALL SEDIMENTATION AND STORM WATER POLLUTION PREVENTION ITEMS AT ALL TIMES.
- 16. ALL STORM WATER POLLUTION PREVENTION PRACTICES WILL BE INSTALLED BEFORE ANY OTHER EARTH MOVING OCCURS
- 17. THE FOLLOWING STORM WATER POLLUTION PREVENTION AND SEDIMENT CONTROL MEASURES WILL BE USED ON THIS SITE:
 - 1 SILT BARRIERS
 - 2. SILT FENCE
 - 3. CONSTRUCTION ENTRANCE
 - 4. EROSION CONTROL SEED BLANKETS SPEC FOR TEMPORARY EROSION CONTROL BLANKETS ON

CONSTRUCTION SEQUENCE

- STAKE AND/OR FLAG LIMITS OF CLEARING
- DURING PRECONSTRUCTION MEETING ALL EROSION & SEDIMENT CONTROL FACILITIES & PROCEDURES SHALL BE DISCUSSED.
- CLEARING & GRUBBING, AS NECESSARY, FOR INSTALLATION OF PERIMETER CONTROLS.
- INSTALL SILT FENCE PERIMETER CONTROLS AS SHOWN ON PLANS.
- INSTALL CONSTRUCTION ENTRANCE IF CONDITIONS ARE SUCH THAT MUD IS COLLECTION ON VEHICLE TIRES. THE TIRES MUST BE CLEANED BEFORE THE VEHICLES ENTER THE PUBLIC ROADWAY. THE SITE ENTRANCE SHALL BE MAINTAINED IN A CONDITION THAT WILL PREVENT THE TRACKING OR FLOW OF MUD INTO THE PUBLIC RIGHT-OF-WAY. ALL MATERIALS SPILLED, DROPPED, WASHED OR TRACKED FROM VEHICLES ONTO THE ROADWAY MUST BE REMOVED PROMPTLY.
- CLEARING & GRUBBING THE REMAINING SITE AS NECESSARY.
- BEGIN FILLING & GRADING AS REQUIRED TO REACH SUBGRADE.
- CONSTRUCT AND MAINTAIN TEMPORARY DRAINAGE SWALES DURING FILLING AND GRADING ACTIVITIES.
- CONSTRUCT SITE WORK INCLUDING STORM DRAINAGE FACILITIES.
- 10. MAINTAIN EROSION & SEDIMENTATION CONTROL MEASURES UNTIL THE SITE HAS BEEN COMPLETELY STABILIZED
- 11. REMOVE SEDIMENT CONTROLS.





820 MORRIS TURNPIKE - STE 104 SHORT HILLS. NJ 07078

02/22/2022



EN PERMIT: 3594

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)	2	1.31.20	UPDATED STANDARDS
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	4	2.21.22	CORRECTED COORDS

SITE INFORMATION: FULTON, KY (CRUTCHFIELD)

1311 CLINTON MOSCOW RD **FULTON, KY 42041 FULTON COUNTY**


AMOND COMMUNICATIONS SITE NUMBE KY007

VERIZON WIRELESS SITE NAME EV CRUTCHFIELD

POD NUMBER 21-11822

DRAWN BY POD CHECKED BY 01.17.17

BEST MANAGEMENT **PRACTICES & EROSION CONTROL** DETAILS AND NOTES

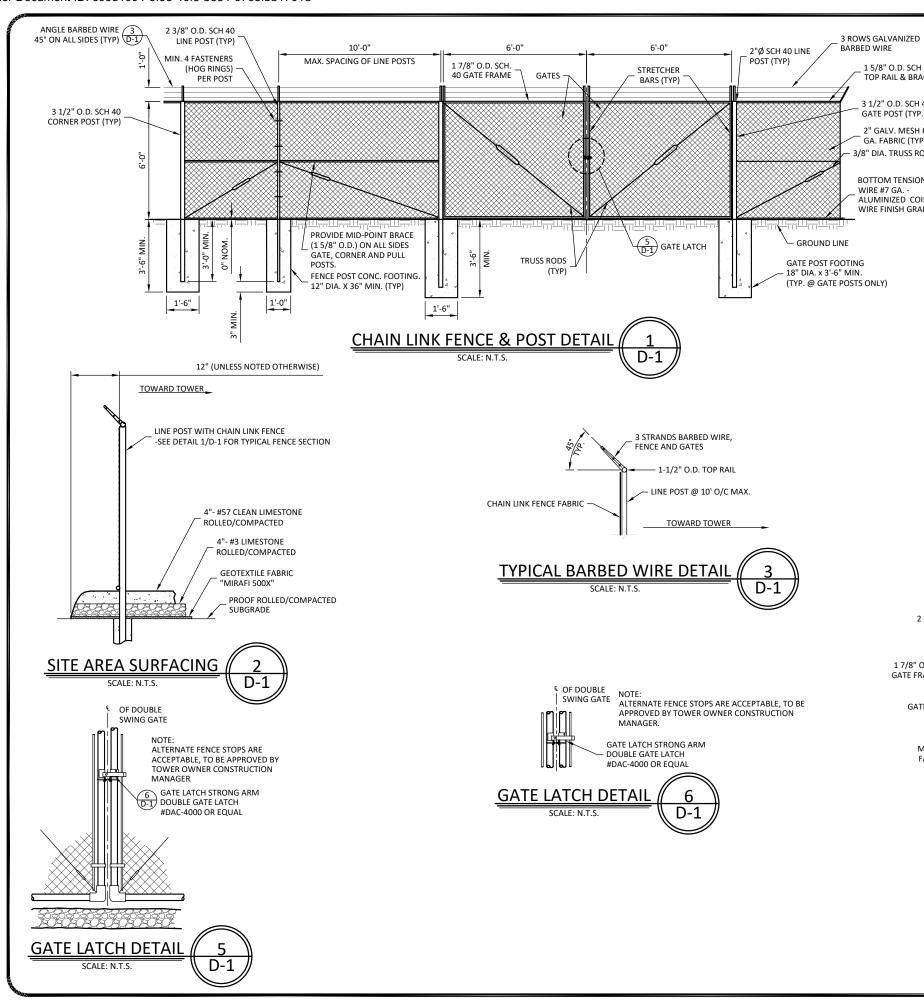

CHAIN LINK FENCING NOTES

- 1. ALL FENCE AND FABRIC SHALL BE HOT DIPPED GALVANIZED WITH A MINIMUM OF 2 OZ. PER SQUARE FOOT, 9 GAUGE WIRE (MIN. BREAKING STRENGTH OF 1,290 LBS) WITH 2" MESH. ALL BARBED WIRE SHALL BE ALUMINUM OR COATED PER NOTE #4.
- 2. BOTTOM EDGE OF FENCE FABRIC SHALL EXTEND TO FINISHED GRADE.
- 3. SITE FENCE SHALL BE 6'-0" FABRIC W/ 3 STRAND BARBED WIRE FOR TOTAL HEIGHT
- 4. BARBED WIRE SHALL MEET ASTM A 121, CLASS 3 GALV. OR ASTM A 585, TYPE I, CLASS 2 COATING (NOT LESS THAN 0.8 OZ. PER SQ. FT.) AND SHALL BE THREE STRAND 12.5 GAGE w/4 POINT BARBS AT 5" O/C.
- 5. BOTTOM OF CONCRETE BASE SHALL BE SET BELOW FROSTLINE (SEE LOCAL CODE). WHERE SOIL BEARING CAPACITY IS LESS THAN 2000 PSF, INCREASE CONCRETE SURROUNDING FENCE POST FOUNDATION DIAMETERS BY 8", PROVIDE CONCRETE WITH A 28 DAY STRENGTH OF 3000 PSI (MIN.)
- PROVIDE A DIAGONAL BRACE ROD AND TURN BUCKLE ON BOTH GATE LEAFS.
- ALL RAILS AND BRACES SHALL BE SCHEDULE 40 STEEL PIPE, AND ALL FENCE POSTS SHALL BE SCHEDULE 40 STEEL PIPE, AND BE 2 OZ. GALVANIZED COATED.
- 8. CONTRACTOR SHALL ENSURE ALL POSTS ARE PLUMB.

1 5/8" O.D. SCH 40

TOP RAIL & BRACE

3 1/2" O.D. SCH 40

GATE POST (TYP.)

2" GALV, MESH #9 GA. FABRIC (TYP)


BOTTOM TENSION WIRF #7 GA -


ALUMINIZED COIL

WIRE FINISH GRADE

3/8" DIA. TRUSS ROD (TYP)

- ALL FENCE SHALL BE FABRICATED AND INSTALLED PER ASTM F2611-15. ASTM F567-14a AND CHAIN LINK FENCE MANUFACTURES INSTITUTE CLFMI-PM 2445.
- 10. CONTRACTOR SHALL FURNISH AND INSTALL ONE (1) MASTER LOCK LONG SHANK #175LH COMBINATION PADLOCK. COMBINATION TO BE SET AT 7011.

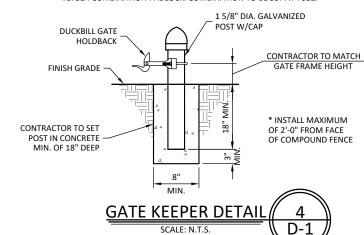

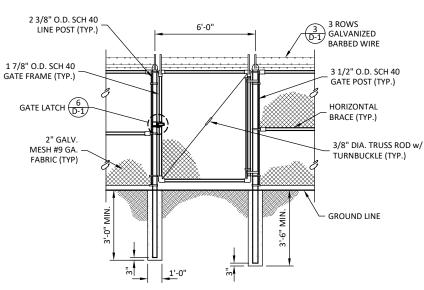







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1311 CLINTON MOSCOW RD FULTON, KY 42041 FULTON COUNTY


AMOND COMMUNICATIONS SITE NUMBE KY007


VERIZON WIRELESS SITE NAME: EV CRUTCHFIELD

POD NUMBER 21-118223 DRAWN BY POD CHECKED BY: DATE: 01.17.17


SHEET TITLE:

FENCE DETAILS AND **NOTES**

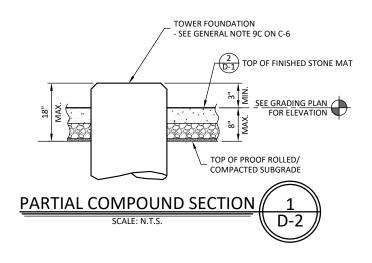

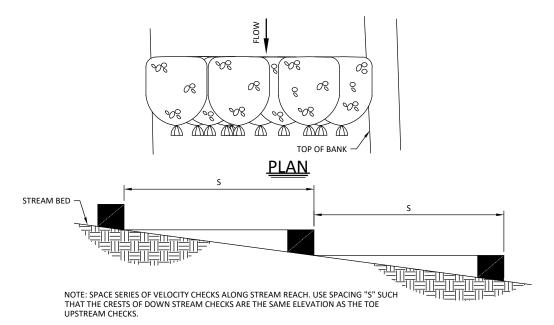

VELOCITY CHECK SPACING

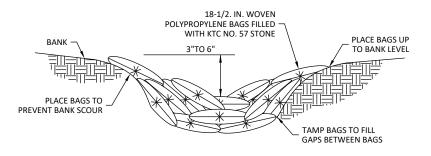

*NOTE: STRAW BALES MAY BE USED IN LIEU OF STONE BAGS

CROSS SECTION STONE BAG SILT CHECK DETAIL SCALE: N.T.S.





820 MORRIS TURNPIKE - STE 104 SHORT HILLS, NJ 07078

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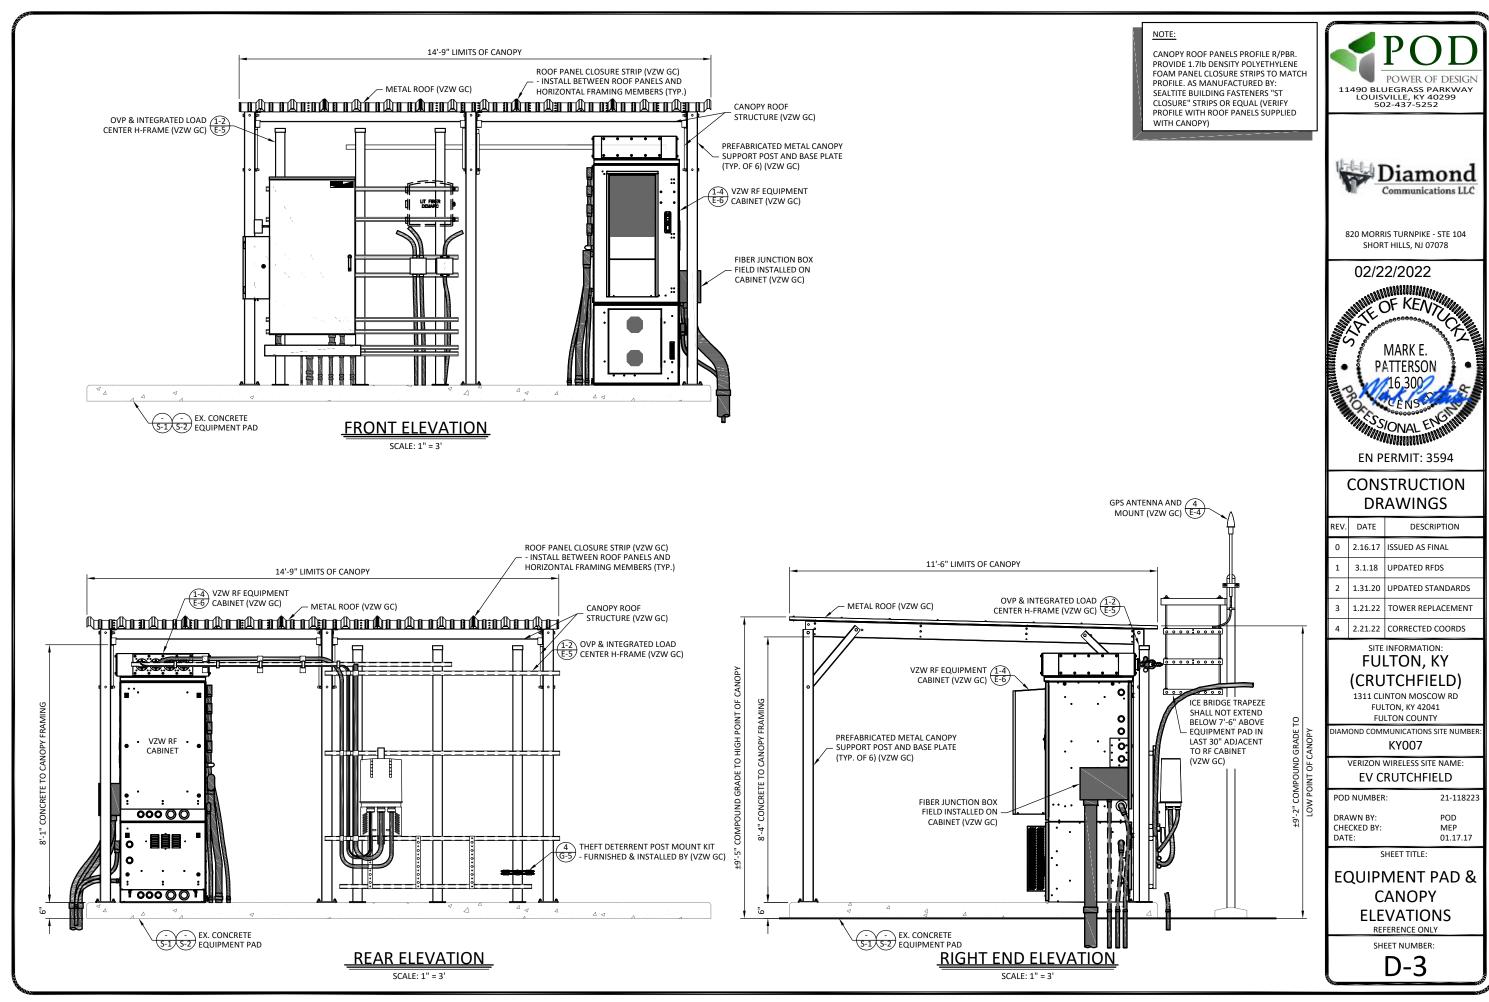
VERIZON WIRELESS SITE NAME: EV CRUTCHFIELD

21-118223 POD NUMBER:

DRAWN BY: POD CHECKED BY: DATE: 01.17.17

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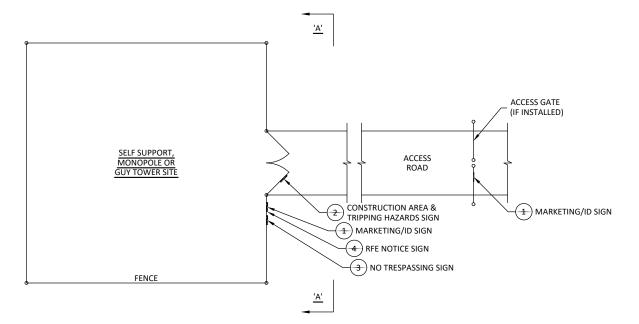
SITE DETAILS



NOTES:


CAUTION - RFE SIGN (BLACK, YELLOW, WHITE) TO BE MOUNTED NEAR TOWER LEG W/CLIMBING CABLE. DO NOT RESTRICT CLIMBING ACCESS.


VERIZON WIRELESS SITE ID SIGN, RFE SIGNS, NOC INFORMATION SIGN AND ALL OTHER SIGNAGE NOT REFERENCED IN THIS DRAWING WILL BE FURNISHED AND INSTALLED BY VERIZON WIRELESS PERSONELL PER VERIZON WIRELESS RFC SIGNAGE & DEMARCATION POLICY.



TYPICAL SITE FENCE SIGNAGE PLAN


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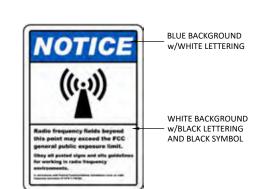


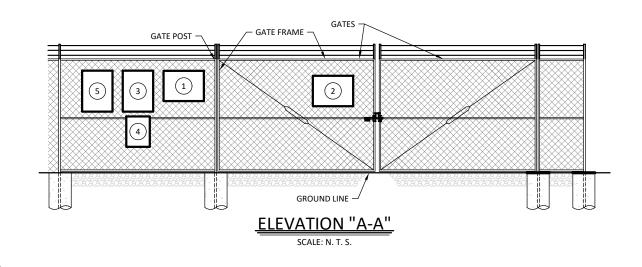

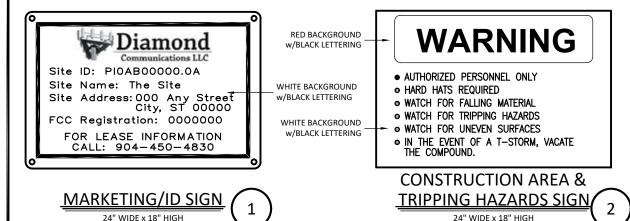





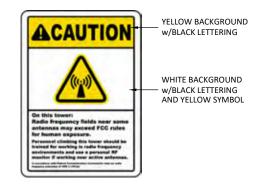

RFE NOTICE SIGN







820 MORRIS TURNPIKE - STE 104 SHORT HILLS, NJ 07078

MARK E.
PATTERSON
16 300

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EN PERMIT: 3594

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(CRUTCHFIELD) 1311 CLINTON MOSCOW RD FULTON, KY 42041

FULTON, KY 42041
FULTON COUNTY

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VERIZON WIRELESS SITE NAME:

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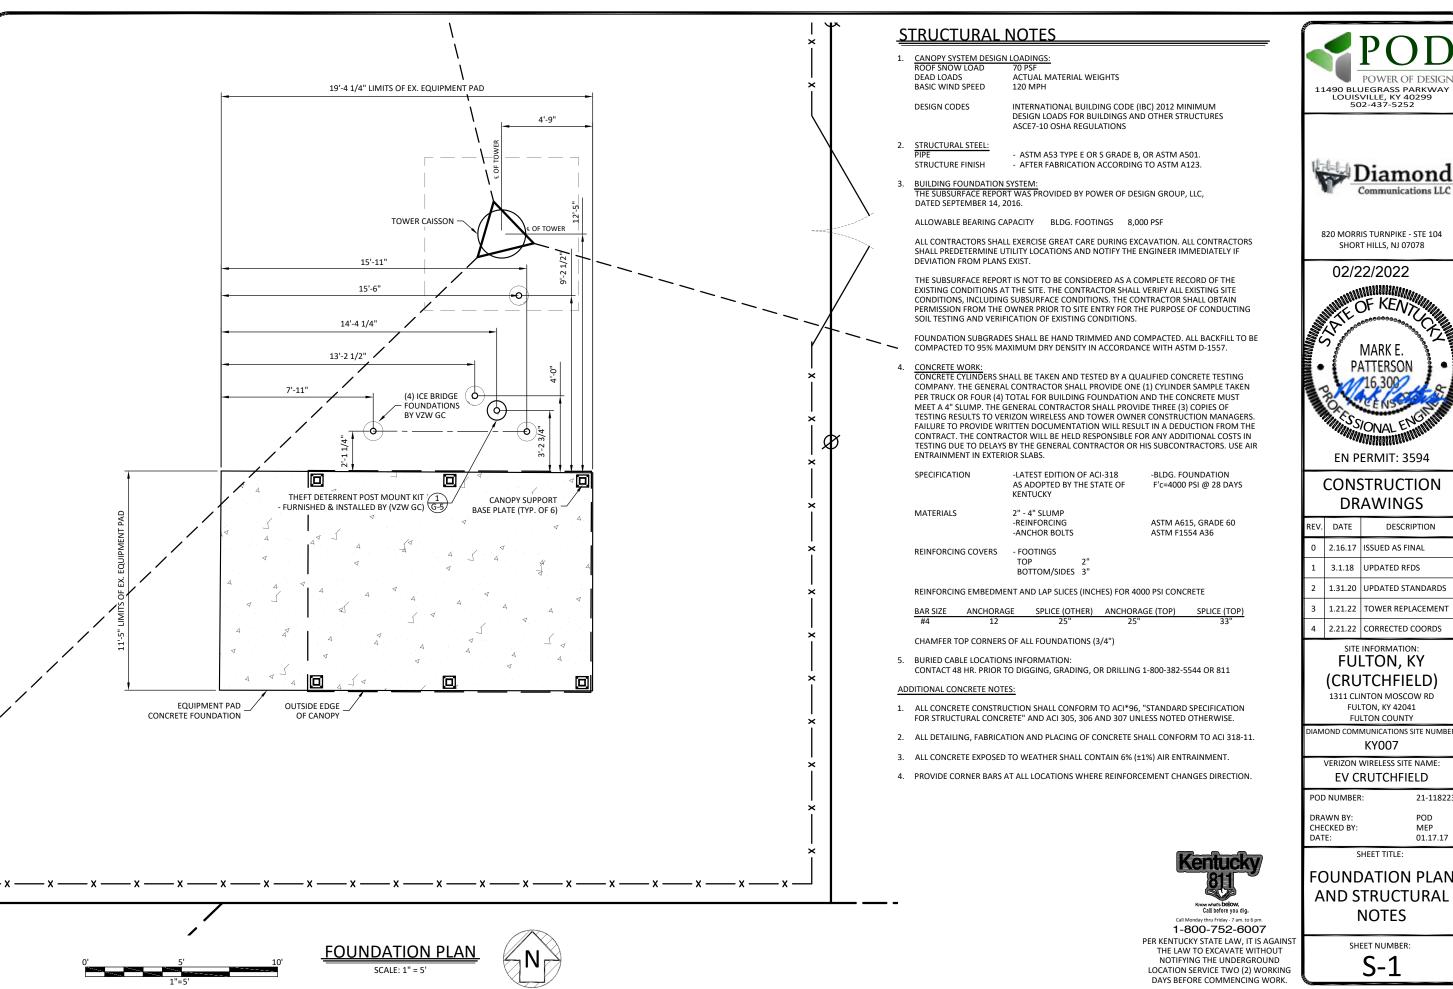
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SITE FENCE SIGNAGE

REFERENCE ONLY

SHEET NUMBER:

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Communications LLC

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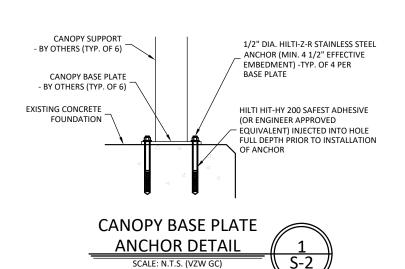
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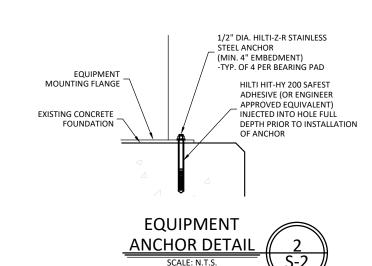
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01.17.17

POD

DESCRIPTION









820 MORRIS TURNPIKE - STE 104 SHORT HILLS, NJ 07078

02/22/2022



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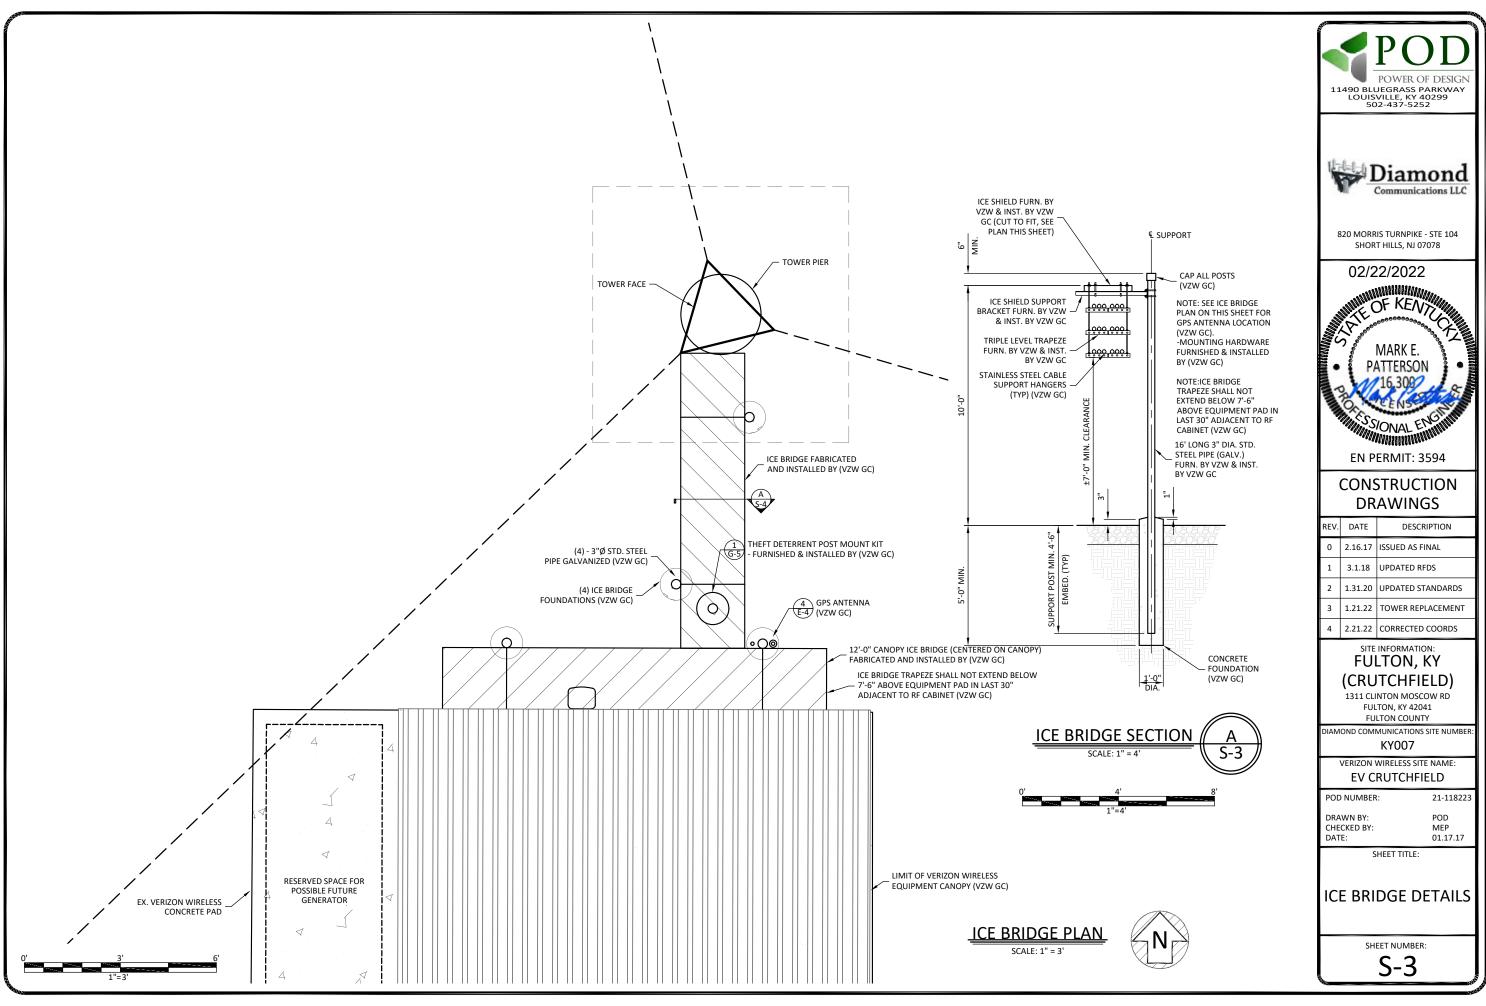
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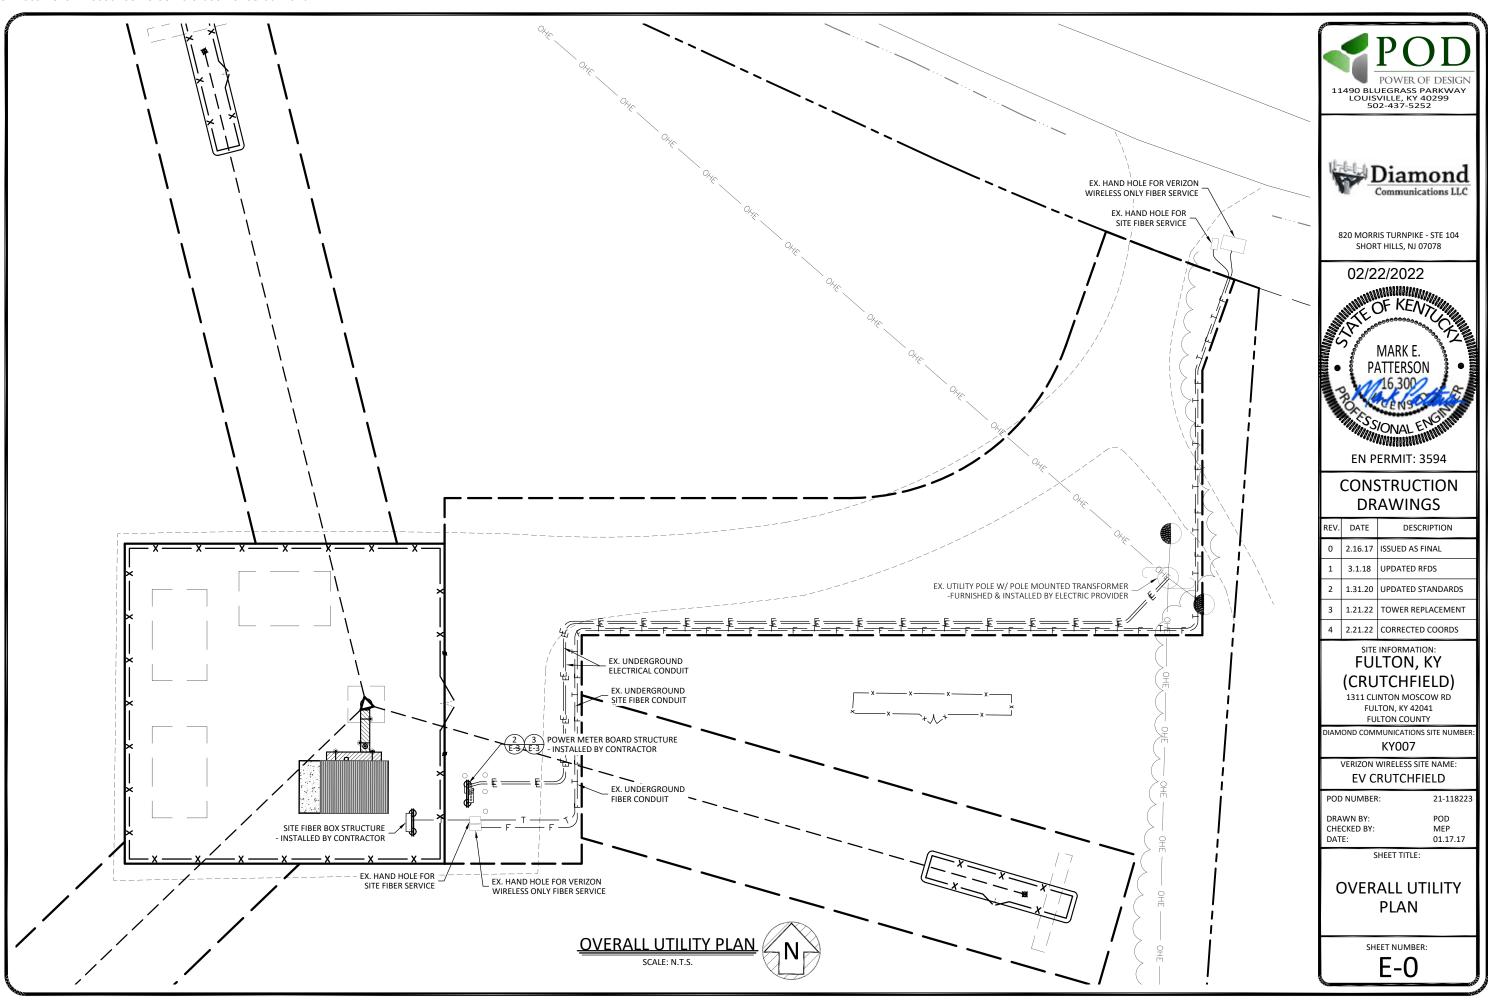
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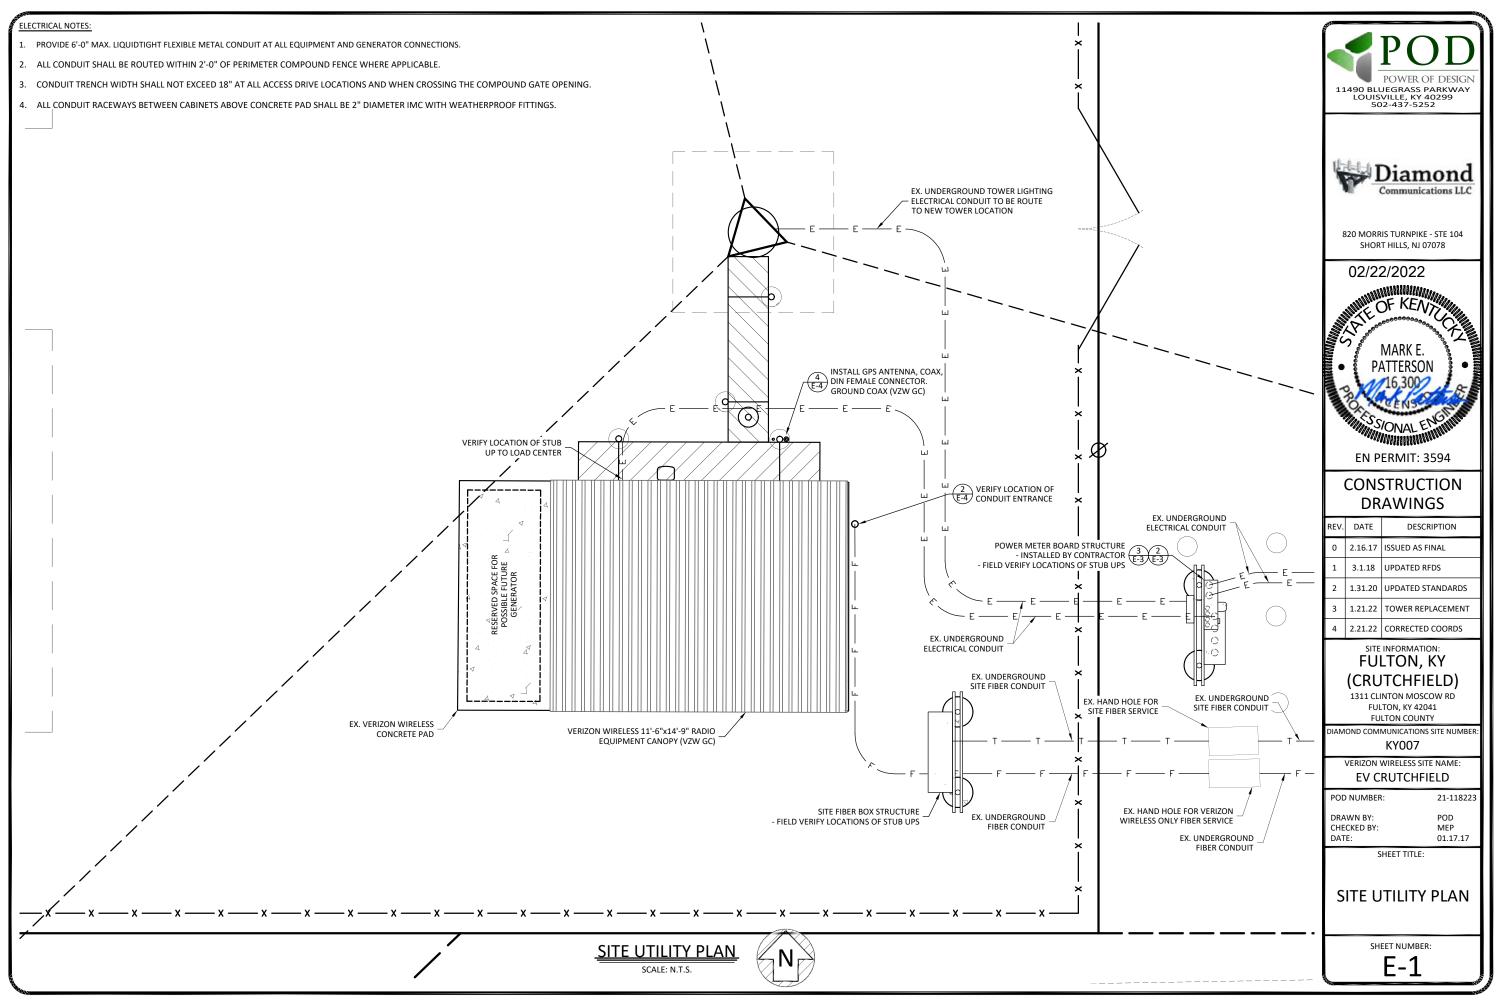
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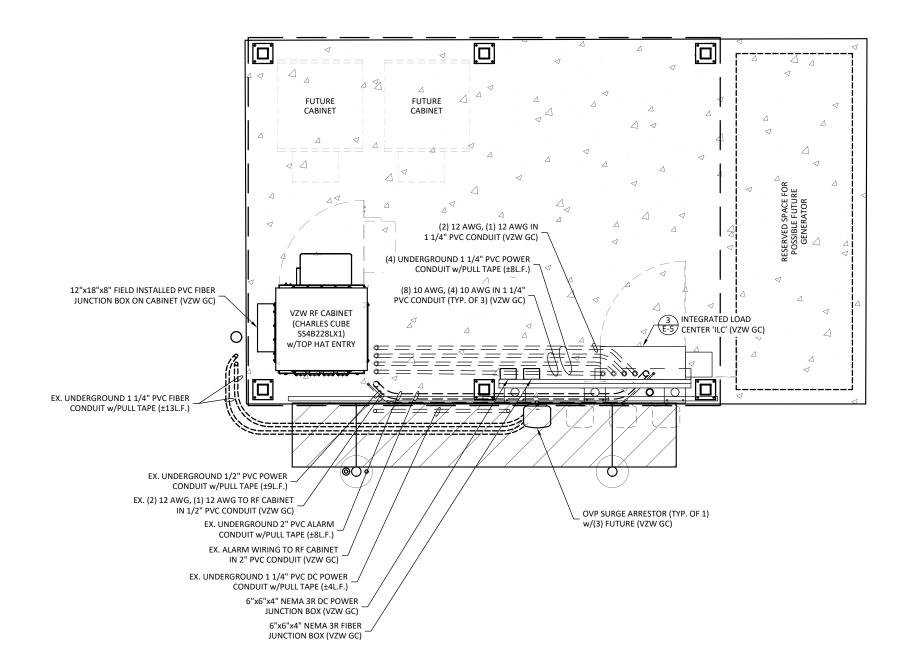
SHEET TITLE:

FOUNDATION DETAILS













NOTE: FIELD VERIFY LOCATIONS OF STUB UPS





820 MORRIS TURNPIKE - STE 104 SHORT HILLS, NJ 07078

02/22/2022



EN PERMIT: 3594

CONSTRUCTION DRAWINGS

ı			
ı	REV.	DATE	DESCRIPTION
	0	2.16.17	ISSUED AS FINAL
١	1	3.1.18	UPDATED RFDS
	2	1.31.20	UPDATED STANDARDS
	3	1.21.22	TOWER REPLACEMENT
	4	2.21.22	CORRECTED COORDS

SITE INFORMATION: FULTON, KY

(CRUTCHFIELD)

1311 CLINTON MOSCOW RD FULTON, KY 42041 FULTON COUNTY

DIAMOND COMMUNICATIONS SITE NUMBER

KY007

VERIZON WIRELESS SITE NAME: EV CRUTCHFIELD

POD NUMBER: 21-118223


DRAWN BY: POD CHECKED BY: MEP DATE: 01.17.17

SHEET

EQUIPMENT PAD UTILITY PLAN & EQUIPMENT PAD TRENCH SECTIONS

SHEET NUMBER:

E-2

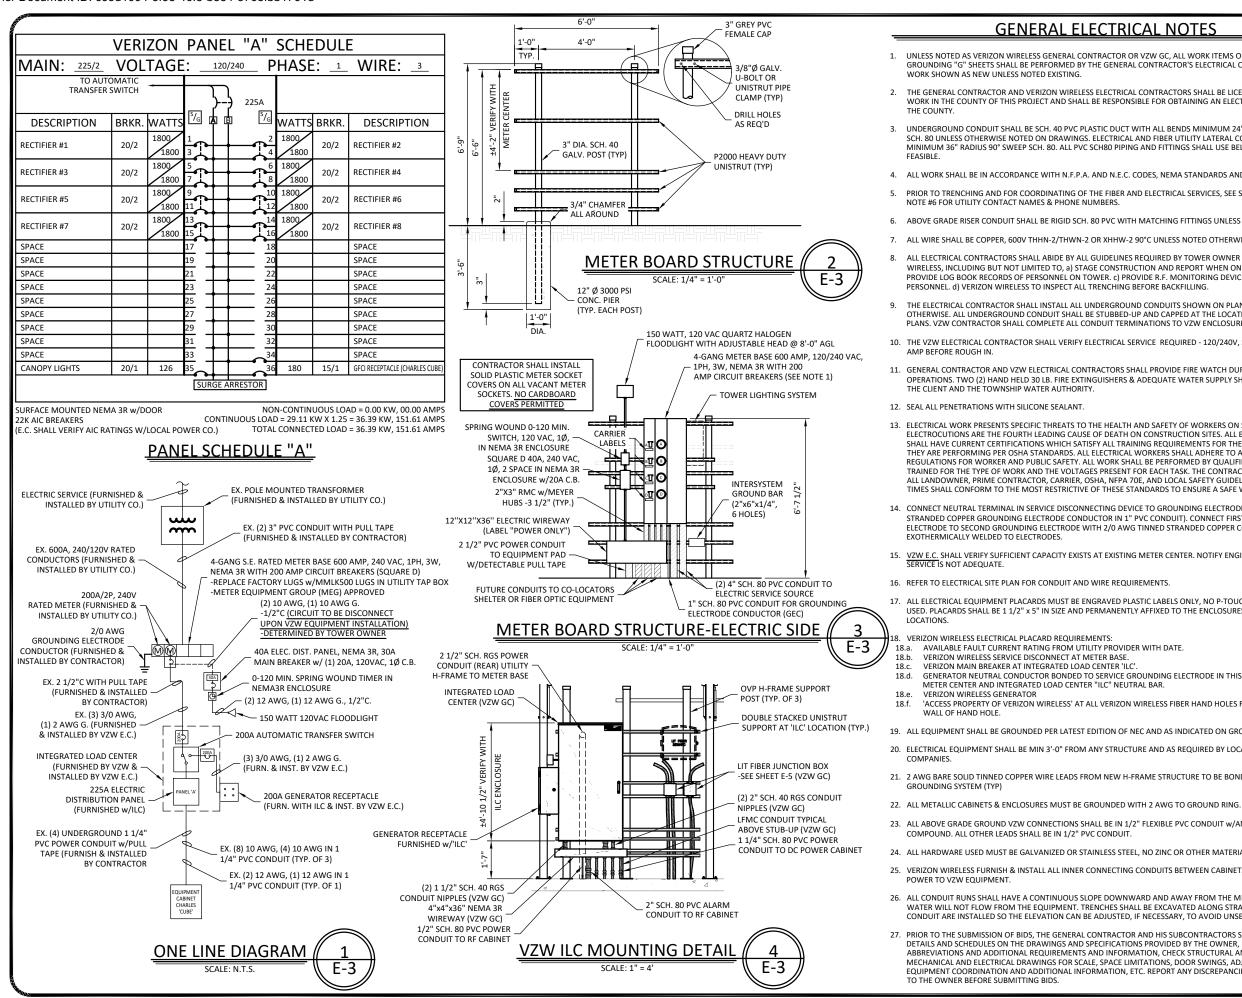

GENERAL ELECTRICAL NOTES

- UNLESS NOTED AS VERIZON WIRELESS GENERAL CONTRACTOR OR VZW GC. ALL WORK ITEMS ON ELECTRICAL "E" & GROUNDING "G" SHEETS SHALL BE PERFORMED BY THE GENERAL CONTRACTOR'S ELECTRICAL CONTRACTOR. ALL WORK SHOWN AS NEW UNLESS NOTED EXISTING.
- THE GENERAL CONTRACTOR AND VERIZON WIRELESS ELECTRICAL CONTRACTORS SHALL BE LICENSED TO PERFORM WORK IN THE COUNTY OF THIS PROJECT AND SHALL BE RESPONSIBLE FOR OBTAINING AN ELECTRICAL PERMIT FROM
- UNDERGROUND CONDUIT SHALL BE SCH. 40 PVC PLASTIC DUCT WITH ALL BENDS MINIMUM 24" RADIUS 90° SWEEP SCH. 80 UNLESS OTHERWISE NOTED ON DRAWINGS. ELECTRICAL AND FIBER UTILITY LATERAL CONDUITS SHALL BE MINIMUM 36" RADIUS 90° SWEEP SCH. 80. ALL PVC SCH80 PIPING AND FITTINGS SHALL USE BELL END WHERE
- 4. ALL WORK SHALL BE IN ACCORDANCE WITH N.F.P.A. AND N.E.C. CODES, NEMA STANDARDS AND ALL LOCAL CODES.
- PRIOR TO TRENCHING AND FOR COORDINATING OF THE FIBER AND ELECTRICAL SERVICES. SEE SHEET C-6 GENERAL
- 6. ABOVE GRADE RISER CONDUIT SHALL BE RIGID SCH. 80 PVC WITH MATCHING FITTINGS UNLESS NOTED OTHERWISE.
- ALL WIRE SHALL BE COPPER, 600V THHN-2/THWN-2 OR XHHW-2 90°C UNLESS NOTED OTHERWISE.
- ALL ELECTRICAL CONTRACTORS SHALL ABIDE BY ALL GUIDELINES REQUIRED BY TOWER OWNER AND VERIZON WIRELESS, INCLUDING BUT NOT LIMITED TO, a) STAGE CONSTRUCTION AND REPORT WHEN ON AND OFF THE SITE, b PROVIDE LOG BOOK RECORDS OF PERSONNEL ON TOWER, c) PROVIDE R.F. MONITORING DEVICES TO TOWER PERSONNEL. d) VERIZON WIRELESS TO INSPECT ALL TRENCHING BEFORE BACKFILLING
- THE ELECTRICAL CONTRACTOR SHALL INSTALL ALL UNDERGROUND CONDUITS SHOWN ON PLANS UNLESS NOTED OTHERWISE. ALL UNDERGROUND CONDUIT SHALL BE STUBBED-UP AND CAPPED AT THE LOCATION INDICATED ON PLANS. VZW CONTRACTOR SHALL COMPLETE ALL CONDUIT TERMINATIONS TO VZW ENCLOSURES.
- 10. THE VZW ELECTRICAL CONTRACTOR SHALL VERIFY ELECTRICAL SERVICE REQUIRED 120/240V, SINGLE PHASE, 200 AMP BEFORE ROUGH IN
- 11. GENERAL CONTRACTOR AND VZW ELECTRICAL CONTRACTORS SHALL PROVIDE FIRE WATCH DURING ALL WELDING OPERATIONS, TWO (2) HAND HELD 30 LB, FIRE EXTINGUISHERS & ADEQUATE WATER SUPPLY SHALL BE APPROVED BY
- 12. SEAL ALL PENETRATIONS WITH SILICONE SEALANT.
- 13. ELECTRICAL WORK PRESENTS SPECIFIC THREATS TO THE HEALTH AND SAFETY OF WORKERS ON SITE. SPECIFICALLY ELECTROCUTIONS ARE THE FOURTH LEADING CAUSE OF DEATH ON CONSTRUCTION SITES. ALL ELECTRICAL WORKERS SHALL HAVE CURRENT CERTIFICATIONS WHICH SATISFY ALL TRAINING REQUIREMENTS FOR THE ELECTRICAL WORK THEY ARE PERFORMING PER OSHA STANDARDS. ALL ELECTRICAL WORKERS SHALL ADHERE TO ALL SAFETY RULES ANI REGULATIONS FOR WORKER AND PUBLIC SAFETY. ALL WORK SHALL BE PERFORMED BY QUALIFIED ELECTRICIANS TRAINED FOR THE TYPE OF WORK AND THE VOLTAGES PRESENT FOR EACH TASK. THE CONTRACTOR SHALL REVIEW ALL LANDOWNER, PRIME CONTRACTOR, CARRIER, OSHA, NFPA 70E, AND LOCAL SAFETY GUIDELINES AND AT ALL TIMES SHALL CONFORM TO THE MOST RESTRICTIVE OF THESE STANDARDS TO ENSURE A SAFE WORKPLACE.
- 14. CONNECT NEUTRAL TERMINAL IN SERVICE DISCONNECTING DEVICE TO GROUNDING ELECTRODE. (2/0 AWG TINNED STRANDED COPPER GROUNDING ELECTRODE CONDUCTOR IN 1" PVC CONDUIT). CONNECT FIRST GROUNDING ELECTRODE TO SECOND GROUNDING ELECTRODE WITH 2/0 AWG TINNED STRANDED COPPER CONDUCTOR
- 15. VZW E.C. SHALL VERIFY SUFFICIENT CAPACITY EXISTS AT EXISTING METER CENTER. NOTIFY ENGINEER IMMEDIATELY SERVICE IS NOT ADEQUATE.
- 16. REFER TO ELECTRICAL SITE PLAN FOR CONDUIT AND WIRE REQUIREMENTS.
- 17. ALL ELECTRICAL EQUIPMENT PLACARDS MUST BE ENGRAVED PLASTIC LABELS ONLY, NO P-TOUCH LABELS ARE TO BE USED. PLACARDS SHALL BE 1 1/2" x 5" IN SIZE AND PERMANENTLY AFFIXED TO THE ENCLOSURES EASILY VISIBLE
- VERIZON WIRELESS ELECTRICAL PLACARD REQUIREMENTS:
- 18.a. AVAILABLE FAULT CURRENT RATING FROM UTILITY PROVIDER WITH DATE. VERIZON WIRELESS SERVICE DISCONNECT AT METER BASE.
- VERIZON MAIN BREAKER AT INTEGRATED LOAD CENTER 'ILC'
- GENERATOR NEUTRAL CONDUCTOR BONDED TO SERVICE GROUNDING ELECTRODE IN THIS ENCLOSURE AT METER CENTER AND INTEGRATED LOAD CENTER "ILC" NEUTRAL BAR.
- VERIZON WIRELESS GENERATOR
- 'ACCESS PROPERTY OF VERIZON WIRELESS' AT ALL VERIZON WIRELESS FIBER HAND HOLES FASTENED TO INSIDE
- 19. ALL EQUIPMENT SHALL BE GROUNDED PER LATEST EDITION OF NEC AND AS INDICATED ON GROUNDING PLAN.
- 20. ELECTRICAL EQUIPMENT SHALL BE MIN 3'-0" FROM ANY STRUCTURE AND AS REQUIRED BY LOCAL UTILITY
- 21. 2 AWG BARE SOLID TINNED COPPER WIRE LEADS FROM NEW H-FRAME STRUCTURE TO BE BONDED TO EXISTING
- 23. ALL ABOVE GRADE GROUND VZW CONNECTIONS SHALL BE IN 1/2" FLEXIBLE PVC CONDUIT w/ANTI-THEFT COMPOUND, ALL OTHER LEADS SHALL BE IN 1/2" PVC CONDUIT.
- 24. ALL HARDWARE USED MUST BE GALVANIZED OR STAINLESS STEEL, NO ZINC OR OTHER MATERIAL IS TO BE USED
- 25. VERIZON WIRELESS FURNISH & INSTALL ALL INNER CONNECTING CONDUITS BETWEEN CABINETS AND LAND ALL AC POWER TO VZW EQUIPMENT
- 26. ALL CONDUIT RUNS SHALL HAVE A CONTINUOUS SLOPE DOWNWARD AND AWAY FROM THE METERBOARD SO THA WATER WILL NOT FLOW FROM THE EQUIPMENT. TRENCHES SHALL BE EXCAVATED ALONG STRAIGHT LINES BEFORE CONDUIT ARE INSTALLED SO THE ELEVATION CAN BE ADJUSTED, IF NECESSARY, TO AVOID UNSEEN OBSTACLES.
- 27. PRIOR TO THE SUBMISSION OF BIDS, THE GENERAL CONTRACTOR AND HIS SUBCONTRACTORS SHALL VERIFY ALL DETAILS AND SCHEDULES ON THE DRAWINGS AND SPECIFICATIONS PROVIDED BY THE OWNER, FOR MEANING OF ABBREVIATIONS AND ADDITIONAL REQUIREMENTS AND INFORMATION, CHECK STRUCTURAL AND OTHER MECHANICAL AND ELECTRICAL DRAWINGS FOR SCALE, SPACE LIMITATIONS, DOOR SWINGS, ADJACENT CARRIER EQUIPMENT COORDINATION AND ADDITIONAL INFORMATION, ETC. REPORT ANY DISCREPANCIES, CONFLICTS, ETC.





820 MORRIS TURNPIKE - STE 104 SHORT HILLS. NJ 07078

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SITE INFORMATION FULTON, KY

(CRUTCHFIELD) 1311 CLINTON MOSCOW RD

FULTON, KY 42041 **FULTON COUNTY**

AMOND COMMUNICATIONS SITE NUMBE KY007

VERIZON WIRELESS SITE NAME **EV CRUTCHFIELD**


POD NUMBER 21-11822 DRAWN BY POD


CHECKED BY: 01.17.17

PANEL SCHEDULE, ONE LINE DIAGRAM **ELECTRICAL NOTES** AND DETAILS

SHEET NUMBER

E-3

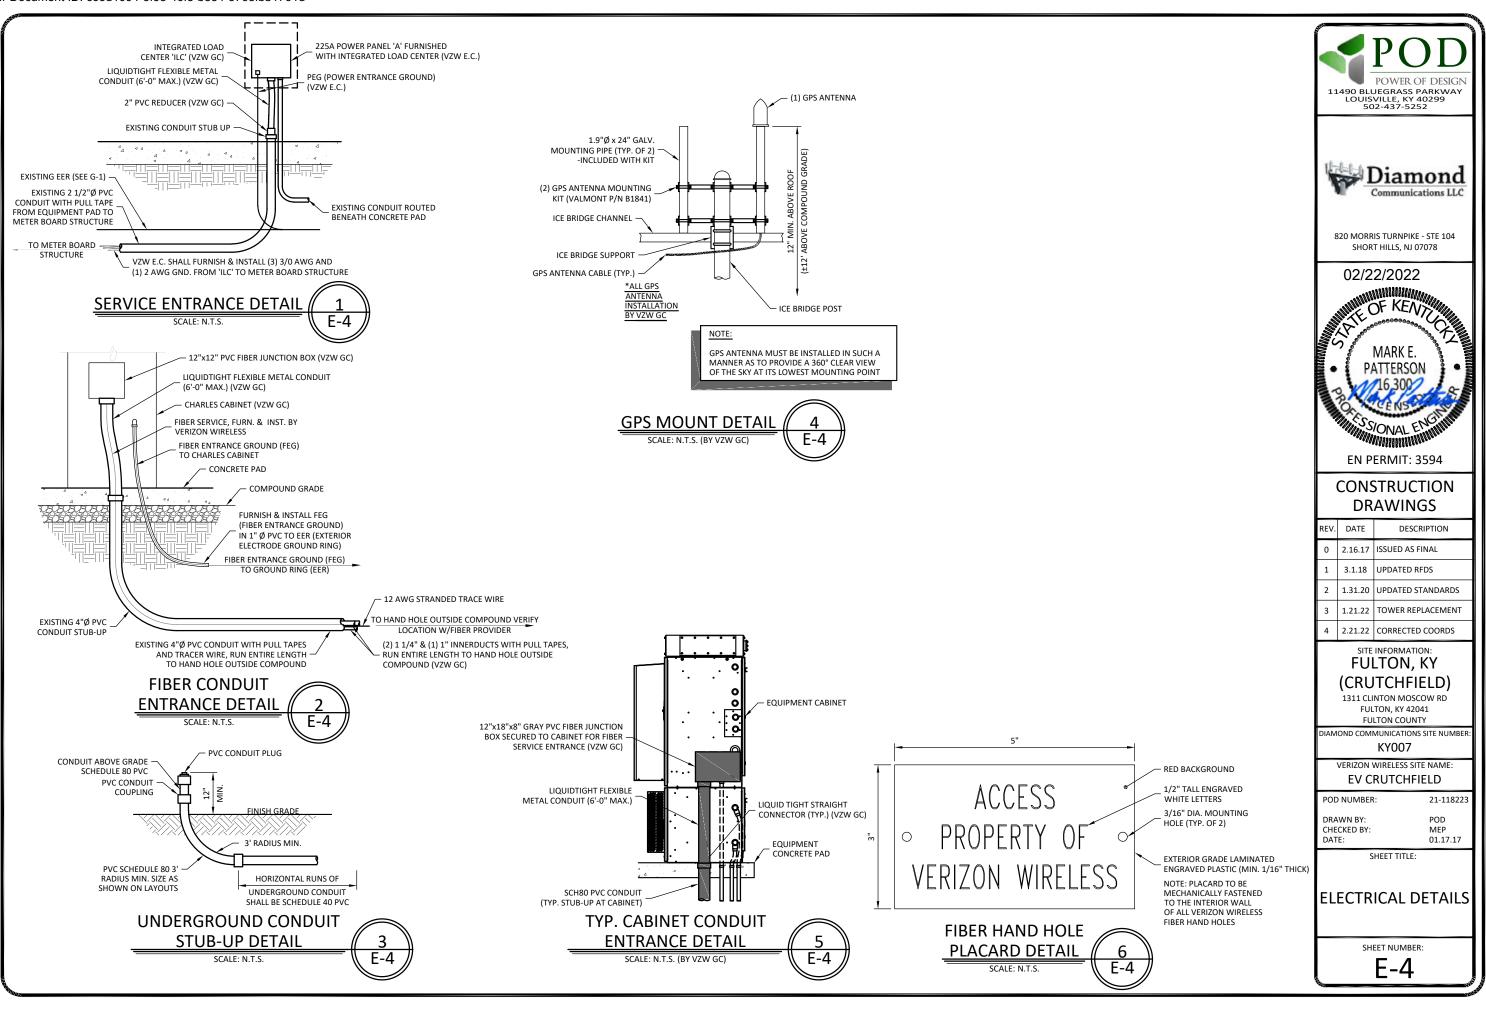

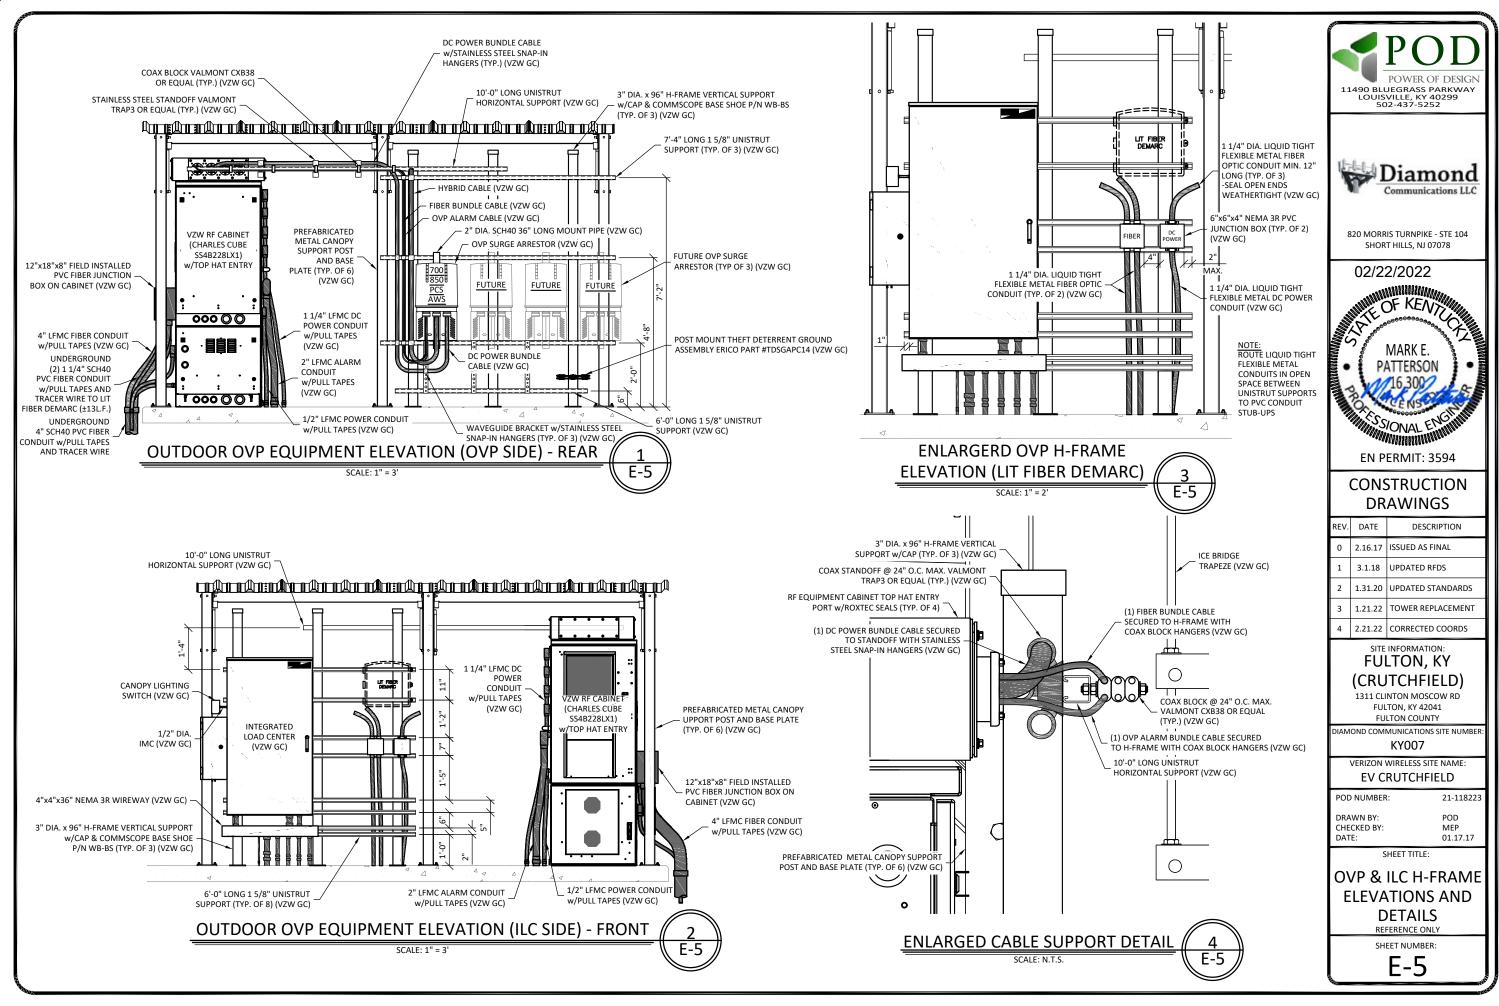

SCALE: N.T.S.

SCALE: N.T.S.

FIBER OPTIC INNERDUCTS SHALL TERMINATE INSIDE CHARLES CABINET ONLY

VERIFY INTERIOR EQUIPMENT LOCATION PRIOR TO JUNCTION BOX FASTENER INSTALLATION. NO SHARP FASTENER EDGES PERMITTED WITHIN CHARLES

ELEVATION

SCALE: N.T.S.





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1311 CLINTON MOSCOW RD FULTON, KY 42041 FULTON COUNTY

AMOND COMMUNICATIONS SITE NUMBE KY007

VERIZON WIRELESS SITE NAME: **EV CRUTCHFIELD**

POD NUMBER

21-118223 POD

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DRAWN BY: CHECKED BY:


E-6

SHEET TITLE:


EQUIPMENT CABINET ELEVATIONS

SHEET NUMBER:

E-6

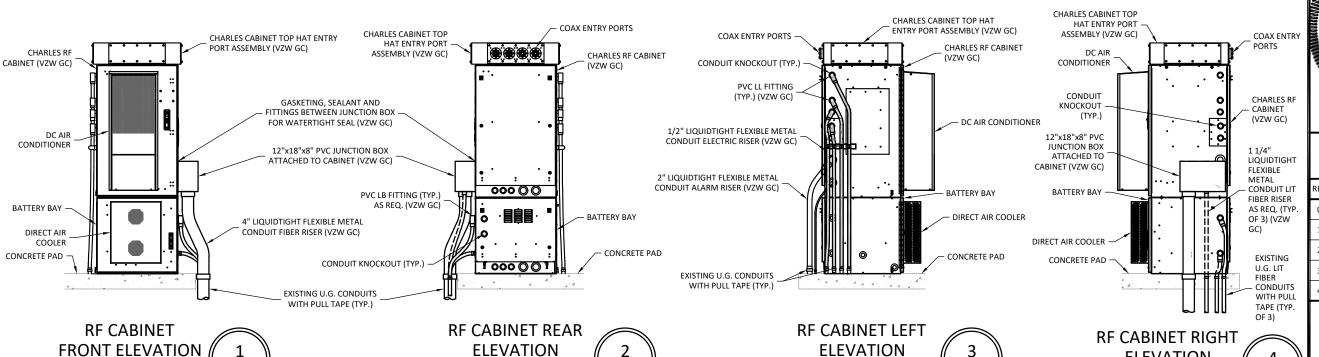

SCALE: N.T.S.

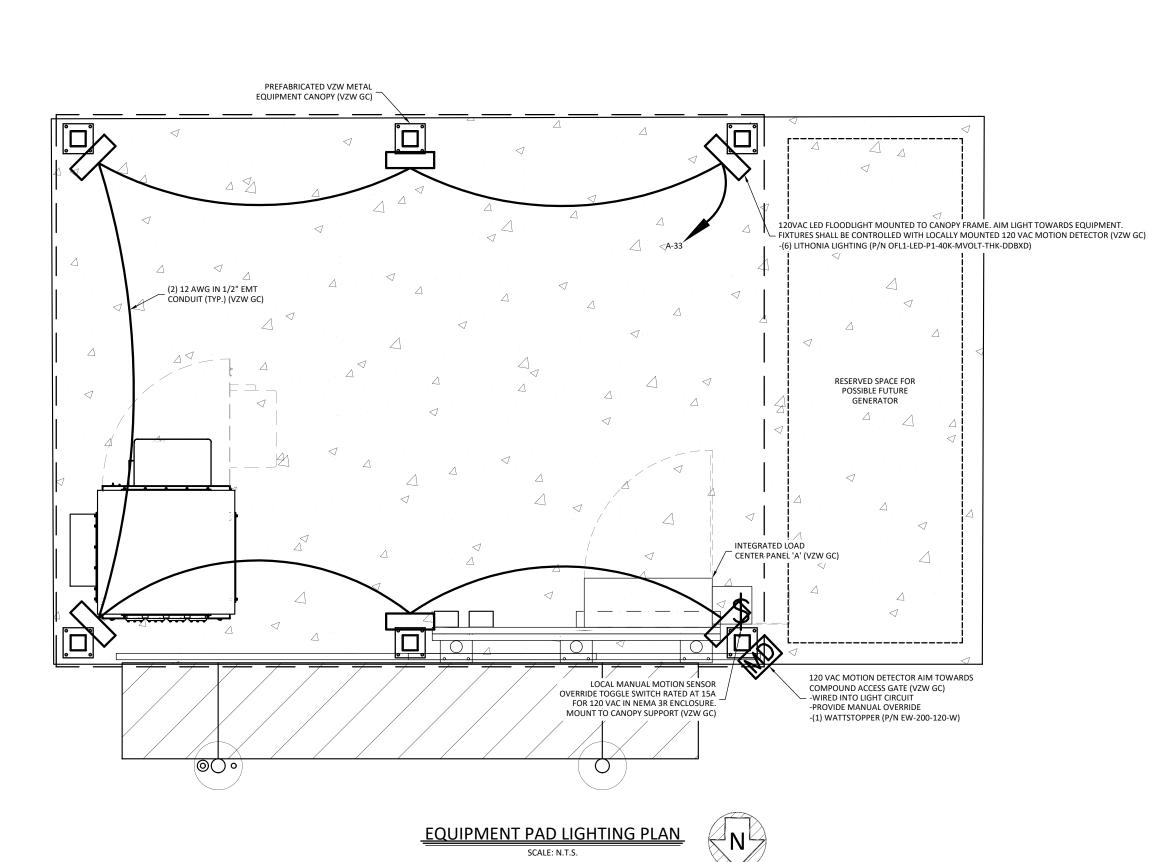





820 MORRIS TURNPIKE - STE 104 SHORT HILLS, NJ 07078

02/22/2022 MARK E. PATTERSON 16,300 18,555/ONAL ENGLISHING

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FULTON, KY 42041

FULTON COUNTY
DIAMOND COMMUNICATIONS SITE NUMBER

KY007
VERIZON WIRELESS SITE NAME:

EV CRUTCHFIELD

POD NUMBER: 21-118223

DRAWN BY: POD CHECKED BY: MEP


CHECKED BY: MEP
DATE: 01.17.17

SHEET TITLE:

EQUIPMENT PAD LIGHTING PLAN

SHEET NUMBER:

E-7

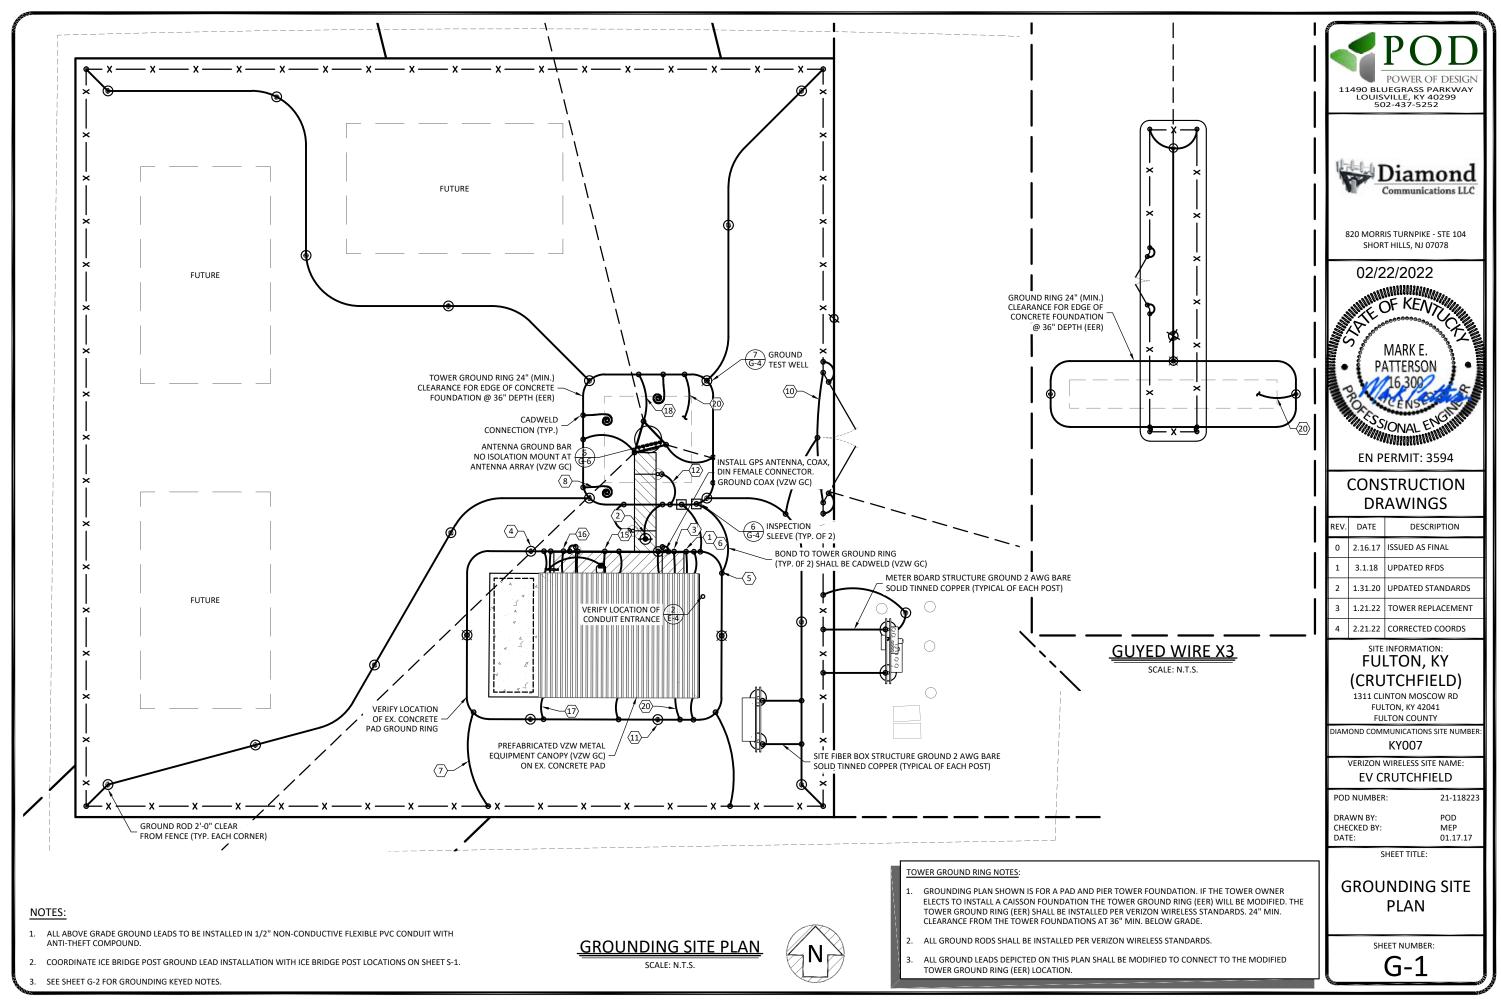

TOWER OWNER GROUNDING KEYED NOTES

- BBG: FURN. & INST. 1 2/0 AWG INSULATED STRANDED COPPER GND. WIRE FOR BATTERY BAY GROUND (BBG) TO (EER). COIL UP 6' ABOVE GRADE. CONNECTION TO (EER) SHALL BE CADWELD.
- CEPSG: FURN. & INST. 1 2 AWG BARE SOLID TINNED COPPER GND. WIRE FOR CEPSG POST TO (EER). COIL UP 6' ABOVE GRADE. CONNECTION (EER) SHALL BE CADWELD.
- GG: FURN. & INST. 2 2 AWG BARE SOLID TINNED COPPER GND. WIRE FOR CABINET GROUND (CG) TO (EER).

 CG: COIL UP 6' ABOVE GRADE. CONNECTION (EER) SHALL BE CADWELD.
- CSG: FURN. & INST. 1 2 AWG BARE SOLID TINNED COPPER GND WIRE FOR ICE BRIDGE CHANNEL TO (EER). COIL UP 15' ABOVE GRADE. CONNECTION (EER) SHALL BE CADWELD.
- FURN. & INST. 2 AWG BARE SOLID TINNED COPPER BURIED EXTERIOR ELECTRODE GROUND RING (EER)
 AROUND RADIO EQUIPMENT PAD AND TOWER BURIED AT 36" OR 6" BELOW FROST LINE (WHICHEVER IS GREATER). MAINTAIN 24" FROM EQUIPMENT PAD AND TOWER FOUNDATIONS MINIMUM.
- FEG: FURN. & INST. 1 2 AWG BARE SOLID TINNED COPPER GND. WIRE FOR FIBER ENTRANCE GROUND (FEG) TO (TGE). COIL UP 10' ABOVE GRADE. CONNECTION TO (EER) SHALL BE CADWELD.
- FURN. & INST. 1 2 AWG BARE SOLID TINNED COPPER GND WIRE FROM NEW FENCING TO GROUND RING

 (EER). CONNECTION TO FENCING SHALL BE AT THE BASE OF FENCE POST USING CADWELD AND WEAVE
 GND. WIRE THRU FABRIC AND ATTACH TO TOP RAIL WITH CADWELD. CONNECTION TO (EER) SHALL BE
 CADWELD.
- (8) FTWGL: FURN. & INST. FUTURE TOWER WAVEGUIDE GROUND BAR LEADS. CONTRACTOR SHALL COIL UP TEN (10') OF 2 AWG SOLID TINNED COPPER GROUND (TYP.)
- 9 GEG: NOT USED
- GG: FURN. & INST. 1 2 AWG BARE SOLID TINNED COPPER GND WIRE AT EACH GATE POST AND PROVIDE GROUND WIRE TO BONDING JUMPER FROM GATE POST TO FENCE POST.
- FURN. & INST. GROUND RODS TO 36" BELOW FINISH GRADE (OR 6" BELOW FROST LINE, WHICHEVER IS
 GRE: GREATER) AT A MINIMUM SPACING OF 10'-0" AT RADIO EQUIPMENT PAD, TOWER AND SITE EXTERIOR
 GROUND SYSTEM. CONNECTION TO (EER) SHALL BE CADWELD. REFER TO DETAIL 5 ON SHEET G-4.
- FURN. & INST. 1 2 AWG BARE SOLID TINNED COPPER GND. WIRE FROM ICE BRIDGE SUPPORT POST TO

 IBSG: (EER). COIL UP 6' ABOVE GRADE. CONNECTION (EER) SHALL BE CADWELD. SEE SHEET S-1 FOR ICE BRIDGE POST LOCATIONS.
- OGA: BY VZW E.C.
- OGL: BY VZW E.C.
- OHG: FURN. & INST. 2 2 AWG BARE SOLID TINNED COPPER GND. WIRE FOR THE 'OVP' H-FRAME TO (EER). COIL UP 6' ABOVE GRADE (TYP. OF 3 POSTS). CONNECTION (EER) SHALL BE CADWELD.
- PEG: FURN. & INST. 1 2 AWG BARE SOLID TINNED COPPER GND. WIRE FOR THE 'ILC' GROUND BAR TO (EER). COIL UP 6' ABOVE GRADE. CONNECTION (EER) SHALL BE CADWELD.
- PCSG: FURN. & INST. 1 2 AWG BARE SOLID TINNED COPPER GND. WIRE FOR EACH PAD CANOPY SUPPORT BASE TO (EER). COIL UP 6' ABOVE GRADE. CONNECTION TO (EER) SHALL BE CADWELD.
- FURN. & INST. 1- 2 AWG BARE SOLID TINNED COPPER GND. WIRE FROM TOWER LEG BASE PLATE TO
 TBG: (EER). CONNECTION TO TOWER LEG BASE PLATE SHALL BE CADWELD OR MECHANICAL TO LEG AND (EER)
 SHALL BE CADWELD.
- 19 TWG: BY VZW E.C.
- FURN. & INST. 1 2 AWG BARE SOLID TINNED COPPER GND. WIRE (UFER GROUND) FOR FOUNDATION

 UG: REINFORCEMENT STEEL CONNECTION TO (EER) SHALL BE CADWELD. PROVIDE HEAT SHRINK TUBING OR ELECTRICAL TAPE PROTECTION FOR CONDUCTOR AT TRANSITION BETWEEN CONCRETE AND SOIL.

TOWER OWNER GROUNDING NOTES

- 1. ALL UNDERGROUND CONNECTIONS ON THE LIGHTNING PROTECTION SYSTEM SHALL BE EXOTHERMIC WELDED USING THE CADWELD PROCESS. THE DIAMOND COMMUNICATIONS LLC SHALL FURN. & INST. ALL THESE CONNECTIONS, INCLUDING WELD METALS, MOLDS AND TOOLS. THE DIAMOND COMMUNICATIONS LLC SHALL FURN. & INST. 5/8" x 10' COPPER CLAD STEEL (COPPER JACKET 0.0012" MIN.) GROUND RODS, DRIVEN VERTICAL TO 36" BELOW FIN. GRADE (OR 6" BELOW FROSTLINE, WHICHEVER IS GREATER) @ 10'-0" O.C. MINIMUM.
- 2. THE DIAMOND COMMUNICATIONS LLC SHALL FURN. & INST. 2 AWG BARE SOLID TINNED COPPER GND. WIRE AT A DEPTH OF 36" BELOW FIN. GRADE FOR THE EQUIPMENT PAD (EER) AND ICE BRIDGE (CSG).
- 3. ALL EXTERIOR GND. CONNECTIONS SHALL BE EXOTHERMIC CADWELD (U.N.O).
- 4. UPON COMPLETION OF THE EQUIPMENT PAD GROUNDING RING AND BEFORE BONDING TO THE TOWER GROUND RING, THE DIAMOND COMMUNICATIONS LLC SHALL MEGGER TEST THIS GROUNDING FIELD. THE REQUIRED RESISTANCE LEVEL IS 5 OHMS OR LESS. THE DIAMOND COMMUNICATIONS LLC SHALL NOTIFY THE ENGINEER IF THESE REQUIREMENTS ARE NOT ACHIEVED. THE DIAMOND COMMUNICATIONS LLC SHALL SUBMIT PRICING TO TOWER OWNER FOR THE INSTALLATION OF ADDITIONAL GROUND RODS REQUIRED FOR PROPER RESISTANCE. UPON APPROVAL FROM TOWER OWNER, THE DIAMOND COMMUNICATIONS LLC SHALL INSTALL ADDITIONAL GROUND RODS AS REQUIRED. AFTER PASSING TEST, THE DIAMOND COMMUNICATIONS LLC SHALL BOND THE EQUIPMENT PAD RING TO THE TOWER RING. THE DIAMOND COMMUNICATIONS LLC SHALL NOTIFY VERIZON WIRELESS CONSTRUCTION MANAGER AND TOWER OWNER CONSTRUCTION MANAGER 48 HOURS PRIOR TO BACKFILLING TRENCHES, POURING CONCRETE FOR FOUNDATIONS. TO INSPECT BONDS AND INSPECT ANY/ALL BREAKS AND REPAIRS TO THE GROUND RING.
- 5. GROUND SYSTEM SHALL BE VISUALLY INSPECTED BY A TOWER OWNER AND VERIZON WIRELESS CONSTRUCTION ENGINEER BEFORE BACKFILLING IF REQUESTED.
- 6. NO SHARP 90° BENDS SHALL BE USED. A LONG SWINGING RADIUS BEND REQUIRED.
- ALL EQUIPMENT PAD AND EQUIPMENT GROUNDING SHALL BE IN ACCORDANCE WITH VERIZON WIRELESS
 SPECIFICATIONS.
- ALL ABOVE GROUND BARE COPPER CONDUCTORS BELOW 10' ABOVE GRADE SHALL BE INSTALLED IN FLEXIBLE PVC CONDUIT. CONDUIT SHALL BE FILLED WITH THEFT DETERRENT COMPOUND (ELECTRIC MOTION COMPANY ANTI-THEFT COMPOUND EM-5101).
- BARE COPPER CONDUCTORS SHALL NOT BE INSTALLED WHERE THEY MAY BE IN CONTACT WITH GALVANIZED METALS.
 THE CONDUCTORS SHALL BE INSULATED OR ENCLOSED IN PVC CONDUIT, PLASTIC SEALTIGHT OR INSTALLED WITH
 STANDOPE SLICH THAT NO CONTACT BETWEEN DISSIMIL AR METALS MAY TAKE PLACE
- CONNECTION OF COPPER CONDUCTORS TO GALVANIZED METAL OR ALUMINUM SHALL BE AVOIDED. BRASS OR STAINLESS STEEL LUGS OR BARS SHALL BE USED FOR THESE CONNECTIONS.

BBG BATTERY BAY GROUND CEPSG COAX ENTRY PROTECTION SYSTEM GROUND	
CEPSG COAX ENTRY PROTECTION SYSTEM GROUND	
CEL SO COLUMN THO LEGIS OF CHIEF	
CG CABINET GROUND	
CSG CABLE SUPPORT GROUND	
EER BURIED EXTERIOR ELECTRODE GROUND RING	
EGC EQUIPMENT GROUNDING CONDUCTOR (NEC DESIGNA	TION)
FEG FIBER ENTRANCE GROUND	
FG FENCE GROUND	
FTWGL FUTURE TOWER WAVEGUIDE GROUND LEAD	
GEG GROUNDING ELECTRODE CONDUCTOR (NEC DESIGNAT	ΓΙΟΝ)
GEG NOT USED	
GES GROUNDING ELECTRODE SYSTEM (NEC DESIGNATION)	
GG GATE GROUND	
GRE GROUND ROD ELECTRODE	
IBSG ICE BRIDGE SUPPORT GROUND	
OGA OVP GROUND ASSEMBLY	
OGL OVP GROUND LEAD	
OHG OVP H-FRAME SUPPORT GROUND	
PEG POWER ENTRANCE GROUND	
PCSG PAD CANOPY SUPPORT GROUND DOWN LEAD	
TBG TOWER BASE GROUND	
TWG TOWER WAVEGUIDE GROUND GROUND ASSEMBLY	
UG UFER GROUND	
 CABLE TO CABLE CADWELD CONNECTION 	
CABLE TO GND. ROD CADWELD CONNECTION	
▼ TEST WELL	
INSPECTION PORT CABLE TO CABLE CADWELD CONNECTION	CTION





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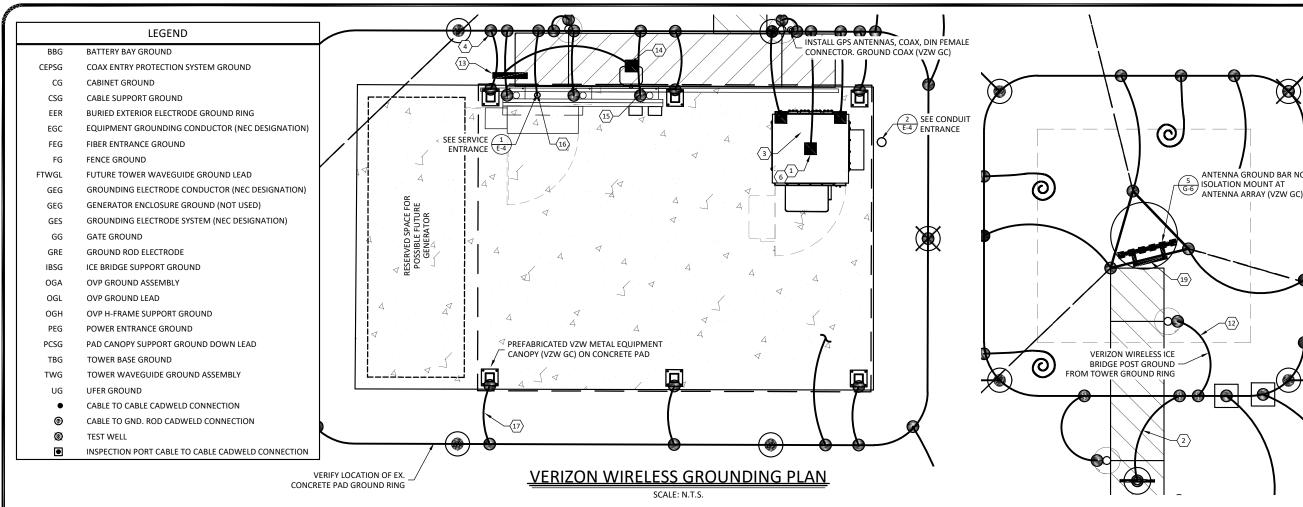
DRAWN BY: CHECKED BY: POD MEP 01.17.17

21-118223

SHEET TITLE:

GROUNDING NOTES

SHEET NUMBER:



VERIZON WIRELESS GROUNDING KEYED NOTES

VZW E.C. SHALL CONNECT THE 1 - 2/0 AWG INSULATED STRANDED COPPER (10) GND. WIRE COILED UP BY THE TOWER OWNER E.C. FOR THE BATTERY BAY BBG: GROUND (BBG). CONNECTION TO THE GROUND BAR IN THE BATTERY BAY SHALL BE MECHANICAL, ROUTE LEAD IN LIQUIDTIGHT FLEXIBLE NONMETALLIC CONDUIT w/ANTI-THEFT COMPOUND. VZW E.C. SHALL FURNISH & INSTALL THE THEFT DETERRENT GROUND POST ASSEMBLY PART #TDSGAPC14 FOR THE COAX ENTRY PROTECTION SYSTEM (AS MFG'D. BY ERICO GROUNDING AND SUPPLIED BY VZW E.C.) TO THE POST. CONNECT THE 2 AWG BARE SOLID TINNED COPPER COILED UP BY (2) CEPSG: TOWER OWNER E.C. TO THE POST. THE CONNECTION TO POST SHALL BE CADWELD, REFER TO THE GENERAL INSTALLATION GUIDE AS SUPPLIED WITH THEFT DETERRENT POST MOUNT GROUND ASSEMBLY. SEE DETAIL 1 (14) ON SHEET G-5 FOR DETAILS. VZW E.C. SHALL FURNISH & INSTALL TWO HOLE LONG BARREL LUGS ON EXISTING 2 AWG BARE TINNED COPPER LEADS. VZW E.C. SHALL FURNISH & INSTALL DRAGON TOOTH WASHERS AND #8 STAINLESS STEEL FASTENERS CG: ON ALL EQUIPMENT CABINET EXTERIOR GROUND LOCATIONS (TYP. 2 PER CABINET). REMOVE ALL SURFACE PAINT AND USE ANTIOXIDENT COMPOUND BETWEEN METAL AND WASHER. ALL LEADS SHALL BE DRESSED TO REDUCE TRIP HAZARDS. DETAIL 3 ON SHEET G-5 FOR DETAILS. VZW E.C. SHALL CONNECT THE 1 - 2 AWG BARE SOLID TINNED COPPER GND $\langle 4 \rangle$ CSG: WIRE COILED BY TOWER OWNER E.C. FOR THE ICE BRIDGE CHANNEL. CONNECTION TO ICE BRIDGE CHANNEL SHALL BE CADWELD. EER: BY TOWER OWNER E.C. VZW E.C. SHALL BRING THE 2 AWG BARE SOLID TINNED COPPER GND. WIRE (17) COILED UP BY TOWER OWNER E.C. FOR (FIBER ENTRANCE GROUND) INTO FEG: THE POWER PLANT CABINET AND MAKE A MECHANICAL CONNECTION TO **6** THE FIBER SERVICE GROUND POINT. ROUTE LEAD IN FLEXIBLE NONMETALLIC CONDUIT w/ANTI-THEFT COMPOUND (18)

 $\langle 7 \rangle$

(8)

FG: BY TOWER OWNER E.C.

FTWGL: BY TOWER OWNER E.C.

- GG: BY TOWER OWNER E.C.
- GRE: BY TOWER OWNER E.C.
- VZW E.C. SHALL CONNECT THE 1 2 AWG BARE SOLID TINNED COPPER BSG: GND. WIRE COILED UP BY TOWER OWNER E.C. FOR ICE BRIDGE SUPPORT POST. CONNECTION TO ICE BRIDGE SUPPORT POST SHALL BE CADWELD.
- VZW E.C. SHALL CONNECT THE THE THEFT DETERRENT GROUND ASSEMBLY
 OGA: KIT PART #TDSGAPC14 FOR THE OVP GROUND (OGL) DIRECTLY TO THE OVP
 H-FRAME POST.
- OGL: VZW E.C. SHALL FURN. & INST. 1 6 AWG GREEN INSULATED STRANDED
 OGL: COPPER GND. WIRE FROM OVP GROUND POINT TO OVP GROUND
 ASSEMBLY (OGA). CONNECTION TO GROUND BAR SHALL BE MECHANICAL
- OHG: VZW E.C. SHALL CONNECT THE 2 2 AWG BARE SOLID TINNED COPPER GND. WIRE COLLED UP BY TOWER OWNER E.C. FOR OVP H-FRAME SUPPORT POST (TYP. OF 3 POSTS). CONNECTION TO POST SHALL BE CADWELD.
- VZW E.C. SHALL CONNECT 1 2 AWG BARE SOLID TINNED COPPER GND WIRE FOR THE POWER ENTRANCE GROUND (PEG) COILED UP BY TOWER PEG: OWNER E.C. CONNECTION OF THE COILED WIRE TO THE INTEGRATED LOAD CENTER GROUND BAR SHALL BE MECHANICAL. ROUTE LEAD IN FLEXIBLE NONMETALLIC CONDUIT W/ANTI-THEFT COMPOUND.
- VZW E.C. SHALL CONNECT SOLID TINNED COPPER ONE HOLE GROUND TAB TO COILED UP GROUND WIRE BY TOWER OWNER E.C. WITH AN EXOTHERMIC CONNECTION. THE CONNECTION OF THE COILED GROUND WIRE AND LUG TO THE CANOPY SUPPORT BASE SHALL BE MECHANICAL. SEE DETAIL 3 ON SHEET G-5. ROUTE LEAD IN FLEXIBLE NONMETALLIC CONDUIT W/ANTI-THEFT COMPOUND.
- TBG: BY TOWER OWNER E.C.

②

- YZW E.C. SHALL CONNECT THE THEFT DETERRENT GROUND ASSEMBLY KIT
 TWG: PART #TDSGABC14 FOR THE TOWER WAVEGUIDE GROUND (TWG)
 DIRECTLY TO THE TOWER
 - UG: BY TOWER OWNER E.C.

VERIZON WIRELESS GROUNDING NOTES

- ALL UNDERGROUND CONNECTIONS ON THE LIGHTNING PROTECTION SYSTEM SHALL BE EXOTHERMIC WELDED USING THE CADWELD PROCESS THE VZW E.C. AND GENERAL CONTRACTOR E.C. SHALL FURN. & INST. ALL THESE CONNECTIONS, INCLUDING WELD METALS, MOLDS AND TOOLS. THE E.C. SHALL FURN. & INST. 5/8" x 10' COPPER CLAD STEEL (COPPER JACKET 0.0012" MIN.) GROUND RODS, DRIVEN VERTICAL TO 36" BELOW FIN. GRADE (OR 6" BELOW FROSTLINE, WHICHEVER IS GREATER) @ 10'-0" O.C. MINIMUM.
- 2. THE VZW E.C. SHALL FURN. & INST. 2 AWG BARE SOLID TINNED COPPER GND. WIRE AT A DEPTH OF 36" BELOW FIN. GRADE FOR THE EQUIPMENT PAD (EER) AND ICE BRIDGE (CSG).
- 3. THE GENERAL CONTRACTOR E.C. SHALL FURN. & INST. 2 AWG BARE SOLID TINNED COPPER GND. WIRE AT A DEPTH OF 36" BELOW FIN. GRADE FOR THE TOWER (EER), FUTURE TOWER WAVEGUIDE GROUND LEADS (FTWGL), GATE GROUND (GG), FENCE (FG), TOWER BASE GROUND (TBG) AND TOWER WAVEGUIDE GROUND (TWG).
- 4. ALL EXTERIOR GND. CONNECTIONS SHALL BE EXOTHERMIC CADWELD (U.N.O.).
- 5. ALL CRIMP LUG CONNECTIONS TO ALL GROUND BARS SHALL BE LUBRICATED WITH A CORROSION INHIBITER ("OXY-GREASE") OR APPROVED EQUAL..
- 5. UPON COMPLETION OF THE TOWER GROUNDING RING, THE GENERAL CONTRACTOR E.C. SHALL MEGGER TEST THE COUMPOUND GROUNDING FIELD. THE REQUIRED RESISTANCE LEVEL IS 5 OHMS OR LESS. THE GENERAL CONTRACTOR E.C. SHALL NOTIFY THE ENGINEER IF THESE REQUIREMENTS ARE NOT ACHIEVED. THE GENERAL CONTRACTOR E.C. SHALL SUBMIT PRICING TO TOWER OWNER FOR THE INSTALLATION OF ADDITIONAL GROUND RODS REQUIRED FOR PROPER RESISTANCE. UPON APPROVAL FROM TOWER OWNER, THE GENERAL CONTRACTOR E.C. SHALL INSTALL ADDITIONAL GROUND RODS AS REQUIRED. AFTER PASSING TEST, THE GENERAL CONTRACTOR E.C. SHALL NOTIFY TOWER OWNER 48 HOURS PRIOR TO BACKFILLING TRENCHES, POURING CONCRETE FOR FOUNDATIONS, TO INSPECT BONDS AND INSPECT ANY/ALL BREAKS AND REPAIRS TO THE GROUND RING.
- UPON COMPLETION OF THE RADIO EQUIPMENT PAD GROUNDING RING AND BEFORE BONDING TO THE TOWER GROUNDING RING, THE VZW E.C. SHALL MEGGER TEST THE EQUIPMENT PAD GROUNDING FIELD. THE REQUIRED RESISTANCE LEVEL IS 5 OHMS OR LESS. THE VZW E.C. SHALL NOTIFY THE ENGINEER IF THESE REQUIREMENTS ARE NOT ACHIEVED. THE VZW E.C. SHALL SUBMIT PRICING TO VERIZON WIRELESS FOR THE INSTALLATION OF ADDITIONAL GROUND RODS REQUIRED FOR PROPER RESISTANCE. UPON APPROVAL FROM VERIZON WIRELESS, THE VZW E.C. SHALL INSTALL ADDITIONAL GROUND RODS AS REQUIRED. AFTER PASSING TEST, THEN THE VZW E.C. SHALL BOND THE RADIO EQUIPMENT PAD GROUND RING TO THE TOWER GROUND RING. THE VZW E.C. SHALL NOTIFY VERIZON WIRELESS 48 HOURS PRIOR TO BACKFILLING TRENCHES, POURING CONCRETE FOR FOUNDATIONS, TO INSPECT BONDS AND INSPECT ANY/ALL BREAKS AND REPAIRS TO THE GROUND RING.
- 8. GROUND SYSTEM SHALL BE VISUALLY INSPECTED BY A TOWER OWNER AND VERIZON WIRELESS CONSTRUCTION ENGINEER BEFORE BACKFILLING IF REQUESTED.
- . GROUND ASSEMBLIES SHALL BE THEFT DETERRENT DESIGN AS MANUFACTURED BY ERICO INC. AND FURNISHED BY VERIZON WIRELESS. PROVIDE TWO (2) LUG HOLES PER VERIZON WIRELESS STANDARDS. UNLESS NOTED OTHERWISE.
- 10. ALL ABOVE GROUND BARE COPPER CONDUCTORS BELOW 10' ABOVE GRADE SHALL BE INSTALLED IN FLEXIBLE PVC CONDUIT. CONDUIT SHALL BE FILLED WITH THEFT DETERRENT COMPOUND (ELECTRIC MOTION COMPANY ANTI-THEFT COMPOUND EM-5101).
- 11. BARE COPPER CONDUCTORS SHALL NOT BE INSTALLED WHERE THEY MAY BE IN CONTACT WITH GALVANIZED METALS. THE CONDUCTORS SHALL BE INSULATED OR ENCLOSED IN PVC CONDUIT, PLASTIC SEALTIGHT OR INSTALLED WITH STANDOFF SUCH THAT NO CONTACT BETWEEN DISSIMILAR METALS MAY TAKE PLACE.
- 12. CONNECTION OF COPPER CONDUCTORS TO GALVANIZED METAL OR ALUMINUM SHALL BE AVOIDED. BRASS OR STAINLESS STEEL LUGS OR BARS SHALL BE USED FOR THESE CONNECTIONS.
- 13. NO SHARP 90° BENDS SHALL BE USED. A LONG SWINGING RADIUS BEND REQUIRED
- 14. ALL GROUNDING SHALL BE IN ACCORDANCE WITH VERIZON WIRELESS SPECIFICATIONS



Communications LLC

11490 BLUEGRASS PARKWAY

LOUISVILLE, KY 40299

502-437-5252

820 MORRIS TURNPIKE - STE 104 SHORT HILLS, NJ 07078

MARK E.
PATTERSON

16 300

SSONAL ENGINEER

EN PERMIT: 3594

CONSTRUCTION DRAWINGS

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SS.	0	2.16.17	ISSUED AS FINAL
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	2	1.31.20	UPDATED STANDARDS
Е	3	1.21.22	TOWER REPLACEMENT
3)	4	2.21.22	CORRECTED COORDS

SITE INFORMATION: FULTON, KY (CRUTCHFIELD)

1311 CLINTON MOSCOW RD FULTON, KY 42041 FULTON COUNTY

AMOND COMMUNICATIONS SITE NUMBE

KY007

VERIZON WIRELESS SITE NAME:

EV CRUTCHFIELD


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DATE: 01.17.17


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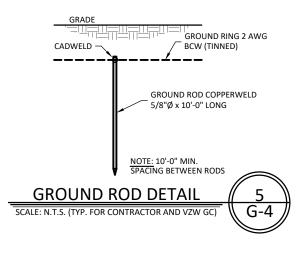
VERIZON WIRELESS GROUNDING PLAN AND NOTES


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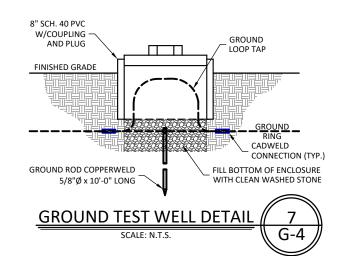



FENCE GROUNDING DETAIL



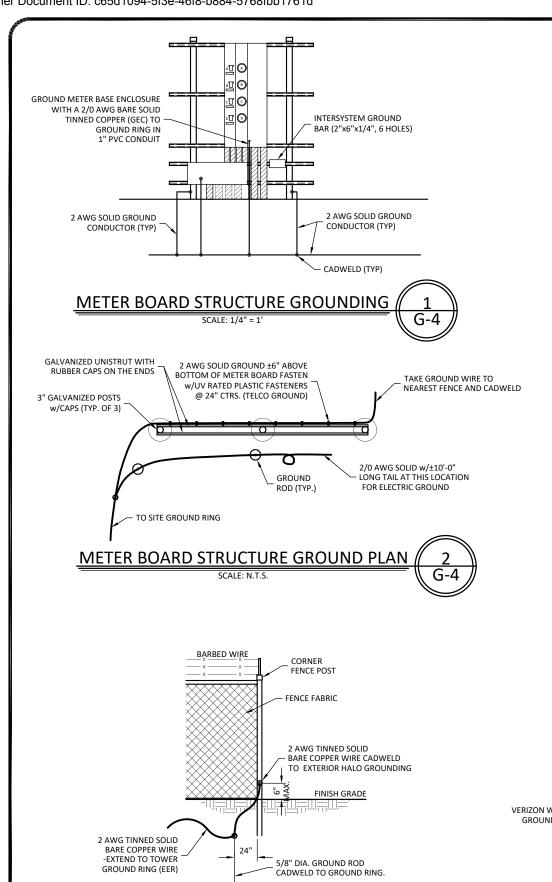

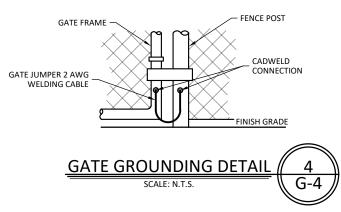

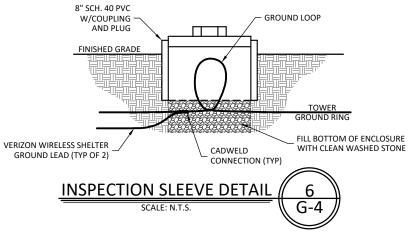

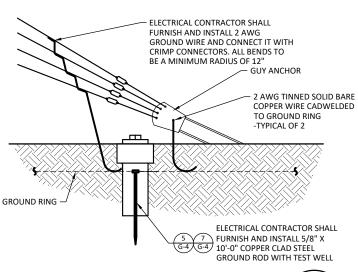







820 MORRIS TURNPIKE - STE 104 SHORT HILLS, NJ 07078

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CONSTRUCTION DRAWINGS

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DIAMOND COMMUNICATIONS SITE NUMBE KY007

VERIZON WIRELESS SITE NAME: EV CRUTCHFIELD


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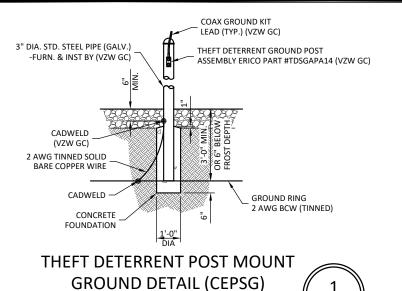
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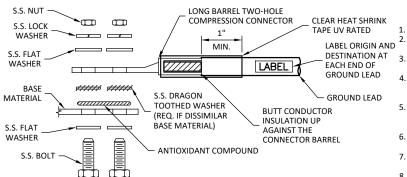
GROUNDING **DETAILS**

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SCALE: N.T.S. (BY VZW GC)



ALL HARDWARE SHALL BE 18-8 STAINLESS STEEL.

CHOOSE BOLT LENGTH TO ALLOW EXPOSURE OF AT LEAST

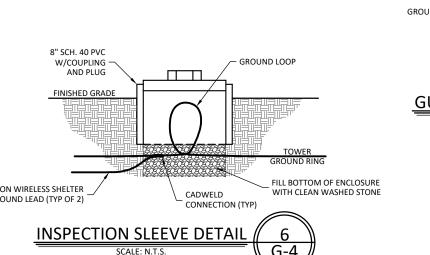BACK TO BACK LUG CONNECTIONS ARE ACCEPTABLE WHEN BONDED TO A GROUND BAR OR STEEL OBJECT. AT CONNECTIONS MADE TO STEEL OR ANY OTHER DISSIMILAR METALS, A DRAGON TOOTH WASHER SHALL BE USED BETWEEN THE CONNECTOR AND METAL.


IF NO DRAGON TOOTH WASHER IS USED, THOROUGHLY REMOVE A SECTION OF THE COATING APPROXIMATELY THE SIZE OF THE CONNECTOR WITH AND ABRASIVE STYLE TOOL

No-Ox-ID ANTI-OXIDATION COMPOUND (SANCHEM) SHALL BE USED AT ALL COPPER TO COPPER CONNECTIONS.

A ZINC BASED (GRAY COLORED) ANTI-OXIDATION COMPOUND SHALL BE USED AT ALL COPPER TO STEEL CONNECTIONS.


PENTROX OR EQUAL ANTI-OXIDATION COMPOUND SHALL BE USED AT ALL COPPER TO ALUMINUM CONNECTIONS.

GROUND LUG INSTALLATION DETAIL

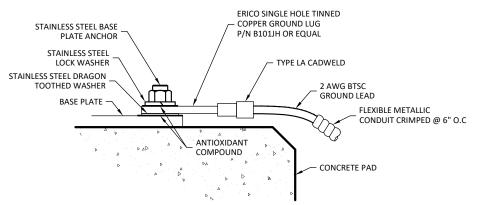

- ALL HARDWARE SHALL BE 18-8 STAINLESS STEEL.
 INSTALL ANCHOR LENGTH TO ALLOW EXPOSURE OF AT LEAST TWO THREADS.
- AT CONNECTIONS MADE TO STEEL OR ANY OTHER DISSIMILAR METALS, A DRAGON TOOTH WASHER SHALL BE USED BETWEEN THE CONNECTOR AND METAL
- IF NO DRAGON TOOTH WASHER IS USED, THOROUGHLY REMOVE A SECTION OF THE COATING APPROXIMATELY THE SIZE OF THE CONNECTOR WITH AND ABRASIVE STYLE TOOL.
- No-Ox-ID ANTI-OXIDATION COMPOUND (SANCHEM) SHALL BE USED AT ALL COPPER TO COPPER
- A ZINC BASED (GRAY COLORED) ANTI-OXIDATION COMPOUND SHALL BE USED AT ALL COPPER TO STEEL CONNECTIONS.
- 7. PENTROX OR EQUAL ANTI-OXIDATION COMPOUND SHALL BE USED AT ALL COPPER TO ALUMINUM CONNECTIONS.

GROUND LUG TO BASEPLATE INSTALLATION DETAIL

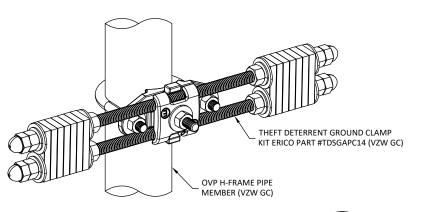

OVP GROUND ASSEMBLY (OGA) SCALE: N.T.S. (BY VZW GC)







820 MORRIS TURNPIKE - STE 104 SHORT HILLS, NJ 07078

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1311 CLINTON MOSCOW RD FULTON, KY 42041

FULTON COUNTY IAMOND COMMUNICATIONS SITE NUMBE

KY007

21-118223

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VERIZON WIRELESS SITE NAME: EV CRUTCHFIELD


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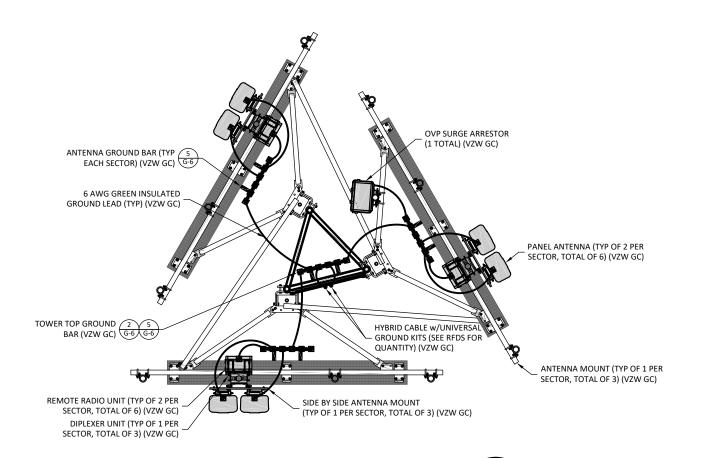
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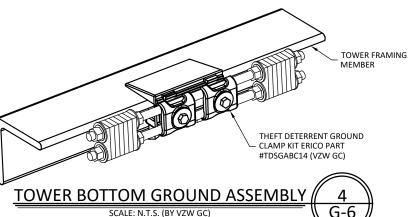
GROUNDING **DETAILS**


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ANTENNA LEVEL GROUNDING PLAN





ANTENNA, TOWER TOP & INTERMEDIATE GROUND BAR

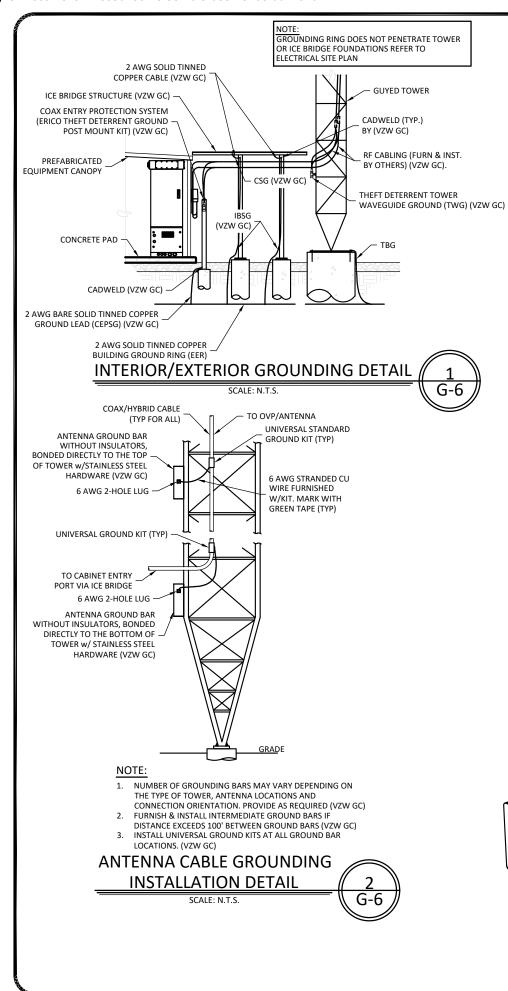SCALE: N.T.S. (BY VZW GC)

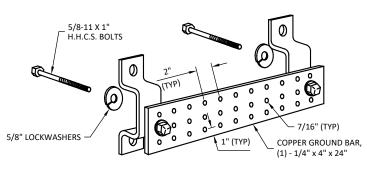





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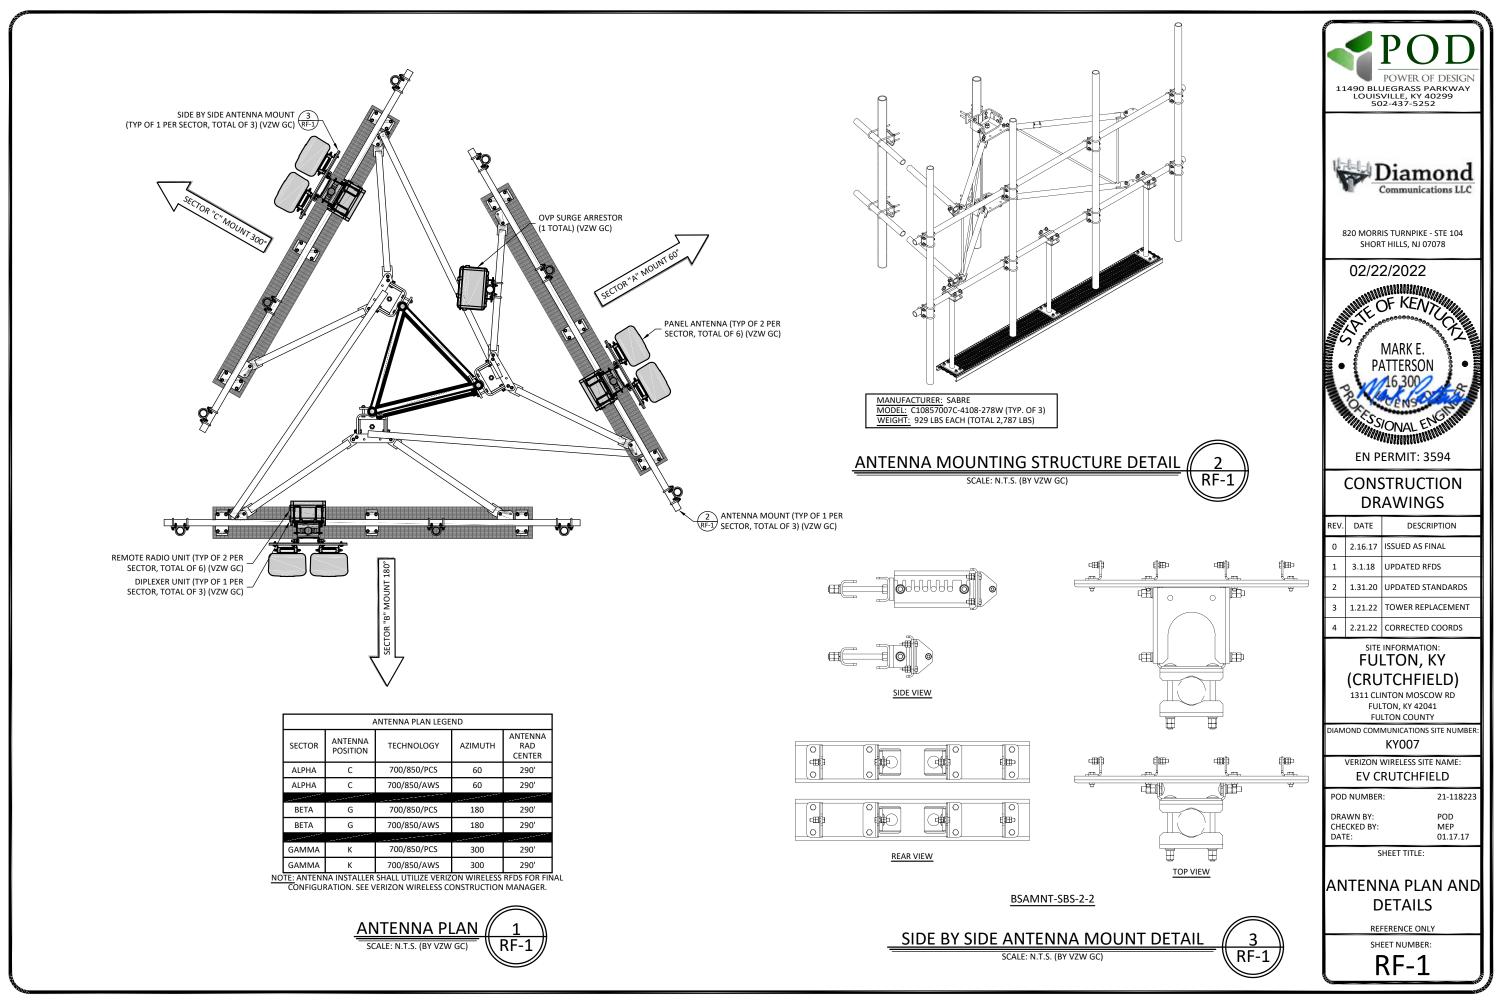
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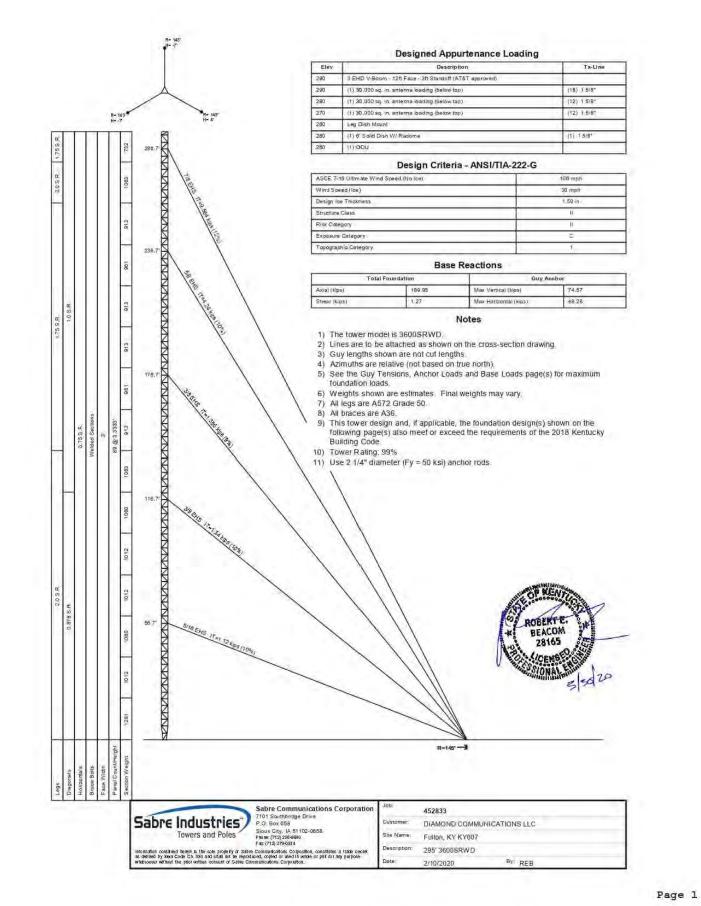
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820 MORRIS TURNPIKE - STE 104 SHORT HILLS, NJ 07078

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FULTON, KY (CRUTCHFIELD)

1311 CLINTON MOSCOW RD FULTON, KY 42041 FULTON COUNTY

DIAMOND COMMUNICATIONS SITE NUMBER

KY007
VERIZON WIRELESS SITE NAME:

EV CRUTCHFIELD

POD NUMBER: 21-118223

DRAWN BY: POD CHECKED BY: MEP DATE: 01.17.17

SHEET TITLE:

TOWER DETAILS

REFERENCE ONLY
SHEET NUMBER:

SHEET NOWBER.

TW-1

TO ANCHOR



WT.



TO ANCHOR

	REINFORCING STEEL SCHEDULE								
ITEM	ITEM LOCATION NO. REQ'D. BAR SPC'G. SIZE CUT LENGTH TOTAL LENGTH TOTAL W								
1.	PAD BOTTOM REINFORCING	18	EQUALLY SPACED AS SHOWN	#7	7'-6"	135'-0"	276 LBS.		
2.	PIER VERTICAL REINFORCING	6	60° APART	#7	3'-11"	23'-6"	48 LBS.		
3.	PIER TIES	3	12" C-C	#3	7'-6"	22'-6"	8 LBS.		
					TO	TAL REBAR WT.	332 LBS.		

2			(3)
(1	8	8	1
(6			9)
)	10	9)	
	2'-0"	0.D.	

LOCATION	W/ROUND PIERS	W/SQUARE PIERS
PAD	3.6 CU. YDS.	3.6 CU. YDS.
PIER	0.4 CU. YDS.	0.5 CU. YDS.
TOTAL CONCRETE	4.0 CU. YDS.	4.1 CU. YDS.

		EMBEDME	NT STEEL REQUIRED	
ITEM	PART NO.	NO. REQ'D.	DESCRIPTION	TOTAL WT.
4.	C30901001	1.	BASE BEARING PIN	12 LBS.
5.	C30902001	1	BASE BEARING PLATE	167 LBS.
			TOTAL STEEL WT.	179 LBS.

PIER TIE DETAIL

GENERAL NOTES

- 1. CONCRETE SHALL HAVE A MINIMUM 28 DAY COMPRESSIVE STRENGTH OF 4500 PSI, IN ACCORDANCE WITH ACI 318-11.
- 2. REBAR TO CONFORM TO ASTM SPECIFICATION A615 GRADE 60.
- 3. ALL REBAR TO HAVE A MINIMUM OF 3" CONCRETE COVER.
- 4. ALL EXPOSED CONCRETE CORNERS TO BE CHAMFERED 3/4".
- 5. THE FOUNDATION DESIGN IS BASED ON THE GEOTECHNICAL REPORT BY: POWER OF DESIGN GROUP, LLC., PROJECT NO.: 16-9169, DATED: SEPTEMBER 14, 2016.
- 6. THE FOUNDATION DESIGN IS BASED ON THE FOLLOWING FACTORED REACTIONS: FACTORED AXIAL LOAD (KIPS) = 189.95 FACTORED SHEAR (KIPS) = 1.27
- 7. SEE THE GEOTECHNICAL REPORT FOR COMPACTION REQUIREMENTS, IF SPECIFIED.

(5)	
· 0	
GRADE	
EXCAVATED AREA COMPACTED BACKFILL	
ELEVATION VIEW	

4'-0"

BEARING PIN MUST BE VERTICAL

WITHIN ±1/16" AND BEARING PLATE MUST BE LEVEL WITHIN ±1/16".-

PLAN VIEW

F	INLESS OT ALL DIME TINISHES A ERANCES:	NSION ND AI FRAC ANGL	RE IN TIONS ES ±	CLUDE	MATERIAL: TOLERANCES DO NOT APPLY TO RAW MATERIAL	Sabre Industries
REV	DATE	DRW	СНК		DESCRIPTION	This document and the information contained herein is the confidential trade secret property of Sabre Communications Corporation ("Sabre") and must not be reproduced, copied or used, in whole or in part, for any purpose without the prior written consent of Sabre. © 2020 Sabre Communications Corporation. All rights reserved.

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GUYED TOWER FOUNDATION SITE: FULTON, KY #KY007 CUSTOMER: DIAMOND COMMUNICATIONS LLC ENTIAL information confidential trade re Communications IOD NO 457205 SIZE DRAWING NO. nd must not be

JOB NO. 4		57295	SIZE	DRAWING NO.	REV	
l	DATE	4/8/20] B	457295-F1		0
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	CHECKED BY	KTW	1	None		





820 MORRIS TURNPIKE - STE 104 SHORT HILLS, NJ 07078

CONSTRUCTION **DRAWINGS**

REV.	DATE	DESCRIPTION
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SITE INFORMATION: FULTON, KY (CRUTCHFIELD)

1311 CLINTON MOSCOW RD FULTON, KY 42041 FULTON COUNTY

DIAMOND COMMUNICATIONS SITE NUMBE KY007

VERIZON WIRELESS SITE NAME: EV CRUTCHFIELD

POD NUMBER: 21-118223

DRAWN BY POD CHECKED BY: DATE: 01.17.17

SHEET TITLE:


TOWER DETAILS

REFERENCE ONLY SHEET NUMBER:

TW-2





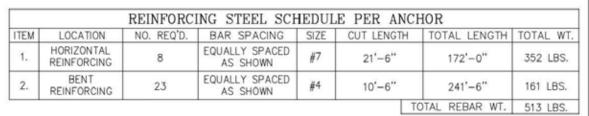


CONCRETE	REQ	UIRED	PER	ANCHOR
TOTAL CONCRE	TE		7.3 CU.	YDS.

		El	MBEDMENT STEEL REQUIRED PER ANCHOR	
ITEM	QTY.	PART NO.	DESCRIPTION	TOTAL WT.
3.	1	C30129046	WELDMENT, ANCHOR SHAFT, 2 1/4" DIA X 13'-10 1/2", 1 1/4" PL.	343 LBS.

GENERAL NOTES

- CONCRETE SHALL HAVE A MINIMUM 28 DAY COMPRESSIVE STRENGTH OF 4500 PSI, IN ACCORDANCE WITH ACI 318-11.
- 2. REBAR TO CONFORM TO ASTM SPECIFICATION A615 GRADE 60.
- 3. ALL REBAR TO HAVE A MINIMUM OF 3" CONCRETE COVER.
- THE FOUNDATION DESIGN IS BASED ON THE GEOTECHNICAL REPORT BY: POWER OF DESIGN GROUP, LLC., PROJECT NO.: 16-9169, DATED: SEPTEMBER 14, 2016.
- THE FOUNDATION DESIGN IS BASED ON THE FOLLOWING FACTORED REACTIONS: UPLIFT (KIPS) = 74.57 HORIZONTAL FORCE (KIPS) = 49.28
- WHEN THE SOIL ELECTRICAL RESISTIVITY IS LESS THAN 50 OHM—M AND/OR THE MEASURED SOIL pH VALUES ARE BELOW 3 OR GREATER THAN 9, ADDITIONAL CORROSION CONTROL IS REQUIRED. SEE THE GEOTECHNICAL REPORT FOR THESE PARAMETERS AND COMPACTION REQUIREMENTS. IF SPECIFIED.

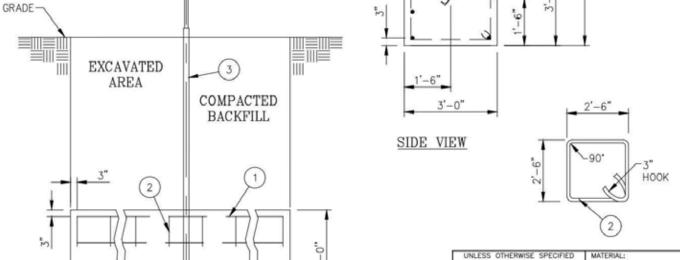

6'-2 1/16"

7 13/16"

11'-0"

22'-0"

REAR VIEW

EXCAVATED AREA COMPACTED BACKFILL

DATE

-GRADE



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CONCRETE ANCHOR

SITE: FULTON, KY #KY007

CUSTOMER: DIAMOND COMMUNICATIONS LLC

JOB NO. 457295		SIZE	DRAWING NO.	REV
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DESCRIPTION





820 MORRIS TURNPIKE - STE 104 SHORT HILLS. NJ 07078

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FULTON, KY (CRUTCHFIELD)

1311 CLINTON MOSCOW RD FULTON, KY 42041 FULTON COUNTY

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VERIZON WIRELESS SITE NAME: EV CRUTCHFIELD

POD NUMBER: 21-118223

DRAWN BY: POD CHECKED BY: MEP DATE: 01.17.17

SHEET TITLE:

TOWER DETAILS

REFERENCE ONLY
SHEET NUMBER:

TW-3