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**COMMONWEALTH OF KENTUCKY
BEFORE THE PUBLIC SERVICE COMMISSION**

PUBLIC SERVICE
COMMISSION

In the Matter of:

THE APPLICATION OF)
NEW CINGULAR WIRELESS PCS, LLC,)
A DELAWARE LIMITED LIABILITY COMPANY,)
D/B/A AT&T MOBILITY)
FOR ISSUANCE OF A CERTIFICATE OF PUBLIC) CASE NO.: 2018-00340
CONVENIENCE AND NECESSITY TO CONSTRUCT)
A WIRELESS COMMUNICATIONS FACILITY)
IN THE COMMONWEALTH OF KENTUCKY)
IN THE COUNTY OF HARLAN)

SITE NAME: WALLINS CREEK

* * * * *

**APPLICATION FOR
CERTIFICATE OF PUBLIC CONVENIENCE AND NECESSITY
FOR CONSTRUCTION OF A WIRELESS COMMUNICATIONS FACILITY**

New Cingular Wireless PCS, LLC, a Delaware limited liability company, d/b/a AT&T Mobility ("Applicant"), by counsel, pursuant to (i) KRS §§ 278.020, 278.040, 278.650, 278.665, and other statutory authority, and the rules and regulations applicable thereto, and (ii) the Telecommunications Act of 1996, respectfully submits this Application requesting issuance of a Certificate of Public Convenience and Necessity ("CPCN") from the Kentucky Public Service Commission ("PSC") to construct, maintain, and operate a Wireless Communications Facility ("WCF") to serve the customers of the Applicant with wireless communications services.

In support of this Application, Applicant respectfully provides and states the following information:

1. The complete name and address of the Applicant: New Cingular Wireless PCS, LLC, a Delaware limited liability company, d/b/a AT&T Mobility, having a local address of Meidinger Tower, 462 S. 4th Street, Suite 2400, Louisville, Kentucky 40202.

2. Applicant proposes construction of an antenna tower for communications services, which is to be located in an area outside the jurisdiction of a planning commission, and Applicant submits this application to the PSC for a certificate of public convenience and necessity pursuant to KRS §§ 278.020(1), 278.040, 278.650, 278.665, and other statutory authority.

3. The Certificate of Authority filed with the Kentucky Secretary of State for the Applicant entity was attached to a prior application and is part of the case record for PSC case number 2011-00473 and is hereby incorporated by reference.

4. The Applicant operates on frequencies licensed by the Federal Communications Commission ("FCC") pursuant to applicable FCC requirements. A copy of the Applicant's FCC licenses to provide wireless services are attached to this Application or described as part of **Exhibit A**, and the facility will be constructed and operated in accordance with applicable FCC regulations.

5. The public convenience and necessity require the construction of the proposed WCF. The construction of the WCF will bring or improve the Applicant's services to an area currently not served or not adequately served by the Applicant by increasing coverage or capacity and thereby enhancing the public's access to innovative and competitive wireless communications services. The WCF will provide a necessary link in the Applicant's communications network that is designed to meet the increasing demands

for wireless services in Kentucky's wireless communications service area. The WCF is an integral link in the Applicant's network design that must be in place to provide adequate coverage to the service area.

6. To address the above-described service needs, Applicant proposes to construct a WCF at County Road 1248A8 a.k.a. Camp Creek Road, Wallins Creek, Kentucky 40873 (36°48'02.36" North latitude, 83°24'43.64" West longitude), on a parcel of land located entirely within the county referenced in the caption of this application. The property on which the WCF will be located is owned by Cindy Honeycutt pursuant to a document recorded at Will Book 25, Page 78 and a Deed recorded at Deed Book 150, Page 19 in the office of the County Clerk. The proposed WCF will consist of a 255-foot tall tower, with an approximately 15-foot tall lightning arrestor attached at the top, for a total height of 270-feet. The WCF will also include concrete foundations and a shelter or cabinets to accommodate the placement of the Applicant's radio electronics equipment and appurtenant equipment. The Applicant's equipment cabinet or shelter will be approved for use in the Commonwealth of Kentucky by the relevant building inspector. The WCF compound will be fenced and all access gate(s) will be secured. A description of the manner in which the proposed WCF will be constructed is attached as **Exhibit B** and **Exhibit C**.

7. A list of utilities, corporations, or persons with whom the proposed WCF is likely to compete is attached as **Exhibit D**.

8. The site development plan and a vertical profile sketch of the WCF signed and sealed by a professional engineer registered in Kentucky depicting the tower height, as

well as a proposed configuration for the antennas of the Applicant has also been included as part of **Exhibit B**.

9. Foundation design plans signed and sealed by a professional engineer registered in Kentucky and a description of the standards according to which the tower was designed are included as part of **Exhibit C**.

10. Applicant has considered the likely effects of the installation of the proposed WCF on nearby land uses and values and has concluded that there is no more suitable location reasonably available from which adequate services can be provided, and that there are no reasonably available opportunities to co-locate Applicant's antennas on an existing structure. When suitable towers or structures exist, Applicant attempts to co-locate on existing structures such as communications towers or other structures capable of supporting Applicant's facilities; however, no other suitable or available co-location site was found to be located in the vicinity of the site.

11. A copy of the Determination of No Hazard to Air Navigation issued by the Federal Aviation Administration ("FAA") is attached as **Exhibit E**.

12. A copy of the application for Kentucky Airport Zoning Commission ("KAZC") Approval to construct the tower is attached as **Exhibit F**.

13. A geotechnical engineering firm has performed soil boring(s) and subsequent geotechnical engineering studies at the WCF site. A copy of the geotechnical engineering report, signed and sealed by a professional engineer registered in the Commonwealth of Kentucky, is attached as **Exhibit G**. The name and address of the geotechnical engineering firm and the professional engineer registered in the Commonwealth of

Kentucky who supervised the examination of this WCF site are included as part of this exhibit.

14. Clear directions to the proposed WCF site from the County seat are attached as **Exhibit H**. The name and telephone number of the preparer of **Exhibit H** are included as part of this exhibit.

15. Applicant, pursuant to a written agreement, has acquired the right to use the WCF site and associated property rights. A copy of the agreement or an abbreviated agreement recorded with the County Clerk is attached as **Exhibit I**.

16. Personnel directly responsible for the design and construction of the proposed WCF are well qualified and experienced. The tower and foundation drawings for the proposed tower submitted as part of **Exhibit C** bear the signature and stamp of a professional engineer registered in the Commonwealth of Kentucky. All tower designs meet or exceed the minimum requirements of applicable laws and regulations.

17. The Construction Manager for the proposed facility is Don Murdock and the identity and qualifications of each person directly responsible for design and construction of the proposed tower are contained in **Exhibits B & C**.

18. As noted on the Survey attached as part of **Exhibit B**, the surveyor has determined that the site is not within any flood hazard area.

19. **Exhibit B** includes a map drawn to an appropriate scale that shows the location of the proposed tower and identifies every owner of real estate within 500 feet of the proposed tower (according to the records maintained by the County Property Valuation Administrator). Every structure and every easement within 500 feet of the proposed tower

or within 200 feet of the access road including intersection with the public street system is illustrated in **Exhibit B**.

20. Applicant has notified every person who, according to the records of the County Property Valuation Administrator, owns property which is within 500 feet of the proposed tower or contiguous to the site property, by certified mail, return receipt requested, of the proposed construction. Each notified property owner has been provided with a map of the location of the proposed construction, the PSC docket number for this application, the address of the PSC, and has been informed of his or her right to request intervention. A list of the notified property owners and a copy of the form of the notice sent by certified mail to each landowner are attached as **Exhibit J** and **Exhibit K**, respectively.

21. Applicant has notified the applicable County Judge/Executive by certified mail, return receipt requested, of the proposed construction. This notice included the PSC docket number under which the application will be processed and informed the County Judge/Executive of his/her right to request intervention. A copy of this notice is attached as **Exhibit L**.

22. Notice signs meeting the requirements prescribed by 807 KAR 5:063, Section 1(2) that measure at least 2 feet in height and 4 feet in width and that contain all required language in letters of required height, have been posted, one in a visible location on the proposed site and one on the nearest public road. Such signs shall remain posted for at least two weeks after filing of the Application, and a copy of the posted text is attached as **Exhibit M**. A legal notice advertisement regarding the location of the proposed facility has been published in a newspaper of general circulation in the county in which the WCF is

proposed to be located. A copy of the newspaper legal notice advertisement is attached as part of **Exhibit M**.

23. The general area where the proposed facility is to be located is mountainous and heavily wooded. There are no existing structures within 500 feet of the proposed tower location.

24. The process that was used by the Applicant's radio frequency engineers in selecting the site for the proposed WCF was consistent with the general process used for selecting all other existing and proposed WCF within the proposed network design area. Applicant's radio frequency engineers have conducted studies and tests in order to develop a highly efficient network that is designed to handle voice and data traffic in the service area. The engineers determined an optimum area for the placement of the proposed facility in terms of elevation and location to provide the best quality service to customers in the service area. A radio frequency design search area prepared in reference to these radio frequency studies was considered by the Applicant when searching for sites for its antennas that would provide the coverage deemed necessary by the Applicant. A map of the area in which the tower is proposed to be located which is drawn to scale and clearly depicts the necessary search area within which the site should be located pursuant to radio frequency requirements is attached as **Exhibit N**.

25. The tower must be located at the proposed location and proposed height to provide necessary service to wireless communications users in the subject area. In addition to expanding and improving voice and data service for AT&T mobile customers, this site will also provide wireless local loop ("WLL") broadband internet service in the

subject area. As a participant in the FCC's Connect America Fund Phase II (CAF II) program, AT&T is aggressively deploying WLL service infrastructure to bring expanded internet access to residential and business customers in rural and other underserved areas. WLL will support internet access at the high speeds required to use and enjoy the most current business, education and entertainment technologies. Broadband service via WLL will be delivered from the tower to a dedicated antenna located at the home or business receiving service and will support downloads at 10 Mbps and uploads at 1 Mbps.

26. All Exhibits to this Application are hereby incorporated by reference as if fully set out as part of the Application.

27. All responses and requests associated with this Application may be directed to:

David A. Pike
Pike Legal Group, PLLC
1578 Highway 44 East, Suite 6
P. O. Box 369
Shepherdsville, KY 40165-0369
Telephone: (502) 955-4400
Telefax: (502) 543-4410
Email: dpike@pikelegal.com

WHEREFORE, Applicant respectfully request that the PSC accept the foregoing Application for filing and having met the requirements of KRS §§ 278.020(1), 278.650, and 278.665 and all applicable rules and regulations of the PSC, grant a Certificate of Public Convenience and Necessity to construct and operate the WCF at the location set forth herein.

Respectfully submitted,



David A. Pike
Pike Legal Group, PLLC
1578 Highway 44 East, Suite 6
P. O. Box 369
Shepherdsville, KY 40165-0369
Telephone: (502) 955-4400
Telefax: (502) 543-4410
Email: dpike@pikelegal.com
Attorney for New Cingular Wireless PCS, LLC
d/b/a AT&T Mobility

LIST OF EXHIBITS

- A - FCC License Documentation
- B - Site Development Plan:
 - 500' Vicinity Map
 - Legal Descriptions
 - Flood Plain Certification
 - Site Plan
 - Vertical Tower Profile
- C - Tower and Foundation Design
- D - Competing Utilities, Corporations, or Persons List
- E - FAA
- F - Kentucky Airport Zoning Commission
- G - Geotechnical Report
- H - Directions to WCF Site
- I - Copy of Real Estate Agreement
- J - Notification Listing
- K - Copy of Property Owner Notification
- L - Copy of County Judge/Executive Notice
- M - Copy of Posted Notices and Newspaper Notice Advertisement
- N - Copy of Radio Frequency Design Search Area

EXHIBIT A
FCC LICENSE DOCUMENTATION

Commonwealth of Kentucky
Trey Grayson, Secretary of State

8/6/2009

Division of Corporations
Business Filings

P. O. Box 718
Frankfort, KY 40602
(502) 584-2848
<http://www.sos.ky.gov>

Certificate of Authorization

Authentication Number: 84012

Jurisdiction: Briggs Law Office, PSC

Visit <http://apps.sos.ky.gov/business/obdb/certvalidate.aspx> to authenticate this certificate.


I, Trey Grayson, Secretary of State of the Commonwealth of Kentucky, do hereby certify that according to the records in the Office of the Secretary of State,
NEW CINGULAR WIRELESS PCS, LLC

, a limited liability company organized under the laws of the state of Delaware, is authorized to transact business in the Commonwealth of Kentucky and received the authority to transact business in Kentucky on October 14, 1999.

I further certify that all fees and penalties owed to the Secretary of State have been paid; that an application for certificate of withdrawal has not been filed; and that the most recent annual report required by KRS 275.190 has been delivered to the Secretary of State.

IN WITNESS WHEREOF, I have hereunto set my hand and affixed my Official Seal at Frankfort, Kentucky, this 6th day of August, 2009.

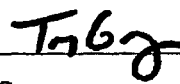


Trey Grayson
Secretary of State
Commonwealth of Kentucky
84012/0481848

REFERENCE COPY

This is not an official FCC license. It is a record of public information contained in the FCC's licensing database on the date that this reference copy was generated. In cases where FCC rules require the presentation, posting, or display of an FCC license, this document may not be used in place of an official FCC license.



**Federal Communications Commission
Wireless Telecommunications Bureau**

RADIO STATION AUTHORIZATION

LICENSEE: NEW CINGULAR WIRELESS PCS, LLC

ATTN: LESLIE WILSON
NEW CINGULAR WIRELESS PCS, LLC
208 S AKARD ST., RM 1016
DALLAS, TX 75202

Call Sign KNKN673	File Number
Radio Service CL - Cellular	
Market Number CMA453	Channel Block A
Sub-Market Designator 0	

FCC Registration Number (FRN): 0003291192

Market Name Kentucky 11 - Clay				
Grant Date 08-30-2011	Effective Date 06-13-2017	Expiration Date 10-01-2021	Five Yr Build-Out Date	Print Date

Site Information:

Location	Latitude	Longitude	Ground Elevation (meters)	Structure Hgt to Tip (meters)	Antenna Structure Registration No.
4	36-44-50.6 N	084-08-43.6 W	469.7	62.2	1043812

Address: 969 CELL TOWER ROAD (76426)
City: WILLIAMSBURG **County:** WHITLEY **State:** KY **Construction Deadline:**

Antenna: 1 Azimuth (from true north)	0	45	90	135	180	225	270	315
Antenna Height AAT (meters)	164.200	142.000	198.300	134.200	151.500	124.900	186.500	184.500
Transmitting ERP (watts)	80.790	33.632	2.346	0.254	0.164	0.164	5.156	40.160
Antenna: 2 Azimuth (from true north)	0	45	90	135	180	225	270	315
Antenna Height AAT (meters)	164.200	142.000	198.300	134.200	151.500	124.900	186.500	184.500
Transmitting ERP (watts)	1.159	16.802	80.666	104.784	22.590	1.407	0.209	0.204
Antenna: 3 Azimuth (from true north)	0	45	90	135	180	225	270	315
Antenna Height AAT (meters)	164.200	142.000	198.300	134.200	151.500	124.900	186.500	184.500
Transmitting ERP (watts)	0.393	0.106	0.095	1.187	9.994	34.712	26.126	3.238

Conditions:

Pursuant to §309(h) of the Communications Act of 1934, as amended, 47 U.S.C. §309(h), this license is subject to the following conditions: This license shall not vest in the licensee any right to operate the station nor any right in the use of the frequencies designated in the license beyond the term thereof nor in any other manner than authorized herein. Neither the license nor the right granted thereunder shall be assigned or otherwise transferred in violation of the Communications Act of 1934, as amended. See 47 U.S.C. § 310(d). This license is subject in terms to the right of use or control conferred by §706 of the Communications Act of 1934, as amended. See 47 U.S.C. §606.

Licensee Name: NEW CINGULAR WIRELESS PCS, LLC

Call Sign: KNKN673

File Number:

Print Date:

Location	Latitude	Longitude	Ground Elevation (meters)	Structure Hgt to Tip (meters)	Antenna Structure Registration No.
7	36-38-29.0 N	083-46-24.9 W	917.4	64.9	1056643

Address: 2 MILES NORTHWEST OF NOETOWN 19 MIL (76435)

City: Middlesboro County: BELL State: KY Construction Deadline:

Antenna: 1 Azimuth (from true north)	0	45	90	135	180	225	270	315
Antenna Height AAT (meters)	514.300	514.900	478.800	557.800	452.400	334.800	345.400	421.600
Transmitting ERP (watts)	41.864	12.118	1.035	0.164	0.104	0.102	0.886	11.503
Antenna: 2 Azimuth (from true north)	0	45	90	135	180	225	270	315
Antenna Height AAT (meters)	514.300	514.900	478.800	557.800	452.400	334.800	345.400	421.600
Transmitting ERP (watts)	0.286	0.947	0.706	0.874	0.879	0.224	0.101	0.109

Location	Latitude	Longitude	Ground Elevation (meters)	Structure Hgt to Tip (meters)	Antenna Structure Registration No.
12	36-58-46.0 N	083-01-30.2 W	736.8	80.5	1010610

Address: 21834 HIGHWAY 160 (76432)

City: GORDON County: LETCHER State: KY Construction Deadline:

Antenna: 1 Azimuth (from true north)	0	45	90	135	180	225	270	315
Antenna Height AAT (meters)	316.700	319.800	30.000	54.700	30.000	198.900	238.900	287.300
Transmitting ERP (watts)	112.719	46.762	8.219	1.163	0.285	0.298	5.383	44.574
Antenna: 2 Azimuth (from true north)	0	45	90	135	180	225	270	315
Antenna Height AAT (meters)	316.700	319.800	30.000	54.700	30.000	198.900	238.900	287.300
Transmitting ERP (watts)	0.636	12.989	91.274	94.955	26.405	2.175	0.841	0.311
Antenna: 3 Azimuth (from true north)	0	45	90	135	180	225	270	315
Antenna Height AAT (meters)	316.700	319.800	30.000	54.700	30.000	198.900	238.900	287.300
Transmitting ERP (watts)	1.458	0.224	0.588	1.866	27.246	84.787	72.123	11.074

Location	Latitude	Longitude	Ground Elevation (meters)	Structure Hgt to Tip (meters)	Antenna Structure Registration No.
13	36-40-53.1 N	084-08-46.5 W	446.2	58.8	

Address: 895 WAGON WHEEL ROAD (76433)

City: WILLIAMSBURG County: WHITLEY State: KY Construction Deadline:

Antenna: 1 Azimuth (from true north)	0	45	90	135	180	225	270	315
Antenna Height AAT (meters)	159.200	160.200	107.400	125.700	101.200	58.800	107.500	145.600
Transmitting ERP (watts)	24.755	89.034	70.279	10.065	1.351	0.211	0.387	1.828

Licensee Name: NEW CINGULAR WIRELESS PCS, LLC

Call Sign: KNKN673

File Number:

Print Date:

Location	Latitude	Longitude	Ground Elevation (meters)	Structure Hgt to Tip (meters)	Antenna Structure Registration No.
13	36-40-53.1 N	084-08-46.5 W	446.2	58.8	

Address: 895 WAGON WHEEL ROAD (76433)

City: WILLIAMSBURG County: WHITLEY State: KY Construction Deadline:

Antenna: 2 Azimuth (from true north)	0	45	90	135	180	225	270	315
Antenna Height AAT (meters)	159.200	160.200	107.400	125.700	101.200	58.800	107.500	145.600
Transmitting ERP (watts)	0.124	3.716	14.234	28.095	19.823	32.016	11.426	8.167
Antenna: 3 Azimuth (from true north)	0	45	90	135	180	225	270	315
Antenna Height AAT (meters)	159.200	160.200	107.400	125.700	101.200	58.800	107.500	145.600
Transmitting ERP (watts)	21.702	2.370	0.815	0.286	0.611	12.974	63.085	92.160

Location	Latitude	Longitude	Ground Elevation (meters)	Structure Hgt to Tip (meters)	Antenna Structure Registration No.
16	36-50-41.4 N	084-09-27.9 W	410.0	97.8	1204258

Address: 4499 HIGHWAY 511 (64046)

City: Rockholds County: WHITLEY State: KY Construction Deadline: 02-23-2013

Antenna: 1 Azimuth (from true north)	0	45	90	135	180	225	270	315
Antenna Height AAT (meters)	144.000	137.900	124.500	157.700	188.600	187.400	152.500	147.000
Transmitting ERP (watts)	40.926	37.139	5.069	0.465	0.105	0.099	1.028	10.105
Antenna: 2 Azimuth (from true north)	0	45	90	135	180	225	270	315
Antenna Height AAT (meters)	144.000	137.900	124.500	157.700	188.600	187.400	152.500	147.000
Transmitting ERP (watts)	0.176	0.199	0.523	10.033	46.347	45.959	7.311	1.005

Location	Latitude	Longitude	Ground Elevation (meters)	Structure Hgt to Tip (meters)	Antenna Structure Registration No.
17	37-09-19.2 N	083-26-33.1 W	516.6	98.1	1043811

Address: 2255 DAVIDSON FORK ROAD (76424)

City: THOUSAND STICKS County: LESLIE State: KY Construction Deadline: 02-23-2013

Antenna: 1 Azimuth (from true north)	0	45	90	135	180	225	270	315
Antenna Height AAT (meters)	255.100	250.600	210.300	157.900	145.900	186.400	230.000	208.500
Transmitting ERP (watts)	183.310	76.153	8.501	2.109	0.426	0.548	8.899	75.006
Antenna: 2 Azimuth (from true north)	0	45	90	135	180	225	270	315
Antenna Height AAT (meters)	255.100	250.600	210.300	157.900	145.900	186.400	230.000	208.500
Transmitting ERP (watts)	1.243	25.877	136.672	204.174	47.594	4.976	1.640	0.627

Licensee Name: NEW CINGULAR WIRELESS PCS, LLC

Call Sign: KNKN673

File Number:

Print Date:

Location	Latitude	Longitude	Ground Elevation (meters)	Structure Hgt to Tip (meters)	Antenna Structure Registration No.
17	37-09-19.2 N	083-26-33.1 W	516.6	98.1	1043811

Address: 2255 DAVIDSON FORK ROAD (76424)

City: THOUSAND STICKS County: LESLIE State: KY Construction Deadline: 02-23-2013

Antenna: 3 Azimuth (from true north)	0	45	90	135	180	225	270	315
Antenna Height AAT (meters)	255.100	250.600	210.300	157.900	145.900	186.400	230.000	208.500
Transmitting ERP (watts)	2.923	0.456	0.895	4.155	54.327	193.511	147.915	23.334

Location	Latitude	Longitude	Ground Elevation (meters)	Structure Hgt to Tip (meters)	Antenna Structure Registration No.
18	36-45-42.1 N	083-40-29.0 W	685.2	129.5	1215974

Address: RO7 PO BOX 264E BIRD BRANCH ROAD (76437)

City: PINEVILLE County: BELL State: KY Construction Deadline: 02-23-2013

Antenna: 1 Azimuth (from true north)	0	45	90	135	180	225	270	315
Antenna Height AAT (meters)	314.900	270.100	337.000	312.300	338.800	334.000	355.300	387.000
Transmitting ERP (watts)	91.981	37.204	3.868	0.986	0.201	0.271	4.377	36.079
Antenna: 2 Azimuth (from true north)	0	45	90	135	180	225	270	315
Antenna Height AAT (meters)	314.900	270.100	337.000	312.300	338.800	334.000	355.300	387.000
Transmitting ERP (watts)	2.152	13.241	26.567	29.575	18.963	5.601	3.888	1.518
Antenna: 3 Azimuth (from true north)	0	45	90	135	180	225	270	315
Antenna Height AAT (meters)	314.900	270.100	337.000	312.300	338.800	334.000	355.300	387.000
Transmitting ERP (watts)	5.299	1.993	2.409	5.378	23.634	32.748	36.478	14.971

Location	Latitude	Longitude	Ground Elevation (meters)	Structure Hgt to Tip (meters)	Antenna Structure Registration No.
19	36-53-53.5 N	083-19-27.0 W	858.6	35.4	

Address: 3017 NORTH US HIGHWAY 421 (76355)

City: BAXTER County: HARLAN State: KY Construction Deadline: 02-23-2013

Antenna: 1 Azimuth (from true north)	0	45	90	135	180	225	270	315
Antenna Height AAT (meters)	423.700	288.900	270.400	273.500	415.500	424.000	260.500	381.500
Transmitting ERP (watts)	118.281	51.051	5.389	1.305	0.258	0.357	5.945	46.435
Antenna: 2 Azimuth (from true north)	0	45	90	135	180	225	270	315
Antenna Height AAT (meters)	423.700	288.900	270.400	273.500	415.500	424.000	260.500	381.500
Transmitting ERP (watts)	4.387	28.108	56.992	61.619	38.611	11.792	8.653	3.099

Licensee Name: NEW CINGULAR WIRELESS PCS, LLC

Call Sign: KNKN673

File Number:

Print Date:

Location	Latitude	Longitude	Ground Elevation (meters)	Structure Hgt to Tip (meters)	Antenna Structure Registration No.
19	36-53-53.5 N	083-19-27.0 W	858.6	35.4	

Address: 3017 NORTH US HIGHWAY 421 (76355)

City: BAXTER County: HARLAN State: KY Construction Deadline: 02-23-2013

Antenna: 3 Azimuth (from true north)	0	45	90	135	180	225	270	315
Antenna Height AAT (meters)	423.700	288.900	270.400	273.500	415.500	424.000	260.500	381.500
Transmitting ERP (watts)	1.510	0.244	0.451	2.060	26.719	99.966	80.742	11.222

Location	Latitude	Longitude	Ground Elevation (meters)	Structure Hgt to Tip (meters)	Antenna Structure Registration No.
22	37-09-01.0 N	083-41-03.6 W	484.0	94.4	1267062

Address: Bear Creek Rd (87003)

City: Hector County: CLAY State: KY Construction Deadline: 02-23-2013

Antenna: 1 Azimuth (from true north)	0	45	90	135	180	225	270	315
Antenna Height AAT (meters)	247.900	220.000	188.600	160.500	206.100	259.700	247.500	246.500
Transmitting ERP (watts)	153.770	65.269	4.896	0.487	0.313	0.307	9.959	76.610
Antenna: 2 Azimuth (from true north)	0	45	90	135	180	225	270	315
Antenna Height AAT (meters)	247.900	220.000	188.600	160.500	206.100	259.700	247.500	246.500
Transmitting ERP (watts)	1.554	22.565	112.704	140.260	30.708	1.874	0.302	0.278
Antenna: 3 Azimuth (from true north)	0	45	90	135	180	225	270	315
Antenna Height AAT (meters)	247.900	220.000	188.600	160.500	206.100	259.700	247.500	246.500
Transmitting ERP (watts)	1.012	0.314	0.295	4.424	44.416	139.728	106.944	13.222

Location	Latitude	Longitude	Ground Elevation (meters)	Structure Hgt to Tip (meters)	Antenna Structure Registration No.
23	37-08-58.7 N	083-45-07.4 W	452.6	96.0	1043808

Address: LUCAS ROAD ON TOP OF HILL (76428)

City: MANCHESTER County: CLAY State: KY Construction Deadline:

Antenna: 1 Azimuth (from true north)	0	45	90	135	180	225	270	315
Antenna Height AAT (meters)	212.800	191.000	150.800	181.400	199.900	198.200	202.800	202.900
Transmitting ERP (watts)	111.736	45.822	5.058	1.185	0.248	0.336	5.441	44.976
Antenna: 2 Azimuth (from true north)	0	45	90	135	180	225	270	315
Antenna Height AAT (meters)	212.800	191.000	150.800	181.400	199.900	198.200	202.800	202.900
Transmitting ERP (watts)	0.630	13.113	68.789	97.232	23.078	2.526	0.830	0.308

Licensee Name: NEW CINGULAR WIRELESS PCS, LLC

Call Sign: KNKN673

File Number:

Print Date:

Location	Latitude	Longitude	Ground Elevation (meters)	Structure Hgt to Tip (meters)	Antenna Structure Registration No.
23	37-08-58.7 N	083-45-07.4 W	452.6	96.0	1043808

Address: LUCAS ROAD ON TOP OF HILL (76428)

City: MANCHESTER County: CLAY State: KY Construction Deadline:

Antenna: 3 Azimuth (from true north)	0	45	90	135	180	225	270	315
Antenna Height AAT (meters)	212.800	191.000	150.800	181.400	199.900	198.200	202.800	202.900
Transmitting ERP (watts)	4.442	3.181	3.850	5.507	16.941	16.885	21.020	12.170

Location	Latitude	Longitude	Ground Elevation (meters)	Structure Hgt to Tip (meters)	Antenna Structure Registration No.
24	36-52-13.8 N	083-24-54.2 W	835.2	80.5	1007945

Address: 3700 WATTS CREEK TOWER ROAD (76431)

City: WALLINS CREEK County: HARLAN State: KY Construction Deadline:

Antenna: 1 Azimuth (from true north)	0	45	90	135	180	225	270	315
Antenna Height AAT (meters)	357.800	283.300	392.600	363.200	337.000	470.900	325.200	332.900
Transmitting ERP (watts)	116.142	48.918	4.986	1.287	0.267	0.341	5.779	46.632
Antenna: 2 Azimuth (from true north)	0	45	90	135	180	225	270	315
Antenna Height AAT (meters)	357.800	283.300	392.600	363.200	337.000	470.900	325.200	332.900
Transmitting ERP (watts)	1.626	16.756	46.777	60.050	27.346	5.464	2.977	1.029
Antenna: 3 Azimuth (from true north)	0	45	90	135	180	225	270	315
Antenna Height AAT (meters)	357.800	283.300	392.600	363.200	337.000	470.900	325.200	332.900
Transmitting ERP (watts)	1.479	0.233	0.427	2.031	27.025	95.886	77.822	11.442

Location	Latitude	Longitude	Ground Elevation (meters)	Structure Hgt to Tip (meters)	Antenna Structure Registration No.
25	36-36-37.5 N	083-42-49.1 W	346.5	60.3	1232693

Address: 131 AMESBURY STREET (76438)

City: MIDDLESBORO County: BELL State: KY Construction Deadline:

Antenna: 1 Azimuth (from true north)	0	45	90	135	180	225	270	315
Antenna Height AAT (meters)	30.000	30.000	30.000	30.000	30.000	30.000	30.000	30.000
Transmitting ERP (watts)	145.069	41.420	3.508	0.571	0.313	0.301	3.015	39.614
Antenna: 2 Azimuth (from true north)	0	45	90	135	180	225	270	315
Antenna Height AAT (meters)	30.000	30.000	30.000	30.000	30.000	30.000	30.000	30.000
Transmitting ERP (watts)	0.125	3.991	32.278	53.652	8.875	0.818	0.150	0.111

Licensee Name: NEW CINGULAR WIRELESS PCS, LLC

Call Sign: KNKN673

File Number:

Print Date:

Location	Latitude	Longitude	Ground Elevation (meters)	Structure Hgt to Tip (meters)	Antenna Structure Registration No.
25	36-36-37.5 N	083-42-49.1 W	346.5	60.3	1232693

Address: 131 AMESBURY STREET (76438)

City: MIDDLESBORO **County:** BELL **State:** KY **Construction Deadline:**

Antenna: 3 Azimuth (from true north)	0	45	90	135	180	225	270	315
Antenna Height AAT (meters)	30.000	30.000	30.000	30.000	30.000	30.000	30.000	30.000
Transmitting ERP (watts)	0.906	0.242	0.226	0.866	20.330	108.084	76.154	7.898

Location	Latitude	Longitude	Ground Elevation (meters)	Structure Hgt to Tip (meters)	Antenna Structure Registration No.
26	36-42-35.9 N	083-40-58.1 W	636.1	57.3	

Address: RURAL ROUTE 1 BOX 109 (76441)

City: PINEVILLE **County:** BELL **State:** KY **Construction Deadline:**

Antenna: 1 Azimuth (from true north)	0	45	90	135	180	225	270	315
Antenna Height AAT (meters)	218.900	188.400	284.100	201.300	245.000	65.400	242.700	257.700
Transmitting ERP (watts)	15.060	36.966	29.277	42.643	20.844	12.416	3.511	5.735
Antenna: 2 Azimuth (from true north)	0	45	90	135	180	225	270	315
Antenna Height AAT (meters)	218.900	188.400	284.100	201.300	245.000	65.400	242.700	257.700
Transmitting ERP (watts)	0.639	0.133	0.186	4.240	28.970	66.602	17.897	2.186

Control Points:

Control Pt. No. 1

Address: 1650 LYNDON FARMS COURT

City: LOUISVILLE **County:** **State:** KY **Telephone Number:** (502)329-4700

Waivers/Conditions:

License renewal granted on a conditional basis, subject to the outcome of FCC proceeding WT Docket No. 10-112 (see FCC 10-86, paras. 113 and 126).

WE MAKE NO FINDING IN THESE CASES THE ISSUES RAISED IN FOOTNOTE 3 OF LA STAR CELLULAR TELEPHONE COMPANY, 7 FF Rcd 3762 (1992). THEREFORE, THESE GRANTS OF TRANSFERS/ASSIGNMENTS ARE CONDITIONED ON ANY SUBSEQUENT ACTION THE COMMISSION MAY TAKE CONCERNING THE

Commission approval of this application and the licenses contained therein are subject to the conditions set forth in the Memorandum Opinion and Order, adopted on December 29, 2006 and released on March 26, 2007, and revised in the Order on Reconsideration, adopted and released on March 26, 2007. See AT&T Inc. and BellSouth Corporation Application for Transfer of Control, WC Docket No. 06-74, Memorandum Opinion and Order, FCC 06-189 (rel. Mar. 26, 2007); AT&T Inc. and BellSouth Corporation, WC Docket No. 06-74, Order on Reconsideration, FCC 07-44 (rel. Mar. 26, 2007).

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Federal Communications Commission

Wireless Telecommunications Bureau

RADIO STATION AUTHORIZATION

LICENSEE: NEW CINGULAR WIRELESS PCS, LLC

ATTN: LESLIE WILSON
NEW CINGULAR WIRELESS PCS, LLC
208 S AKARD ST., RM 1016
DALLAS, TX 75202

Call Sign	File Number
KNLF288	
Radio Service	
CW - PCS Broadband	

FCC Registration Number (FRN): 0003291192

Grant Date 06-02-2015	Effective Date 06-13-2017	Expiration Date 06-23-2025	Print Date
Market Number MTA044	Channel Block B	Sub-Market Designator 0	
Market Name Knoxville			
1st Build-out Date 06-23-2000	2nd Build-out Date 06-23-2005	3rd Build-out Date	4th Build-out Date

Waivers/Conditions:

License renewal granted on a conditional basis, subject to the outcome of FCC proceeding WT Docket No. 10-112 (see FCC 10-86, paras. 113 and 126).

Commission approval of this application and the licenses contained therein are subject to the conditions set forth in the Memorandum Opinion and Order, adopted on December 29, 2006 and released on March 26, 2007, and revised in the Order on Reconsideration, adopted and released on March 26, 2007. See AT&T Inc. and BellSouth Corporation Application for Transfer of Control, WC Docket No. 06-74, Memorandum Opinion and Order, FCC 06-189 (rel. Mar. 26, 2007); AT&T Inc. and BellSouth Corporation, WC Docket No. 06-74, Order on Reconsideration, FCC 07-44 (rel. Mar. 26, 2007).

Conditions:

Pursuant to §309(h) of the Communications Act of 1934, as amended, 47 U.S.C. §309(h), this license is subject to the following conditions: This license shall not vest in the licensee any right to operate the station nor any right in the use of the frequencies designated in the license beyond the term thereof nor in any other manner than authorized herein. Neither the license nor the right granted thereunder shall be assigned or otherwise transferred in violation of the Communications Act of 1934, as amended. See 47 U.S.C. § 310(d). This license is subject in terms to the right of use or control conferred by §706 of the Communications Act of 1934, as amended. See 47 U.S.C. §606.

This license may not authorize operation throughout the entire geographic area or spectrum identified on the hardcopy version. To view the specific geographic area and spectrum authorized by this license, refer to the Spectrum and Market Area information under the Market Tab of the license record in the Universal Licensing System (ULS). To view the license record, go to the ULS homepage at <http://wireless.fcc.gov/uls/index.htm?job=home> and select "License Search". Follow the instructions on how to search for license information.

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Federal Communications Commission

Wireless Telecommunications Bureau

RADIO STATION AUTHORIZATION

LICENSEE: NEW CINGULAR WIRELESS PCS, LLC

ATTN: LESLIE WILSON
NEW CINGULAR WIRELESS PCS, LLC
208 S AKARD ST., RM 1016
DALLAS, TX 75202

Call Sign KNLH550	File Number
Radio Service CW - PCS Broadband	

FCC Registration Number (FRN): 0003291192

Grant Date 04-11-2017	Effective Date 06-14-2017	Expiration Date 04-28-2027	Print Date
Market Number BTA229	Channel Block E	Sub-Market Designator 0	
Market Name Kingsport-Johnston City, TN-Br			
1st Build-out Date 04-28-2002	2nd Build-out Date	3rd Build-out Date	4th Build-out Date

Waivers/Conditions:

This authorization is subject to the condition that, in the event that systems using the same frequencies as granted herein are authorized in an adjacent foreign territory (Canada/United States), future coordination of any base station transmitters within 72 km (45 miles) of the United States/Canada border shall be required to eliminate any harmful interference to operations in the adjacent foreign territory and to ensure continuance of equal access to the frequencies by both countries.

License renewal granted on a conditional basis, subject to the outcome of FCC proceeding WT Docket No. 10-112 (see FCC 10-86, paras. 113 and 126).

Conditions:

Pursuant to §309(h) of the Communications Act of 1934, as amended, 47 U.S.C. §309(h), this license is subject to the following conditions: This license shall not vest in the licensee any right to operate the station nor any right in the use of the frequencies designated in the license beyond the term thereof nor in any other manner than authorized herein. Neither the license nor the right granted thereunder shall be assigned or otherwise transferred in violation of the Communications Act of 1934, as amended. See 47 U.S.C. § 310(d). This license is subject in terms to the right of use or control conferred by §706 of the Communications Act of 1934, as amended. See 47 U.S.C. §606.

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Licensee Name: NEW CINGULAR WIRELESS PCS, LLC

Call Sign: KNLH550

File Number:

Print Date:

This authorization is subject to the condition that the remaining balance of the winning bid amount will be paid in accordance with Part 1 of the Commission's rules, 47 C.F.R. Part 1.

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Federal Communications Commission

Wireless Telecommunications Bureau

RADIO STATION AUTHORIZATION

LICENSEE: NEW CINGULAR WIRELESS PCS, LLC

ATTN: LESLIE WILSON
NEW CINGULAR WIRELESS PCS, LLC
208 S AKARD ST., RM 1016
DALLAS, TX 75202

Call Sign	File Number
KNLH575	
Radio Service	
CW - PCS Broadband	

FCC Registration Number (FRN): 0003291192

Grant Date 04-13-2017	Effective Date 06-14-2017	Expiration Date 04-28-2027	Print Date
Market Number BTA295	Channel Block E	Sub-Market Designator 0	
Market Name Middlesboro-Harlan, KY			
1st Build-out Date 04-28-2002	2nd Build-out Date	3rd Build-out Date	4th Build-out Date

Waivers/Conditions:

This authorization is subject to the condition that, in the event that systems using the same frequencies as granted herein are authorized in an adjacent foreign territory (Canada/United States), future coordination of any base station transmitters within 72 km (45 miles) of the United States/Canada border shall be required to eliminate any harmful interference to operations in the adjacent foreign territory and to ensure continuance of equal access to the frequencies by both countries.

License renewal granted on a conditional basis, subject to the outcome of FCC proceeding WT Docket No. 10-112 (see FCC 10-86, paras. 113 and 126).

Conditions:

Pursuant to §309(h) of the Communications Act of 1934, as amended, 47 U.S.C. §309(h), this license is subject to the following conditions: This license shall not vest in the licensee any right to operate the station nor any right in the use of the frequencies designated in the license beyond the term thereof nor in any other manner than authorized herein. Neither the license nor the right granted thereunder shall be assigned or otherwise transferred in violation of the Communications Act of 1934, as amended. See 47 U.S.C. § 310(d). This license is subject in terms to the right of use or control conferred by §706 of the Communications Act of 1934, as amended. See 47 U.S.C. §606.

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Licensee Name: NEW CINGULAR WIRELESS PCS, LLC

Call Sign: KNLH575

File Number:

Print Date:

This authorization is subject to the condition that the remaining balance of the winning bid amount will be paid in accordance with Part 1 of the Commission's rules, 47 C.F.R. Part 1.

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Federal Communications Commission

Wireless Telecommunications Bureau

RADIO STATION AUTHORIZATION

LICENSEE: NEW CINGULAR WIRELESS PCS, LLC

ATTN: LESLIE WILSON
NEW CINGULAR WIRELESS PCS, LLC
208 S AKARD ST., RM 1016
DALLAS, TX 75202

Call Sign	File Number
WQGA824	
Radio Service	
AW - AWS (1710-1755 MHz and 2110-2155 MHz)	

FCC Registration Number (FRN): 0003291192

Grant Date 11-29-2006	Effective Date 06-14-2017	Expiration Date 11-29-2021	Print Date
Market Number CMA453	Channel Block A	Sub-Market Designator 0	
Market Name Kentucky 11 - Clay			
1st Build-out Date	2nd Build-out Date	3rd Build-out Date	4th Build-out Date

Waivers/Conditions:

This authorization is conditioned upon the licensee, prior to initiating operations from any base or fixed station, making reasonable efforts to coordinate frequency usage with known co-channel and adjacent channel incumbent federal users operating in the 1710-1755 MHz band whose facilities could be affected by the proposed operations. See, e.g., FCC and NTIA Coordination Procedures in the 1710-1755 MHz Band, Public Notice, FCC 06-50, WTB Docket No. 02-353, rel. April 20, 2006.

Conditions:

Pursuant to §309(h) of the Communications Act of 1934, as amended, 47 U.S.C. §309(h), this license is subject to the following conditions: This license shall not vest in the licensee any right to operate the station nor any right in the use of the frequencies designated in the license beyond the term thereof nor in any other manner than authorized herein. Neither the license nor the right granted thereunder shall be assigned or otherwise transferred in violation of the Communications Act of 1934, as amended. See 47 U.S.C. § 310(d). This license is subject in terms to the right of use or control conferred by §706 of the Communications Act of 1934, as amended. See 47 U.S.C. §606.

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Federal Communications Commission

Wireless Telecommunications Bureau

RADIO STATION AUTHORIZATION

LICENSEE: NEW CINGULAR WIRELESS PCS, LLC

ATTN: LESLIE WILSON
NEW CINGULAR WIRELESS PCS, LLC
208 S AKARD ST., RM 1016
DALLAS, TX 75202

Call Sign	File Number
WQGA852	
Radio Service	
AW - AWS (1710-1755 MHz and 2110-2155 MHz)	

FCC Registration Number (FRN): 0003291192

Grant Date 11-29-2006	Effective Date 06-14-2017	Expiration Date 11-29-2021	Print Date
Market Number CMA681	Channel Block A	Sub-Market Designator 0	
Market Name Virginia 1 - Lee			
1st Build-out Date	2nd Build-out Date	3rd Build-out Date	4th Build-out Date

Waivers/Conditions:

This authorization is conditioned upon the licensee, prior to initiating operations from any base or fixed station, making reasonable efforts to coordinate frequency usage with known co-channel and adjacent channel incumbent federal users operating in the 1710-1755 MHz band whose facilities could be affected by the proposed operations. See, e.g., FCC and NTIA Coordination Procedures in the 1710-1755 MHz Band, Public Notice, FCC 06-50, WTB Docket No. 02-353, rel. April 20, 2006.

Conditions:

Pursuant to §309(h) of the Communications Act of 1934, as amended, 47 U.S.C. §309(h), this license is subject to the following conditions: This license shall not vest in the licensee any right to operate the station nor any right in the use of the frequencies designated in the license beyond the term thereof nor in any other manner than authorized herein. Neither the license nor the right granted thereunder shall be assigned or otherwise transferred in violation of the Communications Act of 1934, as amended. See 47 U.S.C. § 310(d). This license is subject in terms to the right of use or control conferred by §706 of the Communications Act of 1934, as amended. See 47 U.S.C. §606.

This license may not authorize operation throughout the entire geographic area or spectrum identified on the hardcopy version. To view the specific geographic area and spectrum authorized by this license, refer to the Spectrum and Market Area information under the Market Tab of the license record in the Universal Licensing System (ULS). To view the license record, go to the ULS homepage at <http://wireless.fcc.gov/uls/index.htm?job=home> and select "License Search". Follow the instructions on how to search for license information.

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Federal Communications Commission

Wireless Telecommunications Bureau

RADIO STATION AUTHORIZATION

LICENSEE: NEW CINGULAR WIRELESS PCS, LLC

ATTN: LESLIE WILSON
NEW CINGULAR WIRELESS PCS, LLC
208 S AKARD ST., RM 1016
DALLAS, TX 75202

Call Sign WQGD755	File Number 0007761932
Radio Service AW - AWS (1710-1755 MHz and 2110-2155 MHz)	

FCC Registration Number (FRN): 0003291192

Grant Date 12-18-2006	Effective Date 09-05-2017	Expiration Date 12-18-2021	Print Date 09-28-2017
Market Number BEA047	Channel Block C	Sub-Market Designator 7	
Market Name Lexington, KY-TN-VA-WV			
1st Build-out Date	2nd Build-out Date	3rd Build-out Date	4th Build-out Date

Waivers/Conditions:

This authorization is conditioned upon the licensee, prior to initiating operations from any base or fixed station, making reasonable efforts to coordinate frequency usage with known co-channel and adjacent channel incumbent federal users operating in the 1710-1755 MHz band whose facilities could be affected by the proposed operations. See, e.g., FCC and NTIA Coordination Procedures in the 1710-1755 MHz Band, Public Notice, FCC 06-50, WTB Docket No. 02-353, rel. April 20, 2006.

Grant of the request to update licensee name is conditioned on it not reflecting an assignment or transfer of control (see Rule 1.948); if an assignment or transfer occurred without proper notification or FCC approval, the grant is void and the station is licensed under the prior name.

Conditions:

Pursuant to §309(h) of the Communications Act of 1934, as amended, 47 U.S.C. §309(h), this license is subject to the following conditions: This license shall not vest in the licensee any right to operate the station nor any right in the use of the frequencies designated in the license beyond the term thereof nor in any other manner than authorized herein. Neither the license nor the right granted thereunder shall be assigned or otherwise transferred in violation of the Communications Act of 1934, as amended. See 47 U.S.C. § 310(d). This license is subject in terms to the right of use or control conferred by §706 of the Communications Act of 1934, as amended. See 47 U.S.C. §606.

This license may not authorize operation throughout the entire geographic area or spectrum identified on the hardcopy version. To view the specific geographic area and spectrum authorized by this license, refer to the Spectrum and Market Area information under the Market Tab of the license record in the Universal Licensing System (ULS). To view the license record, go to the ULS homepage at <http://wireless.fcc.gov/uls/index.htm?job=home> and select "License Search". Follow the instructions on how to search for license information.

Commonwealth of Kentucky
Trey Grayson, Secretary of State

8/6/2009

Division of Corporations
Business Filings

P. O. Box 718
Frankfort, KY 40602
(502) 584-2848
<http://www.sos.ky.gov>

Certificate of Authorization

Authentication Number: 84012

Jurisdiction: Briggs Law Office, PSC

Visit <http://apps.sos.ky.gov/business/obdb/certvaldate.aspx> to authenticate this certificate.

I, Trey Grayson, Secretary of State of the Commonwealth of Kentucky, do hereby certify that according to the records in the Office of the Secretary of State,
NEW CINGULAR WIRELESS PCS, LLC

, a limited liability company organized under the laws of the state of Delaware, is authorized to transact business in the Commonwealth of Kentucky and received the authority to transact business in Kentucky on October 14, 1999.

I further certify that all fees and penalties owed to the Secretary of State have been paid; that an application for certificate of withdrawal has not been filed; and that the most recent annual report required by KRS 275.190 has been delivered to the Secretary of State.

IN WITNESS WHEREOF, I have hereunto set my hand and affixed my Official Seal at Frankfort, Kentucky, this 6th day of August, 2009.




Trey Grayson

Trey Grayson
Secretary of State
Commonwealth of Kentucky
84012/0481848

EXHIBIT B

SITE DEVELOPMENT PLAN:

**500' VICINITY MAP
LEGAL DESCRIPTIONS
FLOOD PLAIN CERTIFICATION
SITE PLAN
VERTICAL TOWER PROFILE**

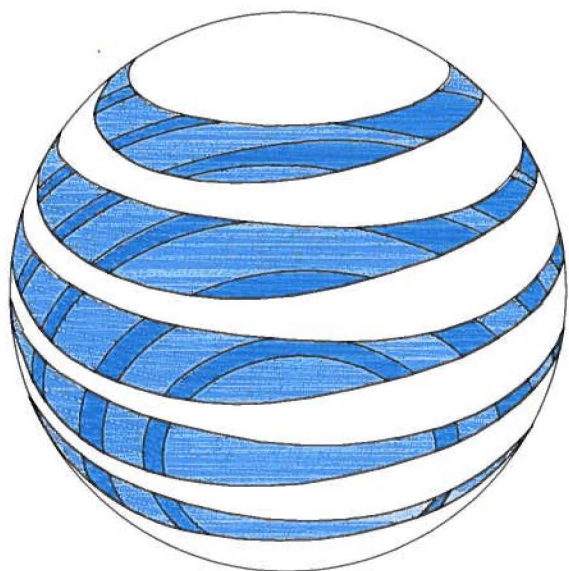

at&t


SITE NAME:

WALLINS CREEK

SITE NUMBER:

-

PROPOSED RAW LAND SITE WITH 255' SELF-SUPPORT TOWER W/
15' LIGHTNING ARRESTOR AND INSTALLATION OF AN 80" x 80"
WALK-IN CABINET & DIESEL GENERATOR ON STEEL PLATFORMS

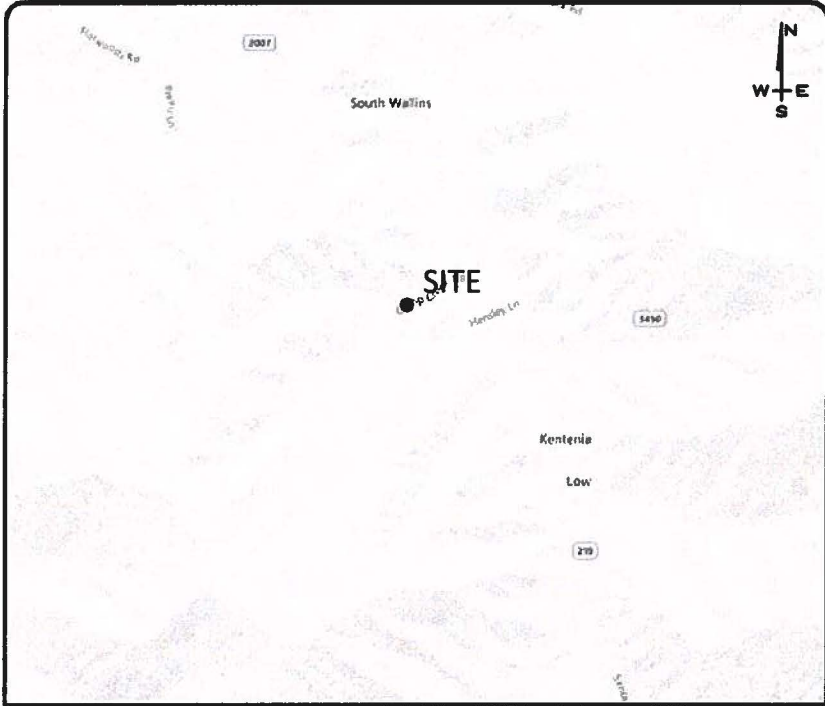

VICINITY MAP

SCALE: NONE

DRIVE DIRECTIONS

FROM HARLAN COUNTY CLERK, 210 E CENTRAL ST, HARLAN, KY 40831 :
HEAD WEST ON E CENTRAL ST TOWARD N 1ST ST 0.2 MILES
DRIVE ALONG US-119 S 8.2 MILES
TAKE STATE HWY 219 TO HENSLEY LN SPUR IN SOUTH WALLINS 2.7 MILES
ARRIVE AT SITE ENTRANCE, ON THE LEFT

SCOPE OF WORK:

ZONING DRAWINGS FOR:
CONSTRUCTION OF A NEW UNMANNED TELECOMMUNICATIONS FACILITY.
SITE WORK: NEW TOWER, UNMANNED WALK-IN CABINET WITH GENERATOR ON STEEL PLATFORMS, AND UTILITY INSTALLATIONS.

PROJECT INFORMATION

COUNTY: HARLAN
SITE ADDRESS: COUNTY ROAD 1248A8
A.K.A. CAMP CREEK ROAD
WALLINS CREEK, KY 40873
APPLICANT: NEW CINGULAR WIRELESS PCS, LLC,
A DELAWARE LIMITED LIABILITY
COMPANY, D/B/A AT&T MOBILITY
MEIDINGER TOWER
462 S. 4TH STREET, SUITE 2400
LOUISVILLE, KY 40202
LATITUDE: 36° 48' 02.36"
LONGITUDE: 83° 24' 43.64"



Know what's below.
Call before you dig.
Call Monday thru Friday - 7 am. to 6 pm.
1-800-752-6007
PER KENTUCKY STATE LAW, IT IS AGAINST THE LAW
TO EXCAVATE WITHOUT NOTIFYING THE
UNDERGROUND LOCATION SERVICE TWO (2)
WORKING DAYS BEFORE COMMENCING WORK.

SHEET INDEX

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B-1.1 SITE SURVEY
B-1.2 SITE SURVEY
B-1.3 SITE SURVEY
B-1.4 SITE SURVEY
B-2 500' RADIUS AND ABUTTERS MAP
CIVIL:
C-1 OVERALL SITE LAYOUT
C-2 OVERALL SITE LAYOUT - CONT'D
C-3 ENLARGED COMPOUND LAYOUT
C-4 TOWER ELEVATION

CONTACT INFORMATION

FIRE DEPARTMENT
WALLINS CREEK VOLUNTEER FIRE DEPARTMENT
PHONE: (606) 664-2609
POLICE DEPARTMENT
HARLAN COUNTY SHERIFF
PHONE: (606) 573-1313
ELECTRIC COMPANY
AEP
PHONE: (859) 744-1490
TELEPHONE COMPANY
AT&T
PHONE: (210) 821-4105

BUILDING CODES AND STANDARDS

CONTRACTOR'S WORK SHALL COMPLY WITH ALL
APPLICABLE NATIONAL, STATE AND LOCAL CODES AS
ADOPTED BY THE LOCAL AUTHORITY HAVING JURISDICTION
FOR THE LOCATION.
• CONTRACTOR'S WORK SHALL COMPLY WITH THE
LATEST EDITION OF THE FOLLOWING STANDARDS:
• AMERICAN CONCRETE INSTITUTE 318
• AMERICAN INSTITUTE OF STEEL CONSTRUCTION
MANUAL OF STEEL CONSTRUCTION
• TELECOMMUNICATIONS INDUSTRY ASSOCIATION
TIA-222
• STRUCTURAL STANDARDS FOR STEEL ANTENNA
TOWER AND SUPPORTING STRUCTURES TIA-601
• COMMERCIAL BUILDING GROUNDING AND BONDING
REQUIREMENTS FOR TELECOMMUNICATIONS
• INSTITUTE FOR ELECTRICAL AND ELECTRONICS
ENGINEERS IEEE-81, IEEE 1100, IEEE C62.41
• ANSI T1.311, FOR TELECOM - DC POWER SYSTEMS -
TELECOM, ENVIRONMENTAL PROTECTION
• 2014 KBC
• 2014 NEC
FOR ANY CONFLICTS BETWEEN SECTIONS OF LISTED CODES
AND STANDARDS, THE MOST RESTRICTIVE REQUIREMENT
SHALL GOVERN.



EN PERMIT: 3594

ZONING
DRAWINGS

REV	DATE	DESCRIPTION
A	9.21.18	ISSUED FOR REVIEW
D	10.4.18	ISSUED AS FINAL

SITE INFORMATION:
WALLINS CREEK
COUNTY ROAD 1248A8
A.K.A. CAMP CREEK ROAD
WALLINS CREEK, KY 40873
HARLAN COUNTY
SITE NUMBER:
-

POD NUMBER: 18-21592
DRAWN BY: KDP
CHECKED BY: MEP
DATE: 9.21.18

SHEET TITLE:
TITLE SHEET
& PROJECT
INFORMATION

SHEET NUMBER:
T-1

FAA COORDINATE POINT
NAD 83
LATITUDE: 36°48'02.36"
LONGITUDE: 83°24'43.64"
NAVD 88
ELEVATION: 1537'± AMSL
NORTHING: 3459574.852
EASTING: 5605746.887

TEMPORARY BENCHMARK
NORTHING: 3459678.899
EASTING: 5605712.273
ELEVATION: 1539.29'
LOCATION: A 60D NAIL
N18°36'E 62.2'± FROM THE
NORTHWEST CORNER OF THE
PROPOSED LEASE AREA.

- GLOBAL POSITIONING SYSTEMS NOTE
1. THE BOUNDARY CORNERS AND A PORTION OF THE TOPOGRAPHY WAS LOCATED USING GPS.
 2. THE TYPE OF GPS UTILIZED WAS NETWORK ADJUSTED REAL TIME KINEMATIC (KDOT VRS NETWORK), NAD 83 KENTUCKY SINGLE ZONE WITH THE ORTHOMETRIC HEIGHT COMPUTED USING GEOID12A. RELATIVE POSITIONAL ACCURACY VARIED FROM 0.04' TO 0.09' HORIZONTALLY.
 3. SPECTRA PRECISION EPOCH 50 DUAL FREQUENCY RECEIVERS WERE USED TO PERFORM THE SURVEY.

GENERAL NOTES

NO SEARCH OF PUBLIC RECORDS HAS BEEN COMPLETED BY POD GROUP TO DETERMINE ANY DEFECTS AND/OR AMBIGUITIES IN THE TITLE OF THE SUBJECT PROPERTY.

THIS SURVEY IS FOR THE PROPOSED LEASE AREA AND THE PROPOSED ACCESS & UTILITY EASEMENTS ONLY, AND ONLY A PARTIAL BOUNDARY SURVEY OF THE PARENT TRACT HAS BEEN PERFORMED.

A PORTION OF THIS SURVEY WAS CONDUCTED BY METHOD OF RANDOM TRAVERSE WITH SIDE SHOTS. UNADJUSTED CLOSURE EQUALS 0.09', FOR A PRECISION OF 1:48,144 AND HAS NOT BEEN ADJUSTED.

THIS PROPERTY IS SUBJECT TO ANY RECORDED EASEMENTS AND/OR RIGHTS OF WAY SHOWN HEREON OR NOT.

THIS PLAT IS NOT INTENDED FOR LAND TRANSFER.

THE PARENT PARCEL, THE PROPOSED LEASE AREA, AND THE PROPOSED ACCESS & UTILITY EASEMENT SHOWN HEREON ARE NOT LOCATED IN A 100-YEAR FLOOD PLAIN (ZONE X) PER FLOOD HAZARD BOUNDARY MAP, COMMUNITY-PANEL NUMBER 21095C0270E, DATED MARCH 16, 2015.

LEGEND

UTILITY POLE

ONE & T ONE & T

EX. FENCE LINE

SET 1/2" REBAR 18" LONG
CAPPED "PATTERSON PLS 3136"

PROPERTY LINE


ADJACENT PROPERTY LINE

P.O.B. POINT OF BEGINNING
SPC STATE PLANE COORDINATE
EX. OVERHEAD ELECTRIC & TELEPHONE


LAND SURVEYOR'S CERTIFICATE

I, MARK E. PATTERSON, HEREBY CERTIFY THAT I AM A LICENSED PROFESSIONAL LAND SURVEYOR LICENSED IN COMPLIANCE WITH THE LAWS OF THE COMMONWEALTH OF KENTUCKY. I FURTHER CERTIFY THAT THIS PLAT AND THE SURVEY ON THE GROUND WERE PERFORMED BY PERSONS UNDER MY DIRECT SUPERVISION, AND THAT THE DIRECTIONAL AND LINEAR MEASUREMENTS BEING WITNESSED BY MONUMENTS SHOWN HEREON ARE TRUE AND CORRECT TO THE BEST OF MY KNOWLEDGE. THE "RURAL" SURVEY, AND THE PLAT ON WHICH IT IS BASED, MEETS ALL SPECIFICATIONS AS STATED IN KAR 201 18:150.


Mark Patterson
MARK PATTERSON, PLS #3136
10/5/2018
DATE

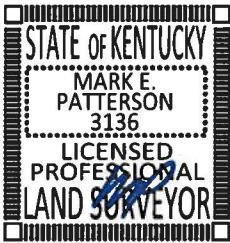

PARCEL ID: 023-00-00-001.00
POCAHONTAS SURFACE INTERESTS, INC.
DEED BOOK 467, PAGE 136

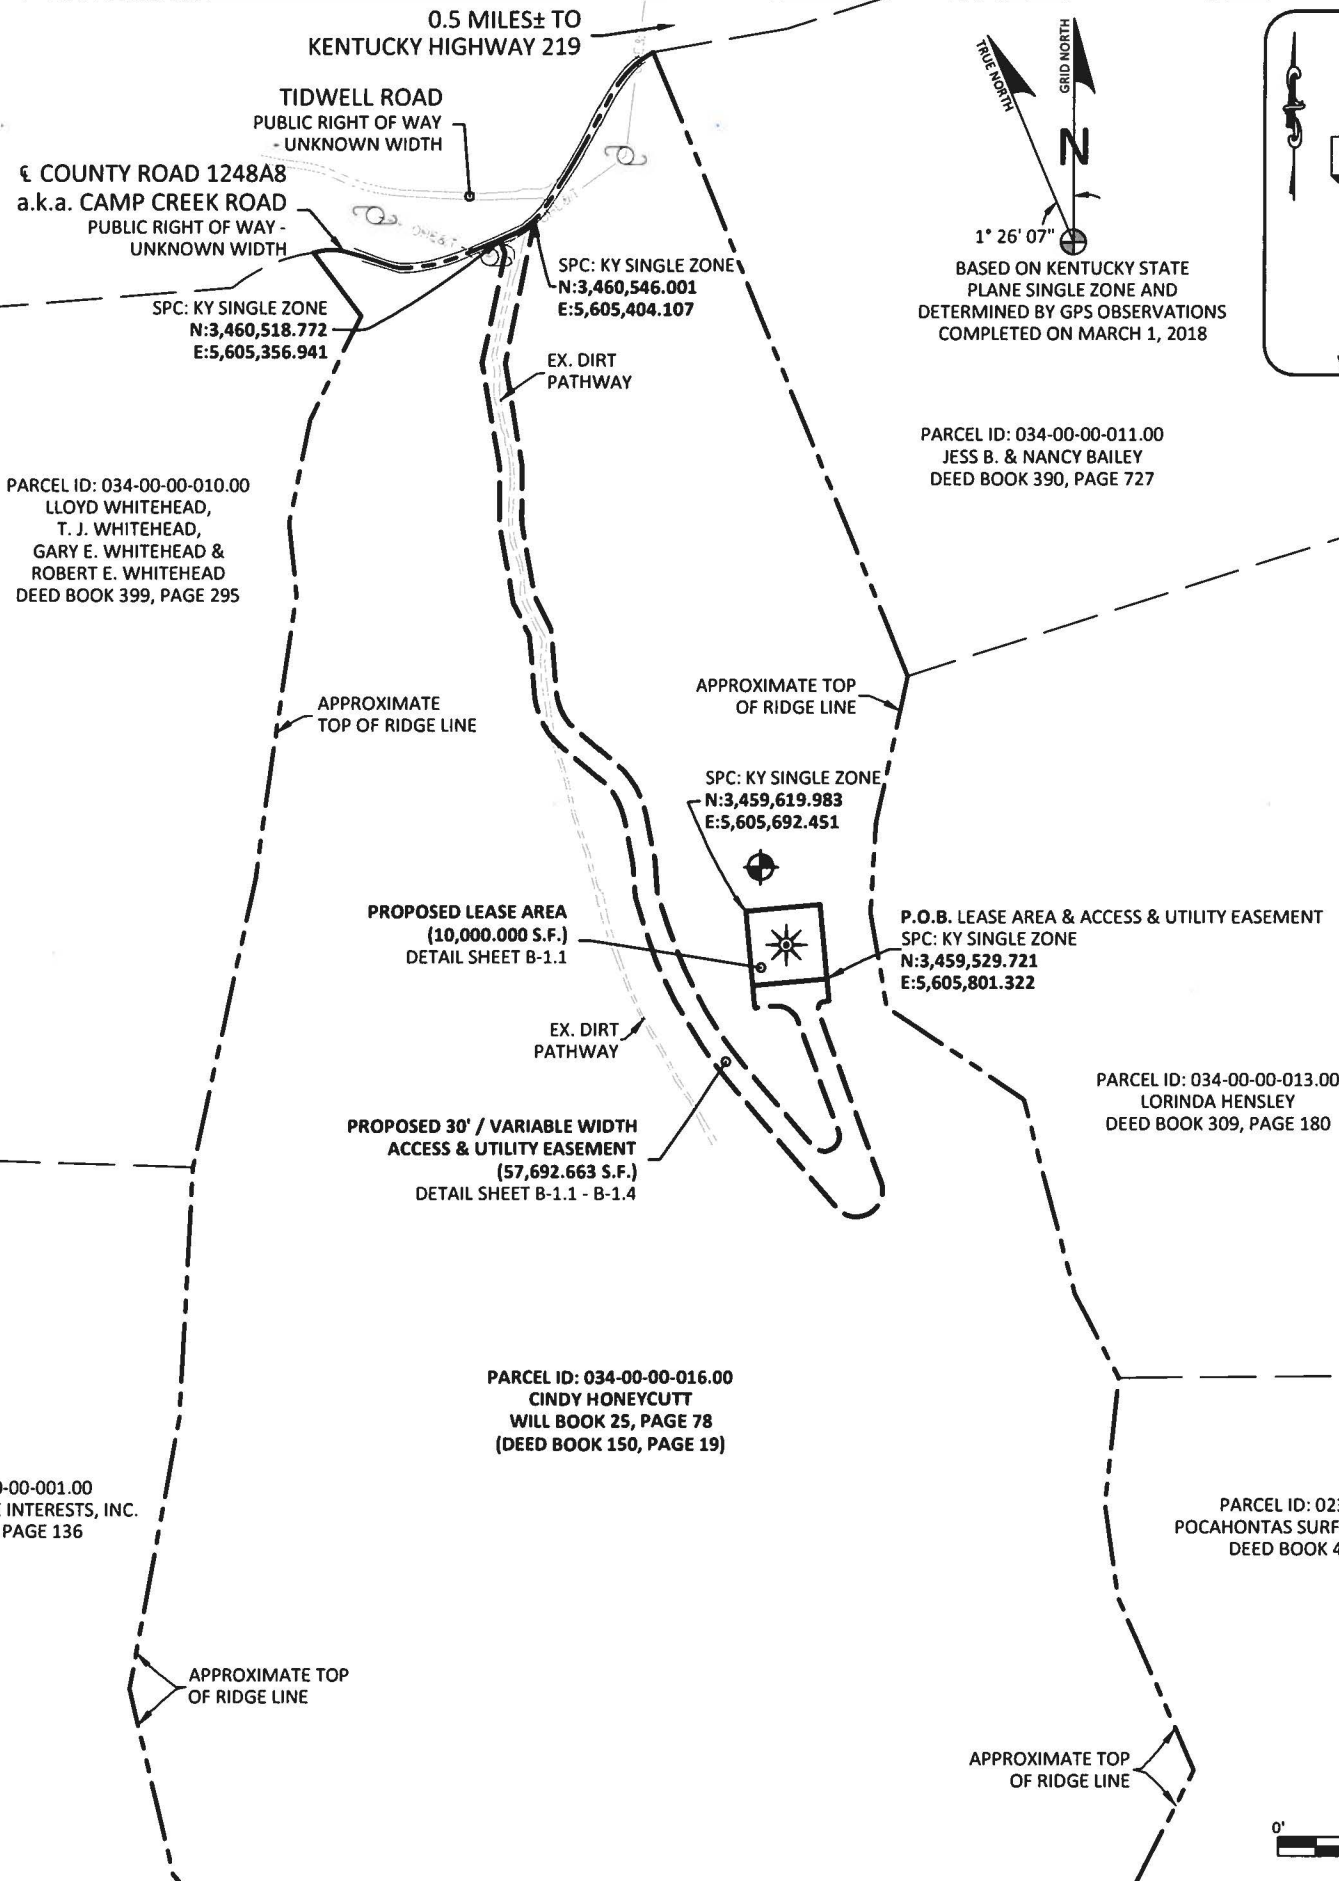

1° 26' 07"
TRUE NORTH
GRID NORTH
N
BASED ON KENTUCKY STATE
PLANE SINGLE ZONE AND
DETERMINED BY GPS OBSERVATIONS
COMPLETED ON MARCH 1, 2018

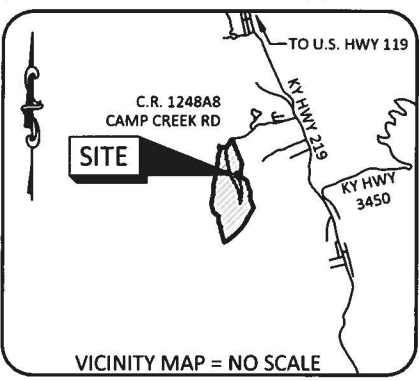

PREPARED BY:
POD
POWER OF DESIGN
11490 BLUEGRASS PARKWAY
LOUISVILLE, KY 40299
502-437-5252

PREPARED FOR:
MasTec

PREPARED FOR:
at&t

SITE SURVEY

REV.	DATE	DESCRIPTION
A	4.11.18	PRELIM ISSUE WITH TITLE
B	5.2.18	REVISED ACCESS & UTILITY EASEMENT
C	5.4.18	CLIENT COMMENTS
D	5.14.18	ISSUED AS FINAL

SITE INFORMATION:

WALLINS CREEK
COUNTY ROAD 1248A8
a.k.a. CAMP CREEK ROAD
WALLINS CREEK, KY 40873
HARLAN COUNTY

TAX PARCEL NUMBER:
034-00-00-016.00

TAX PARCEL ADDRESS:
O HENSLEY HOLLOW - WALLINS O
WALLINS CREEK, KY 40873

PROPERTY OWNER:
CINDY HONEYCUTT
P. O. BOX 356
WHITESBURG, KY 41858

SOURCE OF TITLE:
WILL BOOK 25, PAGE 78
(DEED BOOK 150, PAGE 19)


SITE NUMBER:

POD NUMBER: 18-21589

DRAWN BY: DAP
CHECKED BY: MEP
SURVEY DATE: 3.1.18
PLAT DATE: 4.2.18

SHEET TITLE:
SITE SURVEY
THIS DOES NOT REPRESENT A
BOUNDARY SURVEY OF THE
PARENT PARCEL

SHEET NUMBER: (5 pages)
B-1

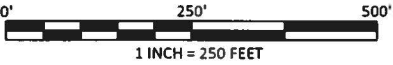

GLOBAL POSITIONING SYSTEMS NOTE

1. THE BOUNDARY CORNERS AND A PORTION OF THE TOPOGRAPHY WAS LOCATED USING GPS.
2. THE TYPE OF GPS UTILIZED WAS NETWORK ADJUSTED REAL TIME KINEMATIC (KDOT VRS NETWORK), NAD 83 KENTUCKY SINGLE ZONE WITH THE ORTHOMETRIC HEIGHT COMPUTED USING GEOID12A. RELATIVE POSITIONAL ACCURACY VARIED FROM 0.04' TO 0.09' HORIZONTALLY.
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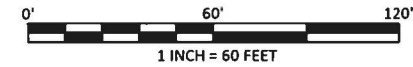
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LEGEND

- P.O.B. POINT OF BEGINNING
SPC STATE PLANE COORDINATE
X 1500' EX. GROUND ELEVATION
— X — X — X — X — EX. FENCE LINE
— SET 1/2" REBAR 18" LONG
CAPPED "PATTERSON PLS 3136"
— — — — — PROPERTY LINE
— — — — — ADJACENT PROPERTY LINE



LAND SURVEYOR'S CERTIFICATE

I, MARK E. PATTERSON, HEREBY CERTIFY THAT I AM A LICENSED PROFESSIONAL LAND SURVEYOR LICENSED IN COMPLIANCE WITH THE LAWS OF THE COMMONWEALTH OF KENTUCKY. I FURTHER CERTIFY THAT THIS PLAT AND THE SURVEY ON THE GROUND WERE PERFORMED BY PERSONS UNDER MY DIRECT SUPERVISION, AND THAT THE DIRECTIONAL AND LINEAR MEASUREMENTS BEING WITNESSED BY MONUMENTS SHOWN HEREON ARE TRUE AND CORRECT TO THE BEST OF MY KNOWLEDGE. THE "RURAL" SURVEY, AND THE PLAT ON WHICH IT IS BASED, MEETS ALL SPECIFICATIONS AS STATED IN KAR 201 18:150.

Mark Patterson
MARK PATTERSON, PLS #3136

10/5/2018
DATE



SHEET B-1.3
MATCH LINE

PARCEL ID: 034-00-00-016.00
CINDY HONEYCUTT
WILL BOOK 25, PAGE 78
(DEED BOOK 150, PAGE 19)

1° 26' 07" N
GRID NORTH
N
BASED ON KENTUCKY STATE
PLANE SINGLE ZONE AND
DETERMINED BY GPS OBSERVATIONS
COMPLETED ON MARCH 1, 2018

FAA COORDINATE POINT
NAD 83
LATITUDE: 36°48'02.36"
LONGITUDE: 83°24'43.64"
NAVD 88
ELEVATION: 1537± AMSL
NORTHING: 3459574.852
EASTING: 5605746.887

TEMPORARY BENCHMARK
NORTHING: 3459678.899
EASTING: 5605712.273
ELEVATION: 1539.29'
LOCATION: A 60D NAIL
N18°36'E 62.2± FROM THE
NORTHWEST CORNER OF THE
PROPOSED LEASE AREA.

PARCEL ID: 034-00-00-011.00
JESS B. & NANCY BAILEY
DEED BOOK 390, PAGE 727

PREPARED BY:
POD
POWER OF DESIGN
11490 BLUEGRASS PARKWAY
LOUISVILLE, KY 40299
502-437-5252

PREPARED FOR:
MasTec

PREPARED FOR:
at&t

SITE SURVEY

REV.	DATE	DESCRIPTION
A	4.11.18	PRELIM ISSUE WITH TITLE
B	5.2.18	REVISED ACCESS & UTILITY EASEMENT
C	5.4.18	CLIENT COMMENTS
D	5.14.18	ISSUED AS FINAL

SITE INFORMATION:

WALLINS CREEK
COUNTY ROAD 1248A8
a.k.a. CAMP CREEK ROAD
WALLINS CREEK, KY 40873
HARLAN COUNTY

TAX PARCEL NUMBER:
034-00-00-016.00

TAX PARCEL ADDRESS:
O HENSLEY HOLLOW - WALLINS O
WALLINS CREEK, KY 40873

PROPERTY OWNER:
CINDY HONEYCUTT
P. O. BOX 356
WHITESBURG, KY 41858

SOURCE OF TITLE:
WILL BOOK 25, PAGE 78
(DEED BOOK 150, PAGE 19)

SITE NUMBER:

POD NUMBER: 18-21589

DRAWN BY: DAP
CHECKED BY: MEP
SURVEY DATE: 3.1.18
PLAT DATE: 4.2.18

SHEET TITLE:

SITE SURVEY
THIS DOES NOT REPRESENT A
BOUNDARY SURVEY OF THE
PARENT PARCEL

SHEET NUMBER: (5 pages)

B-1.2



PER KENTUCKY STATE LAW, IT IS AGAINST THE LAW TO
EXCAVATE WITHOUT NOTIFYING THE UNDERGROUND
LOCATION SERVICE TWO (2) WORKING DAYS BEFORE
COMMENCING WORK.

PARCEL ID:
034-00-00-013.00
LORINDA HENSLEY
DEED BOOK 309, PAGE 180

MATCH LINE
SHEET B-1.1

SPC: KY SINGLE ZONE
N:3,459,619.983
E:5,605,692.451

PROPOSED
LEASE AREA
(10,000.000 S.F.)

APPROXIMATE
TOP OF RIDGE LINE

EX. BOTTOM
OF CLIFF
1538.9'
1536.6'
1552.4'
1562.1'
1562.9'
EX. TOP
OF CLIFF
1535.9'

N84°39'40"E 100.00'

NO

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FAA COORDINATE POINT
NAD 83
LATITUDE: 36°48'02.36"
LONGITUDE: 83°24'43.64"
NAVD 88
ELEVATION: 1537'± AMSL
NORTHING: 3459574.852
EASTING: 5605746.887

TEMPORARY BENCHMARK
NORTHING: 3459678.899
EASTING: 5605712.273
ELEVATION: 1539.29'
LOCATION: A 60D NAIL
N18°36'E 62.2'± FROM THE
NORTHWEST CORNER OF THE
PROPOSED LEASE AREA.

1° 26' 07" N
BASED ON KENTUCKY STATE
PLANE SINGLE ZONE AND
DETERMINED BY GPS OBSERVATIONS
COMPLETED ON MARCH 1, 2018

PREPARED BY:
POD
POWER OF DESIGN
11490 BLUEGRASS PARKWAY
LOUISVILLE, KY 40299
502-437-5252

PREPARED FOR:
MasTec

PREPARED FOR:
at&t

PARCEL ID: 034-00-00-011.00
JESS B. & NANCY BAILEY
DEED BOOK 390, PAGE 727

PARCEL ID: 034-00-00-010.00
LLOYD WHITEHEAD,
T. J. WHITEHEAD,
GARY E. WHITEHEAD &
ROBERT E. WHITEHEAD
DEED BOOK 399, PAGE 295

PROPOSED 30' / VARIABLE WIDTH
ACCESS & UTILITY EASEMENT
(57,692.663 S.F.)

PARCEL ID: 034-00-00-016.00
CINDY HONEYCUTT
WILL BOOK 25, PAGE 78
(DEED BOOK 150, PAGE 19)

GLOBAL POSITIONING SYSTEMS NOTE

1. THE BOUNDARY CORNERS AND A PORTION OF THE TOPOGRAPHY WAS LOCATED USING GPS.
2. THE TYPE OF GPS UTILIZED WAS NETWORK ADJUSTED REAL TIME KINEMATIC (KDOT VRS NETWORK), NAD 83 KENTUCKY SINGLE ZONE WITH THE ORTHOMETRIC HEIGHT COMPUTED USING GEOID12A. RELATIVE POSITIONAL ACCURACY VARIED FROM 0.04' TO 0.09' HORIZONTALLY.
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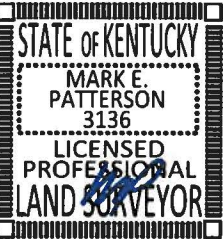
LEGEND

- UTILITY POLE
- P.O.B. POINT OF BEGINNING
SPC STATE PLANE COORDINATE
× 1500' EX. GROUND ELEVATION
EX. OVERHEAD ELECTRIC & TELEPHONE
EX. FENCE LINE
SET 1/2" REBAR 18" LONG
CAPPED "PATTERSON PLS 3136"
PROPERTY LINE
ADJACENT PROPERTY LINE

LAND SURVEYOR'S CERTIFICATE

I, MARK E. PATTERSON, HEREBY CERTIFY THAT I AM A LICENSED PROFESSIONAL LAND SURVEYOR LICENSED IN COMPLIANCE WITH THE LAWS OF THE COMMONWEALTH OF KENTUCKY. I FURTHER CERTIFY THAT THIS PLAT AND THE SURVEY ON THE GROUND WERE PERFORMED BY PERSONS UNDER MY DIRECT SUPERVISION, AND THAT THE DIRECTIONAL AND LINEAR MEASUREMENTS BEING WITNESSED BY MONUMENTS SHOWN HEREON ARE TRUE AND CORRECT TO THE BEST OF MY KNOWLEDGE. THE "RURAL" SURVEY, AND THE PLAT ON WHICH IT IS BASED, MEETS ALL SPECIFICATIONS AS STATED IN KAR 201 18:150.

Mark Patterson
MARK PATTERSON, PLS #3136
10/5/2018
DATE



SITE SURVEY

REV.	DATE	DESCRIPTION
A	4.11.18	PRELIM ISSUE WITH TITLE
B	5.2.18	REVISED ACCESS & UTILITY EASEMENT
C	5.4.18	CLIENT COMMENTS
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SITE INFORMATION:

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TAX PARCEL NUMBER:
034-00-00-016.00

TAX PARCEL ADDRESS:
O HENSLEY HOLLOW - WALLINS O
WALLINS CREEK, KY 40873

PROPERTY OWNER:
CINDY HONEYCUTT
P. O. BOX 356
WHITESBURG, KY 41858

SOURCE OF TITLE:
WILL BOOK 25, PAGE 78
(DEED BOOK 150, PAGE 19)

SITE NUMBER:

POD NUMBER: 18-21589

DRAWN BY: DAP
CHECKED BY: MEP
SURVEY DATE: 3.1.18
PLAT DATE: 4.2.18

SHEET TITLE:

SITE SURVEY
THIS DOES NOT REPRESENT A
BOUNDARY SURVEY OF THE
PARENT PARCEL

SHEET NUMBER: (5 pages)

B-1.3



PER KENTUCKY STATE LAW, IT IS AGAINST THE LAW TO
EXCAVATE WITHOUT NOTIFYING THE UNDERGROUND
LOCATION SERVICE TWO (2) WORKING DAYS BEFORE
COMMENCING WORK

APPROXIMATE TOP OF
RIDGE LINE

MATCH LINE
SHEET B-1.2

0' 60' 120'
1 INCH = 60 FEET

LEGAL DESCRIPTIONS

PROPOSED LEASE AREA

THE FOLLOWING IS A DESCRIPTION OF THE PROPOSED LEASE AREA TO BE LEASED FROM THE PROPERTY CONVEYED TO CINDY HONEYCUTT AS RECORDED IN THE OFFICE OF THE CLERK OF HARLAN COUNTY, KENTUCKY AS WILL BOOK 25, PAGE 78, BEING THE SAME PROPERTY CONVEYED TO HAGAN & WILMA HONEYCUTT AS DESCRIBED IN DEED BOOK 150, PAGE 19, PARCEL ID: 034-00-00-016.00, WHICH IS MORE PARTICULARLY DESCRIBED AS FOLLOWS:

BEARING DATUM USED HEREIN IS BASED UPON KENTUCKY STATE PLANE COORDINATE SYSTEM, SINGLE ZONE, NAD 83, FROM A REAL TIME KINEMATIC GLOBAL POSITIONING SYSTEM OBSERVATION USING THE KENTUCKY TRANSPORTATION CABINET REAL TIME GPS NETWORK COMPLETED ON MARCH 1, 2018.

BEGINNING TO A SET 1/2" REBAR, 18" LONG, CAPPED "PATTERSON PLS 3136", HEREAFTER REFERRED TO AS A "SET IPC" AT THE SOUTHEAST CORNER OF THE PROPOSED LEASE AREA WITH A STATE PLANE COORDINATE, KENTUCKY SINGLE ZONE VALUE OF N:3,459,529.721 & E:5,605,801.322, ON THE PROPERTY CONVEYED TO CINDY HONEYCUTT AS RECORDED IN THE OFFICE OF THE CLERK OF HARLAN COUNTY, KENTUCKY AS WILL BOOK 25, PAGE 78, BEING THE SAME PROPERTY CONVEYED TO HAGAN & WILMA HONEYCUTT AS DESCRIBED IN DEED BOOK 150, PAGE 19, PARCEL ID: 034-00-00-016.00; THENCE S84°39'40"W 100.00' TO A SET IPC; THENCE N05°20'20"W 100.00' TO A SET IPC, WITH A STATE PLANE COORDINATE, KENTUCKY SINGLE ZONE VALUE OF N:3,459,619.983 & E:5,605,692.451 IN THE NORTHWEST CORNER OF SAID LEASE AREA; THENCE N84°39'40"E 100.00' TO A SET IPC; THENCE S05°20'20"E 100.00' TO THE POINT OF BEGINNING CONTAINING 10,000.000 SQUARE FEET AS PER SURVEY BY MARK E. PATTERSON, PLS #3136 DATED MARCH 1, 2018.

PROPOSED 30' / VARIABLE WIDTH ACCESS & UTILITY EASEMENT

THE FOLLOWING IS A DESCRIPTION OF THE PROPOSED 30' / VARIABLE WIDTH ACCESS & UTILITY EASEMENT TO BE GRANTED FROM THE PROPERTY CONVEYED TO CINDY HONEYCUTT AS RECORDED IN THE OFFICE OF THE CLERK OF HARLAN COUNTY, KENTUCKY AS WILL BOOK 25, PAGE 78, BEING THE SAME PROPERTY CONVEYED TO HAGAN & WILMA HONEYCUTT AS DESCRIBED IN DEED BOOK 150, PAGE 19, PARCEL ID: 034-00-00-016.00, WHICH IS MORE PARTICULARLY DESCRIBED AS FOLLOWS:

BEARING DATUM USED HEREIN IS BASED UPON KENTUCKY STATE PLANE COORDINATE SYSTEM, SINGLE ZONE, NAD 83, FROM A REAL TIME KINEMATIC GLOBAL POSITIONING SYSTEM OBSERVATION USING THE KENTUCKY TRANSPORTATION CABINET REAL TIME GPS NETWORK COMPLETED ON MARCH 1, 2018.

BEGINNING TO A SET 1/2" REBAR, 18" LONG, CAPPED "PATTERSON PLS 3136", HEREAFTER REFERRED TO AS A "SET IPC" AT THE SOUTHEAST CORNER OF THE PROPOSED LEASE AREA WITH A STATE PLANE COORDINATE, KENTUCKY SINGLE ZONE VALUE OF N:3,459,529.721 & E:5,605,801.322, ON THE PROPERTY CONVEYED TO CINDY HONEYCUTT AS RECORDED IN THE OFFICE OF THE CLERK OF HARLAN COUNTY, KENTUCKY AS WILL BOOK 25, PAGE 78, BEING THE SAME PROPERTY CONVEYED TO HAGAN & WILMA HONEYCUTT AS DESCRIBED IN DEED BOOK 150, PAGE 19, PARCEL ID: 034-00-00-016.00; THENCE LEAVING SAID LEASE AREA, S05°20'20"E 30.00'; THENCE S84°39'40"W 5.80'; THENCE WITH THE CHORD OF A CURVE TO THE LEFT HAVING A RADIUS OF 10.00', S32°10'15"W 15.87'; THENCE S20°19'10"E 243.11'; THENCE WITH THE CHORD OF A CURVE TO THE RIGHT HAVING A RADIUS OF 35.00', S59°27'59"W 68.89'; THENCE N40°44'52"W 224.28'; THENCE WITH THE CHORD OF A CURVE TO THE RIGHT HAVING A RADIUS OF 565.00', N29°16'22"W 224.80'; THENCE N17°47'52"W 51.09'; THENCE N04°27'33"W 47.37'; THENCE N11°37'35"W 60.41'; THENCE WITH THE CHORD OF A CURVE TO THE LEFT HAVING A RADIUS OF 91.00', N30°47'09"W 59.73'; THENCE N49°56'42"W 71.23'; THENCE WITH THE CHORD OF A CURVE TO THE RIGHT HAVING A RADIUS OF 101.00', N27°34'11"W 76.90'; THENCE N05°11'39"W 79.25'; THENCE N26°32'01"W 49.76'; THENCE N10°20'56"W 107.33'; THENCE N00°17'44"E 75.13'; THENCE N09°33'30"W 143.16'; THENCE N11°31'58"E 149.46'; THENCE N22°34'32"W 19.21' TO THE CENTER OF COUNTY ROAD 1248A8 (a.k.a. CAMP CREEK ROAD) HAVING A STATE PLANE COORDINATE, KENTUCKY SINGLE ZONE VALUE OF N:3,460,518.772 & E:5,605,356.941; THENCE WITH THE CENTER OF SAID ROAD, N67°25'28"E 12.00'; THENCE WITH THE CHORD OF A CURVE TO THE LEFT HAVING A RADIUS OF 104.26', N57°54'55"E 42.59' HAVING A STATE PLANE COORDINATE, KENTUCKY SINGLE ZONE VALUE OF N:3,460,546.001 & E:5,605,404.107; THENCE LEAVING SAID CENTER OF ROAD AND TRAVERSING ACROSS THE PROPERTY OF HONEYCUTT, S11°31'58"W 195.89'; THENCE S09°33'30"E 140.16'; THENCE S00°17'44"W 74.92'; THENCE S10°20'56"E 100.27'; THENCE S26°32'01"E 51.14'; THENCE S05°11'39"E 84.91'; THENCE WITH THE CHORD OF A CURVE TO THE LEFT HAVING A RADIUS OF 71.00', S27°34'11"E 54.06'; THENCE S49°56'42"E 71.23'; THENCE WITH THE CHORD OF A CURVE TO THE RIGHT HAVING A RADIUS OF 121.00', S30°47'09"E 79.42'; THENCE S11°37'35"E 62.28'; THENCE S04°27'33"E 45.74'; THENCE S17°47'52"E 47.58'; THENCE WITH THE CHORD OF A CURVE TO THE LEFT HAVING A RADIUS OF 535.00', S29°16'22"E 212.87'; THENCE S40°44'52"E 141.03'; THENCE WITH THE CHORD OF A CURVE TO THE LEFT HAVING A RADIUS OF 20.00', N59°27'59"E 39.37'; THENCE N20°19'10"W 157.89'; THENCE WITH THE CHORD OF A CURVE TO THE LEFT HAVING A RADIUS OF 30.00', N57°49'45"W 36.53'; THENCE S84°39'40"W 27.09'; THENCE N05°20'20"W 30.00' TO A SET IPC IN THE SOUTHWEST CORNER OF SAID LEASE AREA; THENCE WITH SAID LEASE AREA, N84°39'40"E 100.00' TO THE POINT OF BEGINNING CONTAINING 57,692.663 SQUARE FEET AS PER SURVEY BY MARK E. PATTERSON, PLS #3136 DATED MARCH 1, 2018.

PARENT PARCEL, LEGAL DESCRIPTION, WILL BOOK 25, PAGE 78 (DEED BOOK 150, PAGE 19) (NOT FIELD SURVEYED)

BEGINNING AT TWO CHESTNUT OAKS ON THE POINT OF A RIDGE A CORNER TO JOHN R. BLANTON TRACT, OWNED BY KENTENIA CORPORATION, THENCE DOWN WITH THE MEANDERS OF THE RIDGE BETWEEN COAL HOLLOW AND LICK HOLLOW, N 29-30 E 39 FEET N 57-15 E 125.8 FEET, N 51-30 E 323.2 FEET, N 45-30 E 290 FEET TO A SOURWOOD N 34-00 E 311 FEET TO A CHESTNUT OAK AND SERVICE, N 29-00 E 311.2 FEET, N 27-30 E 208.2 FEET TO A SPOTTED OAK N 24-00 W 252.8 FEET, N 8-00 127 FEET N 6-00 E 170.2 FEET, N 28-00 W 127.4 FEET, N 14-50 W 268.8 FEET N 55-30 W 93.2 FEET, N 56-45 W 130.3 FEET, N 9-45 W 129.8 FEET, N 3-30 E 121.2 FEET TO A CHESTNUT, N 12-15 E 198.8 FEET TO TWO CHESTNUT OAKS AND SOURWOOD ON TOP OF THE RIDGE AT JANE BROCKS LINE, THENCE WITH SAID LINE, LEAVING THE RIDGE, N 22-30 W 870 FEET TO A ROCK ON THE BANK OF CAMP CREEK, THENCE LEAVING THE LINES OF SAID BROCK AND WITH THE LINES OF S. R. BAILEY, UP SAID CREEK S 57-30 W 123 FEET, S 20-00 W 108.5 FEET TO A STAKE, BETWEEN SAID CREEK AND THE ROAD, S 87-00 W 221.2 FEET, N 85-30 W 160 FEET TO A STAKE AT THE FOOT OF A SPUR RIDGE, THENCE RUNNING UP THE SAME WITH ITS MEANDERS S 37-00 E 194, S 26-00 W 153.8 FEET TO A WHITE OAK, S 11-15 W 142 FEET, S 6-00 E 96.2 FEET TO A STAKE NEAR A LEANING WHITE OAK, S 8-20 W 295.7 FEET TO A STAKE BY A BEECH, S 7-15 W 85.6 FEET TO A STAKE CORNER OF J.R. BLANTON TRACT, THENCE LEAVE THE LINE OF SAID BAILEY TRACT AND WITH LINE OF BLANTON TRACT S 12-15 W 398 FEET, S 3-00 W 333.5 FEET S 1-15 W 371.5 FEET, S 13-15 E 256 FEET S 42-15 E 112.8 FEET, S 58-15 E 149 FEET TO A STAKE ON A HIGH POINT SOUTH 224.8 FEET, S 29-15 E 114 FEET, S 6-45 E 218.7 FEET, S 21-15 E 78.8 FEET, S 15-00 E 277.5 FEET TO THE BEGINNING, CONTAINING 70.9 ACRES MORE OR LESS.

REPORT OF TITLE (PARCEL 034-00-00-016.00) HARLAN COUNTY

THIS SURVEY DOES NOT CONSTITUTE A TITLE SEARCH BY POD GROUP, LLC. AND AS SUCH WE ARE NOT RESPONSIBLE FOR THE INVESTIGATION OR INDEPENDENT SEARCH FOR EASEMENTS OF RECORD, ENCUMBRANCES, RESTRICTIVE COVENANTS, OWNERSHIP TITLE EVIDENCE, UNRECORDED EASEMENTS, AUGMENTING EASEMENTS, IMPLIED OR PRESCRIPTIVE EASEMENTS, OR ANY OTHER FACTS THAT AN ACCURATE AND CURRENT TITLE SEARCH MAY DISCLOSE AND THIS SURVEY WAS COMPLETED WITH THE AID OF TITLE WORK PREPARED BY US TITLE SOLUTIONS, FOR THE BENEFIT OF MASTEC NETWORK SOLUTIONS, ON BEHALF OF AT&T, FILE NO. 58825-KY1711-5030, REFERENCE NO. FA13800700, ISSUE DATE OF DECEMBER 8, 2017. THE FOLLOWING COMMENTS ARE IN REGARD TO SAID REPORT.

SCHEDULE B

- TAXES, TAX LIENS, TAX SALES, WATER RATES, SEWER AND ASSESSMENTS SET FORTH IN SCHEDULE HEREIN. TAX ID :034-00-00-016.00 - PERIOD :2017 - PAYMENT STATUS: PAID - TAX AMOUNT : \$61.00 (NOT A SURVEY MATTER, THEREFORE POD GROUP, LLC DID NOT EXAMINE OR ADDRESS THIS ITEM.)
- MORTGAGES RETURNED HEREIN (-0-). SEE SEPARATE MORTGAGE SCHEDULE. NONE WITHIN PERIOD SEARCHED
- ANY STATE OF FACTS WHICH AN ACCURATE SURVEY MIGHT SHOW OR SURVEY EXCEPTIONS SET FORTH HEREIN. (POD GROUP, LLC DID NOT PERFORM A BOUNDARY SURVEY, THEREFORE WE DID NOT ADDRESS THIS ITEM.)
- RIGHTS OF TENANTS OR PERSON IN POSSESSION. (NOT A SURVEY MATTER, THEREFORE POD GROUP, LLC DID NOT EXAMINE OR ADDRESS THIS ITEM.)

(JUDGMENTS, LIENS AND UCC)

- NONE WITHIN PERIOD SEARCHED

(COVENANTS/RESTRICTIONS)

- NONE WITHIN PERIOD SEARCHED

(EASEMENTS AND RIGHTS OF WAY)

- NONE WITHIN PERIOD SEARCHED

(OTHER FILED DOCUMENTS)

- LEASE AGREEMENT BETWEEN HAGAN AND WILMA HONEYCUTT AND LINDA DAY DATED 6/5/1984 RECORDED 6/12/1984 IN BOOK 29 PAGE 369. (LEASE AS RECORDED IN BOOK 29, PAGE 369 IS FOR ALL OF THE COAL AND MINING RIGHTS, LEASE AFFECTS THE PARENT PARCEL, THE PROPOSED LEASE AREA AND THE PROPOSED ACCESS & UTILITY EASEMENT.)
- LEASE AGREEMENT BETWEEN HAGAN AND WILMA HONEYCUTT AND LINDA DAY DATED 6/5/1984 RECORDED 6/15/1984 IN BOOK 29 PAGE 385. (LEASE AS RECORDED IN BOOK 29, PAGE 385 IS FOR ALL OF THE COAL AND MINING RIGHTS, LEASE AFFECTS THE PARENT PARCEL, THE PROPOSED LEASE AREA AND THE PROPOSED ACCESS & UTILITY EASEMENT.)
- PROBATE ORDER BETWEEN THE ESTATE OF WILMA HONEYCUTT, DECEASED AND HAGAN H. HONEYCUTT DATED 7/23/1993 RECORDED 7/26/1993 IN BOOK 21 PAGE 100. (ORDER AS RECORDED IN BOOK 21, PAGE 100 AFFECTS THE PARENT PARCEL, LEAVING SAID REAL ESTATE TO HAGAN H. HONEYCUTT.)
- PROBATE ORDER BETWEEN LAST WILL AND TESTAMENT OF HAGAN HONEYCUTT, DECEASED AND CINDY HONEYCUTT DATED 3/20/1998 RECORDED 3/23/1998 IN BOOK 25 PAGE 78. (ORDER AS RECORDED IN BOOK 25, PAGE 78 AFFECTS THE PARENT PARCEL, LEAVING SAID REAL ESTATE TO CINDY HONEYCUTT.)

LAND SURVEYOR'S CERTIFICATE

I, MARK E. PATTERSON, HEREBY CERTIFY THAT I AM A LICENSED PROFESSIONAL LAND SURVEYOR LICENSED IN COMPLIANCE WITH THE LAWS OF THE COMMONWEALTH OF KENTUCKY. I FURTHER CERTIFY THAT THIS PLAT AND THE SURVEY ON THE GROUND WERE PERFORMED BY PERSONS UNDER MY DIRECT SUPERVISION, AND THAT THE DIRECTIONAL AND LINEAR MEASUREMENTS BEING WITNESSED BY MONUMENTS SHOWN HEREON ARE TRUE AND CORRECT TO THE BEST OF MY KNOWLEDGE. THE "RURAL" SURVEY, AND THE PLAT ON WHICH IT IS BASED, MEETS ALL SPECIFICATIONS AS STATED IN KAR 201 18:150.

Mark Patterson 10/5/2018
MARK PATTERSON, PLS #3136 DATE



PREPARED BY:
POD
POWER OF DESIGN
11490 BLUEGRASS PARKWAY
LOUISVILLE, KY 40299
502.437.5252

PREPARED FOR:
MasTec

PREPARED FOR:
 at&t

SITE SURVEY

REV.	DATE	DESCRIPTION
A	4.11.18	PRELIM ISSUE WITH TITLE
B	5.2.18	REVISED ACCESS & UTILITY EASEMENT
C	5.4.18	CLIENT COMMENTS
D	5.14.18	ISSUED AS FINAL

SITE INFORMATION:
WALLINS CREEK
COUNTY ROAD 1248A8
a.k.a. CAMP CREEK ROAD
WALLINS CREEK, KY 40873
HARLAN COUNTY

TAX PARCEL NUMBER:
034-00-00-016.00
TAX PARCEL ADDRESS:
O HENSLEY HOLLOW - WALLINS O
WALLINS CREEK, KY 40873

PROPERTY OWNER:
CINDY HONEYCUTT
P. O. BOX 356
WHITESBURG, KY 41858

SOURCE OF TITLE:
WILL BOOK 25, PAGE 78
(DEED BOOK 150, PAGE 19)


SITE NUMBER:

POD NUMBER: 18-21589
DRAWN BY: DAP
CHECKED BY: MEP
SURVEY DATE: 3.1.18
PLAT DATE: 4.2.18

SHEET TITLE:
SITE SURVEY
THIS DOES NOT REPRESENT A
BOUNDARY SURVEY OF THE
PARENT PARCEL

SHEET NUMBER: (5 pages)

B-1.4

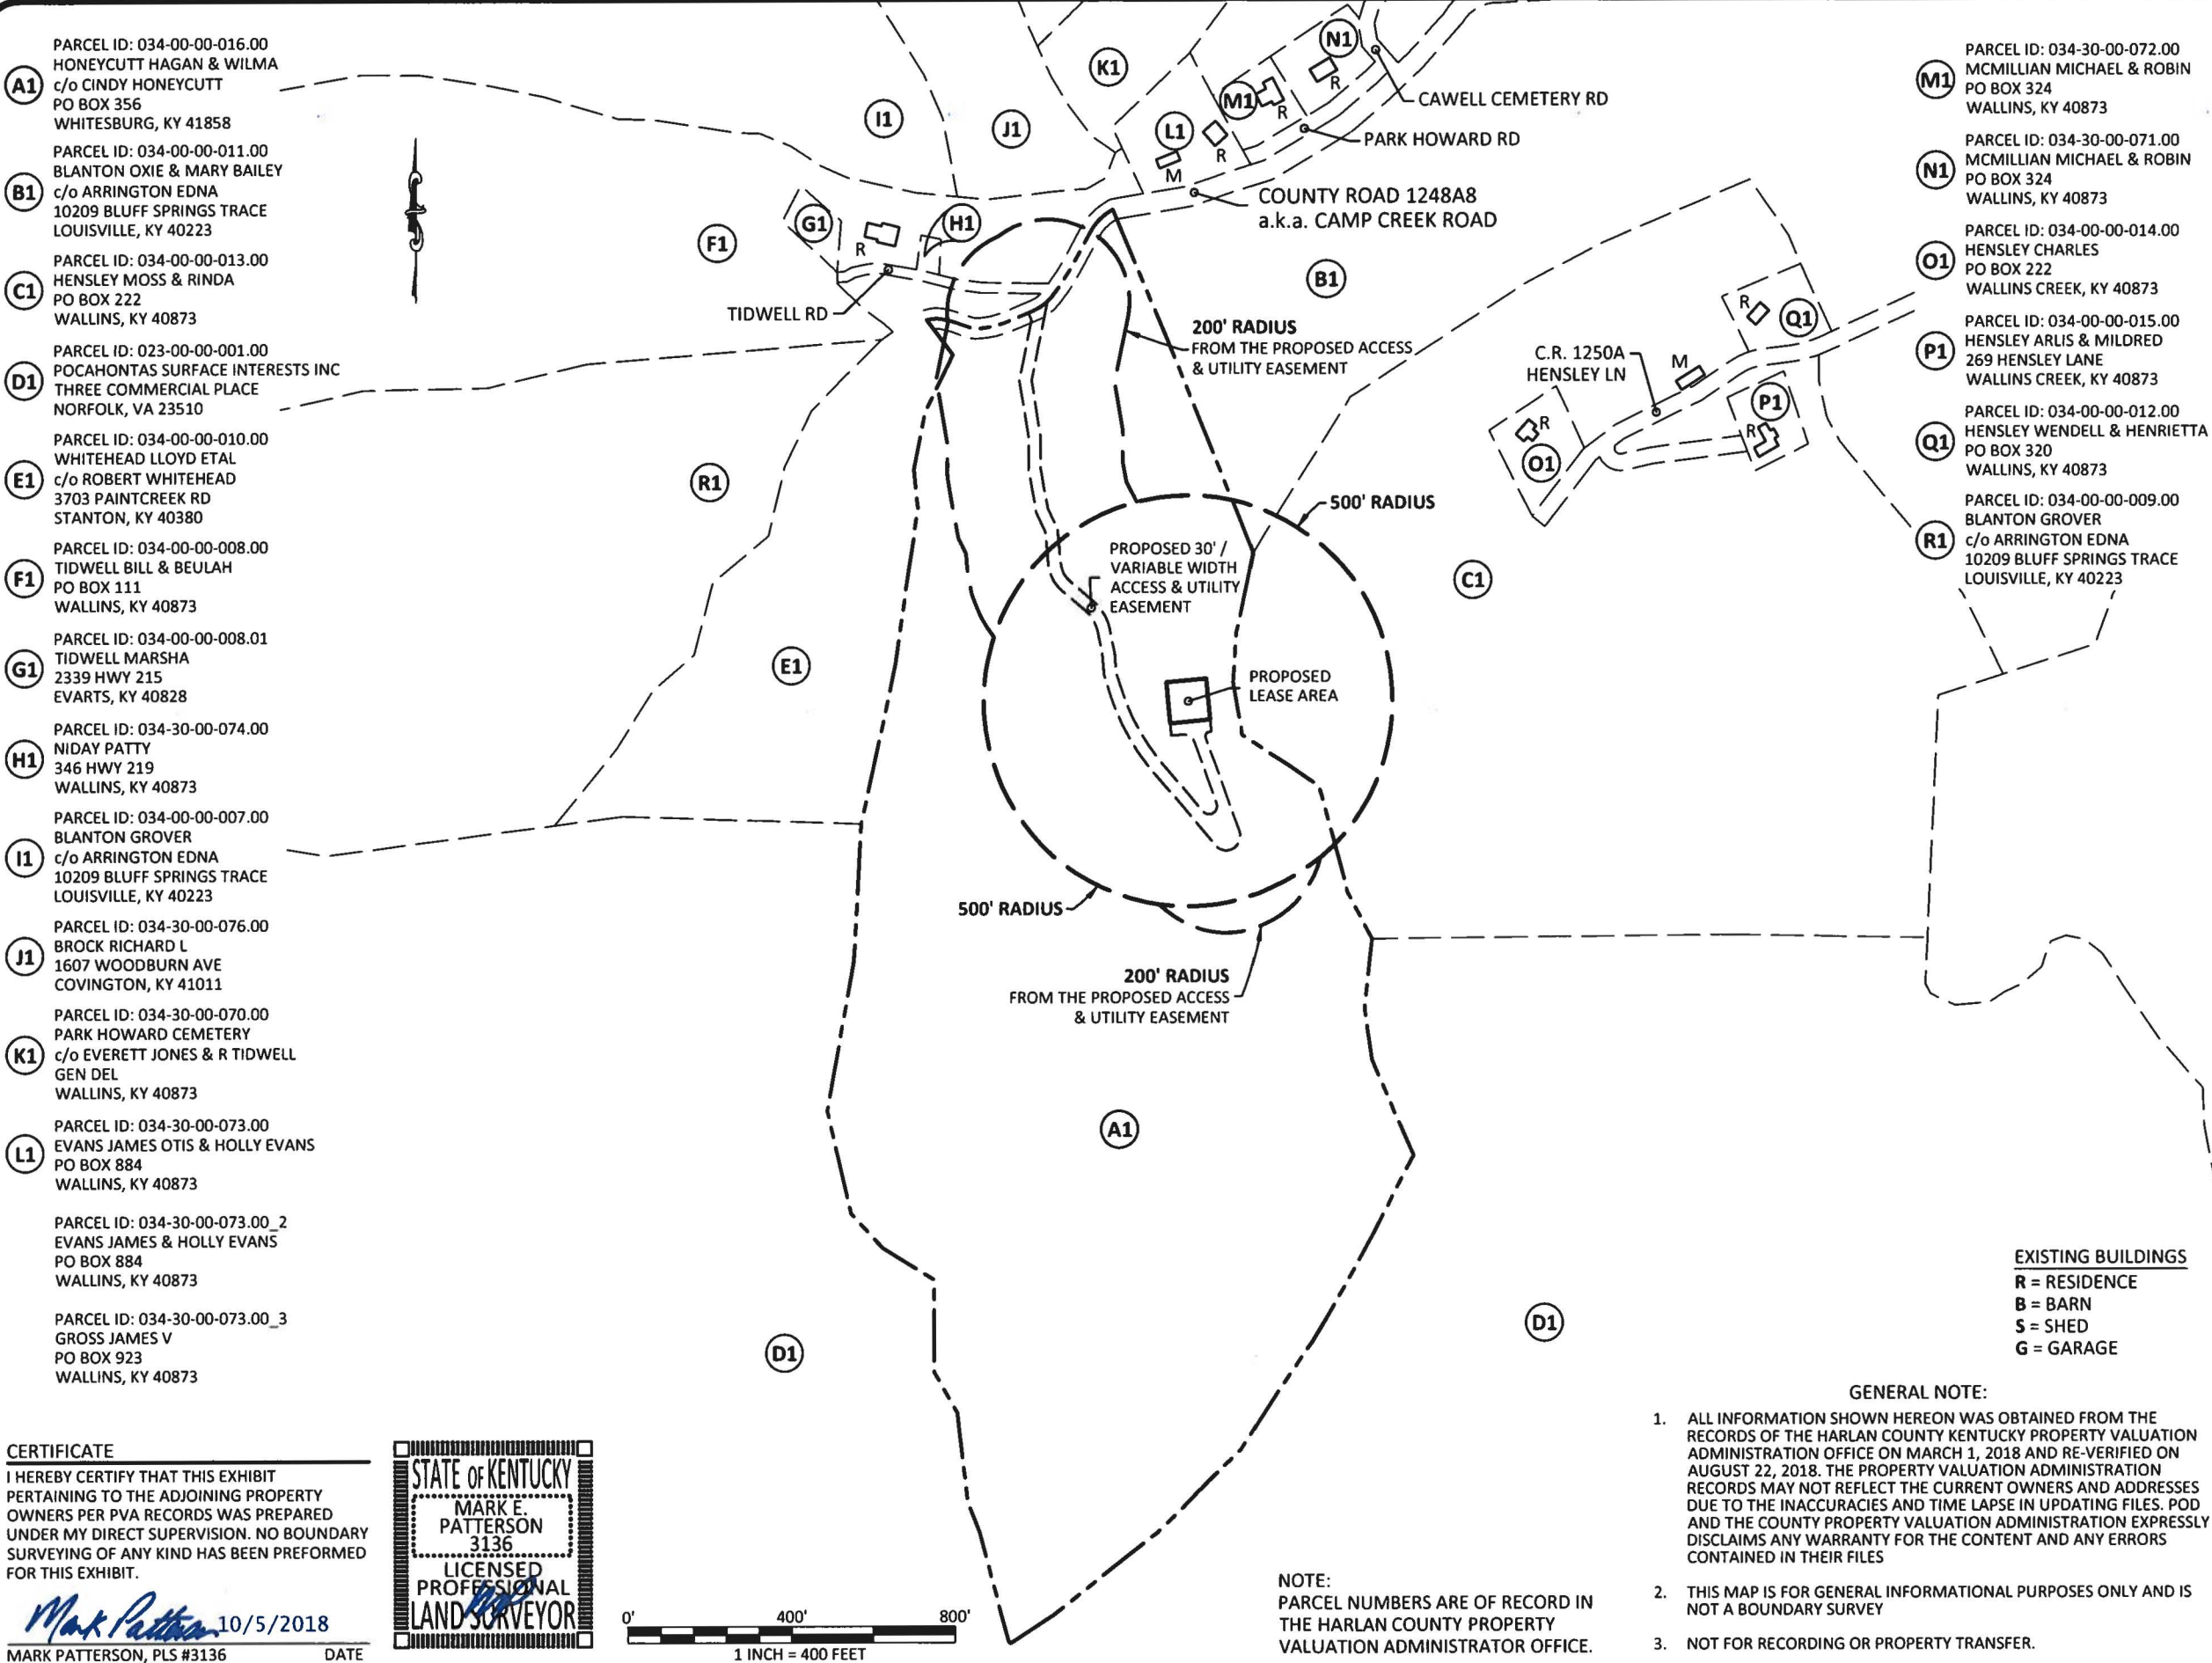

PREPARED BY:

POD
POWER OF DESIGN
11490 BLUEGRASS PARKWAY
LOUISVILLE, KY 40299
502-437-5252

PREPARED FOR:

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PREPARED FOR:

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EXHIBIT		
REV.	DATE	DESCRIPTION
A	8.22.18	ISSUED FOR REVIEW
D	10.5.18	ISSUED AS FINAL

SITE INFORMATION:

WALLINS CREEK
COUNTY ROAD 1248A8
a.k.a. CAMP CREEK ROAD
WALLINS CREEK, KY 40873
HARLAN COUNTY

TAX PARCEL NUMBER:
034-00-00-016.00

TAX PARCEL ADDRESS:
0 HENSLEY HOLLOW - WALLINS O
WALLINS CREEK, KY 40873

PROPERTY OWNER:
CINDY HONEYCUTT
P. O. BOX 356
WHITESBURG, KY 41858

SOURCE OF TITLE:
WILL BOOK 25, PAGE 78
(DEED BOOK 150, PAGE 19)

SITE NUMBER:

POD NUMBER: 18-27369

DRAWN BY: DAP
CHECKED BY: MEP
SURVEY DATE: 3.1.18
PLAT DATE: 8.22.18

SHEET TITLE:

**500' RADIUS AND
ABUTTERS MAP**

SHEET NUMBER: (1 pages)

B-2



TIDWELL ROAD
PUBLIC RIGHT OF WAY WIDTH UNKNOWN

COUNTY ROAD 1248A8
PUBLIC RIGHT OF WAY WIDTH UNKNOWN

PROPOSED 16' ACCESS GATE

PROPOSED 30' ACCESS & UTILITY EASEMENT

PROPOSED 12' GRAVEL ACCESS DRIVE

1005'
TOWER TO PROPERTY LINE 'A'

1021'
TOWER TO RESIDENCE

708'
TOWER TO PROPERTY LINE 'D'

105'
TOWER TO PROPERTY LINE 'B'

PROPOSED 100' x 100' LEASE AREA

EXISTING DIRT PATHWAY

PROPOSED 255' SELF-SUPPORT TOWER W/ 15' LIGHTNING ARRESTOR

APPROXIMATE LOCATION OF EXISTING CAVE (ALL ROAD RUNOFF WATER MUST BE DIVERTED AWAY FROM CAVE BOTH DURING AND AFTER CONSTRUCTION)

1219'
TOWER TO PROPERTY LINE 'C'

EXISTING RESIDENCE



Know what's below.
Call before you dig.
Call Monday thru Friday - 7 am. to 6 pm.
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PER KENTUCKY STATE LAW, IT IS AGAINST THE LAW TO EXCAVATE WITHOUT NOTIFYING THE UNDERGROUND LOCATION SERVICE TWO (2) WORKING DAYS BEFORE COMMENCING WORK.



LEGEND

- UTILITY POLE
- EXISTING BOUNDARY
- PROPOSED ACCESS & UTILITY EASEMENT
- PROPOSED FENCE LINE
- EXISTING PROPERTY LINES
- OHE&T
- EXISTING OVERHEAD ELECTRIC & TELEPHONE

PREPARED BY:

POD
POWER OF DESIGN
11490 BLUEGRASS PARKWAY
LOUISVILLE, KY 40299
502-437-5252

PREPARED FOR:

MasTec

PREPARED FOR:

at&t

STATE OF KENTUCKY
MARK E. PATTERSON
16,300
PROFESSIONAL ENGINEER

10/5/2018
EN PERMIT: 3594

ZONING DRAWINGS

REV	DATE	DESCRIPTION
A	9.21.18	ISSUED FOR REVIEW
0	10.4.18	ISSUED AS FINAL

SITE INFORMATION:
WALLINS CREEK
COUNTY ROAD 1248A8
A.K.A. CAMP CREEK ROAD
WALLINS CREEK, KY 40873
HARLAN COUNTY
SITE NUMBER:
-

POD NUMBER: 18-21592
DRAWN BY: KDP
CHECKED BY: MEP
DATE: 9.21.18

SHEET TITLE:



OVERALL SITE LAYOUT

SHEET NUMBER:
C-1




TIDWELL ROAD
PUBLIC RIGHT OF WAY WIDTH UNKNOWN

COUNTY ROAD 1248A8
PUBLIC RIGHT OF WAY WIDTH UNKNOWN

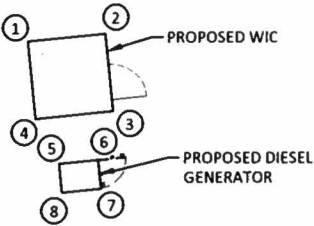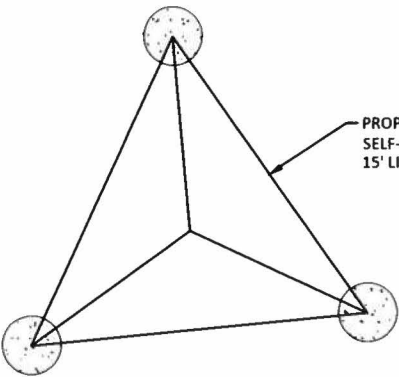

PROPERTY LINE	EQUIPMENT	DISTANCE
A	1	1034'
B	2	128'
C	3	1216'
D	1	709'
A	5	1045'
B	6	131'
C	7	1211'
D	5	714'

EQUIPMENT ENLARGEMENT
NOT TO SCALE

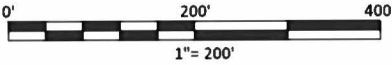

PROPOSED 16' ACCESS GATE

PROPOSED 30' ACCESS & UTILITY EASEMENT

PROPOSED 12' GRAVEL ACCESS DRIVE

EXISTING DIRT PATHWAY

PROPOSED 255' SELF-SUPPORT TOWER W/ 15' LIGHTNING ARRESTOR

APPROXIMATE LOCATION OF EXISTING CAVE (ALL ROAD RUNOFF WATER MUST BE DIVERTED AWAY FROM CAVE BOTH DURING AND AFTER CONSTRUCTION)

PROPOSED 100' x 100' LEASE AREA

EXISTING RESIDENCE

LEGEND

- UTILITY POLE
- EXISTING BOUNDARY
- PROPOSED ACCESS & UTILITY EASEMENT
- PROPOSED FENCE LINE
- EXISTING PROPERTY LINES
- OHE&T
- EXISTING OVERHEAD ELECTRIC & TELEPHONE

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502-437-5252

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MasTec

PREPARED FOR:

at&t

STATE OF KENTUCKY

MARK E. PATTERSON
16380
PROFESSIONAL ENGINEER

10/5/2018

EN PERMIT: 3594

ZONING
DRAWINGS

REV	DATE	DESCRIPTION
A	9.21.18	ISSUED FOR REVIEW
D	10.4.18	ISSUED AS FINAL

SITE INFORMATION:
WALLINS CREEK

COUNTY ROAD 1248A8
A.K.A. CAMP CREEK ROAD
WALLINS CREEK, KY 40873

HARLAN COUNTY

SITE NUMBER:

POD NUMBER: 18-21592

DRAWN BY: KDP
CHECKED BY: MEP
DATE: 9.21.18

SHEET TITLE:


OVERALL
SITE LAYOUT
-CONT'D

SHEET NUMBER:

C-2



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TO EXCAVATE WITHOUT NOTIFYING THE
UNDERGROUND LOCATION SERVICE TWO (2)
WORKING DAYS BEFORE COMMENCING WORK.

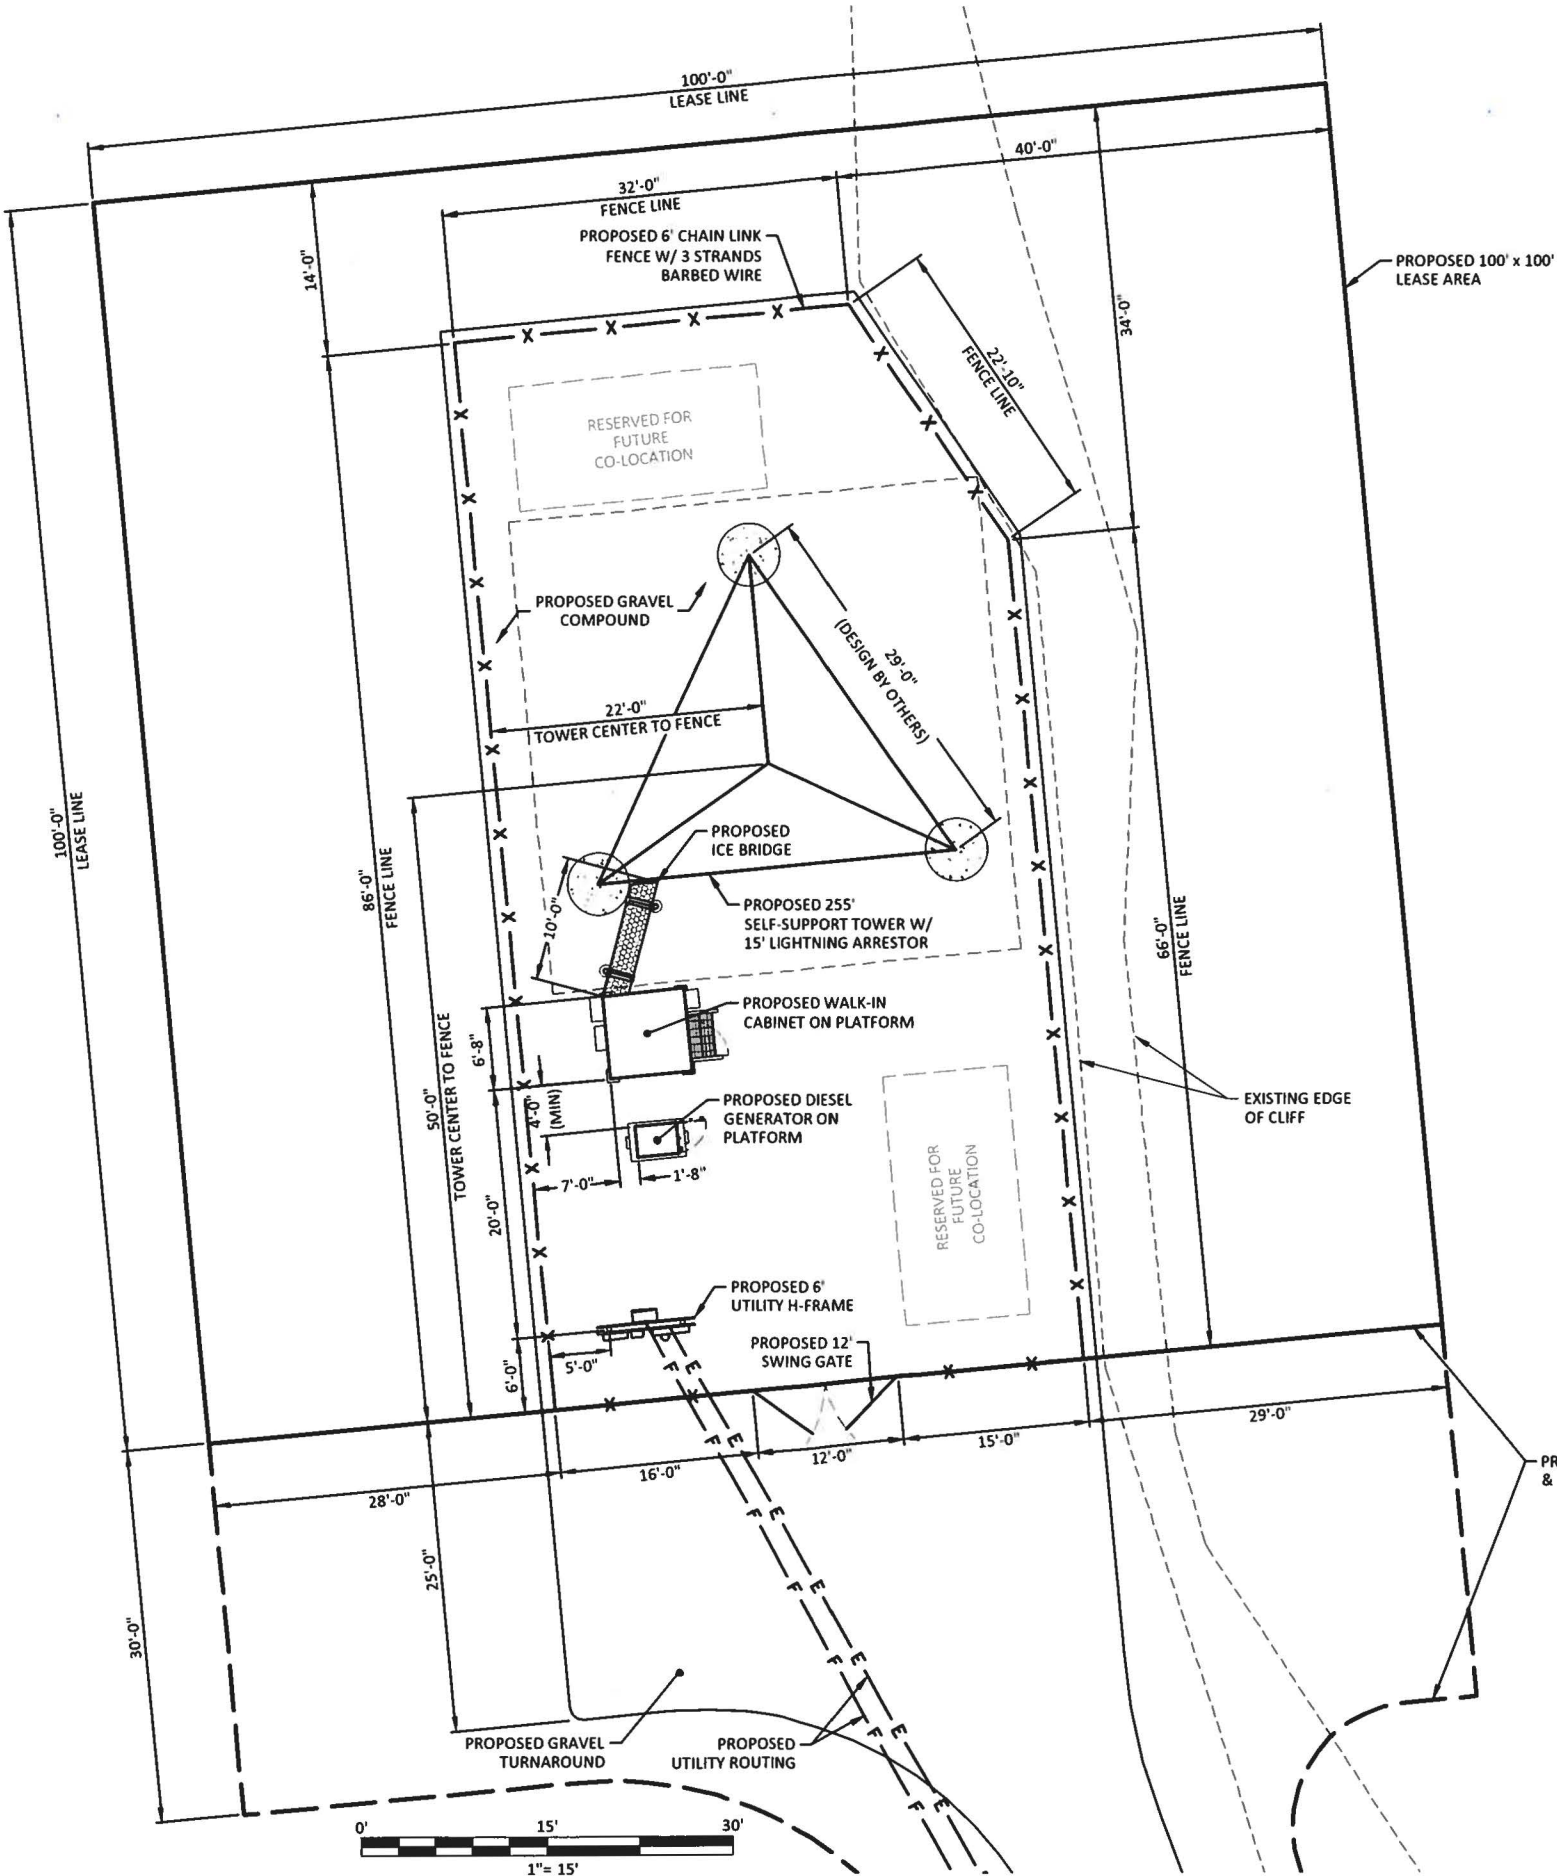

LEGEND

---	PROPOSED ACCESS & UTILITY EASEMENT
-X-X-	PROPOSED FENCE LINE
-E-E-	PROPOSED ELECTRIC CONDUIT
-F-F-	PROPOSED FIBER CONDUIT
---	EXISTING EDGE OF CLIFF




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PREPARED BY:
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LOUISVILLE, KY 40299
502-437-5252

PREPARED FOR:
MasTec

PREPARED FOR:
 at&t

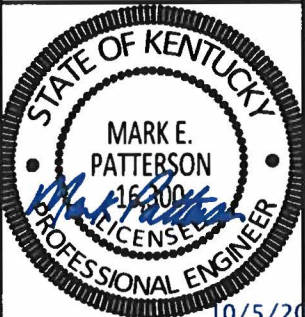

EN PERMIT: 3594

**ZONING
DRAWINGS**

REV	DATE	DESCRIPTION
A	9.21.18	ISSUED FOR REVIEW
0	10.4.18	ISSUED AS FINAL

SITE INFORMATION:
WALLINS CREEK
COUNTY ROAD 1248A8
A.K.A. CAMP CREEK ROAD
WALLINS CREEK, KY 40873

HARLAN COUNTY

SITE NUMBER:
-

POD NUMBER: 18-21592


DRAWN BY: KDP
CHECKED BY: MEP
DATE: 9.21.18

SHEET TITLE:
**ENLARGED
COMPOUND
LAYOUT**

SHEET NUMBER:
C-3

TOWER NOTES:

- 1. THE PROPOSED TOWER, FOUNDATION, ANTENNA MOUNTS, AND ANTENNAS WERE DESIGNED BY OTHERS.
- 2. THE TOWER ELEVATION SHOWN IS FOR REFERENCE ONLY.
- 3. SEE TOWER MANUFACTURER'S DRAWINGS FOR TOWER AND FOUNDATION DETAILS & SPECIFICATIONS.
- 4. MANUFACTURER'S DRAWINGS SUPERCEDE A&E DRAWINGS.

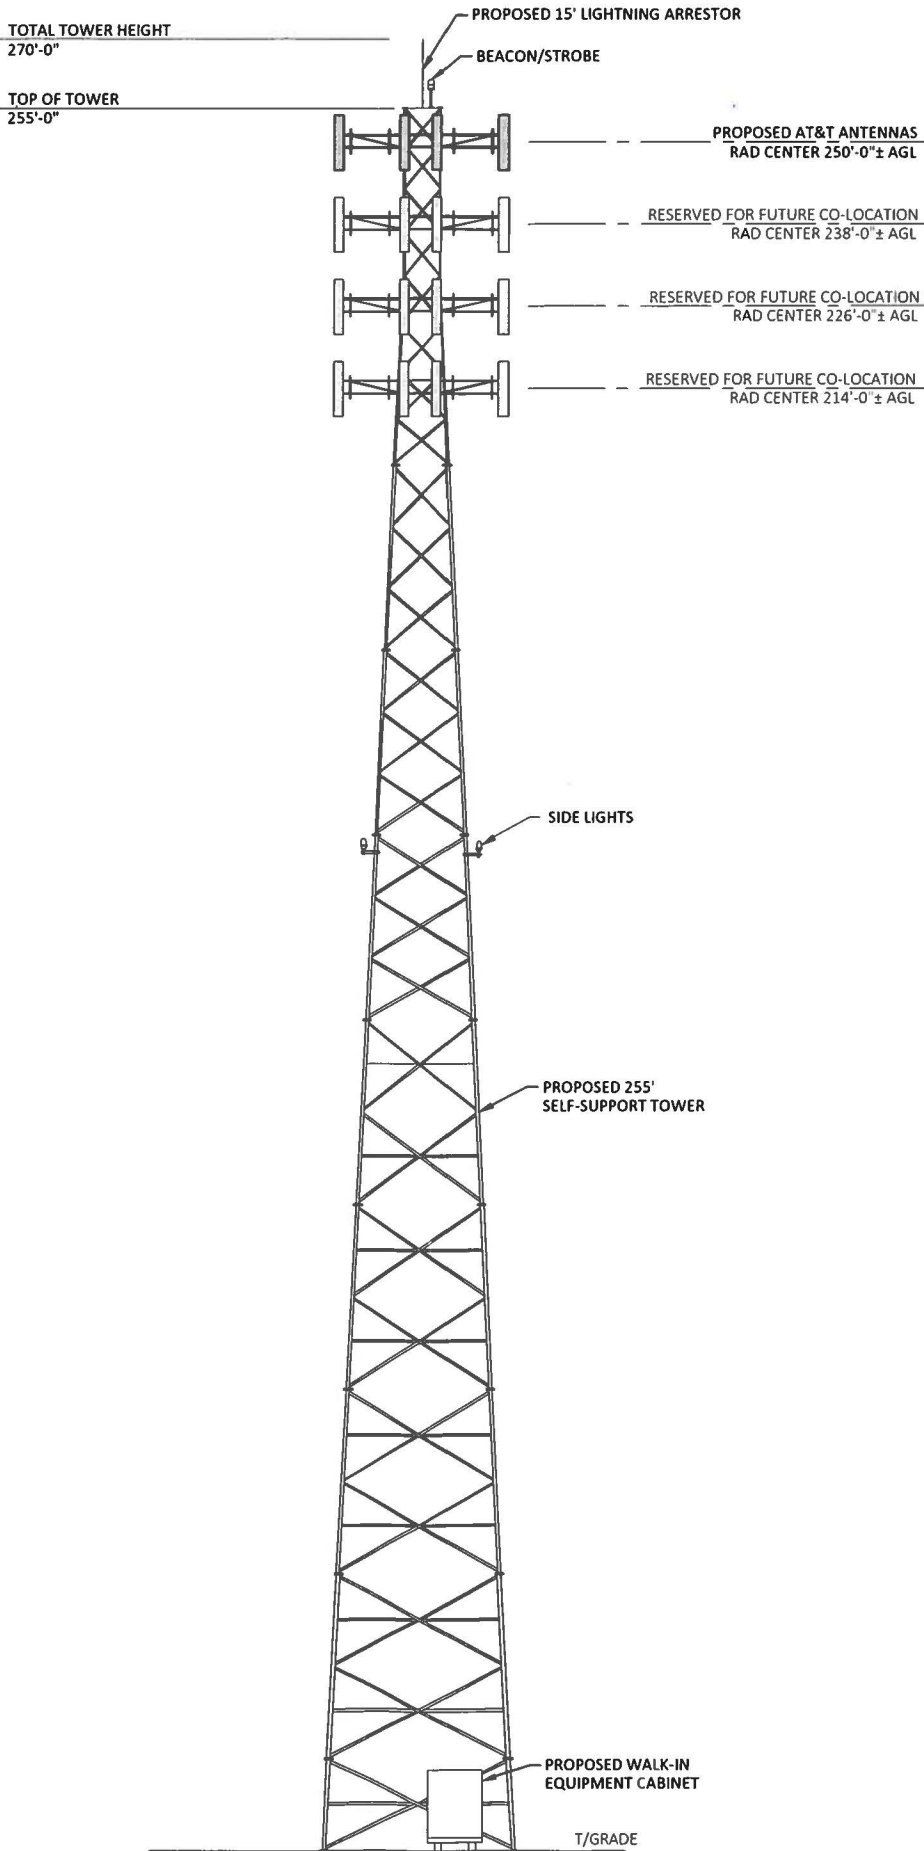

PREPARED BY:

POD
POWER OF DESIGN

11490 BLUEGRASS PARKWAY
LOUISVILLE, KY 40299
502-437-5252

PREPARED FOR:

MasTec

PREPARED FOR:

at&t

STATE OF KENTUCKY

MARK E. PATTERSON
16,300
PROFESSIONAL ENGINEER

10/5/2018

EN PERMIT: 3594

ZONING
DRAWINGS

REV	DATE	DESCRIPTION
A	9.21.18	ISSUED FOR REVIEW
0	10.4.18	ISSUED AS FINAL

SITE INFORMATION:

WALLINS CREEK

COUNTY ROAD 1248A8
A.K.A. CAMP CREEK ROAD
WALLINS CREEK, KY 40873

HARLAN COUNTY

SITE NUMBER:
-

POD NUMBER: 18-21592

DRAWN BY: KDP
CHECKED BY: MEP
DATE: 9.21.18

SHEET TITLE:

**TOWER
ELEVATION**

SHEET NUMBER:

C-4

EXHIBIT C
TOWER AND FOUNDATION DESIGN




Structural Design Report
255' S3TL Series HD1 Self-Supporting Tower
Site: Wallins Creek, KY

Prepared for: AT&T
by: Sabre Towers & Poles TM


Job Number: 418882

October 1, 2018

Tower Profile.....	1-2
Foundation Design Summary (Preliminary).....	3
Maximum Leg Loads.....	4
Maximum Diagonal Loads.....	5
Maximum Foundation Loads.....	6
Calculations.....	7-20

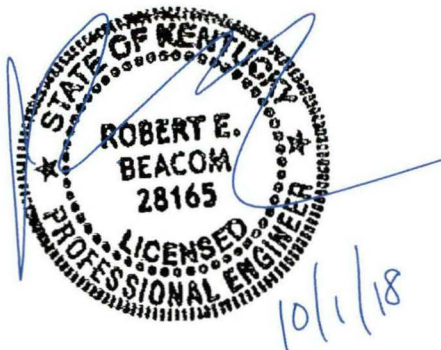

Legs	12.75 OD X .375	A	8.625 OD X .500	J	I	NONE	B	C	D	E	F	G
Diagonals	L 4 X 4 X 5/16	L 4 X 4 X 1/4					L 3 X 3 X 3/16	L 2 X 2 X 3/16	L			M
Horizontals												
Internals												
Sub-Diagonals												
Sub-Horizontals												
Brace Bolts	(2) 3/4"	(2) 5/8"	(1) 3/4"	17'	19'	21'	13'	11'	9'	7'	5'	
Top Face Width	27"	25'	23'	21'	12 @ 10'	15'	3017	2421	1900	1375	565	
Panel Count/Height	R	S										
Section Weight	7231	6556	5877	6207	5173	4518	4305	3211				

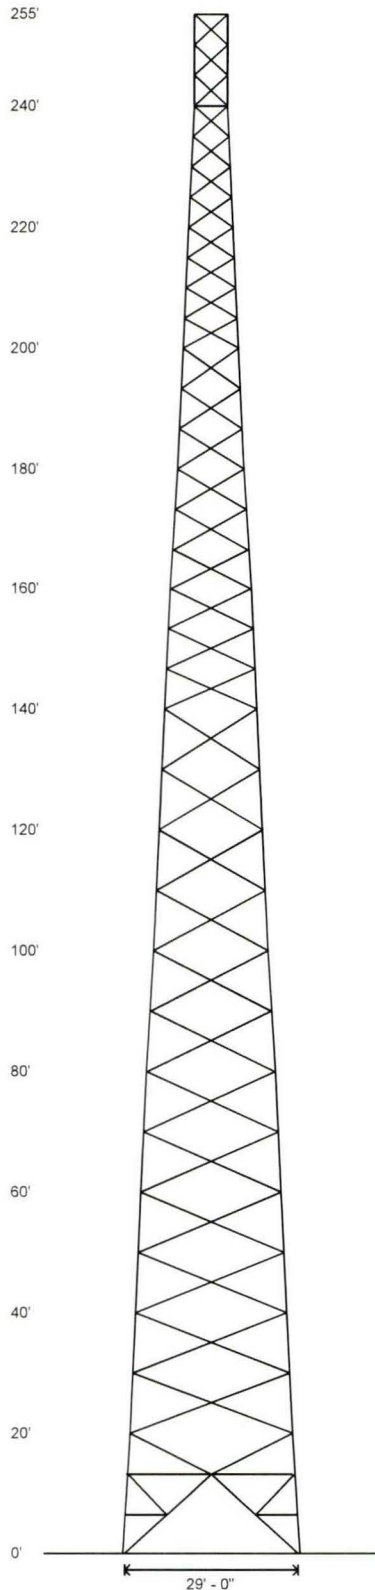

Base Reactions

Total Foundation		Individual Footing	
Shear (kips)	96.58	Shear (kips)	58.82
Axial (kips)	200.4	Compression (kips)	639
Moment (ft-kips)	15218	Uplift (kips)	561
Torsion (ft-kips)	39.55		

Material List

Display	Value
A	10.75 OD X .500
B	8.625 OD X .322
C	5.563 OD X .500
D	5.563 OD X .375
E	4.500 OD X .337
F	3.500 OD X .300
G	2.375 OD X .154
H	L 5 X 3 1/2 X 5/16 (SLV)
I	L 3 1/2 X 3 1/2 X 1/4
J	L 3 1/2 X 3 X 1/4 (SLV)
K	L 2 1/2 X 2 1/2 X 1/4
L	L 2 1/2 X 2 1/2 X 3/16
M	L 2 X 2 X 1/8
N	L 4 X 4 X 1/4
O	L 2 X 2 X 3/16
P	L 3 X 3 X 1/4
Q	L 3 X 3 X 3/16
R	1 @ 13.333'
S	1 @ 6.667'

Notes

- 1) All legs are A500 (50 ksi Min. Yield).
- 2) All braces are A572 Grade 50.
- 3) All brace bolts are A325-X.
- 4) The tower model is S3TL Series HD1.
- 5) Transmission lines are to be attached to standard 12 hole waveguide ladders with stackable hangers.
- 6) Azimuths are relative (not based on true north).
- 7) Foundation loads shown are maximums.
- 8) All unequal angles are oriented with the short leg vertical.
- 9) Weights shown are estimates. Final weights may vary.
- 10) This tower was designed for a basic wind speed of 89 mph with 0" of radial ice, and 30 mph with 1/2" of radial ice, in accordance with ANSI/TIA-222-G, Structure Class II, Exposure Category C, Topographic Category 1.
- 11) The foundation loads shown are factored loads.
- 12) The tower design meets the requirements for an Ultimate Wind Speed of 115 mph (Risk Category II), in accordance with the 2012 International Building Code.
- 13) Tower Rating: 98.79%

Sabre Industries
Towers and Poles

Sabre Communications Corporation
7101 Southbridge Drive
P.O. Box 658
Sioux City, IA 51102-0658
Phone: (712) 258-6690
Fax: (712) 279-0814

Information contained herein is the sole property of Sabre Communications Corporation, constitutes a trade secret as defined by Iowa Code Ch. 550 and shall not be reproduced, copied or used in whole or part for any purpose whatsoever without the prior written consent of Sabre Communications Corporation.

Job: **418882**

Customer: **AT&T**

Site Name: **Wallins Creek, KY**


Description: **255' S3TL**

Date: **10/1/2018** By: **REB**

Designed Appurtenance Loading

Elev	Description	Tx-Line
260	(1) Extendible Lightning Rod	
250	(1) 278 sq. ft. EPA 6000# (no Ice)	(18) 1 5/8"
238	(1) 208 sq. ft. EPA 4000# (no ice)	(18) 1 5/8"


Elev	Description	Tx-Line
226	(1) 208 sq. ft. EPA 4000# (no ice)	(18) 1 5/8"
214	(1) 208 sq. ft. EPA 4000# (no ice)	(18) 1 5/8"

 Sabre Industries Towers and Poles	Sabre Communications Corporation 7101 Southbridge Drive P.O. Box 658 Sioux City, IA 51102-0658 Phone: (712) 258-6690 Fax: (712) 279-0814		Job: 418882
			Customer: AT&T
			Site Name: Wallins Creek, KY
			Description: 255' S3TL
			Date: 10/1/2018 By: REB
<small>Information contained herein is the sole property of Sabre Communications Corporation, constitutes a trade secret as defined by Iowa Code Ch. 550 and shall not be reproduced, copied or used in whole or part for any purpose whatsoever without the prior written consent of Sabre Communications Corporation.</small>			

Customer: AT&T
Site: Wallins Creek, KY

255 ft. Model S3TL Series HD1 Self Supporting Tower At
89 mph Wind with no ice and 30 mph Wind with 0.5 in. Ice per ANSI/TIA-222-G.

PRELIMINARY -NOT FOR CONSTRUCTION-

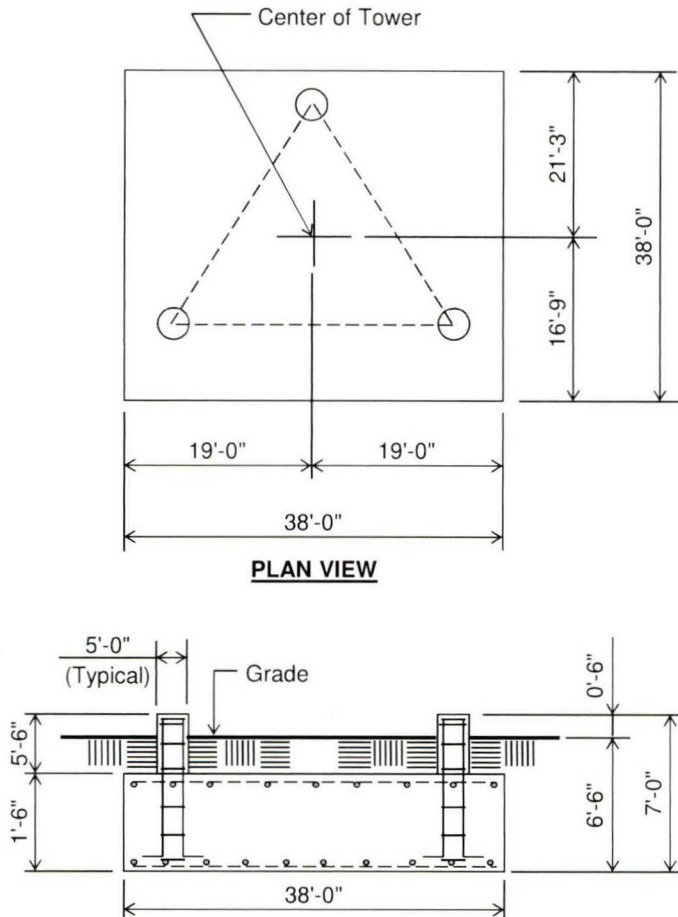

(92.2 cu. yds.)
(1 REQUIRED.; NOT TO SCALE)


CAUTION: Center of
tower is not in center
of slab.

Notes:


- 1) Concrete shall have a minimum 28-day compressive strength of 4,500 psi, in accordance with ACI 318-11.
- 2) Rebar to conform to ASTM specification A615 Grade 60.
- 3) All rebar to have a minimum of 3" concrete cover.
- 4) All exposed concrete corners to be chamfered 3/4".
- 5) The foundation design is based on presumptive clay soil as defined in ANSI/TIA-222-G-2005. It is recommended that a soil analysis of the site be performed to verify the soil parameters used in the design.
- 6) The foundation is based on the following factored loads:
Factored download (kips) = 100.23
Factored overturn (kip-ft) = 15,218.17
Factored shear (kips) = 96.58
- 7) 5' of soil cover is required over the entire area of the foundation slab.
- 8) The bottom anchor bolt template shall be positioned as closely as possible to the bottom of the anchor bolts.

Rebar Schedule per Mat and per Pier	
Pier	(34) #6 vertical rebar w/ hooks at bottom w/ #4 rebar ties, two (2) within top 5" of pier then 12" C/C
Mat	(66) #11 horizontal rebar evenly spaced each way top and bottom. (264 total)
Anchor Bolts per Leg	
(6) 1.75" dia. x 87" F1554-105 on a 18" B.C. w/ 10.5" max. projection above concrete.	

Maximum

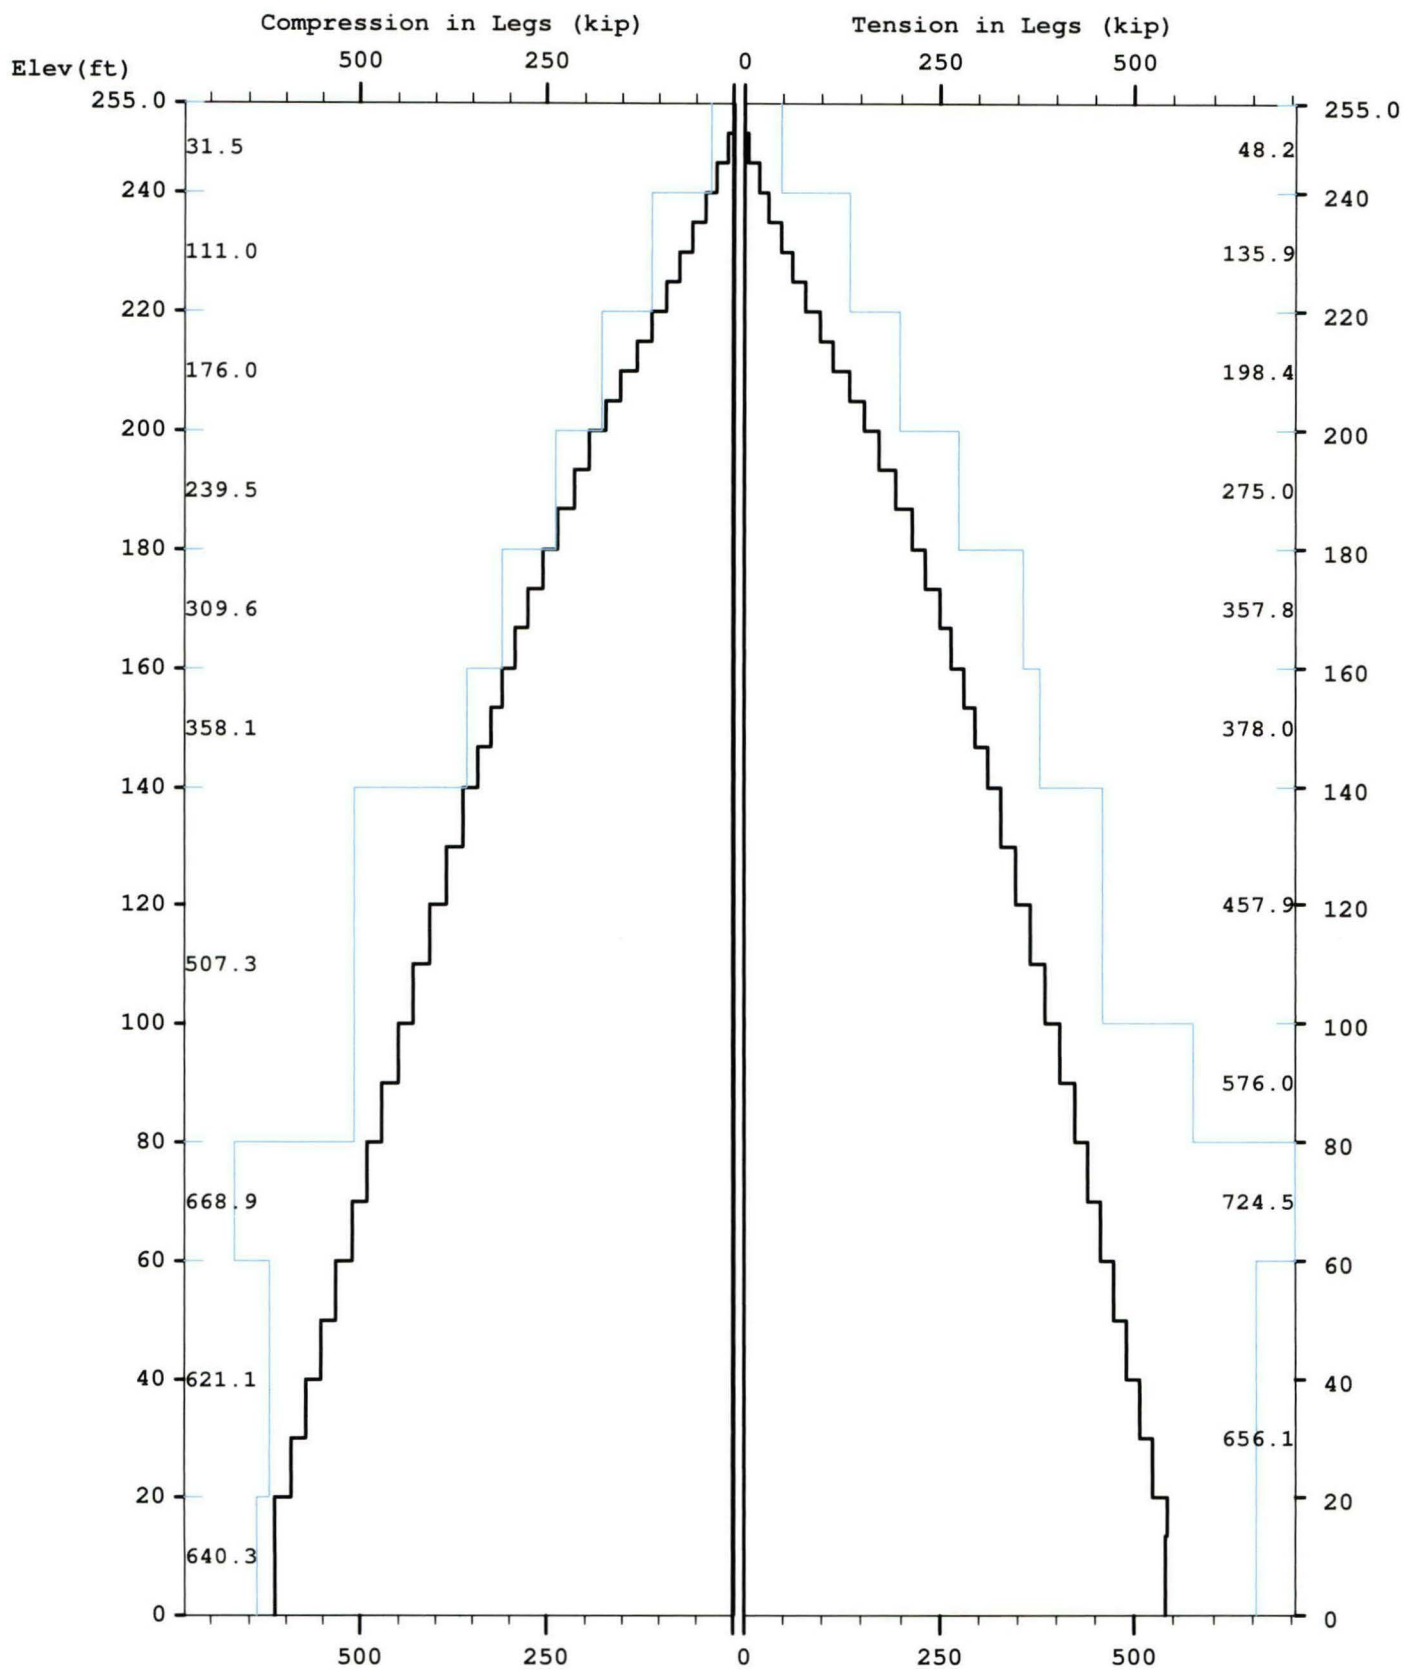


Maximum


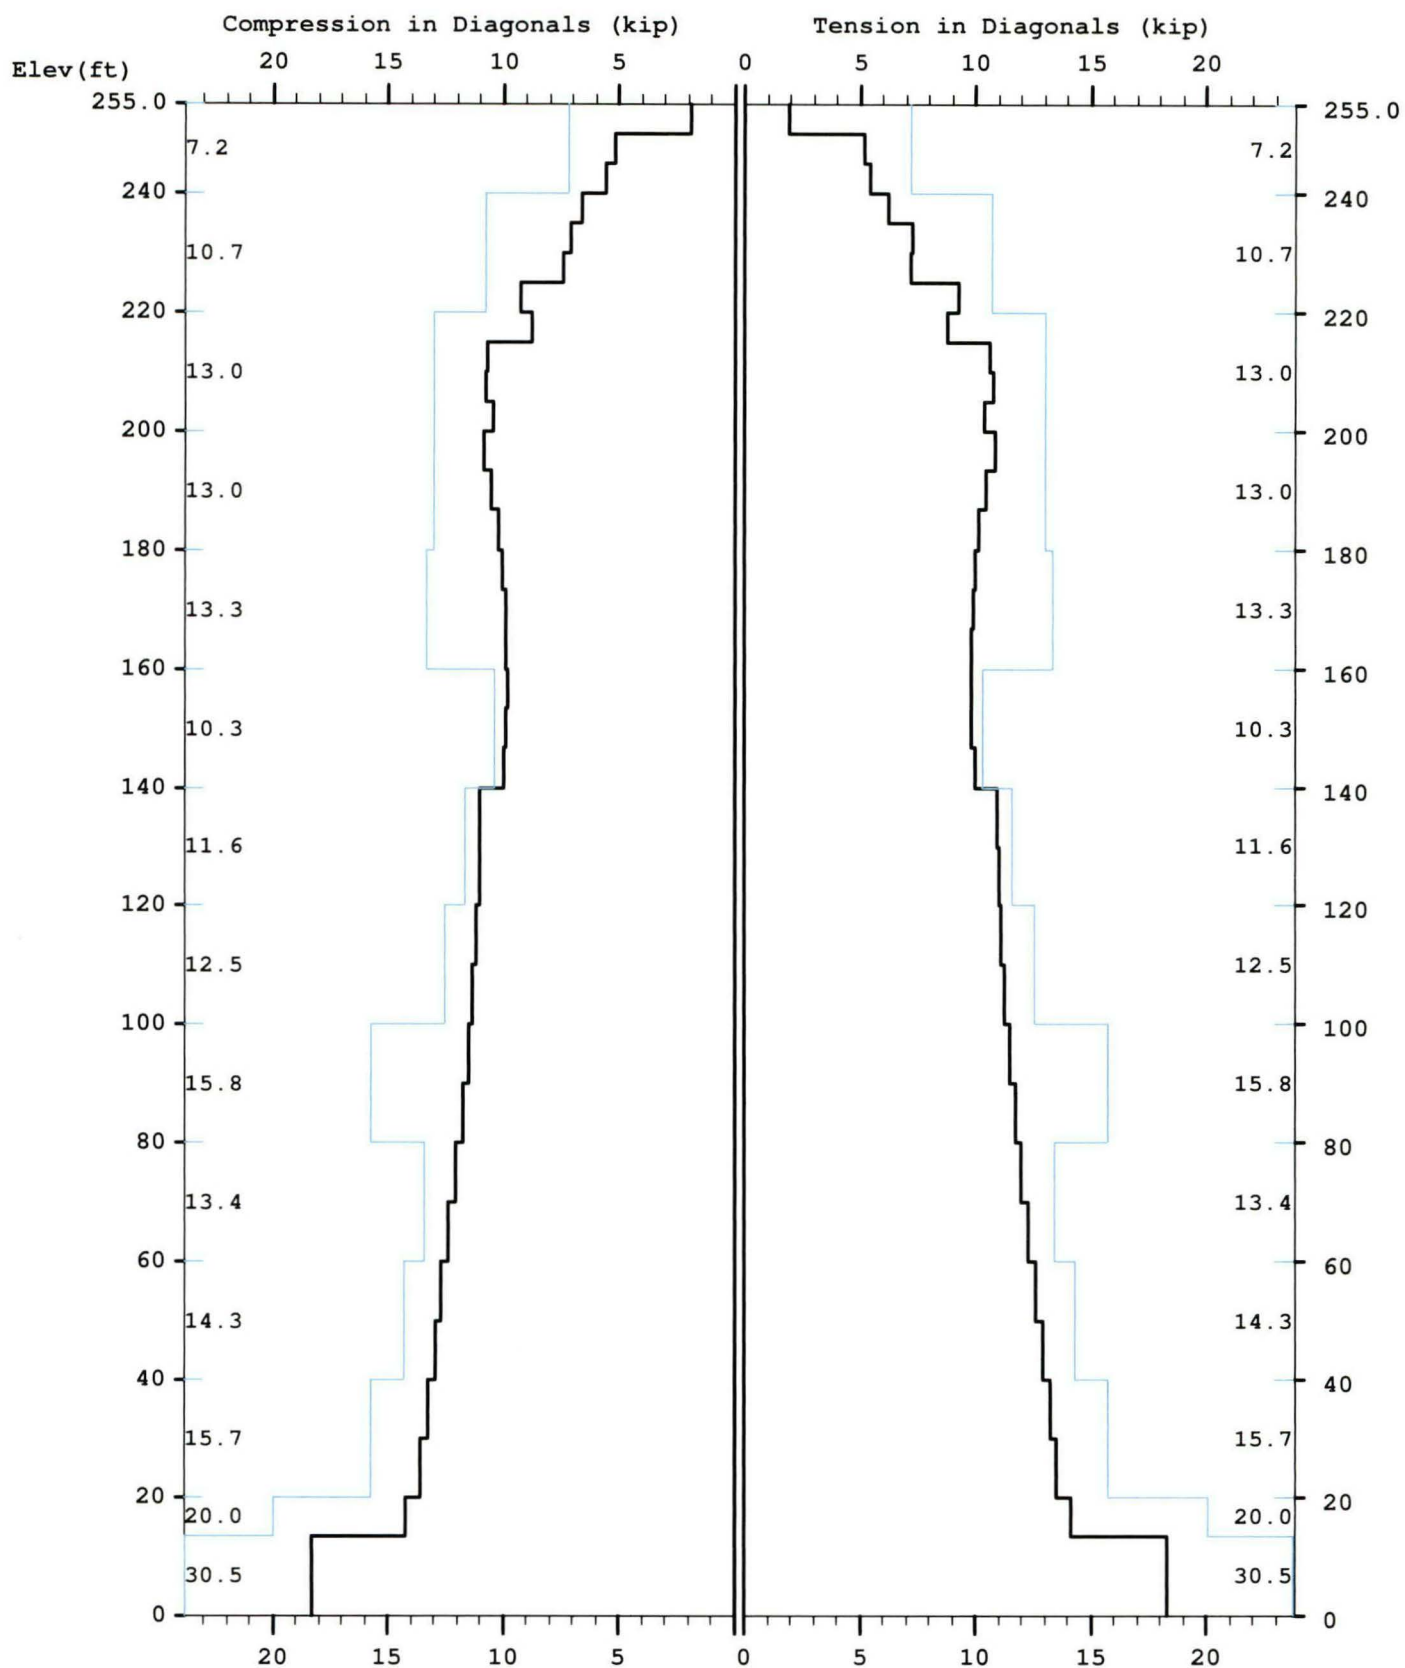


Maximum

TOTAL FOUNDATION LOADS (kip, ft-kip)

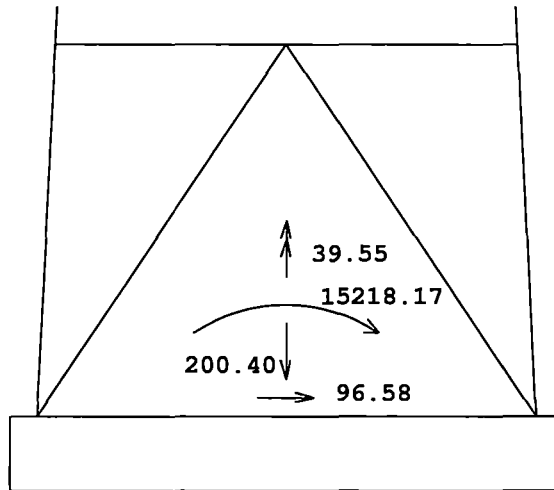

INDIVIDUAL FOOTING LOADS (kip)

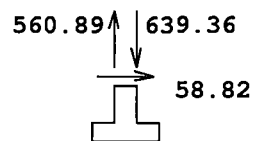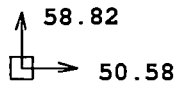

418882

Latticed Tower Analysis (Unguyed)
Processed under license at:

(c)2015 Guymast Inc. 416-736-7453

Sabre Towers and Poles

on: 29 sep 2018 at: 8:57:42

MAST GEOMETRY (ft)

PANEL TYPE	NO.OF LEGS	ELEV.AT BOTTOM	ELEV.AT TOP	F.W..AT BOTTOM	F.W..AT TOP	TYPICAL PANEL HEIGHT
X	3	250.00	255.00	5.00	5.00	5.00
X	3	240.00	250.00	5.00	5.00	5.00
X	3	235.00	240.00	5.50	5.00	5.00
X	3	220.00	235.00	7.00	5.50	5.00
X	3	200.00	220.00	9.00	7.00	5.00
X	3	180.00	200.00	11.00	9.00	6.67
X	3	160.00	180.00	13.00	11.00	6.67
X	3	140.00	160.00	15.00	13.00	6.67
X	3	120.00	140.00	17.00	15.00	10.00
X	3	100.00	120.00	19.00	17.00	10.00
X	3	80.00	100.00	21.00	19.00	10.00
X	3	60.00	80.00	23.00	21.00	10.00
X	3	40.00	60.00	25.00	23.00	10.00
X	3	20.00	40.00	27.00	25.00	10.00
V	3	13.33	20.00	27.67	27.00	6.67
A	3	0.00	13.33	29.00	27.67	13.33

MEMBER PROPERTIES

MEMBER TYPE	BOTTOM ELEV ft	TOP ELEV ft	X-SECTN AREA in.sq	RADIUS OF GYRAT in	ELASTIC MODULUS ksi	THERMAL EXPANSN /deg
LE	240.00	255.00	1.075	0.787	29000.	0.0000117
LE	220.00	240.00	3.016	0.787	29000.	0.0000117
LE	200.00	220.00	4.407	0.787	29000.	0.0000117
LE	180.00	200.00	6.111	0.787	29000.	0.0000117
LE	160.00	180.00	7.952	0.787	29000.	0.0000117
LE	140.00	160.00	8.399	0.787	29000.	0.0000117
LE	80.00	140.00	12.763	0.787	29000.	0.0000117
LE	60.00	80.00	16.101	0.787	29000.	0.0000117
LE	0.00	60.00	14.579	0.787	29000.	0.0000117
DI	240.00	255.00	0.484	0.626	29000.	0.0000117
DI	220.00	240.00	0.715	0.626	29000.	0.0000117
DI	200.00	220.00	0.902	0.626	29000.	0.0000117
DI	180.00	200.00	1.188	0.626	29000.	0.0000117
DI	140.00	180.00	1.090	0.626	29000.	0.0000117
DI	120.00	140.00	1.562	0.626	29000.	0.0000117
DI	100.00	120.00	1.688	0.626	29000.	0.0000117
DI	40.00	100.00	1.938	0.626	29000.	0.0000117
DI	13.33	40.00	2.402	0.626	29000.	0.0000117
DI	0.00	13.33	2.559	0.626	29000.	0.0000117
HO	250.00	255.00	0.484	0.626	29000.	0.0000117
HO	235.00	240.00	0.715	0.626	29000.	0.0000117
HO	0.00	13.33	1.938	0.626	29000.	0.0000117
BR	0.00	13.33	1.438	0.000	29000.	0.0000117

FACTORED MEMBER RESISTANCES

BOTTOM ELEV ft	TOP ELEV ft	LEGS		DIAGONALS		HORIZONTALS		INT BRACING	
		COMP kip	TENS kip	COMP kip	TENS kip	COMP kip	TENS kip	COMP kip	TENS kip
250.0	255.0	31.48	48.15	7.16	7.16	5.82	5.82	0.00	0.00
240.0	250.0	31.48	48.15	7.16	7.16	0.00	0.00	0.00	0.00
235.0	240.0	110.98	135.90	10.74	10.74	8.46	8.46	0.00	0.00
220.0	235.0	110.98	135.90	10.74	10.74	0.00	0.00	0.00	0.00
200.0	220.0	175.98	198.45	13.03	13.03	0.00	0.00	0.00	0.00
180.0	200.0	239.46	274.95	13.00	13.00	0.00	0.00	0.00	0.00
160.0	180.0	309.64	357.75	13.34	13.34	0.00	0.00	0.00	0.00

140.0	160.0	358.08	378.00	10.34	10.34	418882	0.00	0.00	0.00
120.0	140.0	507.33	457.90	11.62	11.62	0.00	0.00	0.00	0.00
100.0	120.0	507.33	457.90	12.53	12.53	0.00	0.00	0.00	0.00
80.0	100.0	507.33	576.00	15.77	15.77	0.00	0.00	0.00	0.00
60.0	80.0	668.86	724.50	13.43	13.43	0.00	0.00	0.00	0.00
40.0	60.0	621.06	656.10	14.31	14.31	0.00	0.00	0.00	0.00
20.0	40.0	621.06	656.10	15.70	15.70	0.00	0.00	0.00	0.00
13.3	20.0	640.29	656.10	20.02	20.02	0.00	0.00	0.00	0.00
0.0	13.3	640.29	656.10	30.51	30.51	15.60	15.60	7.41	7.41

=====

* Only 3 condition(s) shown in full

* Some wind loads may have been derived from full-scale wind tunnel testing

=====

LOADING CONDITION A

89 mph wind with no ice. Wind Azimuth: 0°

MAST LOADING

LOAD TYPE	ELEV ft	APPLY..LOAD..AT RADIUS ft	AZI	LOAD AZIFORCES.....	MOMENTS.....	
					HORIZ kip	DOWN kip	VERTICAL ft-kip	TORSNAL ft-kip
C	260.0	0.00	0.0	0.0	0.28	0.15	0.00	0.00
C	250.0	0.00	0.0	0.0	10.00	7.20	0.00	0.00
C	238.0	0.00	0.0	0.0	7.41	4.80	0.00	0.00
C	226.0	0.00	0.0	0.0	7.33	4.80	0.00	0.00
C	214.0	0.00	0.0	0.0	7.24	4.80	0.00	0.00
D	255.0	0.00	180.0	0.0	0.07	0.04	0.00	0.00
D	250.0	0.00	180.0	0.0	0.07	0.04	0.00	0.00
D	250.0	0.00	42.0	0.0	0.13	0.06	0.06	0.10
D	240.0	0.00	42.0	0.0	0.13	0.06	0.06	0.10
D	240.0	0.00	64.4	0.0	0.16	0.12	0.06	0.11
D	235.0	0.00	64.4	0.0	0.16	0.12	0.06	0.11
D	235.0	0.00	79.5	0.0	0.17	0.12	0.06	0.11
D	230.0	0.00	79.5	0.0	0.17	0.12	0.06	0.11
D	230.0	0.00	83.3	0.0	0.18	0.13	0.05	0.10
D	225.0	0.00	83.3	0.0	0.18	0.13	0.05	0.10
D	225.0	0.00	92.0	0.0	0.20	0.15	0.04	0.06
D	220.0	0.00	92.0	0.0	0.20	0.15	0.04	0.06
D	220.0	0.00	89.2	0.0	0.22	0.18	0.05	0.06
D	215.0	0.00	89.2	0.0	0.22	0.18	0.05	0.06
D	215.0	0.00	353.1	0.0	0.23	0.20	0.01	0.04
D	210.0	0.00	353.1	0.0	0.23	0.20	0.01	0.04
D	210.0	0.00	322.3	0.0	0.23	0.20	0.02	0.04
D	200.0	0.00	322.2	0.0	0.24	0.21	0.02	0.04
D	200.0	0.00	322.4	0.0	0.23	0.23	0.02	0.04
D	180.0	0.00	321.9	0.0	0.24	0.24	0.02	0.04
D	180.0	0.00	322.4	0.0	0.24	0.26	0.02	0.04
D	160.0	0.00	321.9	0.0	0.25	0.26	0.02	0.04
D	160.0	0.00	322.4	0.0	0.26	0.27	0.02	0.04
D	140.0	0.00	322.0	0.0	0.26	0.27	0.02	0.04
D	140.0	0.00	322.3	0.0	0.24	0.33	0.02	0.04
D	110.0	0.00	322.3	0.0	0.25	0.34	0.02	0.04
D	110.0	0.00	322.3	0.0	0.25	0.35	0.02	0.04
D	80.0	0.00	322.3	0.0	0.26	0.37	0.02	0.03
D	80.0	0.00	322.4	0.0	0.26	0.42	0.02	0.03
D	40.0	0.00	322.3	0.0	0.27	0.41	0.02	0.03
D	40.0	0.00	322.4	0.0	0.25	0.45	0.02	0.03
D	20.0	0.00	322.3	0.0	0.25	0.45	0.02	0.03
D	20.0	0.00	322.4	0.0	0.20	0.42	0.02	0.02
D	13.3	0.00	322.4	0.0	0.20	0.42	0.02	0.02
D	13.3	0.00	322.4	0.0	0.24	0.50	0.02	0.02
D	0.0	0.00	322.4	0.0	0.24	0.50	0.02	0.02

LOADING CONDITION M

89 mph wind with no ice. Wind Azimuth: 0°

418882

MAST LOADING

=====

LOAD TYPE	ELEV ft	APPLY... RADIUS ft	LOAD...AT AZI	LOAD AZIFORCES.....	MOMENTS.....	
					HORIZ kip	DOWN kip	VERTICAL ft-kip	TORSNAL ft-kip
C	260.0	0.00	0.0	0.0	0.28	0.12	0.00	0.00
C	250.0	0.00	0.0	0.0	10.00	5.40	0.00	0.00
C	238.0	0.00	0.0	0.0	7.41	3.60	0.00	0.00
C	226.0	0.00	0.0	0.0	7.33	3.60	0.00	0.00
C	214.0	0.00	0.0	0.0	7.24	3.60	0.00	0.00
D	255.0	0.00	180.0	0.0	0.07	0.03	0.00	0.00
D	250.0	0.00	180.0	0.0	0.07	0.03	0.00	0.00
D	250.0	0.00	42.0	0.0	0.13	0.04	0.04	0.10
D	240.0	0.00	42.0	0.0	0.13	0.04	0.04	0.10
D	240.0	0.00	64.4	0.0	0.16	0.09	0.04	0.11
D	235.0	0.00	64.4	0.0	0.16	0.09	0.04	0.11
D	235.0	0.00	79.5	0.0	0.17	0.09	0.04	0.11
D	230.0	0.00	79.5	0.0	0.17	0.09	0.04	0.11
D	230.0	0.00	83.3	0.0	0.18	0.10	0.04	0.10
D	225.0	0.00	83.3	0.0	0.18	0.10	0.04	0.10
D	225.0	0.00	92.0	0.0	0.20	0.11	0.03	0.06
D	220.0	0.00	92.0	0.0	0.20	0.11	0.03	0.06
D	220.0	0.00	89.2	0.0	0.22	0.13	0.04	0.06
D	215.0	0.00	89.2	0.0	0.22	0.13	0.04	0.06
D	215.0	0.00	351.6	0.0	0.23	0.15	0.01	0.04
D	200.0	0.00	316.7	0.0	0.24	0.15	0.02	0.04
D	200.0	0.00	322.4	0.0	0.23	0.17	0.02	0.04
D	180.0	0.00	321.9	0.0	0.24	0.18	0.02	0.04
D	180.0	0.00	322.4	0.0	0.24	0.19	0.02	0.04
D	160.0	0.00	321.9	0.0	0.25	0.20	0.02	0.04
D	160.0	0.00	322.4	0.0	0.26	0.20	0.02	0.04
D	140.0	0.00	322.0	0.0	0.26	0.21	0.02	0.04
D	140.0	0.00	322.3	0.0	0.24	0.25	0.02	0.04
D	110.0	0.00	322.3	0.0	0.25	0.26	0.02	0.04
D	110.0	0.00	322.3	0.0	0.25	0.26	0.02	0.04
D	80.0	0.00	322.3	0.0	0.26	0.28	0.02	0.03
D	80.0	0.00	322.4	0.0	0.26	0.31	0.02	0.03
D	40.0	0.00	322.3	0.0	0.27	0.31	0.02	0.03
D	40.0	0.00	322.4	0.0	0.25	0.33	0.02	0.03
D	20.0	0.00	322.3	0.0	0.25	0.34	0.02	0.03
D	20.0	0.00	322.4	0.0	0.20	0.31	0.02	0.02
D	13.3	0.00	322.4	0.0	0.20	0.31	0.02	0.02
D	13.3	0.00	322.4	0.0	0.24	0.37	0.02	0.02
D	0.0	0.00	322.4	0.0	0.24	0.37	0.02	0.02

LOADING CONDITION Y

30 mph wind with 0.5 ice. Wind Azimuth: 0°

MAST LOADING

=====

LOAD TYPE	ELEV ft	APPLY... RADIUS ft	LOAD...AT AZI	LOAD AZIFORCES.....	MOMENTS.....	
					HORIZ kip	DOWN kip	VERTICAL ft-kip	TORSNAL ft-kip
C	260.0	0.00	0.0	0.0	0.04	0.25	0.00	0.00
C	250.0	0.00	0.0	0.0	1.06	14.55	0.00	0.00
C	238.0	0.00	0.0	0.0	1.17	9.67	0.00	0.00
C	226.0	0.00	0.0	0.0	1.15	9.65	0.00	0.00
C	214.0	0.00	0.0	0.0	1.13	9.62	0.00	0.00
D	255.0	0.00	180.0	0.0	0.01	0.12	0.00	0.00
D	250.0	0.00	180.0	0.0	0.01	0.12	0.00	0.00
D	250.0	0.00	42.0	0.0	0.01	0.18	0.17	0.01
D	240.0	0.00	42.0	0.0	0.01	0.18	0.17	0.01
D	240.0	0.00	68.0	0.0	0.01	0.29	0.16	0.01
D	235.0	0.00	68.0	0.0	0.01	0.29	0.16	0.01
D	235.0	0.00	86.0	0.0	0.02	0.30	0.17	0.01
D	230.0	0.00	86.0	0.0	0.02	0.30	0.17	0.01
D	230.0	0.00	88.3	0.0	0.02	0.32	0.15	0.01
D	225.0	0.00	88.3	0.0	0.02	0.32	0.15	0.01
D	225.0	0.00	89.1	0.0	0.02	0.38	0.11	0.00
D	220.0	0.00	89.1	0.0	0.02	0.38	0.11	0.00

					418882		
D	220.0	0.00	86.5	0.0	0.02	0.42	0.12
D	215.0	0.00	86.5	0.0	0.02	0.42	0.12
D	215.0	0.00	348.3	0.0	0.02	0.47	0.04
D	210.0	0.00	348.3	0.0	0.02	0.47	0.04
D	210.0	0.00	322.4	0.0	0.02	0.49	0.06
D	180.0	0.00	321.9	0.0	0.02	0.53	0.06
D	180.0	0.00	322.4	0.0	0.02	0.56	0.06
D	160.0	0.00	321.9	0.0	0.02	0.57	0.06
D	160.0	0.00	322.4	0.0	0.02	0.59	0.06
D	140.0	0.00	322.0	0.0	0.02	0.60	0.06
D	140.0	0.00	322.3	0.0	0.02	0.64	0.06
D	110.0	0.00	322.3	0.0	0.02	0.66	0.06
D	110.0	0.00	322.3	0.0	0.02	0.67	0.06
D	80.0	0.00	322.3	0.0	0.02	0.71	0.06
D	80.0	0.00	322.3	0.0	0.02	0.76	0.06
D	50.0	0.00	322.4	0.0	0.02	0.76	0.06
D	50.0	0.00	322.3	0.0	0.02	0.77	0.06
D	20.0	0.00	322.3	0.0	0.02	0.80	0.06
D	20.0	0.00	322.4	0.0	0.02	0.75	0.06
D	13.3	0.00	322.4	0.0	0.02	0.75	0.06
D	13.3	0.00	322.4	0.0	0.02	0.98	0.08
D	0.0	0.00	322.4	0.0	0.02	0.98	0.08

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MAXIMUM TENSION IN MAST MEMBERS (kip)

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ELEV ft	LEGS	DIAG	HORIZ	BRACE
255.0	----- 0.84 S	1.92 G	1.20 A	0.00 A
250.0	----- 4.83 M	5.18 H	0.20 G	0.00 A
245.0	----- 18.39 M	5.45 N	0.26 I	0.00 A
240.0	----- 31.02 M	6.26 M	0.55 K	0.00 A
235.0	----- 46.94 M	7.23 H	0.16 A	0.00 A
230.0	----- 62.27 M	7.23 T	0.12 A	0.00 A
225.0	----- 78.60 M	9.24 H	0.06 A	0.00 A
220.0	----- 97.53 M	8.76 N	0.22 A	0.00 A
215.0	----- 114.08 M	10.60 N	0.03 a	0.00 A
210.0	----- 134.98 M	10.77 B	0.24 A	0.00 A
205.0	----- 152.72 M	10.37 T	0.05 A	0.00 A
200.0	----- 173.61 M	10.88 T	0.20 A	0.00 A
193.3	----- 193.99 M	10.46 N	0.07 A	0.00 A
186.7	----- 214.28 M	10.18 R	0.18 A	0.00 A
180.0	----- 232.06 M	9.99 X	0.07 A	0.00 A
173.3	----- 249.75 M	9.89 X	0.12 A	0.00 A
166.7	----- 265.76 M	9.83 X	0.07 A	0.00 A
160.0	----- 281.74 M	9.83 R	0.10 A	0.00 A
153.3	----- 296.52 M	9.87 P	0.09 A	0.00 A
146.7	----- 311.33 M	9.95 V	0.09 A	0.00 A
140.0	----- 328.40 M	10.96 P	0.09 A	0.00 A
130.0	----- 348.80 M	11.01 V	0.11 A	0.00 A
120.0	----- 367.88 M	11.11 P	0.08 A	0.00 A
110.0	----- 386.76 M	11.27 V	0.10 A	0.00 A
100.0	----- 404.74 M	11.47 P	0.06 A	0.00 A

90.0	-----		0.09 A	418882	0.00 A
	422.61 M	11.72 P			
80.0	-----		0.06 A		0.00 A
	439.83 M	11.99 P			
70.0	-----		0.06 A		0.00 A
	456.94 M	12.29 P			
60.0	-----		0.06 A		0.00 A
	473.63 M	12.60 V			
50.0	-----		0.06 A		0.00 A
	490.30 M	12.93 P			
40.0	-----		0.05 O		0.00 A
	506.61 M	13.24 V			
30.0	-----		0.08 S		0.00 A
	522.75 M	13.52 P			
20.0	-----		0.15 A		0.00 A
	541.53 M	14.18 V			
13.3	-----		0.84 U		0.00 J
	540.35 M	18.28 V			
0.0	-----		0.00 A		0.00 A

MAXIMUM COMPRESSION IN MAST MEMBERS (kip)

ELEV ft	LEGS	DIAG	HORIZ	BRACE
255.0	-----		-1.21 G	0.00 A
	-1.02 A	-1.90 A		
250.0	-----		-0.19 M	0.00 A
	-9.37 G	-5.20 B		
245.0	-----		-0.18 O	0.00 A
	-23.14 G	-5.55 H		
240.0	-----		-0.50 Q	0.00 A
	-37.61 G	-6.61 G		
235.0	-----		-0.10 S	0.00 A
	-55.74 G	-7.11 N		
230.0	-----		-0.11 S	0.00 A
	-71.84 G	-7.38 H		
225.0	-----		-0.02 S	0.00 A
	-91.19 G	-9.26 B		
220.0	-----		-0.20 S	0.00 A
	-110.81 G	-8.79 B		
215.0	-----		-0.01 U	0.00 A
	-130.32 G	-10.73 G		
210.0	-----		-0.21 S	0.00 A
	-152.72 G	-10.76 T		
205.0	-----		-0.03 S	0.00 A
	-171.26 G	-10.42 B		
200.0	-----		-0.18 S	0.00 A
	-193.28 G	-10.89 B		
193.3	-----		-0.05 S	0.00 A
	-214.91 G	-10.50 B		
186.7	-----		-0.16 S	0.00 A
	-236.55 G	-10.20 L		
180.0	-----		-0.05 S	0.00 A
	-255.70 G	-10.03 F		
173.3	-----		-0.10 S	0.00 A
	-274.86 G	-9.91 L		
166.7	-----		-0.06 S	0.00 A
	-292.34 G	-9.86 F		
160.0	-----		-0.09 S	0.00 A
	-309.86 G	-9.85 L		
153.3	-----		-0.08 S	0.00 A
	-326.19 G	-9.90 J		
146.7	-----		-0.08 S	0.00 A
	-342.61 G	-9.97 J		
140.0	-----		-0.08 S	0.00 A
	-361.82 G	-11.02 J		
130.0	-----		-0.10 S	0.00 A
	-385.04 G	-11.05 J		
120.0	-----		-0.07 S	0.00 A
	-406.94 G	-11.16 D		
110.0	-----		-0.08 S	0.00 A
	-428.75 G	-11.31 J		
100.0	-----		-0.05 S	0.00 A

418882

90.0	-449.71 G	-11.52 D		
	-----	-----	-0.08 S	0.00 A
80.0	-470.67 G	-11.76 J		
	-----	-----	-0.05 S	0.00 A
70.0	-491.15 G	-12.05 D		
	-----	-----	-0.05 S	0.00 A
60.0	-511.71 G	-12.34 J		
	-----	-----	-0.05 S	0.00 A
50.0	-531.83 G	-12.65 D		
	-----	-----	-0.05 S	0.00 A
40.0	-551.97 G	-12.97 J		
	-----	-----	-0.06 I	0.00 A
30.0	-571.87 G	-13.27 D		
	-----	-----	-0.09 A	0.00 A
20.0	-591.73 G	-13.56 J		
	-----	-----	-0.13 S	0.00 A
13.3	-613.90 G	-14.25 D		
	-----	-----	-1.01 C	0.00 D
0.0	-615.47 G	-18.33 D		
	-----	-----	0.00 A	0.00 A

FORCE/RESISTANCE RATIO IN LEGS

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MAST ELEV ft	-- LEG COMPRESSION --			---- LEG TENSION ----		
	MAX COMP	COMP RESIST	FORCE/ RESIST RATIO	MAX TENS	TENS RESIST	FORCE/ RESIST RATIO
255.00	1.02	31.48	0.03	0.84	48.15	0.02
250.00	9.37	31.48	0.30	4.83	48.15	0.10
245.00	23.14	31.48	0.74	18.39	48.15	0.38
240.00	37.61	110.98	0.34	31.02	135.90	0.23
235.00	55.74	110.98	0.50	46.94	135.90	0.35
230.00	71.84	110.98	0.65	62.27	135.90	0.46
225.00	91.19	110.98	0.82	78.60	135.90	0.58
220.00	110.81	175.98	0.63	97.53	198.45	0.49
215.00	130.32	175.98	0.74	114.08	198.45	0.57
210.00	152.72	175.98	0.87	134.98	198.45	0.68
205.00	171.26	175.98	0.97	152.72	198.45	0.77
200.00	193.28	239.46	0.81	173.61	274.95	0.63
193.33	214.91	239.46	0.90	193.99	274.95	0.71
186.67	236.55	239.46	0.99	214.28	274.95	0.78
180.00	255.70	309.64	0.83	232.06	357.75	0.65
173.33	274.86	309.64	0.89	249.75	357.75	0.70
166.67	292.34	309.64	0.94	265.76	357.75	0.74
160.00	309.86	358.08	0.87	281.74	378.00	0.75
153.33	326.19	358.08	0.91	296.52	378.00	0.78
146.67	342.61	358.08	0.96	311.33	378.00	0.82
140.00	361.82	507.33	0.71	328.40	457.90	0.72
130.00	385.04	507.33	0.76	348.80	457.90	0.76
120.00	406.94	507.33	0.80	367.88	457.90	0.80
110.00	428.75	507.33	0.85	386.76	457.90	0.84
100.00	449.71	507.33	0.89	404.74	576.00	0.70

	418882					
90.00	470.67	507.33	0.93	422.61	576.00	0.73
80.00	491.15	668.86	0.73	439.83	724.50	0.61
70.00	511.71	668.86	0.77	456.94	724.50	0.63
60.00	531.83	621.06	0.86	473.63	656.10	0.72
50.00	551.97	621.06	0.89	490.30	656.10	0.75
40.00	571.87	621.06	0.92	506.61	656.10	0.77
30.00	591.73	621.06	0.95	522.75	656.10	0.80
20.00	613.90	640.29	0.96	541.53	656.10	0.83
13.33	615.47	640.29	0.96	540.35	656.10	0.82
0.00						

FORCE/RESISTANCE RATIO IN DIAGONALS

MAST ELEV ft	- DIAG COMPRESSION -			--- DIAG TENSION ---		
	MAX COMP	COMP RESIST	FORCE/ RESIST RATIO	MAX TENS	TENS RESIST	FORCE/ RESIST RATIO
255.00	1.90	7.16	0.27	1.92	7.16	0.27
250.00	5.20	7.16	0.73	5.18	7.16	0.72
245.00	5.55	7.16	0.77	5.45	7.16	0.76
240.00	6.61	10.74	0.62	6.26	10.74	0.58
235.00	7.11	10.74	0.66	7.23	10.74	0.67
230.00	7.38	10.74	0.69	7.23	10.74	0.67
225.00	9.26	10.74	0.86	9.24	10.74	0.86
220.00	8.79	13.03	0.67	8.76	13.03	0.67
215.00	10.73	13.03	0.82	10.60	13.03	0.81
210.00	10.76	13.03	0.83	10.77	13.03	0.83
205.00	10.42	13.03	0.80	10.37	13.03	0.80
200.00	10.89	13.00	0.84	10.88	13.00	0.84
193.33	10.50	13.00	0.81	10.46	13.00	0.80
186.67	10.20	13.00	0.78	10.18	13.00	0.78
180.00	10.03	13.34	0.75	9.99	13.34	0.75
173.33	9.91	13.34	0.74	9.89	13.34	0.74
166.67	9.86	13.34	0.74	9.83	13.34	0.74
160.00	9.85	10.34	0.95	9.83	10.34	0.95
153.33	9.90	10.34	0.96	9.87	10.34	0.95
146.67	9.97	10.34	0.96	9.95	10.34	0.96
140.00	11.02	11.62	0.95	10.96	11.62	0.94
130.00	11.05	11.62	0.95	11.01	11.62	0.95
120.00	11.16	12.53	0.89	11.11	12.53	0.89
110.00	11.31	12.53	0.90	11.27	12.53	0.90
100.00	11.52	15.77	0.73	11.47	15.77	0.73
90.00	11.76	15.77	0.75	11.72	15.77	0.74

418882						
80.00	12.05	13.43	0.90	11.99	13.43	0.89
70.00	12.34	13.43	0.92	12.29	13.43	0.92
60.00	12.65	14.31	0.88	12.60	14.31	0.88
50.00	12.97	14.31	0.91	12.93	14.31	0.90
40.00	13.27	15.70	0.85	13.24	15.70	0.84
30.00	13.56	15.70	0.86	13.52	15.70	0.86
20.00	14.25	20.02	0.71	14.18	20.02	0.71
13.33	18.33	30.51	0.60	18.28	30.51	0.60
0.00						

MAXIMUM INDIVIDUAL FOUNDATION LOADS: (kip)

LOAD---COMPONENTS---				TOTAL
NORTH	EAST	DOWN	UPLIFT	SHEAR
58.82 G	50.58 K	639.36 G	-560.89 M	58.82 G

MAXIMUM TOTAL LOADS ON FOUNDATION : (kip & kip-ft)

HORIZONTAL---			DOWN	OVERTURNING---		TORSION
NORTH	EAST	TOTAL		NORTH	EAST	
		@ 0.0				@ 0.0
96.6 G	92.1 J	96.6 G	200.4 C	15218.2 G	14593.7 J	15218.2 G
						39.6 T

Latticed Tower Analysis (Unguyed)
Processed under license at:

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Sabre Towers and Poles

on: 29 sep 2018 at: 8:58:21

***** Service Load Condition *****

* Only 1 condition(s) shown in full
* Some wind loads may have been derived from full-scale wind tunnel testing

LOADING CONDITION A

60 mph wind with no ice. Wind Azimuth: 0°

MAST LOADING

LOAD TYPE	ELEV ft	APPLY.. RADIUS ft	LOAD..AT AZI	LOAD AZI	FORCES		MOMENTS	
					HORIZ kip	DOWN kip	VERTICAL ft-kip	TORSNAL ft-kip
C	260.0	0.00	0.0	0.0	0.08	0.13	0.00	0.00
C	250.0	0.00	0.0	0.0	2.84	6.00	0.00	0.00
C	238.0	0.00	0.0	0.0	2.10	4.00	0.00	0.00
C	226.0	0.00	0.0	0.0	2.08	4.00	0.00	0.00
C	214.0	0.00	0.0	0.0	2.06	4.00	0.00	0.00

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D	255.0	0.00	180.0	0.0	0.02	0.03	0.00	0.00
D	250.0	0.00	180.0	0.0	0.02	0.03	0.00	0.00
D	250.0	0.00	42.0	0.0	0.04	0.05	0.05	0.03
D	240.0	0.00	42.0	0.0	0.04	0.05	0.05	0.03
D	240.0	0.00	64.4	0.0	0.05	0.10	0.05	0.03
D	235.0	0.00	64.4	0.0	0.05	0.10	0.05	0.03
D	235.0	0.00	79.5	0.0	0.05	0.10	0.05	0.03
D	225.0	0.00	83.3	0.0	0.05	0.11	0.04	0.03
D	225.0	0.00	92.0	0.0	0.06	0.13	0.04	0.02
D	220.0	0.00	92.0	0.0	0.06	0.13	0.04	0.02
D	220.0	0.00	89.2	0.0	0.06	0.15	0.04	0.02
D	215.0	0.00	89.2	0.0	0.06	0.15	0.04	0.02
D	215.0	0.00	353.1	0.0	0.07	0.16	0.01	0.01
D	210.0	0.00	353.1	0.0	0.07	0.16	0.01	0.01
D	210.0	0.00	322.3	0.0	0.07	0.17	0.02	0.01
D	200.0	0.00	322.2	0.0	0.07	0.17	0.02	0.01
D	200.0	0.00	322.4	0.0	0.07	0.19	0.02	0.01
D	180.0	0.00	321.9	0.0	0.07	0.20	0.02	0.01
D	180.0	0.00	322.4	0.0	0.07	0.21	0.02	0.01
D	160.0	0.00	321.9	0.0	0.07	0.22	0.02	0.01
D	160.0	0.00	322.4	0.0	0.07	0.22	0.02	0.01
D	140.0	0.00	322.0	0.0	0.08	0.23	0.02	0.01
D	140.0	0.00	322.3	0.0	0.07	0.28	0.02	0.01
D	110.0	0.00	322.3	0.0	0.07	0.29	0.02	0.01
D	110.0	0.00	322.3	0.0	0.07	0.29	0.02	0.01
D	80.0	0.00	322.3	0.0	0.08	0.31	0.02	0.01
D	80.0	0.00	322.4	0.0	0.08	0.35	0.02	0.01
D	40.0	0.00	322.3	0.0	0.08	0.34	0.02	0.01
D	40.0	0.00	322.4	0.0	0.07	0.37	0.02	0.01
D	20.0	0.00	322.3	0.0	0.07	0.38	0.02	0.01
D	20.0	0.00	322.4	0.0	0.06	0.35	0.02	0.01
D	13.3	0.00	322.4	0.0	0.06	0.35	0.02	0.01
D	13.3	0.00	322.4	0.0	0.07	0.41	0.02	0.01
D	0.0	0.00	322.4	0.0	0.07	0.41	0.02	0.01

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MAXIMUM MAST DISPLACEMENTS:

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ELEV ft	-----DEFLECTIONS (ft)-----			--TILTS (DEG)---		TWIST DEG
	NORTH	EAST	DOWN	NORTH	EAST	
255.0	1.028 G	-0.989 D	0.015 G	0.523 G	-0.504 D	-0.029 F
250.0	0.983 G	-0.945 D	0.015 G	0.524 G	-0.505 D	-0.029 F
245.0	0.936 G	-0.900 D	0.014 G	0.518 G	-0.498 D	-0.029 F
240.0	0.890 G	-0.856 D	0.013 G	0.499 G	-0.480 D	-0.028 F
235.0	0.846 G	-0.814 D	0.013 G	0.489 G	-0.471 D	-0.026 F
230.0	0.803 G	-0.773 D	0.013 G	0.476 G	-0.458 D	-0.025 F
225.0	0.762 G	-0.732 D	0.012 G	0.460 G	-0.442 D	-0.024 F
220.0	0.721 G	-0.693 D	0.012 G	0.440 G	-0.424 D	-0.023 F
215.0	0.683 G	-0.657 D	0.012 G	0.426 G	-0.410 D	-0.022 F
210.0	0.645 G	-0.620 D	0.011 G	0.409 G	-0.394 D	-0.021 F
205.0	0.609 G	-0.586 D	0.011 G	0.391 G	-0.376 D	-0.020 F
200.0	0.575 G	-0.552 D	0.010 G	0.372 G	-0.358 D	-0.019 F
193.3	0.532 G	-0.511 D	0.010 G	0.352 G	-0.338 D	-0.018 F
186.7	0.491 G	-0.472 D	0.009 G	0.331 G	-0.318 D	-0.017 F
180.0	0.453 G	-0.435 D	0.009 G	0.309 G	-0.297 D	-0.016 F
173.3	0.416 G	-0.400 D	0.009 G	0.292 G	-0.281 D	-0.015 F
166.7	0.382 G	-0.367 D	0.008 G	0.275 G	-0.265 D	0.015 H
160.0	0.350 G	-0.336 D	0.008 G	0.258 G	-0.248 D	0.014 H
153.3	0.320 G	-0.307 D	0.008 G	0.241 G	-0.232 D	0.013 H
146.7	0.291 G	-0.280 D	0.007 G	0.225 G	-0.216 D	0.012 H
140.0	0.265 G	-0.254 D	0.007 G	0.208 G	-0.200 D	0.011 H
130.0	0.229 G	-0.220 D	0.007 G	0.192 G	-0.184 D	0.010 H
120.0	0.196 G	0.188 J	0.006 G	0.175 G	-0.168 D	0.009 H
110.0	0.165 G	0.158 J	0.006 G	0.159 G	-0.153 D	0.009 H
100.0	0.138 G	0.132 J	0.005 G	0.142 G	-0.137 D	0.008 H
90.0	0.113 G	0.108 J	0.005 G	0.126 G	-0.121 D	0.007 H
80.0	0.091 G	0.087 J	0.004 G	0.110 G	-0.105 D	0.006 H
70.0	0.072 G	0.069 J	0.004 G	0.097 G	-0.093 D	0.005 H
60.0	0.054 G	0.052 J	0.003 G	0.084 G	-0.081 D	0.004 H
50.0	0.039 G	0.038 J	0.003 G	0.070 G	-0.067 D	0.004 H
40.0	0.026 G	0.025 J	0.002 G	0.056 G	-0.054 D	0.003 H
30.0	0.015 G	-0.014 D	0.002 G	0.042 G	-0.040 D	0.002 H
20.0	0.005 G	-0.005 D	0.001 G	0.028 G	-0.026 D	0.001 H
13.3	0.002 G	0.002 J	0.001 G	0.019 G	-0.018 D	0.001 H
0.0	0.000 A	0.000 A	0.000 A	0.000 A	0.000 A	0.000 A

418882

MAXIMUM TENSION IN MAST MEMBERS (kip)

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ELEV ft	LEGS	DIAG	HORIZ	BRACE
255.0	-----		0.34 A	0.00 A
	0.19 G	0.56 G		
250.0	-----		0.06 G	0.00 A
	0.00 A	1.48 H		
245.0	-----		0.10 I	0.00 A
	3.68 A	1.53 B		
240.0	-----		0.17 K	0.00 A
	6.70 A	1.69 A		
235.0	-----		0.06 A	0.00 A
	10.54 A	2.10 H		
230.0	-----		0.04 A	0.00 A
	14.71 A	2.01 B		
225.0	-----		0.03 A	0.00 A
	18.36 A	2.62 H		
220.0	-----		0.07 A	0.00 A
	23.59 A	2.48 H		
215.0	-----		0.01 C	0.00 A
	27.33 A	2.97 B		
210.0	-----		0.08 A	0.00 A
	32.82 A	3.06 B		
205.0	-----		0.02 A	0.00 A
	37.68 A	2.93 B		
200.0	-----		0.07 A	0.00 A
	43.33 A	3.09 H		
193.3	-----		0.02 A	0.00 A
	48.84 A	2.96 B		
186.7	-----		0.06 A	0.00 A
	54.29 A	2.90 L		
180.0	-----		0.02 A	0.00 A
	59.04 A	2.84 L		
173.3	-----		0.04 A	0.00 A
	63.73 A	2.82 L		
166.7	-----		0.02 A	0.00 A
	67.97 A	2.80 L		
160.0	-----		0.03 A	0.00 A
	72.17 A	2.81 L		
153.3	-----		0.03 A	0.00 A
	76.05 A	2.82 D		
146.7	-----		0.03 A	0.00 A
	79.92 A	2.86 J		
140.0	-----		0.03 A	0.00 A
	84.32 A	3.14 D		
130.0	-----		0.04 A	0.00 A
	89.49 A	3.16 D		
120.0	-----		0.03 A	0.00 A
	94.30 A	3.19 D		
110.0	-----		0.03 A	0.00 A
	99.03 A	3.25 D		
100.0	-----		0.02 A	0.00 A
	103.50 A	3.31 D		
90.0	-----		0.03 A	0.00 A
	107.92 A	3.38 D		
80.0	-----		0.02 A	0.00 A
	112.11 A	3.46 D		
70.0	-----		0.02 A	0.00 A
	116.22 A	3.55 D		
60.0	-----		0.02 A	0.00 A
	120.20 A	3.63 J		
50.0	-----		0.02 A	0.00 A
	124.18 A	3.72 J		
40.0	-----		0.01 C	0.00 A
	128.01 A	3.81 J		
30.0	-----		0.02 G	0.00 A
	131.74 A	3.89 D		
20.0	-----		0.05 A	0.00 A
	136.42 A	4.07 J		
13.3	-----		0.21 I	0.00 H
	135.11 A	5.26 J		
0.0	-----		0.00 A	0.00 A

418882

MAXIMUM COMPRESSION IN MAST MEMBERS (kip)

=====

ELEV ft	LEGS	DIAG	HORIZ	BRACE
255.0	-----	-----	-0.35 G	0.00 A
	-0.35 A	-0.54 A		
250.0	-----	-----	-0.05 A	0.00 A
	-4.08 G	-1.50 B		
245.0	-----	-----	-0.03 C	0.00 A
	-8.05 G	-1.62 H		
240.0	-----	-----	-0.12 E	0.00 A
	-12.72 G	-1.98 G		
235.0	-----	-----	-0.01 G	0.00 A
	-18.52 G	-1.99 B		
230.0	-----	-----	-0.03 G	0.00 A
	-23.30 G	-2.15 H		
225.0	-----	-----	0.00 A	0.00 A
	-29.70 G	-2.64 B		
220.0	-----	-----	-0.05 G	0.00 A
	-35.42 G	-2.51 H		
215.0	-----	-----	0.00 A	0.00 A
	-41.83 G	-3.07 G		
210.0	-----	-----	-0.05 G	0.00 A
	-48.59 G	-3.05 B		
205.0	-----	-----	0.00 G	0.00 A
	-54.03 G	-2.98 B		
200.0	-----	-----	-0.04 G	0.00 A
	-60.54 G	-3.10 B		
193.3	-----	-----	-0.01 G	0.00 A
	-66.98 G	-3.01 H		
186.7	-----	-----	-0.04 G	0.00 A
	-73.45 G	-2.92 L		
180.0	-----	-----	-0.01 G	0.00 A
	-79.21 G	-2.88 L		
173.3	-----	-----	-0.02 G	0.00 A
	-85.01 G	-2.84 L		
166.7	-----	-----	-0.01 G	0.00 A
	-90.33 G	-2.84 L		
160.0	-----	-----	-0.02 G	0.00 A
	-95.67 G	-2.83 L		
153.3	-----	-----	-0.02 G	0.00 A
	-100.69 G	-2.86 J		
146.7	-----	-----	-0.02 G	0.00 A
	-105.74 G	-2.87 D		
140.0	-----	-----	-0.02 G	0.00 A
	-111.71 G	-3.19 D		
130.0	-----	-----	-0.02 G	0.00 A
	-119.02 G	-3.20 D		
120.0	-----	-----	-0.02 G	0.00 A
	-125.95 G	-3.24 D		
110.0	-----	-----	-0.02 G	0.00 A
	-132.88 G	-3.29 D		
100.0	-----	-----	-0.01 G	0.00 A
	-139.60 G	-3.36 D		
90.0	-----	-----	-0.02 G	0.00 A
	-146.33 G	-3.43 D		
80.0	-----	-----	-0.01 G	0.00 A
	-152.98 G	-3.51 J		
70.0	-----	-----	-0.01 G	0.00 A
	-159.69 G	-3.59 J		
60.0	-----	-----	-0.01 G	0.00 A
	-166.26 G	-3.68 D		
50.0	-----	-----	-0.01 G	0.00 A
	-172.83 G	-3.77 D		
40.0	-----	-----	-0.02 I	0.00 A
	-179.36 G	-3.85 D		
30.0	-----	-----	-0.03 A	0.00 A
	-185.90 G	-3.93 D		
20.0	-----	-----	-0.03 G	0.00 A
	-192.95 G	-4.13 D		
13.3	-----	-----	-0.32 C	0.00 C
	-194.26 G	-5.30 D		
0.0	-----	-----	0.00 A	0.00 A

MAXIMUM INDIVIDUAL FOUNDATION LOADS: (kip)

=====

418882

-----LOAD-----	COMPONENTS-----			TOTAL
NORTH	EAST	DOWN	UPLIFT	SHEAR
17.94 G	15.43 K	201.73 G	-140.37 A	17.94 G

MAXIMUM TOTAL LOADS ON FOUNDATION : (kip & kip-ft)

-----HORIZONTAL-----			DOWN	-----OVERTURNING-----			TORSION
NORTH	EAST	TOTAL		NORTH	EAST	TOTAL	
		@				@	
		0.0				0.0	
27.8	-26.5	27.8	83.5	4367.2	-4189.4	4367.2	11.2
G	D	G	G	G	D	G	H

=====

MAT FOUNDATION DESIGN BY SABRE TOWERS & POLES

Tower Description 255' S3TL Series HD1

Customer AT&T

Project Number 418882

Date 10/1/2018

Engineer REB

Overall Loads:

Factored Moment (ft-kips)	15218.17
Factored Axial (kips)	200.40
Factored Shear (kips)	96.58

Individual Leg Loads:

Factored Uplift (kips)	561.00
Factored Download (kips)	639.00
Factored Shear (kips)	59.00

Tower eccentric from mat (ft)= 2.25

Width of Tower (ft)	29
Ultimate Bearing Pressure	5.00
Bearing Φ s	0.75

Allowable Bearing Pressure (ksf)	2.50
Safety Factor	2.00

Bearing Design Strength (ksf)	3.75
Water Table Below Grade (ft)	999
Width of Mat (ft)	38
Thickness of Mat (ft)	1.5
Depth to Bottom of Slab (ft)	6.5
Bolt Circle Diameter (in)	18

Max. Factored Net Bearing Pressure (ksf) 3.48

Minimum Mat Width (ft) 36.00

Top of Concrete to Top of Bottom Threads (in)	72.625
Diameter of Pier (ft)	5
Ht. of Pier Above Ground (ft)	0.5
Ht. of Pier Below Ground (ft)	5
Quantity of Bars in Mat	66
Bar Diameter in Mat (in)	1.41
Area of Bars in Mat (in ²)	103.06
Spacing of Bars in Mat (in)	6.90
Quantity of Bars Pier	34
Bar Diameter in Pier (in)	0.75
Tie Bar Diameter in Pier (in)	0.5
Spacing of Ties (in)	12
Area of Bars in Pier (in ²)	15.02
Spacing of Bars in Pier (in)	4.82
f'c (ksi)	4.5
fy (ksi)	60
Unit Wt. of Soil (kcf)	0.11
Unit Wt. of Concrete (kcf)	0.15
Volume of Concrete (yd ³)	92.22

Minimum Pier Diameter (ft) 2.83
Equivalent Square b (ft) 4.43

Recommended Spacing (in) 6 to 12

Minimum Pier A_s (in²) 14.14
Recommended Spacing (in) 5 to 12

MAT FOUNDATION DESIGN BY SABRE TOWERS & POLES (CONTINUED)

Two-Way Shear:

Average d (in)	13.59
ϕv_c (ksi)	0.228
$\phi v_c = \phi(2 + 4/\beta_c)f'_c{}^{1/2}$	0.342
$\phi v_c = \phi(\alpha_s d/b_o + 2)f'_c{}^{1/2}$	0.253
$\phi v_c = \phi 4f'_c{}^{1/2}$	0.228
Shear perimeter, b_o (in)	223.59
β_c	1

v_u (ksi) 0.214

Stability:

Overturning Design Strength (ft-k) 20395.7

Factored Overturning Moment (ft-k) 15894.2

One-Way Shear:

ϕV_c (kips) 706.7

V_u (kips) 675.1

Pier Design:

Design Tensile Strength (kips) 811.1

T_u (kips) 561.0

ϕV_n (kips) 198.1

V_u (kips) 59.0

$\phi V_c = \phi 2(1 + N_u/(500A_g))f'_c{}^{1/2}b_w d$ 198.1

V_s (kips) 0.0

*** $V_s \text{ max} = 4 f'_c{}^{1/2}b_w d$ (kips) 772.8

Maximum Spacing (in) 7.81

(Only if Shear Ties are Required)

Actual Hook Development (in) 12.18

Req'd Hook Development l_{dh} (in) 8.84

*** Ref. ACI 11.5.5 & 11.5.6.3

Anchor Bolt Pull-Out:

$\phi P_c = \phi \lambda (2/3)f'_c{}^{1/2}(2.8A_{\text{SLOPE}} + 4A_{\text{FLAT}})$ 426.0

P_u (kips) 561.0

Pier Rebar Development Length (in) 52.50

Required Length of Development (in) 18.56

Flexure in Slab:

ϕM_n (ft-kips) 5480.4

M_u (ft-kips) 5435.9

a (in) 3.55

Steel Ratio 0.01663

β_1 0.825

Maximum Steel Ratio (ρ_t) 0.0197

Minimum Steel Ratio 0.0018

Rebar Development in Pad (in) 124.13

Required Development in Pad (in) 20.77

Condition	1 is OK, 0 Fails
Minimum Mat Width	1
Maximum Soil Bearing Pressure	1
Pier Area of Steel	1
Pier Shear	1
Two-Way Shear	1
Overturning	1
Anchor Bolt Pull-Out	1
Flexure	1
Steel Ratio	1
Length of Development in Pad	1
Interaction Diagram Visual Check	1
One-Way Shear	1
Hook Development	1
Minimum Mat Depth	1



August 15th, 2018
Kentucky Public Service Commission
211 Sower Blvd.
P.O. Box 615
Frankfort, KY 40602-0615

RE: Site Name – Wallins Creek
Proposed Cell Tower
36 48 02.36 North Latitude, 83 24 43.64 West Longitude

Dear Commissioners:

The Project / Construction Manager for the proposed new communications facility will be Don Murdock. His contact information is (615) 207-8280 or Don.Murdock@mastec.com

Don has been in the industry completing civil construction and constructing towers since 2009. He has worked at Mastec Network Solutions since 2009 completing project and construction management on new site build projects.

Thank you,

A handwritten signature in blue ink, appearing to read "Don Murdock".

Don Murdock, Sr. Project Manager – Tennessee/Kentucky Market
MasTec Network Solutions
(615) 207-8280

EXHIBIT D
COMPETING UTILITIES, CORPORATIONS, OR PERSONS LIST

KY Public Service Commission

Master Utility Search

- Search for the utility of interest by using any single or combination of criteria.
- Enter Partial names to return the closest match for Utility Name and Address/City/Contact entries.

Utility ID	Utility Name	Address/City/Contact	Utility Type	Status
<input type="text"/>	<input type="text"/>	<input type="text"/>	<input type="text"/>	Active <input type="text"/>
<input type="button" value="Search"/>				

	Utility ID	Utility Name	Utility Type	Class	City	State
<input type="button" value="View"/>	4107900	365 Wireless, LLC	Cellular	D	Atlanta	GA
<input type="button" value="View"/>	4109300	Access Point, Inc.	Cellular	D	Cary	NC
<input type="button" value="View"/>	4108300	Air Voice Wireless, LLC	Cellular	A	Bloomfield Hill	MI
<input type="button" value="View"/>	4110650	Alliant Technologies of KY, L.L.C.	Cellular	C	Morristown	NJ
<input type="button" value="View"/>	44451184	Alltel Communications, LLC	Cellular	A	Basking Ridge	NJ
<input type="button" value="View"/>	4110850	AltaWorx, LLC	Cellular	C	Fairhope	AL
<input type="button" value="View"/>	4107800	American Broadband and Telecommunications Company	Cellular	C	Toledo	OH
<input type="button" value="View"/>	4108650	AmeriMex Communications Corp.	Cellular	D	Dunedin	FL
<input type="button" value="View"/>	4105100	AmeriVision Communications, Inc. d/b/a Affinity 4	Cellular	D	Virginia Beach	VA
<input type="button" value="View"/>	4110700	Andrew David Balholm dba Norcell	Cellular	C	Clayton	WA
<input type="button" value="View"/>	4108600	BCN Telecom, Inc.	Cellular	D	Morristown	NJ
<input type="button" value="View"/>	4110550	Blue Casa Mobile, LLC	Cellular	D	Santa Barbara	CA
<input type="button" value="View"/>	4108750	Blue Jay Wireless, LLC	Cellular	C	Carrollton	TX
<input type="button" value="View"/>	4111050	BlueBird Communications, LLC	Cellular	C	New York	NY
<input type="button" value="View"/>	4202300	Bluegrass Wireless, LLC	Cellular	A	Elizabethtown	KY
<input type="button" value="View"/>	4107600	Boomerang Wireless, LLC	Cellular	B	Hiawatha	IA
<input type="button" value="View"/>	4105500	BullsEye Telecom, Inc.	Cellular	D	Southfield	MI

View	4110050	CampusSims, Inc.	Cellular	D	Boston	MA
View	4100700	Cellco Partnership dba Verizon Wireless	Cellular	A	Basking Ridge	NJ
View	4106600	Cintex Wireless, LLC	Cellular	D	Rockville	MD
View	4111000	ComApp Technologies LLC	Cellular	C	Melrose	MA
View	4101900	Consumer Cellular, Incorporated	Cellular	A	Portland	OR
View	4106400	Credo Mobile, Inc.	Cellular	A	San Francisco	CA
View	4108850	Cricket Wireless, LLC	Cellular	A	San Antonio	TX
View	4001900	CTC Communications Corp. d/b/a EarthLink Business I	Cellular	D	Grand Rapids	MI
View	10640	Cumberland Cellular Partnership	Cellular	A	Elizabethtown	KY
View	4101000	East Kentucky Network, LLC dba Appalachian Wireless	Cellular	A	Ivel	KY
View	4002300	Easy Telephone Service Company dba Easy Wireless	Cellular	D	Ocala	FL
View	4109500	Enhanced Communications Group, LLC	Cellular	D	Bartlesville	OK
View	4110450	Excellus Communications, LLC	Cellular	D	Chattanooga	TN
View	4105900	Flash Wireless, LLC	Cellular	C	Concord	NC
View	4104800	France Telecom Corporate Solutions L.L.C.	Cellular	D	Oak Hill	VA
View	4109350	Global Connection Inc. of America	Cellular	D	Norcross	GA
View	4102200	Globalstar USA, LLC	Cellular	B	Covington	LA
View	4109600	Google North America Inc.	Cellular	B	Mountain View	CA
View	33350363	Granite Telecommunications, LLC	Cellular	D	Quincy	MA
View	4106000	GreatCall, Inc. d/b/a Jitterbug	Cellular	A	San Diego	CA
View	10630	GTE Wireless of the Midwest dba Verizon Wireless	Cellular	A	Basking Ridge	NJ
View	4110600	Horizon River Technologies, LLC	Cellular	C	Atlanta	GA
View	4103100	i-Wireless, LLC	Cellular	A	Newport	KY
View	4109800	IM Telecom, LLC d/b/a Infiniti Mobile	Cellular	D	Tulsa	OK
View	22215360	KDDI America, Inc.	Cellular	D	New York	NY
View	10872	Kentucky RSA #1 Partnership	Cellular	A	Basking Ridge	NJ
View	10680	Kentucky RSA #3 Cellular General	Cellular	A	Elizabethtown	KY
View	10681	Kentucky RSA #4 Cellular General	Cellular	A	Elizabethtown	KY
View	4109750	Konatel, Inc. dba telecom.mobi	Cellular	D	Johnstown	PA
View	4110900	Lunar Labs, Inc.	Cellular	C	Detroit	MI
View	4107300	Lycamobile USA, Inc.	Cellular	D	Newark	NJ
View	4108800	MetroPCS Michigan, LLC	Cellular	A	Bellevue	WA

View	4109650	Mitel Cloud Services, Inc.	Cellular	D	Mesa	AZ
View	4202400	New Cingular Wireless PCS, LLC dba AT&T Mobility, PCS	Cellular	A	San Antonio	TX
View	10900	New Par dba Verizon Wireless	Cellular	A	Basking Ridge	NJ
View	4000800	Nextel West Corporation	Cellular	D	Overland Park	KS
View	4001300	NPCR, Inc. dba Nextel Partners	Cellular	D	Overland Park	KS
View	4001800	OnStar, LLC	Cellular	A	Detroit	MI
View	4110750	Onvoy Spectrum, LLC	Cellular	C	Plymouth	MN
View	4109050	Patriot Mobile LLC	Cellular	D	Southlake	TX
View	4110250	Plintron Technologies USA LLC	Cellular	D	Bellevue	WA
View	33351182	PNG Telecommunications, Inc. dba PowerNet Global Communications	Cellular	D	Cincinnati	OH
View	4202100	Powertel/Memphis, Inc. dba T-Mobile	Cellular	A	Bellevue	WA
View	4107700	Puretalk Holdings, LLC	Cellular	A	Covington	GA
View	4106700	Q Link Wireless, LLC	Cellular	A	Dania	FL
View	4108700	Ready Wireless, LLC	Cellular	B	Hiawatha	IA
View	4110500	Republic Wireless, Inc.	Cellular	D	Raleigh	NC
View	4106200	Rural Cellular Corporation	Cellular	A	Basking Ridge	NJ
View	4108550	Sage Telecom Communications, LLC dba TruConnect	Cellular	D	Los Angeles	CA
View	4109150	SelecTel, Inc. d/b/a SelecTel Wireless	Cellular	D	Freemont	NE
View	4106300	SI Wireless, LLC	Cellular	A	Carbondale	IL
View	4110150	Spectrotel, Inc. d/b/a Touch Base Communications	Cellular	D	Neptune	NJ
View	4200100	Sprint Spectrum, L.P.	Cellular	A	Atlanta	GA
View	4200500	SprintCom, Inc.	Cellular	A	Atlanta	GA
View	4109550	Stream Communications, LLC	Cellular	D	Dallas	TX
View	4110200	T C Telephone LLC d/b/a Horizon Cellular	Cellular	D	Red Bluff	CA
View	4202200	T-Mobile Central, LLC dba T-Mobile	Cellular	A	Bellevue	WA
View	4002500	TAG Mobile, LLC	Cellular	D	Carrollton	TX
View	4109700	Telecom Management, Inc. dba Pioneer Telephone	Cellular	D	South Portland	ME
View	4107200	Telefonica USA, Inc.	Cellular	D	Miami	FL
View	4108900	Telrite Corporation dba Life Wireless	Cellular	D	Covington	GA
View	4108450	Tempo Telecom, LLC	Cellular	D	Kansas City	MO
View	4109950	The People's Operator USA, LLC	Cellular	D	New York	NY
View	4109000	Ting, Inc.	Cellular	A	Toronto	ON
View	4110400	Torch Wireless Corp.	Cellular	D	Jacksonville	FL

View	4103300	Touchtone Communications, Inc.	Cellular	D	Whippany	NJ
View	4104200	TracFone Wireless, Inc.	Cellular	D	Miami	FL
View	4002000	Truphone, Inc.	Cellular	D	Durham	NC
View	4110300	UVNV, Inc.	Cellular	D	Costa Mesa	CA
View	4105700	Virgin Mobile USA, L.P.	Cellular	A	Atlanta	GA
View	4110800	Visible Service LLC	Cellular	C	Lone Tree	CO
View	4106500	WiMacTel, Inc.	Cellular	D	Palo Alto	CA
View	4110950	Wing Tel Inc.	Cellular	C	New York	NY
View	4109900	Wireless Telecom Cooperative, Inc. dba theWirelessFreeway	Cellular	D	Louisville	KY

EXHIBIT E
FAA



Mail Processing Center
Federal Aviation Administration
Southwest Regional Office
Obstruction Evaluation Group
10101 Hillwood Parkway
Fort Worth, TX 76177

Aeronautical Study No.
2018-ASO-13610-OE

Issued Date: 09/20/2018

ROBERT P. WALTERS
AT&T MOBILITY - (dc)
VP-RAN OPERATIONS
208 S Akard Dr # 1016.1
Dallas, TX 75202

**** DETERMINATION OF NO HAZARD TO AIR NAVIGATION ****

The Federal Aviation Administration has conducted an aeronautical study under the provisions of 49 U.S.C., Section 44718 and if applicable Title 14 of the Code of Federal Regulations, part 77, concerning:

Structure:	Tower Wallins Creek
Location:	Wallins Creek, KY
Latitude:	36-48-02.36N NAD 83
Longitude:	83-24-43.64W
Heights:	1537 feet site elevation (SE)
	270 feet above ground level (AGL)
	1807 feet above mean sea level (AMSL)

This aeronautical study revealed that the structure does not exceed obstruction standards and would not be a hazard to air navigation provided the following condition(s), if any, is(are) met:

As a condition to this Determination, the structure is to be marked/lighted in accordance with FAA Advisory circular 70/7460-1 L Change 2, Obstruction Marking and Lighting, a med-dual system - Chapters 4,8(M-Dual),&12.

Any failure or malfunction that lasts more than thirty (30) minutes and affects a top light or flashing obstruction light, regardless of its position, should be reported immediately to (877) 487-6867 so a Notice to Airmen (NOTAM) can be issued. As soon as the normal operation is restored, notify the same number.

It is required that FAA Form 7460-2, Notice of Actual Construction or Alteration, be e-filed any time the project is abandoned or:

____ At least 10 days prior to start of construction (7460-2, Part 1)
 X Within 5 days after the construction reaches its greatest height (7460-2, Part 2)

This determination expires on 03/20/2020 unless:

- (a) the construction is started (not necessarily completed) and FAA Form 7460-2, Notice of Actual Construction or Alteration, is received by this office.
- (b) extended, revised, or terminated by the issuing office.

- (c) the construction is subject to the licensing authority of the Federal Communications Commission (FCC) and an application for a construction permit has been filed, as required by the FCC, within 6 months of the date of this determination. In such case, the determination expires on the date prescribed by the FCC for completion of construction, or the date the FCC denies the application.

NOTE: REQUEST FOR EXTENSION OF THE EFFECTIVE PERIOD OF THIS DETERMINATION MUST BE E-FILED AT LEAST 15 DAYS PRIOR TO THE EXPIRATION DATE. AFTER RE-EVALUATION OF CURRENT OPERATIONS IN THE AREA OF THE STRUCTURE TO DETERMINE THAT NO SIGNIFICANT AERONAUTICAL CHANGES HAVE OCCURRED, YOUR DETERMINATION MAY BE ELIGIBLE FOR ONE EXTENSION OF THE EFFECTIVE PERIOD.

This determination is based, in part, on the foregoing description which includes specific coordinates, heights, frequency(ies) and power. Any changes in coordinates, heights, and frequencies or use of greater power, except those frequencies specified in the Colo Void Clause Coalition; Antenna System Co-Location; Voluntary Best Practices, effective 21 Nov 2007, will void this determination. Any future construction or alteration, including increase to heights, power, or the addition of other transmitters, requires separate notice to the FAA. This determination includes all previously filed frequencies and power for this structure.

If construction or alteration is dismantled or destroyed, you must submit notice to the FAA within 5 days after the construction or alteration is dismantled or destroyed.

This determination does include temporary construction equipment such as cranes, derricks, etc., which may be used during actual construction of the structure. However, this equipment shall not exceed the overall heights as indicated above. Equipment which has a height greater than the studied structure requires separate notice to the FAA.

This determination concerns the effect of this structure on the safe and efficient use of navigable airspace by aircraft and does not relieve the sponsor of compliance responsibilities relating to any law, ordinance, or regulation of any Federal, State, or local government body.

A copy of this determination will be forwarded to the Federal Communications Commission (FCC) because the structure is subject to their licensing authority.

If we can be of further assistance, please contact our office at (206) 231-2993, or lynnette.farrell@faa.gov. On any future correspondence concerning this matter, please refer to Aeronautical Study Number 2018-ASO-13610-OE.

Signature Control No: 368759408-385611765

(DNE)

Lynnette Farrell
Technician

Attachment(s)
Map(s)

cc: FCC

TOPO Map for ASN 2018-ASO-13610-OE

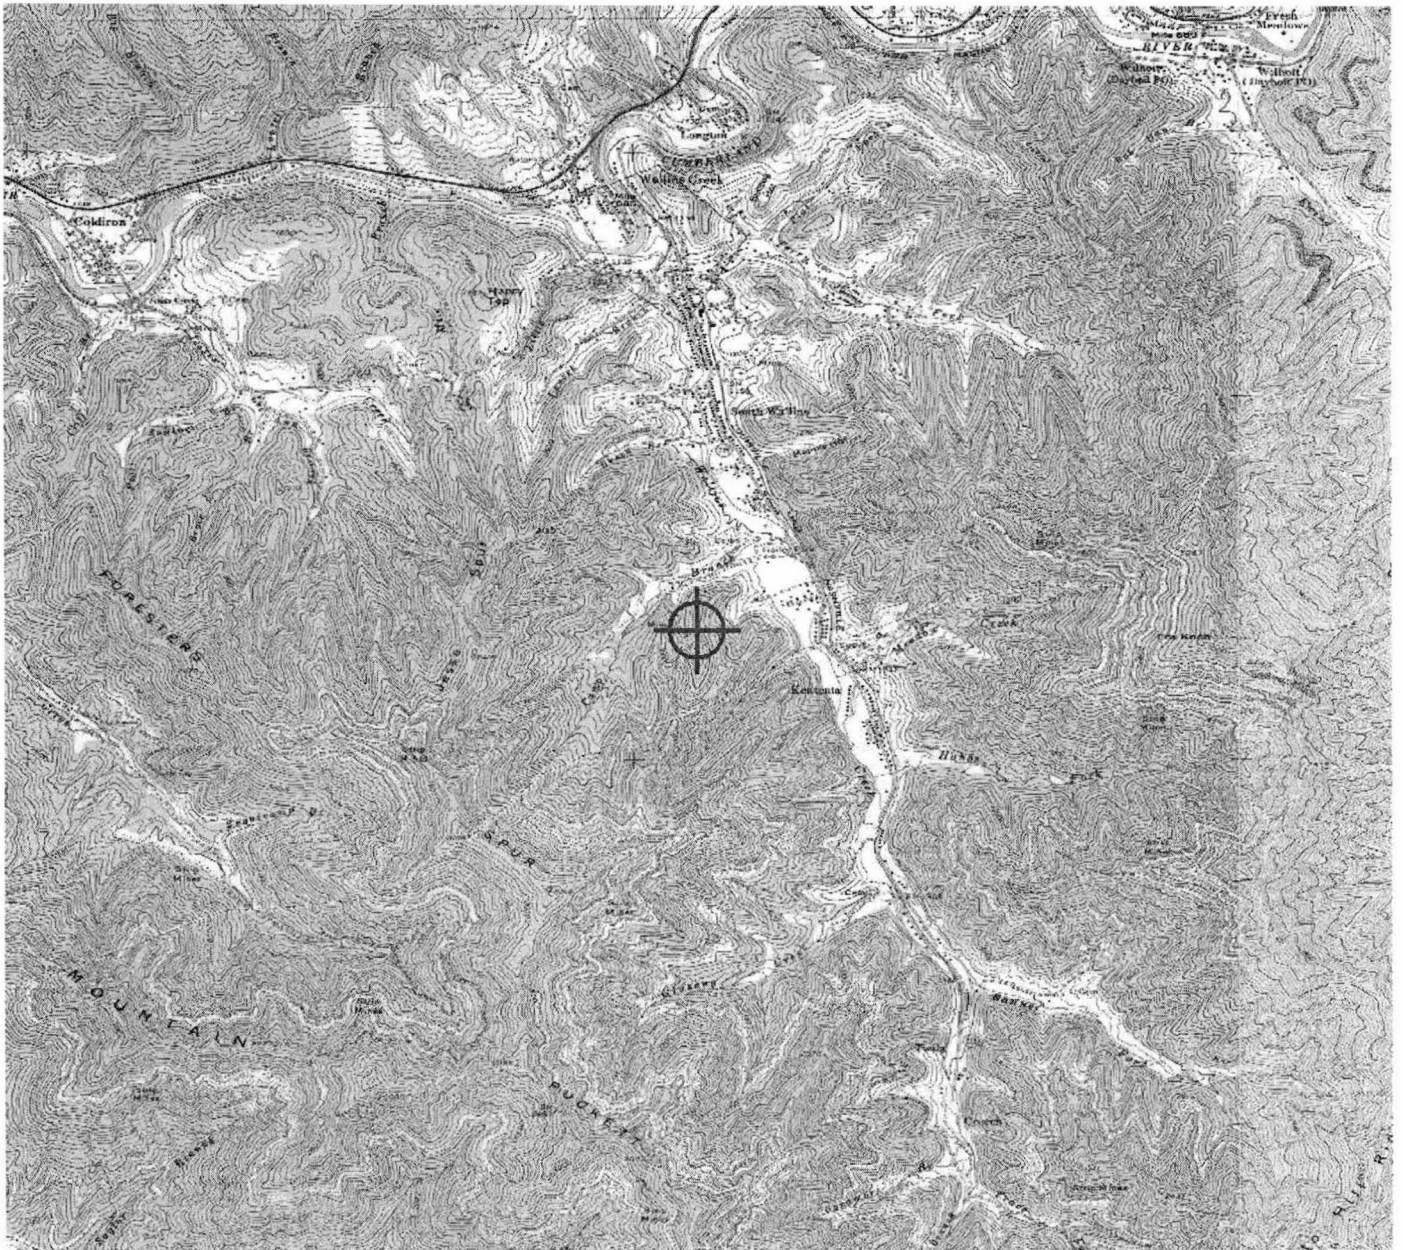


EXHIBIT F
KENTUCKY AIRPORT ZONING COMMISSION



KENTUCKY TRANSPORTATION CABINET
KENTUCKY AIRPORT ZONING COMMISSION

TC 55-2
Rev. 06/2016
Page 2 of 2

APPLICATION FOR PERMIT TO CONSTRUCT OR ALTER A STRUCTURE

APPLICANT (name) John Monday		PHONE 855-699-7073	FAX 972-907-1131	KY AERONAUTICAL STUDY #	
ADDRESS (street) 3300 E. Renner Road, B3132		CITY Richardson		STATE TX	ZIP 75082
APPLICANT'S REPRESENTATIVE (name) Cody Knox		PHONE 318-355-6599	FAX 318-388-6167		
ADDRESS (street) 214 Expo Circle, Suite 4		CITY West Monroe		STATE LA	ZIP 71292
APPLICATION FOR <input checked="" type="checkbox"/> New Construction <input type="checkbox"/> Alteration <input type="checkbox"/> Existing DURATION <input type="checkbox"/> Permanent <input type="checkbox"/> Temporary (months days)				WORK SCHEDULE Start End TBD	
TYPE <input type="checkbox"/> Crane <input type="checkbox"/> Building <input checked="" type="checkbox"/> Antenna Tower <input type="checkbox"/> Power Line <input type="checkbox"/> Water Tank <input type="checkbox"/> Landfill <input type="checkbox"/> Other		MARKING/PAINTING/LIGHTING PREFERRED <input type="checkbox"/> Red Lights & Paint <input type="checkbox"/> White- medium intensity <input type="checkbox"/> White- high intensity <input checked="" type="checkbox"/> Dual- red & medium intensity white <input type="checkbox"/> Dual- red & high intensity white <input type="checkbox"/> Other			
LATITUDE 36° 48' 02.36 "		LONGITUDE 83° 24' 43.64 "		DATUM <input checked="" type="checkbox"/> NAD83 <input type="checkbox"/> NAD27 <input type="checkbox"/> Other	
NEAREST KENTUCKY City <small>Wallins Creek</small> County <small>Harlan</small>		NEAREST KENTUCKY PUBLIC USE OR MILITARY AIRPORT Tucker-Guthrie Memorial			
SITE ELEVATION (AMSL, feet) 1537		TOTAL STRUCTURE HEIGHT (AGL, feet) 270		CURRENT (FAA aeronautical study #) 2018-ASO-13610-OE	
OVERALL HEIGHT (site elevation plus total structure height, feet) 1807				PREVIOUS (FAA aeronautical study #)	
DISTANCE (from nearest Kentucky public use or Military airport to structure) 4.36 NM				PREVIOUS (KY aeronautical study #)	
DIRECTION (from nearest Kentucky public use or Military airport to structure) Southwest					
DESCRIPTION OF LOCATION (Attach USGS 7.5 minute quadrangle map or an airport layout drawing with the precise site marked and any certified survey.) 1A and Quad attached					
DESCRIPTION OF PROPOSAL AT&T proposes to construct a 255' cell tower with a 15' lightning rod for an overall height of 270'.					
FAA Form 7460-1 (Has the "Notice of Construction or Alteration" been filed with the Federal Aviation Administration?) <input type="checkbox"/> No <input checked="" type="checkbox"/> Yes, when? 6/26/2018					
CERTIFICATION (I hereby certify that all the above entries, made by me, are true, complete, and correct to the best of my knowledge and belief.)					
PENALTIES (Persons failing to comply with KRS 183.861 to 183.990 and 602 KAR 050 are liable for fines and/or imprisonment as set forth in KRS 183.990(3). Noncompliance with FAA regulations may result in further penalties.)					
NAME Michelle Ward	TITLE Sr. Real Estate Mgr.	SIGNATURE 		DATE 9/26/2018	
COMMISSION ACTION <input type="checkbox"/> Approved <input type="checkbox"/> Disapproved		<input type="checkbox"/> Chairperson, KAZC <input type="checkbox"/> Administrator, KAZC			
SIGNATURE		DATE			

EXHIBIT G
GEOTECHNICAL REPORT



July 27, 2018

Ms. Michelle Ward
AT&T
534 Armory Place
4th Floor
Louisville, KY 40202

Subject: Geotechnical Investigation

Site Name: WALLINS CREEK

Site Address: County Road 1248A8, aka Camp Creek Rd, Wallins Creek, KY 40873, Harlan County

Coordinates: N36° 48' 02.36", W83° 24' 43.64"

POD Project No. 18-21590

Dear Ms. Ward:

Power of Design (POD) was authorized in July 2018 to complete the Geotechnical Investigation for the subject Property. We utilized the survey of the subject Property dated May 14, 2018. The Property is located in a wooded area south of CR 1248A8. The Property includes a proposed 100-foot by 100-foot lease area located in a wooded area and a proposed approximate 1790-foot long by 30-foot wide access/utility easement. The proposed easement would extend in a south/southwesterly direction off CR 1248A8 until reaching the proposed lease area.

Due to existing steep terrain along the proposed access/utility easement, it would not be possible for a geotechnical drill rig to access the center of the lease area. In order to complete the requested Geotechnical Investigation, tree clearing, and considerable grading activities would be necessary.

We appreciate the opportunity to be of service to you on this project. If you have any questions regarding this letter, please contact our office.

Cordially,

A handwritten signature in blue ink that reads "Mark Patterson".

Mark Patterson, P.E.
Project Engineer
License No.: KY 16300





Preliminary Geotechnical Investigation

Site Name: WALLINS CREEK

Site Address: County Road 1248A8,
aka Camp Creek Rd
Wallins Creek, KY 40873
Harlan County

Coordinates: N36° 48' 02.36"
W83° 24' 43.64"

POD Project No. 18-21590



SUBMITTED TO:

Ms. Michelle Ward
AT&T
534 Armory Place
4th Floor
Louisville, KY 40202

PREPARED BY:

Power of Design
11490 Bluegrass Parkway
Louisville, KY 40299



July 27, 2018

Ms. Michelle Ward
AT&T
534 Armory Place
4th Floor
Louisville, KY 40202

Re: Subject: **Preliminary Geotechnical Investigation**
Site Name: WALLINS CREEK
Site Address: County Road 1248A8, aka Camp Creek Rd
Wallins Creek, KY 40873
Harlan County
Coordinates: N36° 48' 02.36", W83° 24' 43.64"
POD Project No. 18-21590

Dear Ms. Ward:

Power of Design (POD) is pleased to submit this report of our Preliminary Geotechnical Investigation for the proposed project. Our services were provided as authorized electronically on July 25, 2018.

This report presents a review of the information provided to us, a description of the site and subsurface conditions, and our recommendations. The appendices contain a USGS Topographic Map and USDA Web Soil Survey map and Soil Descriptions for mapped soil types.

Purpose and Scope of Work

The purpose of this effort was to evaluate the likely site conditions so that preliminary foundation design plans can be prepared. No soil borings or testing has been conducted for this report. A final Geotechnical Investigation including borings should be conducted for the proposed tower.

Project Information

POD provided a survey dated 5/14/18 of the Property. The Property is located on a steep wooded hillside south of CR 1248A8. We understand that plans call for a new 250-foot tall self-supporting lattice tower on the site, approximately as shown on Figure 1.



Estimated Site and Subsurface Conditions

The topography leading up to the proposed compound very steep. The elevation at the proposed tower location is about 1,537 feet AMSL. Based on a site visit of the area, exposed weathered rock and soil with rock lens was observed.

The soil survey shows the Cloverlick-Guyandotte-Highsplant Complex (CgF) soil type for the proposed tower location. A Description of this soil type is attached. In summary, the general soil profile description includes Channery Loam to very Cahnnerly Loam at depths from about 0.5 to 7 feet. Most of the upper rock at these depths could be described as "rippable".

Recommendations

Based on the anticipated rocky soil and relatively shallow bedrock, the tower will likely be supported on a shallow mat (pad and pier) foundation system. Groundwater will not likely be encountered in foundation excavations. Assuming partially weathered rock at the tower foundation bearing level, a nominal bearing pressure of about 5 kips per square foot is likely appropriate.

We appreciate the opportunity to be of service.

Cordially,

A handwritten signature in blue ink that reads "Mark Patterson".

Mark Patterson, P.E.
Project Engineer
License No.: KY 16300




Appendix A Figure 1 - Topographic Map and Site Survey
Appendix B Soil Survey and Soil Descriptions




APPENDIX A

Topographic Map and Site Survey

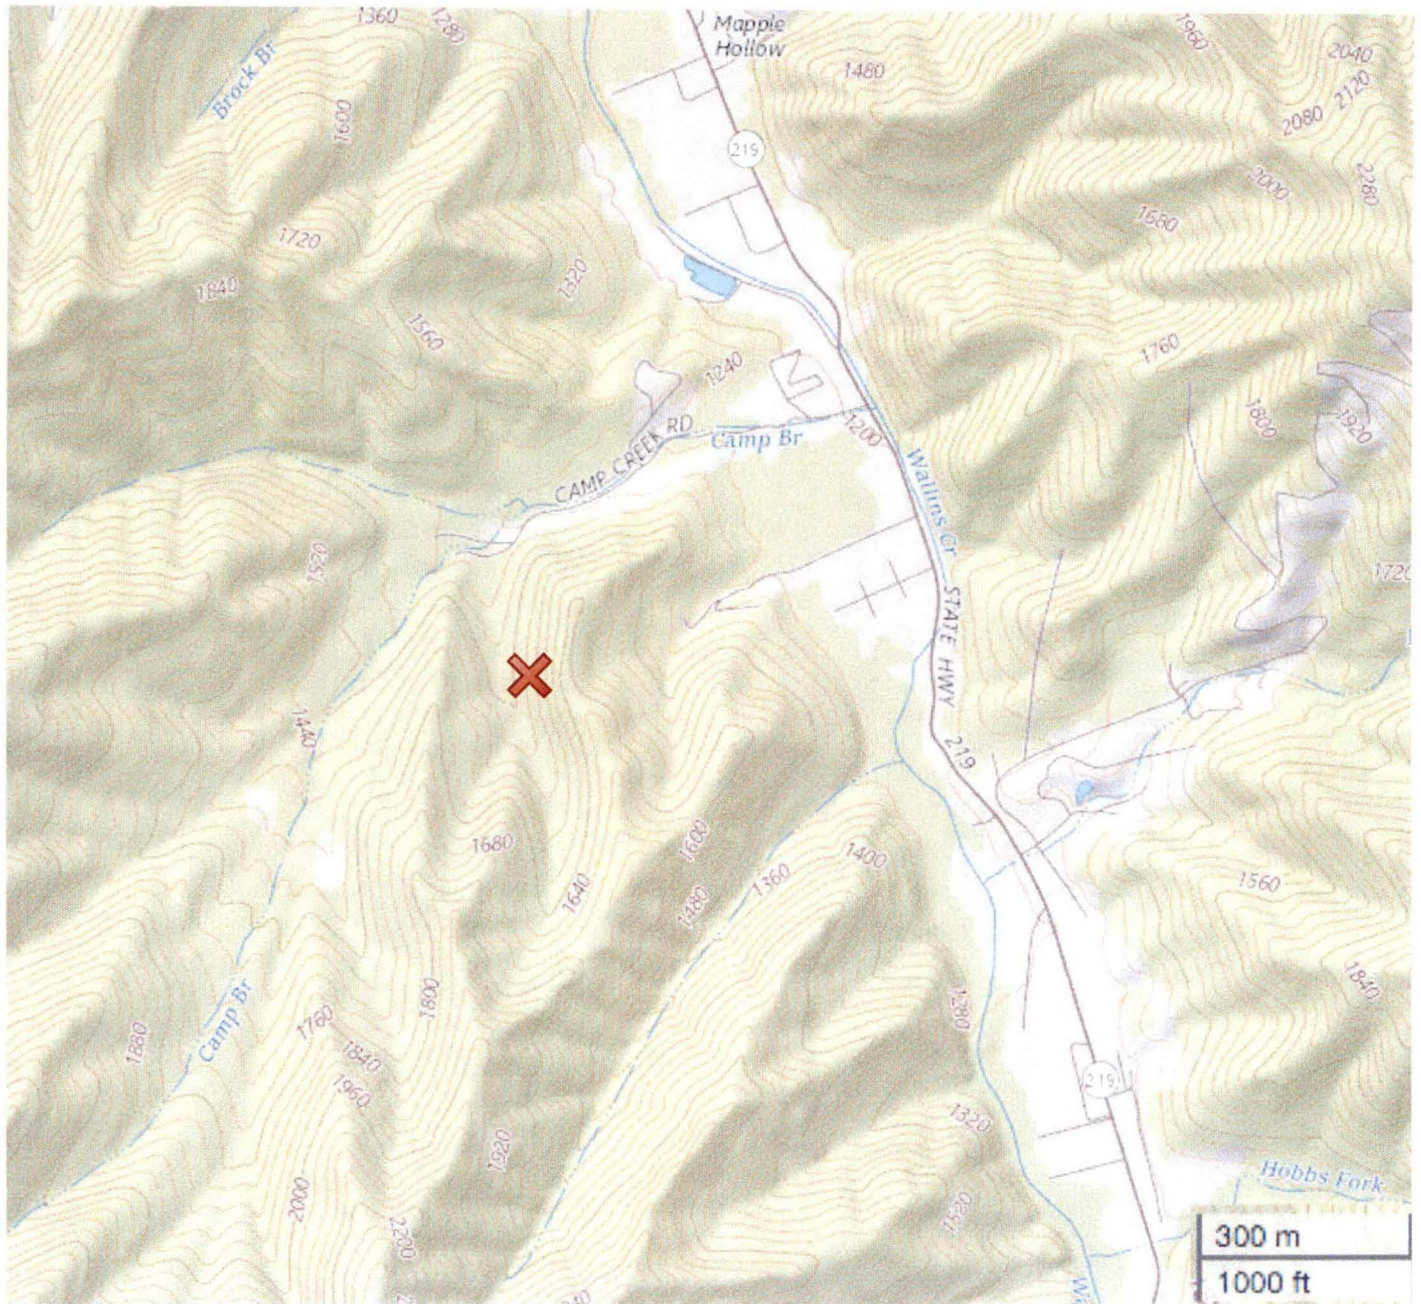

Source: U.S. Geological Survey, 20160401, USGS US Topo 7.5-minute map for Wallins Creek, KY 2016: USGS - National Geospatial Technical Operations Center (NGTOC).

X = Proposed Site

	<p>Site Name: WALLINS CREEK</p> <p>Site Address: County Road 1248A8, aka Camp Creek Rd Wallins Creek, KY 40873 Harlan County</p> <p>Coordinates: N36° 48' 02.36" W83° 24' 43.64"</p>	<p>Figure 1:</p> <p>Site Location Plan</p>
---	---	--

FAA COORDINATE POINT
 NAD 83
 LATITUDE: 36°48'02.36"
 LONGITUDE: 83°24'43.64"
 NAVD 88
 ELEVATION: 1537'± AMSL
 NORTHING: 3459574.852
 EASTING: 5605746.887

TEMPORARY BENCHMARK
 NORTHING: 3459678.899
 EASTING: 5605712.273
 ELEVATION: 1539.29'
 LOCATION: A 600 NAIL
 NORTHWEST CORNER OF THE
 PROPOSED LEASE AREA.

GLOBAL POSITIONING SYSTEMS NOTE

1. THE BOUNDARY CORNERS AND A PORTION OF THE TOPOGRAPHY WAS LOCATED USING GPS.
2. THE TYPE OF GPS UTILIZED WAS NETWORK ADJUSTED REAL TIME KINEMATIC (KDOT VRS NETWORK). NAD 83 KENTUCKY SINGLE ZONE WITH THE ORTHOMETRIC HEIGHT COMPUTED USING GEOID12A. RELATIVE POSITIONAL ACCURACY VARIED FROM 0.04' TO 0.09' HORIZONTALLY.
3. SPECTRA PRECISION EPOCH 50 DUAL FREQUENCY RECEIVERS WERE USED TO PERFORM THE SURVEY.

GENERAL NOTES

NO SEARCH OF PUBLIC RECORDS HAS BEEN COMPLETED BY POD GROUP TO DETERMINE ANY DEFECTS AND/OR AMBIGUITIES IN THE TITLE OF THE SUBJECT PROPERTY.

THIS SURVEY IS FOR THE PROPOSED LEASE AREA AND THE PROPOSED ACCESS & UTILITY EASEMENTS ONLY, AND ONLY A PARTIAL BOUNDARY SURVEY OF THE PARENT TRACT HAS BEEN PERFORMED.

A PORTION OF THIS SURVEY WAS CONDUCTED BY METHOD OF RANDOM TRAVERSE WITH SIDE SHOTS. UNADJUSTED CLOSURE EQUALS 0.09'; FOR A PRECISION OF 1:48,144 AND HAS NOT BEEN ADJUSTED.

THIS PROPERTY IS SUBJECT TO ANY RECORDED EASEMENTS AND/OR RIGHTS OF WAY SHOWN HEREON OR NOT.

THIS PLAT IS NOT INTENDED FOR LAND TRANSFER.

THE PARENT PARCEL, THE PROPOSED LEASE AREA, AND THE PROPOSED ACCESS & UTILITY EASEMENT SHOWN HEREON ARE NOT LOCATED IN A 100-YEAR FLOOD PLAIN (ZONE X) PER FLOOD HAZARD BOUNDARY MAP, COMMUNITY-PANEL NUMBER 21095C0270E, DATED MARCH 16, 2015.

LEGEND

UTILITY POLE
 P.O.B. POINT OF BEGINNING
 SPC STATE PLANE COORDINATE
 EX. OVERHEAD ELECTRIC & TELEPHONE
 EX. FENCE LINE
 SET 1/2" REBAR 18" LONG
 CAPPED "PATTERSON PLS 3136"
 PROPERTY LINE
 ADJACENT PROPERTY LINE


LAND SURVEYOR'S CERTIFICATE

I, MARK E. PATTERSON, HEREBY CERTIFY THAT I AM A LICENSED PROFESSIONAL LAND SURVEYOR LICENSED IN COMPLIANCE WITH THE LAWS OF THE COMMONWEALTH OF KENTUCKY. I FURTHER CERTIFY THAT THIS PLAT AND THE SURVEY ON THE GROUND WERE PERFORMED BY PERSONS UNDER MY DIRECT SUPERVISION, AND THAT THE DIRECTIONAL AND LINEAR MEASUREMENTS BEING WITNESSED BY MONUMENTS SHOWN HEREON ARE TRUE AND CORRECT TO THE BEST OF MY KNOWLEDGE. THE "RURAL" SURVEY, AND THE PLAT ON WHICH IT IS BASED, MEETS ALL SPECIFICATIONS AS STATED IN KAR 201 18-150.

Mark Patterson
 MARK PATTERSON, PLS #3136

5/14/2018

DATE

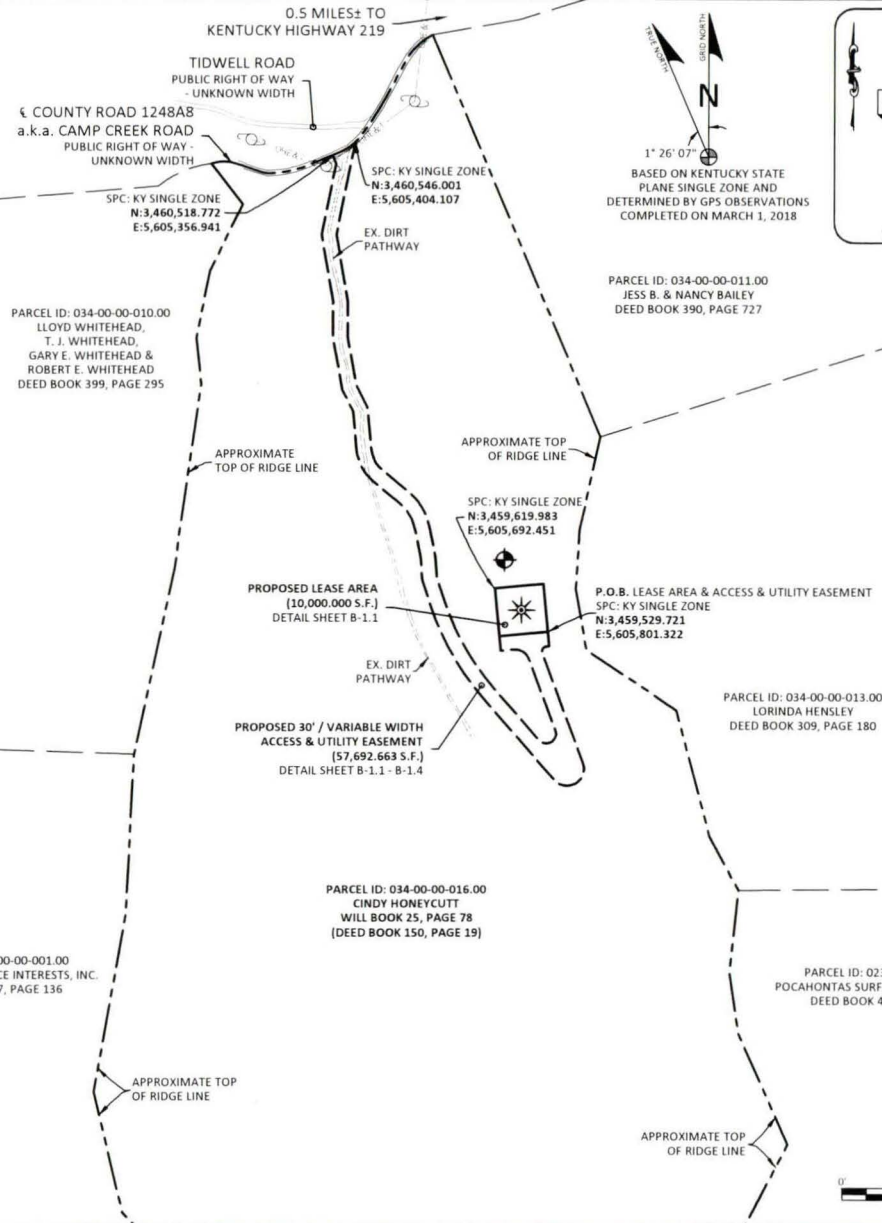

PARCEL ID: 034-00-00-011.00
JESS B. & NANCY BAILEY
DEED BOOK 390, PAGE 727

PARCEL ID: 034-00-00-013.00
LORINDA HENSLEY
DEED BOOK 309, PAGE 180

PARCEL ID: 023-00-00-001.00
POCAHONTAS SURFACE INTERESTS, INC.
DEED BOOK 467, PAGE 136



0' 250' 500'
 1 INCH = 250 FEET



PREPARED FOR:
MasTec

PREPARED FOR:
 at&t

SITE SURVEY

REV	DATE	DESCRIPTION
A	4.11.18	PRELIM ISSUE WITH TITLE
B	5.2.18	REVISED ACCESS & UTILITY EASEMENT
C	5.4.18	CLIENT COMMENTS
D	5.14.18	ISSUED AS FINAL

SITE INFORMATION:

WALLINS CREEK
 COUNTY ROAD 1248A8
 a.k.a. CAMP CREEK ROAD
 WALLINS CREEK, KY 40873
 HARLAN COUNTY
 TAX PARCEL NUMBER:
 034-00-00-016.00
 TAX PARCEL ADDRESS:
 0 HENSLEY HOLLOW - WALLINS CREEK, KY 40873
 PROPERTY OWNER:
 CINDY HONEYCUTT
 P. O. BOX 356
 WHITESBURG, KY 41858
 SOURCE OF TITLE:
 WILL BOOK 25, PAGE 78
 (DEED BOOK 150, PAGE 19)

SITE NUMBER:

POD NUMBER: 18-21589
 DRAWN BY: DAP
 CHECKED BY: MEP
 SURVEY DATE: 3.1.18
 PLAT DATE: 4.2.18

SHEET TITLE:

SITE SURVEY
 THIS DOES NOT REPRESENT A
 BOUNDARY SURVEY OF THE
 PARENT PARCEL

SHEET NUMBER: (5 pages)

B-1

GLOBAL POSITIONING SYSTEMS NOTE

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2. THE TYPE OF GPS UTILIZED WAS NETWORK ADJUSTED REAL TIME KINEMATIC (KDOT VRS NETWORK). NAD 83 KENTUCKY SINGLE ZONE WITH THE ORTHOMETRIC HEIGHT COMPUTED USING GEOID12A. RELATIVE POSITIONAL ACCURACY VARIED FROM 0.04" TO 0.09" HORIZONTALLY.
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LEGEND

P.O.B. POINT OF BEGINNING

SPC STATE PLANE COORDINATE

x 1500' EX. GROUND ELEVATION

— x — EX. FENCE LINE

— SET 1/2" REBAR 18" LONG
CAPPED "PATTERSON PLS 3136"

— PROPERTY LINE

— ADJACENT PROPERTY LINE

0' 60' 120'
1 INCH = 60 FEET

LAND SURVEYOR'S CERTIFICATE

I, MARK E. PATTERSON, HEREBY CERTIFY THAT I AM A LICENSED PROFESSIONAL LAND SURVEYOR LICENSED IN COMPLIANCE WITH THE LAWS OF THE COMMONWEALTH OF KENTUCKY. I FURTHER CERTIFY THAT THIS PLAT AND THE SURVEY ON THE GROUND WERE PERFORMED BY PERSONS UNDER MY DIRECT SUPERVISION, AND THAT THE DIRECTIONAL AND LINEAR MEASUREMENTS BEING WITNESSED BY MONUMENTS SHOWN HEREON ARE TRUE AND CORRECT TO THE BEST OF MY KNOWLEDGE. THE "RURAL" SURVEY, AND THE PLAT ON WHICH IT IS BASED, MEETS ALL SPECIFICATIONS AS STATED IN KAR 201 18:150.

Mark Patterson
MARK PATTERSON, PLS #3136

5/14/2018

DATE



SHEET B-1.2
MATCH LINE

SPC: KY SINGLE ZONE
N:3,459,619.983
E:5,605,692.451

PROPOSED
LEASE AREA
(10,000.000 S.F.)

S29°16'22"E
CH=212.87'
R=535.00'

N29°16'22"W
CH=224.80'
R=565.00'

S84°39'40"W
CH=39.37'
R=20.00'

S84°39'40"E
CH=39.37'
R=20.00'

S84°39'40"W
CH=39.37'
R=20.00'

S84°39'40"E
CH=39.37'
R=20.00'

S84°39'40"W
CH=39.37'
R=20.00'

S84°39'40"E
CH=39.37'
R=20.00'

S84°39'40"W
CH=39.37'
R=20.00'

S84°39'40"E
CH=39.37'
R=20.00'

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R=20.00'

S84°39'40"E
CH=39.37'
R=20.00'

S84°39'40"W
CH=39.37'
R=20.00'

PARCEL ID:
034-00-00-013.00
LORINDA HENSLEY
DEED BOOK 309, PAGE 180

1" = 26' 07"
BASED ON KENTUCKY STATE
PLANE SINGLE ZONE AND
DETERMINED BY GPS OBSERVATIONS
COMPLETED ON MARCH 1, 2018

FAA COORDINATE POINT

NAD 83
LATITUDE: 36°48'02.36"
LONGITUDE: 83°24'43.64"
NAVD 88
ELEVATION: 1537'± AMSL
NORTHING: 3459574.852
EASTING: 5605746.887

TEMPORARY BENCHMARK

NORTHING: 3459678.899
EASTING: 5605712.273
ELEVATION: 1539.29'
LOCATION: A 60D NAIL
N18°36'E 62.2± FROM THE
NORTHWEST CORNER OF THE
PROPOSED LEASE AREA.

PREPARED BY:



PREPARED FOR:



PREPARED FOR:



SITE SURVEY

REV.	DATE	DESCRIPTION
A	4.11.18	PRELIM ISSUE WITH TITLE
B	5.2.18	REVISED ACCESS & UTILITY EASEMENT
C	5.4.18	CLIENT COMMENTS
D	5.14.18	ISSUED AS FINAL

SITE INFORMATION:

WALLINS CREEK
COUNTY ROAD 1248AB
a.k.a. CAMP CREEK ROAD
WALLINS CREEK, KY 40873
HARLAN COUNTY

TAX PARCEL NUMBER:
034-00-00-016.00

TAX PARCEL ADDRESS:
O HENSLEY HOLLOW - WALLINS O
WALLINS CREEK, KY 40873

PROPERTY OWNER:
CINDY HONEYCUTT
P.O. BOX 356
WHITESBURG, KY 41858

SOURCE OF TITLE:
WILL BOOK 25, PAGE 78
(DEED BOOK 150, PAGE 19)

SITE NUMBER:

POD NUMBER:	18-21589
DRAWN BY:	DAP
CHECKED BY:	MEP
SURVEY DATE:	3.1.18
PLAT DATE:	4.2.18

SHEET TITLE:

SITE SURVEY
THIS DOES NOT REPRESENT A
BOUNDARY SURVEY OF THE
PARENT PARCEL

SHEET NUMBER: (5 pages)

B-1.1



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KENTUCKY.TOLERANCEACT.COM

GLOBAL POSITIONING SYSTEMS NOTE

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2. THE TYPE OF GPS UTILIZED WAS NETWORK ADJUSTED REAL TIME KINEMATIC (KDOT VRS NETWORK), NAD 83 KENTUCKY SINGLE ZONE WITH THE ORTHOMETRIC HEIGHT COMPUTED USING GEOID12A. RELATIVE POSITIONAL ACCURACY VARIED FROM 0.04' TO 0.09' HORIZONTALLY.
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LEGEND

P.O.B. POINT OF BEGINNING

SPC STATE PLANE COORDINATE

× 1500' EX. GROUND ELEVATION

— X — X — X — EX. FENCE LINE
 — SET 1/2" REBAR 18" LONG CAPPED "PATTERSON PLS 3136" —
 — — — — — PROPERTY LINE
 — — — — — ADJACENT PROPERTY LINE



LAND SURVEYOR'S CERTIFICATE

I, MARK E. PATTERSON, HEREBY CERTIFY THAT I AM A LICENSED PROFESSIONAL LAND SURVEYOR LICENSED IN COMPLIANCE WITH THE LAWS OF THE COMMONWEALTH OF KENTUCKY. I FURTHER CERTIFY THAT THIS PLAT AND THE SURVEY ON THE GROUND WERE PERFORMED BY PERSONS UNDER MY DIRECT SUPERVISION, AND THAT THE DIRECTIONAL AND LINEAR MEASUREMENTS BEING WITNESSED BY MONUMENTS SHOWN HEREON ARE TRUE AND CORRECT TO THE BEST OF MY KNOWLEDGE, THE "RURAL" SURVEY, AND THE PLAT ON WHICH IT IS BASED, MEETS ALL SPECIFICATIONS AS STATED IN KAR 201 18:150.



Mark Patterson 5/14/2018
 MARK PATTERSON, PLS #3136 DATE

SHEET B-1.3
 MATCH LINE

PARCEL ID: 034-00-00-016.00
 CINDY HONEYCUTT
 WILL BOOK 25, PAGE 78
 (DEED BOOK 150, PAGE 19)

1" 26' 07"
 BASED ON KENTUCKY STATE
 PLANE SINGLE ZONE AND
 DETERMINED BY GPS OBSERVATIONS
 COMPLETED ON MARCH 1, 2018

✳️ FAA COORDINATE POINT
 NAD 83
 LATITUDE: 36°48'02.36"
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 NAVD 88
 ELEVATION: 1537± AMSL
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 EASTING: 5605746.887

⬮ TEMPORARY BENCHMARK
 NORTHING: 3459678.899
 EASTING: 5605712.273
 ELEVATION: 1539.29'
 LOCATION: A 60D NAIL
 N18°36'E 62.2'± FROM THE
 NORTHWEST CORNER OF THE
 PROPOSED LEASE AREA.

PARCEL ID: 034-00-00-011.00
 JESS B. & NANCY BAILEY
 DEED BOOK 390, PAGE 727

APPROXIMATE
 TOP OF RIDGE LINE



MATCH LINE
 SHEET B-1.1

SPC: KY SINGLE ZONE
 N:3,459,619.983
 E:5,605,692.451
 PROPOSED LEASE AREA
 (10,000,000 S.F.)

PARCEL ID:
 034-00-00-013.00
 LORINDA HENSLEY
 DEED BOOK 309, PAGE 180



PREPARED FOR:
MasTec

PREPARED FOR:
 at&t

SITE SURVEY

REV.	DATE	DESCRIPTION
A	4.11.18	PRELIM ISSUE WITH TITLE
B	5.2.18	REVISED ACCESS & UTILITY EASEMENT
C	5.4.18	CLIENT COMMENTS
D	5.14.18	ISSUED AS FINAL

SITE INFORMATION:
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 COUNTY ROAD 1248A8
 a.k.a. CAMP CREEK ROAD
 WALLINS CREEK, KY 40873
 HARLAN COUNTY


TAX PARCEL NUMBER:
 034-00-00-016.00
 TAX PARCEL ADDRESS:
 O HENSLEY HOLLOW - WALLINS O
 WALLINS CREEK, KY 40873
 PROPERTY OWNER:
 CINDY HONEYCUTT
 P.O. BOX 356
 WHITESBURG, KY 41858
 SOURCE OF TITLE:
 WILL BOOK 25, PAGE 78
 (DEED BOOK 150, PAGE 19)

SITE NUMBER:

POD NUMBER: 18-21589
 DRAWN BY: DAP
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 SURVEY DATE: 3.1.18
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SHEET TITLE:
SITE SURVEY
 THIS DOES NOT REPRESENT A
 BOUNDARY SURVEY OF THE
 PARENT PARCEL

SHEET NUMBER: (5 pages)
B-1.2

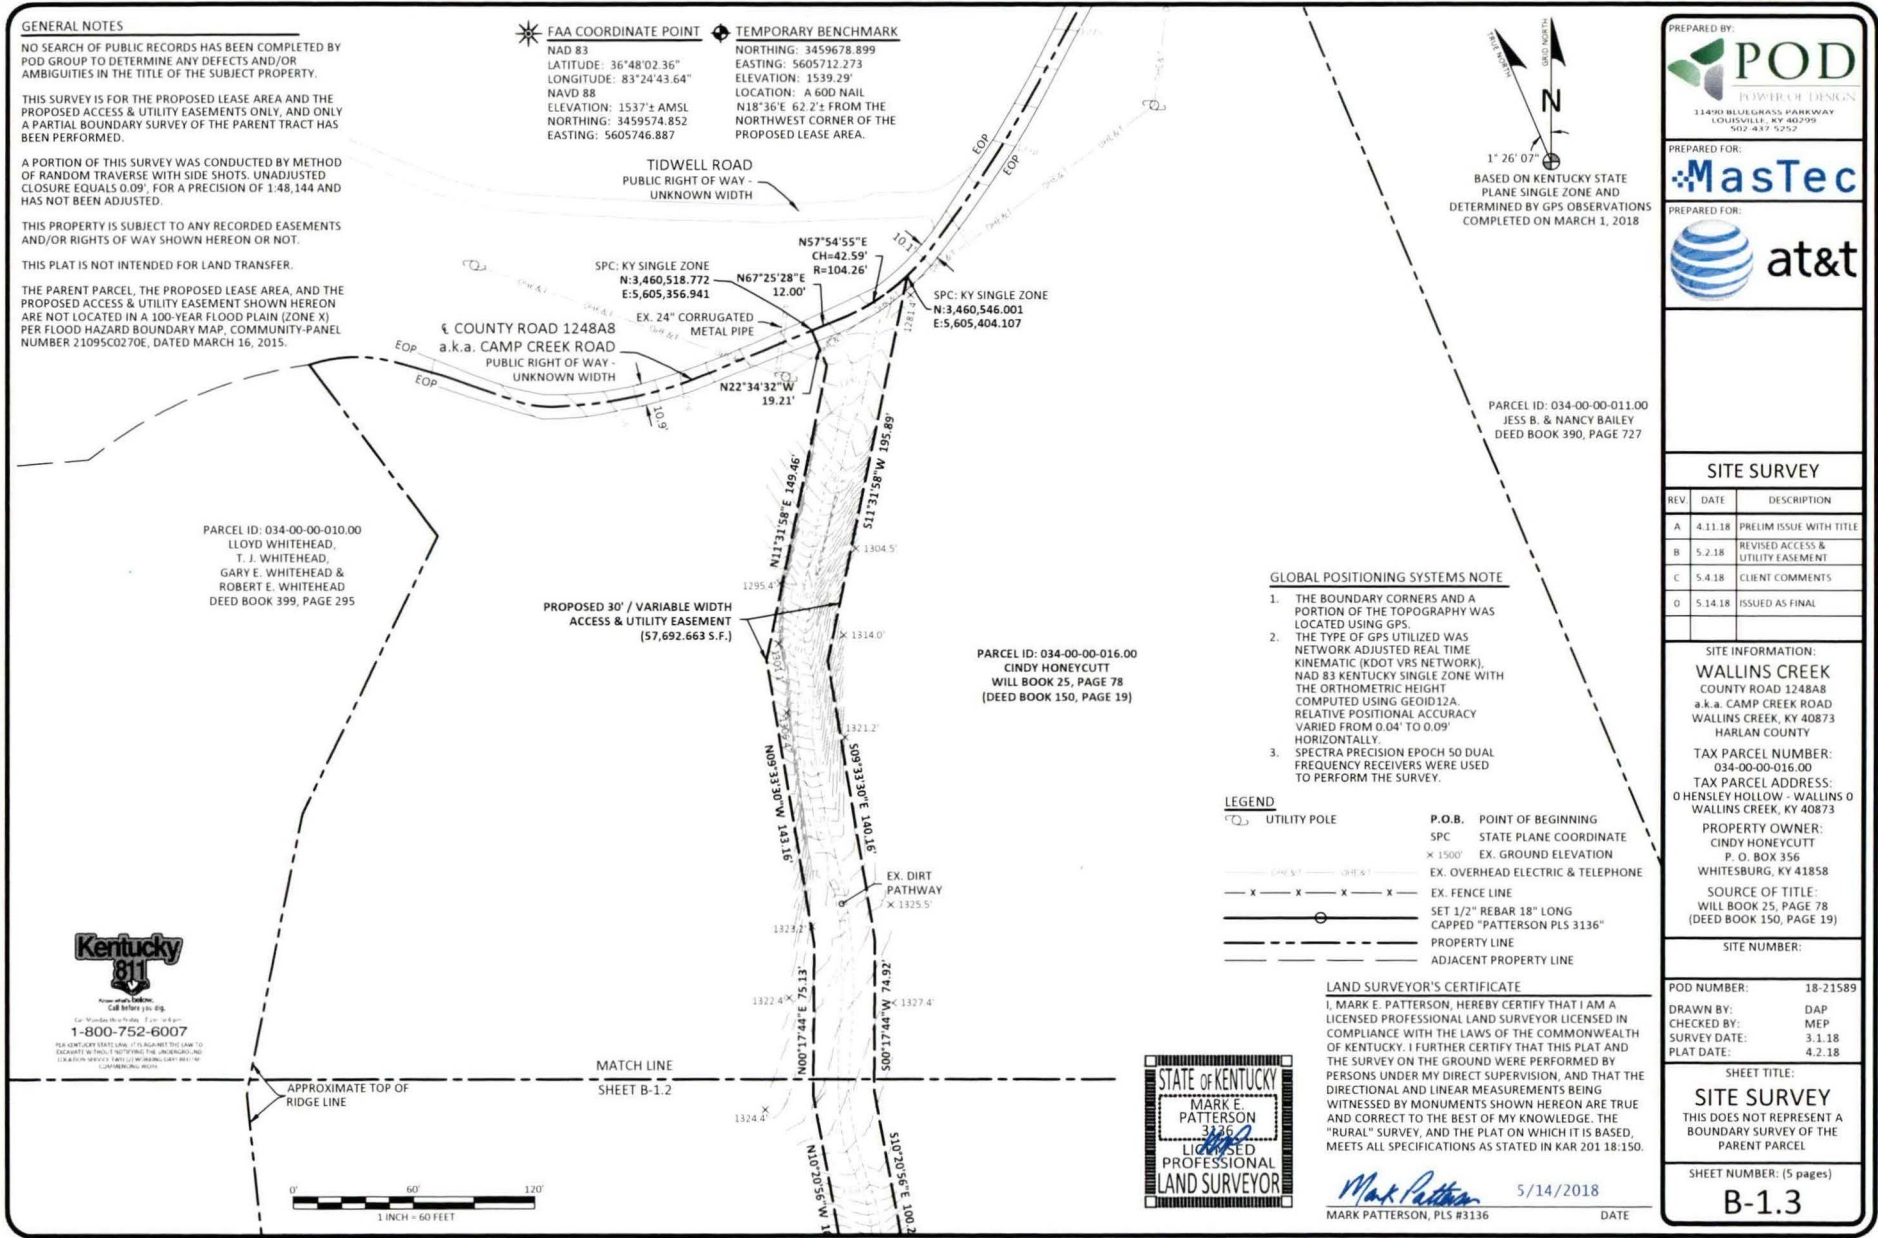

LEGAL DESCRIPTIONS

PROPOSED LEASE AREA

THE FOLLOWING IS A DESCRIPTION OF THE PROPOSED LEASE AREA TO BE LEASED FROM THE PROPERTY CONVEYED TO CINDY HONEYCUTT AS RECORDED IN THE OFFICE OF THE CLERK OF HARLAN COUNTY, KENTUCKY AS WILL BOOK 25, PAGE 78, BEING THE SAME PROPERTY CONVEYED TO HAGAN & WILMA HONEYCUTT AS DESCRIBED IN DEED BOOK 150, PAGE 19, PARCEL ID: 034-00-00-016.00, WHICH IS MORE PARTICULARLY DESCRIBED AS FOLLOWS:

BEARING DATUM USED HEREIN IS BASED UPON KENTUCKY STATE PLANE COORDINATE SYSTEM, SINGLE ZONE, NAD 83, FROM A REAL TIME KINEMATIC GLOBAL POSITIONING SYSTEM OBSERVATION USING THE KENTUCKY TRANSPORTATION CABINET REAL TIME GPS NETWORK COMPLETED ON MARCH 1, 2018.

BEGINNING TO A SET 1/2" REBAR, 18" LONG, CAPPED "PATTERSON PLS #3136", HEREAFTER REFERRED TO AS A "SET IPC" AT THE SOUTHEAST CORNER OF THE PROPOSED LEASE AREA WITH A STATE PLANE COORDINATE, KENTUCKY SINGLE ZONE VALUE OF N 3,459,529.721 & E 5,605,801.322, ON THE PROPERTY CONVEYED TO CINDY HONEYCUTT AS RECORDED IN THE OFFICE OF THE CLERK OF HARLAN COUNTY, KENTUCKY AS WILL BOOK 25, PAGE 78, BEING THE SAME PROPERTY CONVEYED TO HAGAN & WILMA HONEYCUTT AS DESCRIBED IN DEED BOOK 150, PAGE 19, PARCEL ID: 034-00-00-016.00; THENCE S84°39'40"W 100.00' TO A SET IPC; THENCE N05°20'20"W 100.00' TO A SET IPC, WITH A STATE PLANE COORDINATE, KENTUCKY SINGLE ZONE VALUE OF N 3,459,619.983 & E 5,605,692.451 IN THE NORTHWEST CORNER OF SAID LEASE AREA; THENCE N84°39'40"W 100.00' TO A SET IPC; THENCE S05°20'20"E 100.00' TO THE POINT OF BEGINNING CONTAINING 10,000.000 SQUARE FEET AS PER SURVEY BY MARK E. PATTERSON, PLS #3136 DATED MARCH 1, 2018.

PROPOSED 30' VARIABLE WIDTH ACCESS & UTILITY EASEMENT

THE FOLLOWING IS A DESCRIPTION OF THE PROPOSED 30' VARIABLE WIDTH ACCESS & UTILITY EASEMENT TO BE GRANTED FROM THE PROPERTY CONVEYED TO CINDY HONEYCUTT AS RECORDED IN THE OFFICE OF THE CLERK OF HARLAN COUNTY, KENTUCKY AS WILL BOOK 25, PAGE 78, BEING THE SAME PROPERTY CONVEYED TO HAGAN & WILMA HONEYCUTT AS DESCRIBED IN DEED BOOK 150, PAGE 19, PARCEL ID: 034-00-00-016.00, WHICH IS MORE PARTICULARLY DESCRIBED AS FOLLOWS:

BEARING DATUM USED HEREIN IS BASED UPON KENTUCKY STATE PLANE COORDINATE SYSTEM, SINGLE ZONE, NAD 83, FROM A REAL TIME KINEMATIC GLOBAL POSITIONING SYSTEM OBSERVATION USING THE KENTUCKY TRANSPORTATION CABINET REAL TIME GPS NETWORK COMPLETED ON MARCH 1, 2018.

BEGINNING TO A SET 1/2" REBAR, 18" LONG, CAPPED "PATTERSON PLS #3136", HEREAFTER REFERRED TO AS A "SET IPC" AT THE SOUTHEAST CORNER OF THE PROPOSED LEASE AREA WITH A STATE PLANE COORDINATE, KENTUCKY SINGLE ZONE VALUE OF N 3,459,529.721 & E 5,605,801.322, ON THE PROPERTY CONVEYED TO CINDY HONEYCUTT AS RECORDED IN THE OFFICE OF THE CLERK OF HARLAN COUNTY, KENTUCKY AS WILL BOOK 25, PAGE 78, BEING THE SAME PROPERTY CONVEYED TO HAGAN & WILMA HONEYCUTT AS DESCRIBED IN DEED BOOK 150, PAGE 19, PARCEL ID: 034-00-00-016.00; THENCE LEAVING SAID LEASE AREA, S05°20'20"E 30.00'; THENCE S84°39'40"W 5.80'; THENCE WITH THE CHORD OF A CURVE TO THE LEFT HAVING A RADIUS OF 10.00', S32°10'15"W 15.87'; THENCE S20°19'10"E 243.11'; THENCE WITH THE CHORD OF A CURVE TO THE RIGHT HAVING A RADIUS OF 35.00', S59°27'58"W 68.89'; THENCE N40°44'52"W 224.28'; THENCE WITH THE CHORD OF A CURVE TO THE RIGHT HAVING A RADIUS OF 565.00', N29°16'22"W 224.80'; THENCE N17°47'52"W 51.09'; THENCE N04°27'33"W 47.37'; THENCE N11°37'35"W 60.41'; THENCE WITH THE CHORD OF A CURVE TO THE LEFT HAVING A RADIUS OF 91.00', N30°47'09"W 59.73'; THENCE N49°56'42"W 71.23'; THENCE WITH THE CHORD OF A CURVE TO THE RIGHT HAVING A RADIUS OF 101.00', N27°34'11"W 76.90'; THENCE N05°11'39"W 79.25'; THENCE N26°32'01"W 49.76'; THENCE N10°20'56"W 107.33'; THENCE N00°17'44"E 75.13'; THENCE N09°33'30"W 141.16'; THENCE N11°31'58"E 149.46'; THENCE N27°34'32"W 19.21' TO THE CENTER OF COUNTY ROAD 1248AB (A.K.A. CAMP CREEK ROAD) HAVING A STATE PLANE COORDINATE, KENTUCKY SINGLE ZONE VALUE OF N 3,460,518.772 & E 5,605,356.941; THENCE WITH THE CENTER OF SAID ROAD, N67°25'28"E 12.00'; THENCE WITH THE CHORD OF A CURVE TO THE LEFT HAVING A RADIUS OF 104.26', N57°54'55"E 42.59' HAVING A STATE PLANE COORDINATE, KENTUCKY SINGLE ZONE VALUE OF N 3,460,546.001 & E 5,605,404.107; THENCE LEAVING SAID CENTER OF ROAD AND TRaversing ACROSS THE PROPERTY OF HONEYCUTT, S11°31'58"W 195.89'; THENCE S09°33'30"E 140.16'; THENCE S00°17'44"W 74.92'; THENCE S10°20'56"E 100.27'; THENCE S26°32'01"E 51.14'; THENCE S05°11'39"E 84.91'; THENCE WITH THE CHORD OF A CURVE TO THE LEFT HAVING A RADIUS OF 71.00', S27°34'11"E 54.06'; THENCE S49°56'42"E 71.23'; THENCE WITH THE CHORD OF A CURVE TO THE RIGHT HAVING A RADIUS OF 121.00', S30°47'09"E 79.42'; THENCE S11°37'35"E 62.28'; THENCE S04°27'33"E 45.74'; THENCE S17°47'52"E 47.58'; THENCE WITH THE CHORD OF A CURVE TO THE LEFT HAVING A RADIUS OF 535.00', S29°16'22"E 212.87'; THENCE S40°44'52"E 141.03'; THENCE WITH THE CHORD OF A CURVE TO THE LEFT HAVING A RADIUS OF 20.00', N59°27'58"E 39.37'; THENCE N20°19'10"W 157.89'; THENCE WITH THE CHORD OF A CURVE TO THE LEFT HAVING A RADIUS OF 30.00', N57°49'45"W 36.53'; THENCE S84°39'40"W 27.09'; THENCE N05°20'20"W 30.00' TO A SET IPC IN THE SOUTHWEST CORNER OF SAID LEASE AREA; THENCE WITH SAID LEASE AREA, N84°39'40"E 100.00' TO THE POINT OF BEGINNING CONTAINING 57,692.663 SQUARE FEET AS PER SURVEY BY MARK E. PATTERSON, PLS #3136 DATED MARCH 1, 2018.

PARENT PARCEL, LEGAL DESCRIPTION, WILL BOOK 25, PAGE 78 (DEED BOOK 150, PAGE 19) (NOT FIELD SURVEYED)

BEGINNING AT TWO CHESTNUT OAKS ON THE POINT OF A RIDGE A CORNER TO JOHN R. BLANTON TRACT, OWNED BY KENTENIA CORPORATION, THENCE DOWN WITH THE MEANDERS OF THE RIDGE BETWEEN COAL HOLLOW AND LICK HOLLOW, N 29-30 E 39 FEET N 57-15 E 125.8 FEET, N 51-30 E 323.2 FEET, N 45-30 E 290 FEET TO A SOURWOOD N 34-00 E 311 FEET TO A CHESTNUT OAK AND SERVICE, N 29-00 E 311.2 FEET, N 27-30 E 208.2 FEET TO A SPOTTED OAK N 24-00 W 252.8 FEET, N 8-00 127 FEET N 6-00 E 170.2 FEET, N 28-00 127.4 FEET, N 14-50 W 268.8 FEET N 55-30 W 93.2 FEET, N 56-45 W 130.3 FEET, N 9-45 W 129.8 FEET, N 3-30 E 121.2 FEET TO A CHESTNUT, N 12-15 E 198.8 FEET TO TWO CHESTNUT OAKS AND SOURWOOD ON TOP OF THE RIDGE AT JANE BROCK'S LINE, THENCE WITH SAID LINE, LEAVING THE RIDGE, N 22-30 W 870 FEET TO A ROCK ON THE BANK OF CAMP CREEK, THENCE LEAVING THE LINES OF SAID BROCK AND WITH THE LINES OF S. R. BAILEY, UP SAID CREEK S 57-30 W 123 FEET, S 20-00 W 108.5 FEET TO A STAKE, BETWEEN SAID CREEK AND THE ROAD, S 87-00 W 221.2 FEET, N 85-30 W 160 FEET TO A STAKE AT THE FOOT OF A SPUR RIDGE, THENCE RUNNING UP THE SAME WITH ITS MEANDERS S 37-00 E 194, S 26-00 W 153.8 FEET TO A WHITE OAK, S 11-15 W 142 FEET, S 6-00 E 96.2 FEET TO A STAKE NEAR A LEANING WHITE OAK, S 8-20 W 295.7 FEET TO A STAKE BY A BEECH, S 7-15 W 85.6 FEET TO A STAKE CORNER OF J.R. BLANTON TRACT, THENCE LEAVE THE LINE OF SAID BAILEY TRACT AND WITH LINE OF BLANTON TRACT S 12-15 W 398 FEET, S 3-00 W 333.5 FEET S 1-15 W 371.5 FEET, S 13-15 E 256 FEET S 42-15 E 112.8 FEET, S 58-15 E 149 FEET TO A STAKE ON A HIGH POINT SOUTH 22.8 FEET, S 29-15 E 114 FEET, S 6-45 E 218.7 FEET, S 21-15 E 78.8 FEET, S 15-00 E 277.5 FEET TO THE BEGINNING, CONTAINING 70.9 ACRES MORE OR LESS.

REPORT OF TITLE (PARCEL 034-00-00-016.00) HARLAN COUNTY

THIS SURVEY DOES NOT CONSTITUTE A TITLE SEARCH BY POD GROUP, LLC, AND AS SUCH WE ARE NOT RESPONSIBLE FOR THE INVESTIGATION OR INDEPENDENT SEARCH FOR EASEMENTS OF RECORD, ENCUMBRANCES, RESTRICTIVE COVENANTS, OWNERSHIP TITLE EVIDENCE, UNRECORDED EASEMENTS, AUGMENTING EASEMENTS, IMPLIED OR PRESCRIPTIVE EASEMENTS, OR ANY OTHER FACTS THAT AN ACCURATE AND CURRENT TITLE SEARCH MAY DISCLOSE AND THIS SURVEY WAS COMPLETED WITH THE AID OF TITLE WORK PREPARED BY US TITLE SOLUTIONS, FOR THE BENEFIT OF MASTEC NETWORK SOLUTIONS, ON BEHALF OF AT&T, FILE NO. 58825-KY1711-5030, REFERENCE NO. FA13800700, ISSUE DATE OF DECEMBER 8, 2017. THE FOLLOWING COMMENTS ARE IN REGARD TO SAID REPORT.

SCHEDULE B

- TAXES, TAX LIENS, TAX SALES, WATER RATES, SEWER AND ASSESSMENTS SET FORTH IN SCHEDULE HEREIN. TAX ID 034-00-00-016.00 - PERIOD: 2017 - PAYMENT STATUS: PAID - TAX AMOUNT: \$61.00 (NOT A SURVEY MATTER, THEREFORE POD GROUP, LLC DID NOT EXAMINE OR ADDRESS THIS ITEM.)
- MORTGAGES RETURNED HEREIN, (-0-). SEE SEPARATE MORTGAGE SCHEDULE. NONE WITHIN PERIOD SEARCHED
- ANY STATE OF FACTS WHICH AN ACCURATE SURVEY MIGHT SHOW OR SURVEY EXCEPTIONS SET FORTH HEREIN. (POD GROUP, LLC DID NOT PERFORM A BOUNDARY SURVEY, THEREFORE WE DID NOT ADDRESS THIS ITEM.)
- RIGHTS OF TENANTS OR PERSON IN POSSESSION. (NOT A SURVEY MATTER, THEREFORE POD GROUP, LLC DID NOT EXAMINE OR ADDRESS THIS ITEM.)

(JUDGMENTS, LIENS AND UCC)

- NONE WITHIN PERIOD SEARCHED

(COVENANTS/RESTRICTIONS)

- NONE WITHIN PERIOD SEARCHED

(EASEMENTS AND RIGHTS OF WAY)

- NONE WITHIN PERIOD SEARCHED

(OTHER FILED DOCUMENTS)

- LEASE AGREEMENT BETWEEN HAGAN AND WILMA HONEYCUTT AND LINDA DAY DATED 6/5/1984 RECORDED 6/12/1984 IN BOOK 29 PAGE 369. (LEASE AS RECORDED IN BOOK 29, PAGE 369 IS FOR ALL OF THE COAL AND MINING RIGHTS, LEASE AFFECTS THE PARENT PARCEL, THE PROPOSED LEASE AREA AND THE PROPOSED ACCESS & UTILITY EASEMENT.)
- LEASE AGREEMENT BETWEEN HAGAN AND WILMA HONEYCUTT AND LINDA DAY DATED 6/5/1984 RECORDED 6/15/1984 IN BOOK 29 PAGE 385. (LEASE AS RECORDED IN BOOK 29, PAGE 385 IS FOR ALL OF THE COAL AND MINING RIGHTS, LEASE AFFECTS THE PARENT PARCEL, THE PROPOSED LEASE AREA AND THE PROPOSED ACCESS & UTILITY EASEMENT.)
- PROBATE ORDER BETWEEN THE ESTATE OF WILMA HONEYCUTT, DECEASED AND HAGAN H. HONEYCUTT DATED 7/23/1993 RECORDED 7/26/1993 IN BOOK 21 PAGE 100. (ORDER AS RECORDED IN BOOK 21, PAGE 100 AFFECTS THE PARENT PARCEL, LEAVING SAID REAL ESTATE TO HAGAN H. HONEYCUTT.)
- PROBATE ORDER BETWEEN LAST WILL AND TESTAMENT OF HAGAN HONEYCUTT, DECEASED AND CINDY HONEYCUTT DATED 3/20/1998 RECORDED 3/23/1998 IN BOOK 25 PAGE 78. (ORDER AS RECORDED IN BOOK 25, PAGE 78 AFFECTS THE PARENT PARCEL, LEAVING SAID REAL ESTATE TO CINDY HONEYCUTT.)

LAND SURVEYOR'S CERTIFICATE

I, MARK E. PATTERSON, HEREBY CERTIFY THAT I AM A LICENSED PROFESSIONAL LAND SURVEYOR LICENSED IN COMPLIANCE WITH THE LAWS OF THE COMMONWEALTH OF KENTUCKY. I FURTHER CERTIFY THAT THIS PLAT AND THE SURVEY ON THE GROUND WERE PERFORMED BY PERSONS UNDER MY DIRECT SUPERVISION, AND THAT THE DIRECTIONAL AND LINEAR MEASUREMENTS BEING WITNESSED BY MONUMENTS SHOWN HEREON ARE TRUE AND CORRECT TO THE BEST OF MY KNOWLEDGE. THE "RURAL" SURVEY, AND THE PLAT ON WHICH IT IS BASED, MEETS ALL SPECIFICATIONS AS STATED IN KAR 201.18.150.



Mark Patterson 5/14/2018
MARK PATTERSON, PLS #3136 DATE



SITE SURVEY

REV.	DATE	DESCRIPTION
A	4.11.18	PRELIM ISSUE WITH TITLE
B	5.2.18	REVISED ACCESS & UTILITY EASEMENT
C	5.4.18	CLIENT COMMENTS
D	5.14.18	ISSUED AS FINAL

SITE INFORMATION:

WALLINS CREEK
COUNTY ROAD 1248AB
a.k.a. CAMP CREEK ROAD
WALLINS CREEK, KY 40873
HARLAN COUNTY

TAX PARCEL NUMBER:
034-00-00-016.00
TAX PARCEL ADDRESS:
O HENSLEY HOLLOW - WALLINS O
WALLINS CREEK, KY 40873

PROPERTY OWNER:
CINDY HONEYCUTT
P. O. BOX 356
WHITESBURG, KY 41858

SOURCE OF TITLE:
WILL BOOK 25, PAGE 78
(DEED BOOK 150, PAGE 19)

SITE NUMBER:

POD NUMBER:	18-21589
DRAWN BY:	DAP
CHECKED BY:	MEP
SURVEY DATE:	3.1.18
PLAT DATE:	4.2.18

SHEET TITLE:

SITE SURVEY
THIS DOES NOT REPRESENT A
BOUNDARY SURVEY OF THE
PARENT PARCEL

SHEET NUMBER: (5 pages)

B-1.4



APPENDIX B

Soil Survey and Soil Descriptions

Soil Map—Bell and Harlan Counties, Kentucky



Natural Resources
Conservation Service


Web Soil Survey
National Cooperative Soil Survey

7/26/2018
Page 1 of 3

Soil Map—Bell and Harlan Counties, Kentucky

MAP LEGEND

Area of Interest (AOI)

 Area of Interest (AOI)

Soils

 Soil Map Unit Polygons

 Soil Map Unit Lines


 Soil Map Unit Points

Special Point Features

 Blowout

 Borrow Pit

 Clay Spot

 Closed Depression

 Gravel Pit

 Gravelly Spot

 Landfill

 Lava Flow

 Marsh or swamp


 Mine or Quarry

 Miscellaneous Water


 Perennial Water

 Rock Outcrop

 Saline Spot

 Sandy Spot

 Severely Eroded Spot

 Sinkhole

 Slide or Slip

 Sodic Spot

 Spoil Area

 Stony Spot

 Very Stony Spot

 Wet Spot

 Other

 Special Line Features

Water Features

 Streams and Canals

Transportation

 Rails

 Interstate Highways

 US Routes

 Major Roads

 Local Roads

Background

 Aerial Photography

MAP INFORMATION

The soil surveys that comprise your AOI were mapped at 1:24,000.

Warning: Soil Map may not be valid at this scale.

Enlargement of maps beyond the scale of mapping can cause misunderstanding of the detail of mapping and accuracy of soil line placement. The maps do not show the small areas of contrasting soils that could have been shown at a more detailed scale.

Please rely on the bar scale on each map sheet for map measurements.

Source of Map: Natural Resources Conservation Service

Web Soil Survey URL:

Coordinate System: Web Mercator (EPSG:3857)

Maps from the Web Soil Survey are based on the Web Mercator projection, which preserves direction and shape but distorts distance and area. A projection that preserves area, such as the Albers equal-area conic projection, should be used if more accurate calculations of distance or area are required.

This product is generated from the USDA-NRCS certified data as of the version date(s) listed below.

Soil Survey Area: Bell and Harlan Counties, Kentucky

Survey Area Data: Version 16, Oct 3, 2017

Soil map units are labeled (as space allows) for map scales 1:50,000 or larger.

Date(s) aerial images were photographed: Jun 27, 2012—Mar 23, 2017

The orthophoto or other base map on which the soil lines were compiled and digitized probably differs from the background imagery displayed on these maps. As a result, some minor shifting of map unit boundaries may be evident.



Map Unit Legend

Map Unit Symbol	Map Unit Name	Acres in AOI	Percent of AOI
CgF	Cloverlick-Guyandotte-Highsplint complex, 20 to 80 percent slopes, very stony	52.9	99.7%
Du	Dumps, Mine; tailings;, and Tipples	0.2	0.3%
Totals for Area of Interest		53.0	100.0%

Map Unit Description: Cloverlick-Guyandotte-Highsplint complex, 20 to 80 percent slopes, very stony---Bell and Harlan Counties, Kentucky

Bell and Harlan Counties, Kentucky

CgF—Cloverlick-Guyandotte-Highsplint complex, 20 to 80 percent slopes, very stony

Map Unit Setting

National map unit symbol: 2w8hx
Elevation: 680 to 3,500 feet
Mean annual precipitation: 28 to 52 inches
Mean annual air temperature: 39 to 68 degrees F
Frost-free period: 135 to 220 days
Farmland classification: Not prime farmland

Map Unit Composition

Cloverlick and similar soils: 45 percent
Guyandotte and similar soils: 22 percent
Highsplint and similar soils: 20 percent
Minor components: 13 percent
Estimates are based on observations, descriptions, and transects of the mapunit.

Description of Cloverlick

Setting

Landform: Mountain slopes
Landform position (three-dimensional): Mountainflank
Down-slope shape: Concave
Across-slope shape: Linear
Parent material: Loamy-skeletal colluvium derived from sandstone and shale

Typical profile

Oi - 0 to 2 inches: channery slightly decomposed plant material
A - 2 to 8 inches: channery loam
Bw1 - 8 to 24 inches: channery loam
Bw2 - 24 to 43 inches: very channery loam
BC - 43 to 80 inches: very flaggy loam

Properties and qualities

Slope: 20 to 80 percent
Percent of area covered with surface fragments: 1.0 percent
Depth to restrictive feature: More than 80 inches
Natural drainage class: Well drained
Capacity of the most limiting layer to transmit water (Ksat):
Moderately high to high (0.60 to 6.00 in/hr)
Depth to water table: More than 80 inches
Frequency of flooding: None
Frequency of ponding: None
Sodium adsorption ratio, maximum in profile: 1.0
Available water storage in profile: Moderate (about 6.3 inches)

Map Unit Description: Cloverlick-Guyandotte-Highsplint complex, 20 to 80 percent slopes, very stony---Bell and Harlan Counties, Kentucky

Interpretive groups

Land capability classification (irrigated): None specified

Land capability classification (nonirrigated): 7e

Hydrologic Soil Group: A

Hydric soil rating: No

Description of Guyandotte

Setting

Landform: Mountain slopes

Landform position (three-dimensional): Mountainbase, mountainflank

Down-slope shape: Concave

Across-slope shape: Concave

Parent material: Loamy-skeletal colluvium derived from sandstone and shale

Typical profile

Oi - 0 to 2 inches: very channery slightly decomposed plant material

Oa - 2 to 5 inches: very channery moderately decomposed plant material

A - 5 to 15 inches: very channery sandy loam

Bw - 15 to 67 inches: very channery sandy loam

Properties and qualities

Slope: 20 to 80 percent

Percent of area covered with surface fragments: 1.6 percent

Depth to restrictive feature: More than 80 inches

Natural drainage class: Well drained

Capacity of the most limiting layer to transmit water (Ksat):

Moderately high to high (0.57 to 5.95 in/hr)

Depth to water table: More than 80 inches

Frequency of flooding: None

Frequency of ponding: None

Available water storage in profile: Low (about 4.0 inches)

Interpretive groups

Land capability classification (irrigated): None specified

Land capability classification (nonirrigated): 7e

Hydrologic Soil Group: A

Hydric soil rating: No

Description of Highsplint

Setting

Landform: Mountain slopes

Landform position (three-dimensional): Mountainflank

Down-slope shape: Concave

Across-slope shape: Linear

Parent material: Loamy-skeletal fine-loamy colluvium derived from sandstone and shale

Map Unit Description: Cloverlick-Guyandotte-Highsplint complex, 20 to 80 percent slopes, very stony---Bell and Harlan Counties, Kentucky

Typical profile

O_i - 0 to 1 inches: very channery slightly decomposed plant material
A - 1 to 4 inches: very channery silt loam
BA - 4 to 11 inches: very channery silt loam
Bw₁ - 11 to 28 inches: very channery clay loam
Bw₂ - 28 to 48 inches: very channery loam
BC - 48 to 85 inches: very channery loam

Properties and qualities

Slope: 20 to 80 percent
Percent of area covered with surface fragments: 1.0 percent
Depth to restrictive feature: More than 80 inches
Natural drainage class: Well drained
Capacity of the most limiting layer to transmit water (K_{sat}):
Moderately high to high (0.20 to 2.00 in/hr)
Depth to water table: More than 80 inches
Frequency of flooding: None
Frequency of ponding: None
Available water storage in profile: Low (about 5.5 inches)

Interpretive groups

Land capability classification (irrigated): None specified
Land capability classification (nonirrigated): 7e
Hydrologic Soil Group: A
Hydric soil rating: No

Minor Components

Kimper

Percent of map unit: 4 percent
Landform: Mountain slopes
Landform position (three-dimensional): Mountainflank
Down-slope shape: Concave
Across-slope shape: Linear
Hydric soil rating: No

Shelocta

Percent of map unit: 4 percent
Landform: Mountain slopes
Landform position (three-dimensional): Mountainflank
Down-slope shape: Concave
Across-slope shape: Linear
Hydric soil rating: No

Cutshin

Percent of map unit: 2 percent
Landform: Mountain slopes
Landform position (three-dimensional): Lower third of mountainflank
Down-slope shape: Concave
Across-slope shape: Concave
Hydric soil rating: No

Map Unit Description: Cloverlick-Guyandotte-Highsplint complex, 20 to 80 percent slopes, very stony---Bell and Harlan Counties, Kentucky

Summers

Percent of map unit: 2 percent

Landform: Ridges

Landform position (three-dimensional): Mountaintop

Down-slope shape: Convex

Across-slope shape: Linear

Hydric soil rating: No

Rock outcrop

Percent of map unit: 1 percent

Data Source Information

Soil Survey Area: Bell and Harlan Counties, Kentucky

Survey Area Data: Version 16, Oct 3, 2017



Map Unit Description: Dumps, Mine; tailings;, and Tipples---Bell and Harlan Counties,
Kentucky

Bell and Harlan Counties, Kentucky

Du—Dumps, Mine; tailings;, and Tipples

Map Unit Setting

National map unit symbol: ljj4
Elevation: 1,000 to 2,100 feet
Mean annual precipitation: 43 to 55 inches
Mean annual air temperature: 42 to 67 degrees F
Frost-free period: 159 to 200 days
Farmland classification: Not prime farmland

Map Unit Composition

Dumps, mine (tailings & tipples): 85 percent
Minor components: 15 percent
Estimates are based on observations, descriptions, and transects of the mapunit.

Description of Dumps, Mine (tailings & Tipples)

Interpretive groups

Land capability classification (irrigated): None specified
Land capability classification (nonirrigated): 8
Hydric soil rating: No

Minor Components

Bethesda, unstable fill

Percent of map unit: 5 percent
Hydric soil rating: No

Udorthents, unstable fill

Percent of map unit: 5 percent
Hydric soil rating: No

Fairpoint, unstable fill

Percent of map unit: 5 percent
Hydric soil rating: No

Data Source Information

Soil Survey Area: Bell and Harlan Counties, Kentucky
Survey Area Data: Version 16, Oct 3, 2017

EXHIBIT H
DIRECTIONS TO WCF SITE

Site Name: Wallins Creek
Driving Directions to Proposed Tower Site

1. Beginning at the offices of the Harlan County Clerk located at 210 E. Central Street, Harlan, Kentucky.
2. Start out going west on E Central St toward N 1st St.
3. Take the 3rd right onto S US Highway 421/US-421 N.
4. Turn left onto S US Highway 119/US-119 S.
5. Turn left onto State Highway 3461/KY-3461.
6. Turn slight left onto Highway 219/KY-219.
7. Turn right onto Camp Creek Rd.
8. Arrive at County Road 1248A8 a.k.a. Camp Creek Road, Wallins Creek, Kentucky 40873 on the left.
9. The site coordinates are 36°48'02.36" North latitude, 83°24'43.64" West longitude.



Prepared by:
Robert W. Grant
Pike Legal Group PLLC
1578 Highway 44 East, Suite 6
P.O. Box 369
Shepherdsville, KY 40165-3069
Telephone: 502-955-4400 or 800-516-4293

EXHIBIT I
COPY OF REAL ESTATE AGREEMENT

Market: Lexington
Cell Site Number: KYL06089
Cell Site Name: Wallins Creek
Fixed Asset Number: 13800700

OPTION AND LEASE AGREEMENT

THIS OPTION AND LEASE AGREEMENT ("**Agreement**"), dated as of the latter of the signature dates below (the "**Effective Date**"), is entered into by Cindy Honeycutt, a widow, having a mailing address of P.O. Box 356, Whitesburg, KY 41858 ("**Landlord**") and New Cingular Wireless PCS, LLC, a Delaware limited liability company, having a mailing address of 575 Morosgo Drive, Atlanta, GA 30324 ("**Tenant**").

BACKGROUND

Landlord owns or controls that certain plot, parcel or tract of land, as described on **Exhibit 1**, together with all rights and privileges arising in connection therewith, located at 0 Hensley Hollow – Wallins 0, in the County of Harlan, State of Kentucky (collectively, the "**Property**"). Tenant desires to use a portion of the Property in connection with its federally licensed communications business. Landlord desires to grant to Tenant the right to use a portion of the Property in accordance with this Agreement.

The parties agree as follows:

1. OPTION TO LEASE.

(a) Landlord grants to Tenant an option (the "**Option**") to lease a certain portion of the Property containing approximately 10,000 square feet including the air space above such ground space, as described on attached **Exhibit 1** (the "**Premises**"), for the placement of Tenant's Communication Facility.

(b) During the Option Term, and during the term of this Agreement, Tenant and its agents, engineers, surveyors and other representatives will have the right to enter upon the Property to inspect, examine, conduct soil borings, drainage testing, material sampling, radio frequency testing and other geological or engineering tests or studies of the Property (collectively, the "**Tests**"), to apply for and obtain licenses, permits, approvals, or other relief required of or deemed necessary or appropriate at Tenant's sole discretion for its use of the Premises and include, without limitation, applications for zoning variances, zoning ordinances, amendments, special use permits, and construction permits (collectively, the "**Government Approvals**"), initiate the ordering and/or scheduling of necessary utilities, and otherwise to do those things on or off the Property that, in the opinion of Tenant, are necessary in Tenant's sole discretion to determine the physical condition of the Property, the environmental history of the Property, Landlord's title to the Property and the feasibility or suitability of the Property for Tenant's Permitted Use, all at Tenant's expense. Tenant will not be liable to Landlord or any third party on account of any pre-existing defect or condition on or with respect to the Property, whether or not such defect or condition is disclosed by Tenant's inspection. Tenant will restore the Property to its condition as it existed at the commencement of the Option Term, reasonable wear and tear and loss by casualty or other causes beyond Tenant's control excepted.

(c) In consideration of Landlord granting Tenant the Option, Tenant agrees to pay Landlord the sum of [REDACTED] within forty five (45) business days of the Effective Date. The Option will be for an initial term of one (1) year commencing on the Effective Date (the "**Initial Option Term**") and may be renewed by Tenant for an additional one (1) year (the "**Renewal Option Term**") upon written notification to Landlord and the payment of an additional [REDACTED] no later than five (5) days prior to the expiration date of the Initial Option Term. The Initial Option Term and any Renewal Option Term are collectively referred to as the "**Option Term**."

(d) The Option may be sold, assigned or transferred at any time by Tenant to an Affiliate (as that term is hereinafter defined) of Tenant or to any third party agreeing to be subject to the terms hereof. Otherwise, the Option may not be sold, assigned or transferred without the written consent of Landlord, such consent not to

be unreasonably withheld, conditioned or delayed. From and after the date the Option has been sold, assigned or transferred by Tenant to an Affiliate or a third party agreeing to be subject to the terms hereof, Tenant shall immediately be released from any and all liability under this Agreement, including the payment of any rental or other sums due, without any further action.

(e) During the Option Term, Tenant may exercise the Option by notifying Landlord in writing. If Tenant exercises the Option then Landlord leases the Premises to Tenant subject to the terms and conditions of this Agreement. If Tenant does not exercise the Option during the Initial Option Term or any extension thereof, this Agreement will terminate and the parties will have no further liability to each other.

(f) If during the Option Term, or during the term of this Agreement the Option is exercised, Landlord decides to subdivide, sell, or change the status of the zoning of the Premises, Property or any of Landlord's contiguous, adjoining or surrounding property (the "**Surrounding Property**,") or in the event of foreclosure, Landlord shall immediately notify Tenant in writing. Landlord agrees that during the Option Term, or during the Term of this Agreement if the Option is exercised, Landlord shall not initiate or consent to any change in the zoning of the Premises, Property or Surrounding Property or impose or consent to any other use or restriction that would prevent or limit Tenant from using the Premises for the Permitted Use. Any and all terms and conditions of this Agreement that by their sense and context are intended to be applicable during the Option Term shall be so applicable.

2. **PERMITTED USE.** Tenant may use the Premises for the transmission and reception of communications signals and the installation, construction, maintenance, operation, repair, replacement and upgrade of its communications fixtures and related equipment, cables, accessories and improvements, which may include a suitable support structure, associated antennas, equipment shelters or cabinets and fencing and any other items necessary to the successful and secure use of the Premises (collectively, the "**Communication Facility**"), as well as the right to test, survey and review title on the Property; Tenant further has the right but not the obligation to add, modify and/or replace equipment in order to be in compliance with any current or future federal, state or local mandated application, including, but not limited to, emergency 911 communication services, at no additional cost to Tenant or Landlord (collectively, the "**Permitted Use**"). Landlord and Tenant agree that any portion of the Communication Facility that may be conceptually described on **Exhibit 1** will not be deemed to limit Tenant's Permitted Use. If **Exhibit 1** includes drawings of the initial installation of the Communication Facility, Landlord's execution of this Agreement will signify Landlord's approval of **Exhibit 1**. For a period of ninety (90) days following the start of construction, Landlord grants Tenant, its subtenants, licensees and sublicensees, the right to use such portions of Landlord's contiguous, adjoining or Surrounding Property as described on **Exhibit 1** as may reasonably be required during construction and installation of the Communication Facility. Tenant has the right to install and operate transmission cables from the equipment shelter or cabinet to the antennas, electric lines from the main feed to the equipment shelter or cabinet and communication lines from the Property's main entry point to the equipment shelter or cabinet, and to make other improvements, alterations, upgrades or additions appropriate for Tenant's Permitted Use, including the right to construct a fence around the Premises and undertake any other appropriate means to secure the Premises at Tenant's expense. Tenant has the right to modify, supplement, replace, upgrade, expand the equipment, increase the number of antennas or relocate the Communication Facility within the Premises at any time during the term of this Agreement. Tenant will be allowed to make such alterations to the Property in order to ensure that Tenant's Communication Facility complies with all applicable federal, state or local laws, rules or regulations. In the event Tenant desires to modify or upgrade the Communication Facility, in a manner that requires an additional portion of the Property (the "**Additional Premises**") for such modification or upgrade, Landlord agrees to lease to Tenant the Additional Premises, upon the same terms and conditions set forth herein, except that the Rent shall increase, in conjunction with the lease of the Additional Premises by the amount equivalent to the then-current per square foot rental rate charged by Landlord to Tenant times the square footage of the Additional Premises. Landlord agrees to take such actions and enter into and deliver to Tenant such documents as Tenant reasonably requests in order to effect and memorialize the lease of the Additional Premises to Tenant.

3. **TERM.**

(a) The initial lease term will be five (5) years (the "**Initial Term**"), commencing on the effective date of written notification by Tenant to Landlord of Tenant's exercise of the Option (the "**Term Commencement Date**"). The Initial Term will terminate on the fifth (5th) anniversary of the Term Commencement Date.

(b) This Agreement will automatically renew for four (4) additional five (5) year term(s) (each five (5) year term shall be defined as an "**Extension Term**"), upon the same terms and conditions unless Tenant notifies Landlord in writing of Tenant's intention not to renew this Agreement at least sixty (60) days prior to the expiration of the Initial Term or then-existing Extension Term.

(c) Unless (i) Landlord or Tenant notifies the other in writing of its intention to terminate this Agreement at least six (6) months prior to the expiration of the final Extension Term, or (ii) the Agreement is terminated as otherwise permitted by this Agreement prior to the end of the final Extension Term, then upon the expiration of the final Extension Term, this Agreement shall continue in force upon the same covenants, terms and conditions for a further term of one (1) year, and for annual terms thereafter ("**Annual Term**") until terminated by either party by giving to the other written notice of its intention to so terminate at least six (6) months prior to the end of any such Annual Term. Monthly rental during such Annual Terms shall be equal to the Rent paid for the last month of the final Extension Term. If Tenant remains in possession of the Premises after the termination of this Agreement, then Tenant will be deemed to be occupying the Premises on a month-to-month basis (the "**Holdover Term**"), subject to the terms and conditions of this Agreement.

(d) The Initial Term, any Extension Terms, any Annual Terms and any Holdover Term are collectively referred to as the Term (the "**Term**").

4. **RENT.**

(a) Commencing on the first day of the month following the date that Tenant commences construction (the "**Rent Commencement Date**"). Tenant will pay Landlord on or before the fifth (5th) day of each calendar month in advance [REDACTED] (the "**Rent**"), at the address set forth above. In any partial month occurring after the Rent Commencement Date, Rent will be prorated. The initial Rent payment will be forwarded by Tenant to Landlord within forty-five (45) days after the Rent Commencement Date.

(b) In year one (1) of each Extension Term, the monthly Rent will increase by [REDACTED] over the Rent paid during the previous five (5) year term.

(c) All charges payable under this Agreement such as utilities and taxes shall be billed by Landlord within one (1) year from the end of the calendar year in which the charges were incurred; any charges beyond such period shall not be billed by Landlord, and shall not be payable by Tenant. The foregoing shall not apply to monthly Rent which is due and payable without a requirement that it be billed by Landlord. The provisions of this subsection shall survive the termination or expiration of this Agreement.

5. **APPROVALS.**

(a) Landlord agrees that Tenant's ability to use the Premises is contingent upon the suitability of the Premises and Property for Tenant's Permitted Use and Tenant's ability to obtain and maintain all Government Approvals. Landlord authorizes Tenant to prepare, execute and file all required applications to obtain Government Approvals for Tenant's Permitted Use under this Agreement and agrees to reasonably assist Tenant with such applications and with obtaining and maintaining the Government Approvals.

(b) Tenant has the right to obtain a title report or commitment for a leasehold title policy from a title insurance company of its choice and to have the Property surveyed by a surveyor of its choice.

(c) Tenant may also perform and obtain, at Tenant's sole cost and expense, soil borings, percolation tests, engineering procedures, environmental investigation or other tests or reports on, over, and under the Property, necessary to determine if Tenant's use of the Premises will be compatible with Tenant's engineering specifications, system, design, operations or Government Approvals.

6. **TERMINATION.** This Agreement may be terminated, without penalty or further liability, as follows:

(a) by either party on thirty (30) days prior written notice, if the other party remains in default under Section 15 of this Agreement after the applicable cure periods;

(b) by Tenant upon written notice to Landlord, if Tenant is unable to obtain or maintain, any required approval(s) or the issuance of a license or permit by any agency, board, court or other governmental authority necessary for the construction or operation of the Communication Facility as now or hereafter intended by Tenant; or if Tenant determines, in its sole discretion that the cost of or delay in obtaining or retaining the same is commercially unreasonable;

(c) by Tenant, upon written notice to Landlord, if Tenant determines, in its sole discretion, due to the title report results or survey results, that the condition of the Premises is unsatisfactory for its intended uses;

(d) by Tenant upon written notice to Landlord for any reason or no reason, at any time prior to commencement of construction by Tenant; or

(e) by Tenant upon sixty (60) days' prior written notice to Landlord for any reason or no reason, so long as Tenant pays Landlord a termination fee equal to three (3) months' Rent, at the then-current rate, provided, however, that no such termination fee will be payable on account of the termination of this Agreement by Tenant under any termination provision contained in any other Section of this Agreement, including the following: 5 Approvals, 6(a) Termination, 6(b) Termination, 6(c) Termination, 6(d) Termination, 11(d) Environmental, 18 Condemnation, or 19 Casualty.

7. **INSURANCE.**

(a) During the Term, Tenant will carry, at its own cost and expense, the following insurance: (i) workers' compensation insurance as required by law; and (ii) commercial general liability (CGL) insurance with respect to its activities on the Property, such insurance to afford protection of up to [REDACTED] per occurrence and [REDACTED] general aggregate, based on Insurance Services Office (ISO) Form CG 00 01 or a substitute form providing substantially equivalent coverage. Tenant's CGL insurance shall contain a provision including Landlord as an additional insured. Such additional insured coverage:

(i) shall be limited to bodily injury, property damage or personal and advertising injury caused, in whole or in part, by Tenant, its employees, agents or independent contractors;

(ii) shall not extend to claims for punitive or exemplary damages arising out of the acts or omissions of Landlord, its employees, agents or independent contractors or where such coverage is prohibited by law or to claims arising out of the gross negligence of Landlord, its employees, agents or independent contractors; and

(iii) shall not exceed Tenant's indemnification obligation under this Agreement, if any.

(b) Notwithstanding the foregoing, Tenant shall have the right to self-insure the coverages required in subsection (a). In the event Tenant elects to self-insure its obligation to include Landlord as an additional insured, the following provisions shall apply (in addition to those set forth in subsection (a)):

(i) Landlord shall promptly and no later than thirty (30) days after notice thereof provide Tenant with written notice of any claim, demand, lawsuit, or the like for which it seeks coverage pursuant to this Section and provide Tenant with copies of any demands, notices, summonses, or legal papers received in connection with such claim, demand, lawsuit, or the like;

(ii) Landlord shall not settle any such claim, demand, lawsuit, or the like without the prior written consent of Tenant; and

(iii) Landlord shall fully cooperate with Tenant in the defense of the claim, demand, lawsuit, or the like.

8. INTERFERENCE.

(a) Prior to or concurrent with the execution of this Agreement, Landlord has provided or will provide Tenant with a list of radio frequency user(s) and frequencies used on the Property as of the Effective Date. Tenant warrants that its use of the Premises will not interfere with those existing radio frequency uses on the Property, as long as those existing radio frequency user(s) operate and continue to operate within their respective frequencies and in accordance with all applicable laws and regulations.

(b) Landlord will not grant, after the date of this Agreement, a lease, license or any other right to any third party, if the exercise of such grant may in any way adversely affect or interfere with the Communication Facility, the operations of Tenant or the rights of Tenant under this Agreement. Landlord will notify Tenant in writing prior to granting any third party the right to install and operate communications equipment on the Property.

(c) Landlord will not, nor will Landlord permit its employees, tenants, licensees, invitees, agents or independent contractors to, interfere in any way with the Communication Facility, the operations of Tenant or the rights of Tenant under this Agreement. Landlord will cause such interference to cease within twenty-four (24) hours after receipt of notice of interference from Tenant. In the event any such interference does not cease within the aforementioned cure period, Landlord shall cease all operations which are suspected of causing interference (except for intermittent testing to determine the cause of such interference) until the interference has been corrected.

(d) For the purposes of this Agreement, "interference" may include, but is not limited to, any use on the Property or Surrounding Property that causes electronic or physical obstruction with, or degradation of, the communications signals from the Communication Facility.

9. INDEMNIFICATION.

(a) Tenant agrees to indemnify, defend and hold Landlord harmless from and against any and all injury, loss, damage or liability (or any claims in respect of the foregoing), costs or expenses (including reasonable attorneys' fees and court costs) arising directly from the installation, use, maintenance, repair or removal of the Communication Facility or Tenant's breach of any provision of this Agreement, except to the extent attributable to the negligent or intentional act or omission of Landlord, its employees, agents or independent contractors.

(b) Landlord agrees to indemnify, defend and hold Tenant harmless from and against any and all injury, loss, damage or liability (or any claims in respect of the foregoing), costs or expenses (including reasonable attorneys' fees and court costs) arising directly from the actions or failure to act of Landlord, its employees or agents, or Landlord's breach of any provision of this Agreement, except to the extent attributable to the negligent or intentional act or omission of Tenant, its employees, agents or independent contractors.

(c) The indemnified party: (i) shall promptly provide the indemnifying party with written notice of any claim, demand, lawsuit, or the like for which it seeks indemnification pursuant to this Section and provide the indemnifying party with copies of any demands, notices, summonses, or legal papers received in connection with such claim, demand, lawsuit, or the like; (ii) shall not settle any such claim, demand, lawsuit, or the like without the prior written consent of the indemnifying party; and (iii) shall fully cooperate with the indemnifying party in the defense of the claim, demand, lawsuit, or the like. A delay in notice shall not relieve the indemnifying party of its indemnity obligation, except (1) to the extent the indemnifying party can show it was prejudiced by the delay; and (2) the indemnifying party shall not be liable for any settlement or litigation expenses incurred before the time when notice is given.

10. WARRANTIES.

(a) Tenant and Landlord each acknowledge and represent that it is duly organized, validly existing and in good standing and has the right, power and authority to enter into this Agreement and bind itself hereto through the party set forth as signatory for the party below.

(b) Landlord represents, warrants and agrees that: (i) Landlord solely owns the Property as a legal lot in fee simple, or controls the Property by lease or license; (ii) the Property is not and will not be encumbered by any liens, restrictions, mortgages, covenants, conditions, easements, leases, or any other agreements of record or not of record, which would adversely affect Tenant's Permitted Use and enjoyment of the Premises under this

Agreement; (iii) as long as Tenant is not in default then Landlord grants to Tenant sole, actual, quiet and peaceful use, enjoyment and possession of the Premises without hindrance or ejection by any persons lawfully claiming under Landlord; (iv) Landlord's execution and performance of this Agreement will not violate any laws, ordinances, covenants or the provisions of any mortgage, lease or other agreement binding on Landlord; and (v) if the Property is or becomes encumbered by a deed to secure a debt, mortgage or other security interest, Landlord will provide promptly to Tenant a mutually agreeable subordination, non-disturbance and attornment agreement executed by Landlord and the holder of such security interest.

11. ENVIRONMENTAL.

(a) Landlord represents and warrants that, except as may be identified in **Exhibit 11** attached to this Agreement, (i) the Property, as of the date of this Agreement, is free of hazardous substances, including asbestos-containing materials and lead paint, and (ii) the Property has never been subject to any contamination or hazardous conditions resulting in any environmental investigation, inquiry or remediation. Landlord and Tenant agree that each will be responsible for compliance with any and all applicable governmental laws, rules, statutes, regulations, codes, ordinances, or principles of common law regulating or imposing standards of liability or standards of conduct with regard to protection of the environment or worker health and safety, as may now or at any time hereafter be in effect, to the extent such apply to that party's activity conducted in or on the Property.

(b) Landlord and Tenant agree to hold harmless and indemnify the other from, and to assume all duties, responsibilities and liabilities at the sole cost and expense of the indemnifying party for, payment of penalties, sanctions, forfeitures, losses, costs or damages, and for responding to any action, notice, claim, order, summons, citation, directive, litigation, investigation or proceeding ("**Claims**"), to the extent arising from that party's breach of its obligations or representations under Section 11(a). Landlord agrees to hold harmless and indemnify Tenant from, and to assume all duties, responsibilities and liabilities at the sole cost and expense of Landlord for, payment of penalties, sanctions, forfeitures, losses, costs or damages, and for responding to any Claims, to the extent arising from subsurface or other contamination of the Property with hazardous substances prior to the Effective Date of this Agreement or from such contamination caused by the acts or omissions of Landlord during the Term. Tenant agrees to hold harmless and indemnify Landlord from, and to assume all duties, responsibilities and liabilities at the sole cost and expense of Tenant for, payment of penalties, sanctions, forfeitures, losses, costs or damages, and for responding to any Claims, to the extent arising from hazardous substances brought onto the Property by Tenant.

(c) The indemnifications of this Section 11 specifically include reasonable costs, expenses and fees incurred in connection with any investigation of Property conditions or any clean-up, remediation, removal or restoration work required by any governmental authority. The provisions of this Section 11 will survive the expiration or termination of this Agreement.

(d) In the event Tenant becomes aware of any hazardous substances on the Property, or any environmental, health or safety condition or matter relating to the Property, that, in Tenant's sole determination, renders the condition of the Premises or Property unsuitable for Tenant's use, or if Tenant believes that the leasing or continued leasing of the Premises would expose Tenant to undue risks of liability to a government agency or other third party, Tenant will have the right, in addition to any other rights it may have at law or in equity, to terminate this Agreement upon written notice to Landlord.

12. ACCESS. At all times throughout the Term of this Agreement, and at no additional charge to Tenant, Tenant and its employees, agents, and subcontractors, will have twenty-four (24) hour per day, seven (7) day per week pedestrian and vehicular access ("**Access**") to and over the Property, from an open and improved public road to the Premises, for the installation, maintenance and operation of the Communication Facility and any utilities serving the Premises. As may be described more fully in **Exhibit 1**, Landlord grants to Tenant an easement for such Access and Landlord agrees to provide to Tenant such codes, keys and other instruments necessary for such Access at no additional cost to Tenant. Upon Tenant's request, Landlord will execute a separate recordable easement evidencing this right. Landlord shall execute a letter granting Tenant Access to the Property substantially in the form attached as **Exhibit 12**; upon Tenant's request, Landlord shall execute additional letters during the Term. Landlord acknowledges that in the event Tenant cannot obtain Access to the

Premises, Tenant shall incur significant damage. If Landlord fails to provide the Access granted by this Section 12, such failure shall be a default under this Agreement. In connection with such default, in addition to any other rights or remedies available to Tenant under this Agreement or at law or equity, Landlord shall pay Tenant, as liquidated damages and not as a penalty, [REDACTED] per day in consideration of Tenant's damages until Landlord cures such default. Landlord and Tenant agree that Tenant's damages in the event of a denial of Access are difficult, if not impossible, to ascertain, and the liquidated damages set forth above are a reasonable approximation of such damages.

13. REMOVAL/RESTORATION. All portions of the Communication Facility brought onto the Property by Tenant will be and remain Tenant's personal property and, at Tenant's option, may be removed by Tenant at any time during or after the Term. Landlord covenants and agrees that no part of the Communication Facility constructed, erected or placed on the Premises by Tenant will become, or be considered as being affixed to or a part of, the Property, it being the specific intention of Landlord that all improvements of every kind and nature constructed, erected or placed by Tenant on the Premises will be and remain the property of Tenant and may be removed by Tenant at any time during or after the Term. Tenant will repair any damage to the Property resulting from Tenant's removal activities. Any portions of the Communication Facility that Tenant does not remove within one hundred twenty (120) days after the later of the end of the Term and cessation of Tenant's operations at the Premises shall be deemed abandoned and owned by Landlord. However, to the extent required by law, Tenant will remove the above-ground portions of the Communications Facility within such one hundred twenty (120) day period. Notwithstanding the foregoing, Tenant will not be responsible for the replacement of any trees, shrubs or other vegetation.

14. MAINTENANCE/UTILITIES.

(a) Tenant will keep and maintain the Premises in good condition, reasonable wear and tear and damage from the elements excepted. Landlord will maintain and repair the Property and access thereto and all areas of the Premises where Tenant does not have exclusive control, in good and tenantable condition, subject to reasonable wear and tear and damage from the elements. Landlord will be responsible for maintenance of landscaping on the Property, including any landscaping installed by Tenant as a condition of this Agreement or any required permit. Notwithstanding the foregoing, Tenant shall be responsible for the construction, maintenance, and upkeep of any Tenant constructed access road installed on the Property to the Communication Facility. Any damage Tenant causes to the access road, Tenant will repair at its cost and expense.

(b) Tenant will be responsible for paying on a monthly or quarterly basis all utilities charges for electricity, telephone service or any other utility used or consumed by Tenant on the Premises. In the event Tenant cannot secure its own metered electrical supply, Tenant will have the right, at its own cost and expense, to submeter from Landlord. When submetering is required under this Agreement, Landlord will read the meter and provide Tenant with an invoice and usage data on a monthly basis. Landlord agrees that it will not include a markup on the utility charges. Landlord further agrees to provide the usage data and invoice on forms provided by Tenant and to send such forms to such address and/or agent designated by Tenant. Tenant will remit payment within forty-five (45) days of receipt of the usage data and required forms. As noted in Section 4(c) above, any utility fee recovery by Landlord is limited to a twelve (12) month period. If Tenant submeters electricity from Landlord, Landlord agrees to give Tenant at least twenty-four (24) hours advance notice of any planned interruptions of said electricity. Landlord acknowledges that Tenant provides a communication service which requires electrical power to operate and must operate twenty-four (24) hours per day, seven (7) days per week. If the interruption is for an extended period of time, in Tenant's reasonable determination, Landlord agrees to allow Tenant the right to bring in a temporary source of power for the duration of the interruption. Landlord will not be responsible for interference with, interruption of or failure, beyond the reasonable control of Landlord, of such services to be furnished or supplied by Landlord.

(c) Landlord hereby grants to any company providing utility or similar services, including electric power and telecommunications, to Tenant an easement over the Property, from an open and improved public road to the Premises, and upon the Premises, for the purpose of constructing, operating and maintaining such lines, wires, circuits, and conduits, associated equipment cabinets and such appurtenances thereto, as such companies may from time to time require in order to provide such services to the Premises. Upon Tenant's or

the service company's request, Landlord will execute a separate recordable easement evidencing this grant, at no cost to Tenant or the service company.

15. DEFAULT AND RIGHT TO CURE.

(a) The following will be deemed a default by Tenant and a breach of this Agreement: (i) non-payment of Rent if such Rent remains unpaid for more than thirty (30) days after written notice from Landlord of such failure to pay; or (ii) Tenant's failure to perform any other term or condition under this Agreement within forty-five (45) days after written notice from Landlord specifying the failure. No such failure, however, will be deemed to exist if Tenant has commenced to cure such default within such period and provided that such efforts are prosecuted to completion with reasonable diligence. Delay in curing a default will be excused if due to causes beyond the reasonable control of Tenant. If Tenant remains in default beyond any applicable cure period, Landlord will have the right to exercise any and all rights and remedies available to it under law and equity.

(b) The following will be deemed a default by Landlord and a breach of this Agreement: (i) Landlord's failure to provide Access to the Premises as required by Section 12 of this Agreement within twenty-four (24) hours after written notice of such failure; (ii) Landlord's failure to cure an interference problem as required by Section 8 of this Agreement within twenty-four (24) hours after written notice of such failure; or (iii) Landlord's failure to perform any term, condition or breach of any warranty or covenant under this Agreement within forty-five (45) days after written notice from Tenant specifying the failure. No such failure, however, will be deemed to exist if Landlord has commenced to cure the default within such period and provided such efforts are prosecuted to completion with reasonable diligence. Delay in curing a default will be excused if due to causes beyond the reasonable control of Landlord. If Landlord remains in default beyond any applicable cure period, Tenant will have: (i) the right to cure Landlord's default and to deduct the costs of such cure from any monies due to Landlord from Tenant, and (ii) any and all other rights available to it under law and equity.

16. ASSIGNMENT/SUBLEASE. Tenant will have the right to assign this Agreement or sublease the Premises and its rights herein, in whole or in part, without Landlord's consent. Upon notification to Landlord of such assignment, Tenant will be relieved of all future performance, liabilities and obligations under this Agreement to the extent of such assignment.

17. NOTICES. All notices, requests and demands hereunder will be given by first class certified or registered mail, return receipt requested, or by a nationally recognized overnight courier, postage prepaid, to be effective when properly sent and received, refused or returned undelivered. Notices will be addressed to the parties as follows:

If to Tenant: New Cingular Wireless PCS, LLC
Attn: Network Real Estate Administration
Re: Cell Site #: KYL06089; Cell Site Name: Wallins Creek (KY)
Fixed Asset No.: 13800700
575 Morosgo Drive
Atlanta, GA 30324

With a copy to: New Cingular Wireless PCS, LLC
Attn.: Legal Department
Re: Cell Site #: KYL06089; Cell Site Name: Wallins Creek (KY)
Fixed Asset No.: 13800700
208 S. Akard Street
Dallas, TX 75202-4206

The copy sent to the Legal Department is an administrative step which alone does not constitute legal notice.

If to Landlord: Cindy Honeycutt
P.O. Box 356
Whitesburg, KY 41858

Either party hereto may change the place for the giving of notice to it by thirty (30) days' prior written notice to the other as provided herein.

18. CONDEMNATION. In the event Landlord receives notification of any condemnation proceedings affecting the Property, Landlord will provide notice of the proceeding to Tenant within forty-eight (48) hours. If a condemning authority takes all of the Property, or a portion sufficient, in Tenant's sole determination, to render the Premises unsuitable for Tenant, this Agreement will terminate as of the date the title vests in the condemning authority. The parties will each be entitled to pursue their own separate awards in the condemnation proceeds, which for Tenant will include, where applicable, the value of its Communication Facility, moving expenses, prepaid Rent, and business dislocation expenses. Tenant will be entitled to reimbursement for any prepaid Rent on a prorata basis.

19. CASUALTY. Landlord will provide notice to Tenant of any casualty or other harm affecting the Property within forty-eight (48) hours of the casualty or other harm. If any part of the Communication Facility or Property is damaged by casualty or other harm as to render the Premises unsuitable, in Tenant's sole determination, then Tenant may terminate this Agreement by providing written notice to Landlord, which termination will be effective as of the date of such casualty or other harm. Upon such termination, Tenant will be entitled to collect all insurance proceeds payable to Tenant on account thereof and to be reimbursed for any prepaid Rent on a prorata basis. Landlord agrees to permit Tenant to place temporary transmission and reception facilities on the Property, but only until such time as Tenant is able to activate a replacement transmission facility at another location; notwithstanding the termination of the Agreement, such temporary facilities will be governed by all of the terms and conditions of this Agreement, including Rent. If Landlord or Tenant undertakes to rebuild or restore the Premises and/or the Communication Facility, as applicable, Landlord agrees to permit Tenant to place temporary transmission and reception facilities on the Property at no additional Rent until the reconstruction of the Premises and/or the Communication Facility is completed. If Landlord determines not to rebuild or restore the Property, Landlord will notify Tenant of such determination within thirty (30) days after the casualty or other harm. If Landlord does not so notify Tenant, and Tenant decides not to terminate under this Section, then Landlord will promptly rebuild or restore any portion of the Property interfering with or required for Tenant's Permitted Use of the Premises to substantially the same condition as existed before the casualty or other harm. Landlord agrees that the Rent shall be abated until the Property and/or the Premises are rebuilt or restored, unless Tenant places temporary transmission and reception facilities on the Property.

20. WAIVER OF LANDLORD'S LIENS. Landlord waives any and all lien rights it may have, statutory or otherwise, concerning the Communication Facility or any portion thereof. The Communication Facility shall be deemed personal property for purposes of this Agreement, regardless of whether any portion is deemed real or personal property under applicable law; Landlord consents to Tenant's right to remove all or any portion of the Communication Facility from time to time in Tenant's sole discretion and without Landlord's consent.

21. TAXES.

(a) Landlord shall be responsible for timely payment of all taxes and assessments levied upon the lands, improvements and other property of Landlord, including any such taxes that may be calculated by the taxing authority using any method, including the income method. Tenant shall be responsible for any taxes and assessments attributable to and levied upon Tenant's leasehold improvements on the Premises if and as set forth in this Section 21. Nothing herein shall require Tenant to pay any inheritance, franchise, income, payroll,

excise, privilege, rent, capital stock, stamp, documentary, estate or profit tax, or any tax of similar nature, that is or may be imposed upon Landlord.

(b) In the event Landlord receives a notice of assessment with respect to which taxes or assessments are imposed on Tenant's leasehold improvements on the Premises, Landlord shall provide Tenant with copies of each such notice immediately upon receipt, but in no event later than thirty (30) days after the date of such notice of assessment. If Landlord does not provide such notice or notices to Tenant within such time period, Landlord shall be responsible for payment of the tax or assessment set forth in the notice, and Landlord shall not have the right to reimbursement of such amount from Tenant. If Landlord provides a notice of assessment to Tenant within such time period and requests reimbursement from Tenant as set forth below, then Tenant shall reimburse Landlord for the tax or assessments identified on the notice of assessment on Tenant's leasehold improvements, which has been paid by Landlord. If Landlord seeks reimbursement from Tenant, Landlord shall, no later than thirty (30) days after Landlord's payment of the taxes or assessments for the assessed tax year, provide Tenant with written notice including evidence that Landlord has timely paid same, and Landlord shall provide to Tenant any other documentation reasonably requested by Tenant to allow Tenant to evaluate the payment and to reimburse Landlord.

(c) For any tax amount for which Tenant is responsible under this Agreement, Tenant shall have the right to contest, in good faith, the validity or the amount thereof using such administrative, appellate or other proceedings as may be appropriate in the jurisdiction, and may defer payment of such obligations, pay same under protest, or take such other steps as Tenant may deem appropriate. This right shall include the ability to institute any legal, regulatory or informal action in the name of Landlord, Tenant, or both, with respect to the valuation of the Premises. Landlord shall cooperate with respect to the commencement and prosecution of any such proceedings and will execute any documents required therefor. The expense of any such proceedings shall be borne by Tenant and any refunds or rebates secured as a result of Tenant's action shall belong to Tenant, to the extent the amounts were originally paid by Tenant. In the event Tenant notifies Landlord by the due date for assessment of Tenant's intent to contest the assessment, Landlord shall not pay the assessment pending conclusion of the contest, unless required by applicable law.

(d) Landlord shall not split or cause the tax parcel on which the Premises are located to be split, bifurcated, separated or divided without the prior written consent of Tenant.

(e) Tenant shall have the right but not the obligation to pay any taxes due by Landlord hereunder if Landlord fails to timely do so, in addition to any other rights or remedies of Tenant. In the event that Tenant exercises its rights under this Section 21(e) due to such Landlord default, Tenant shall have the right to deduct such tax amounts paid from any monies due to Landlord from Tenant as provided in Section 15(b), provided that Tenant may exercise such right without having provided to Landlord notice and the opportunity to cure per Section 15(b).

(f) Any tax-related notices shall be sent to Tenant in the manner set forth in Section 17 and, in addition, of a copy of any such notices shall be sent to the following address. Promptly after the Effective Date of this Agreement, Landlord shall provide the following address to the taxing authority for the authority's use in the event the authority needs to communicate with Tenant. In the event that Tenant's tax addresses changes by notice to Landlord, Landlord shall be required to provide Tenant's new tax address to the taxing authority or authorities.

New Cingular Wireless PCS, LLC
Attn: Network Real Estate Administration -- Taxes
Re: Cell Site #: KYL06089; Cell Site Name: Wallins Creek (KY)
Fixed Asset No: 13800700
575 Morosgo Drive
Atlanta, GA 30324

(g) Notwithstanding anything to the contrary contained in this Section 21, Tenant shall have no obligation to reimburse any tax or assessment for which the Landlord is reimbursed or rebated by a third party.

22. SALE OF PROPERTY

(a) Landlord shall not be prohibited from the selling, leasing or use of any of the Property or the Surrounding Property except as provided below.

(b) If Landlord, at any time during the Term of this Agreement, decides to rezone or sell, subdivide or otherwise transfer all or any part of the Premises, or all or any part of the Property or Surrounding Property, to a purchaser other than Tenant, Landlord shall promptly notify Tenant in writing, and such rezoning, sale, subdivision or transfer shall be subject to this Agreement and Tenant's rights hereunder. In the event of a change in ownership, transfer or sale of the Property, within ten (10) days of such transfer, Landlord or its successor shall send the documents listed below in this subsection (b) to Tenant. Until Tenant receives all such documents, Tenant shall not be responsible for any failure to make payments under this Agreement and reserves the right to hold payments due under this Agreement.

- i. Old deed to Property
- ii. New deed to Property
- iii. Bill of Sale or Transfer
- iv. Copy of current Tax Bill
- v. New IRS Form W-9
- vi. Completed and Signed AT&T Payment Direction Form
- vii. Full contact information for new Landlord including phone number(s)

(c) Landlord agrees not to sell, lease or use any areas of the Property or Surrounding Property for the installation, operation or maintenance of other wireless communications facilities if such installation, operation or maintenance would interfere with Tenant's Permitted Use or communications equipment as determined by radio propagation tests performed by Tenant in its sole discretion. Landlord or Landlord's prospective purchaser shall reimburse Tenant for any costs and expenses of such testing. If the radio frequency propagation tests demonstrate levels of interference unacceptable to Tenant, Landlord shall be prohibited from selling, leasing or using any areas of the Property or the Surrounding Property for purposes of any installation, operation or maintenance of any other wireless communications facility or equipment.

(d) The provisions of this Section shall in no way limit or impair the obligations of Landlord under this Agreement, including interference and access obligations.

23. RENTAL STREAM OFFER. If at any time after the date of this Agreement, Landlord receives a bona fide written offer from a third party seeking an assignment or transfer of Rent payments associated with this Agreement ("**Rental Stream Offer**"), Landlord shall immediately furnish Tenant with a copy of the Rental Stream Offer. Tenant shall have the right within twenty (20) days after it receives such copy to match the Rental Stream Offer and agree in writing to match the terms of the Rental Stream Offer. Such writing shall be in the form of a contract substantially similar to the Rental Stream Offer. If Tenant chooses not to exercise this right or fails to provide written notice to Landlord within the twenty (20) day period, Landlord may assign the right to receive Rent payments pursuant to the Rental Stream Offer, subject to the terms of this Agreement. If Landlord attempts to assign or transfer Rent payments without complying with this Section, the assignment or transfer shall be void. Tenant shall not be responsible for any failure to make payments under this Agreement and reserves the right to hold payments due under this Agreement until Landlord complies with this Section.

24. MISCELLANEOUS.

(a) **Amendment/Waiver.** This Agreement cannot be amended, modified or revised unless done in writing and signed by Landlord and Tenant. No provision may be waived except in a writing signed by both parties. The failure by a party to enforce any provision of this Agreement or to require performance by the other

party will not be construed to be a waiver, or in any way affect the right of either party to enforce such provision thereafter.

(b) **Memorandum/Short Form Lease.** Contemporaneously with the execution of this Agreement, the parties will execute a recordable Memorandum or Short Form of Lease substantially in the form attached as **Exhibit 24b**. Either party may record this Memorandum or Short Form of Lease at any time during the Term, in its absolute discretion. Thereafter during the Term of this Agreement, either party will, at any time upon fifteen (15) business days' prior written notice from the other, execute, acknowledge and deliver to the other a recordable Memorandum or Short Form of Lease.

(c) **Limitation of Liability.** Except for the indemnity obligations set forth in this Agreement, and otherwise notwithstanding anything to the contrary in this Agreement, Tenant and Landlord each waives any claims that each may have against the other with respect to consequential, incidental or special damages, however caused, based on any theory of liability.

(d) **Compliance with Law.** Tenant agrees to comply with all federal, state and local laws, orders, rules and regulations ("Laws") applicable to Tenant's use of the Communication Facility on the Property. Landlord agrees to comply with all Laws relating to Landlord's ownership and use of the Property and any improvements on the Property.

(e) **Bind and Benefit.** The terms and conditions contained in this Agreement will run with the Property and bind and inure to the benefit of the parties, their respective heirs, executors, administrators, successors and assigns.

(f) **Entire Agreement.** This Agreement and the exhibits attached hereto, all being a part hereof, constitute the entire agreement of the parties hereto and will supersede all prior offers, negotiations and agreements with respect to the subject matter of this Agreement. Exhibits are numbered to correspond to the Section wherein they are first referenced. Except as otherwise stated in this Agreement, each party shall bear its own fees and expenses (including the fees and expenses of its agents, brokers, representatives, attorneys, and accountants) incurred in connection with the negotiation, drafting, execution and performance of this Agreement and the transactions it contemplates.

(g) **Governing Law.** This Agreement will be governed by the laws of the state in which the Premises are located, without regard to conflicts of law.

(h) **Interpretation.** Unless otherwise specified, the following rules of construction and interpretation apply: (i) captions are for convenience and reference only and in no way define or limit the construction of the terms and conditions hereof; (ii) use of the term "including" will be interpreted to mean "including but not limited to"; (iii) whenever a party's consent is required under this Agreement, except as otherwise stated in this Agreement or as same may be duplicative, such consent will not be unreasonably withheld, conditioned or delayed; (iv) exhibits are an integral part of this Agreement and are incorporated by reference into this Agreement; (v) use of the terms "termination" or "expiration" are interchangeable; (vi) reference to a default will take into consideration any applicable notice, grace and cure periods; (vii) to the extent there is any issue with respect to any alleged, perceived or actual ambiguity in this Agreement, the ambiguity shall not be resolved on the basis of who drafted the Agreement; (viii) the singular use of words includes the plural where appropriate and (ix) if any provision of this Agreement is held invalid, illegal or unenforceable, the remaining provisions of this Agreement shall remain in full force if the overall purpose of the Agreement is not rendered impossible and the original purpose, intent or consideration is not materially impaired.

(i) **Affiliates.** All references to "Tenant" shall be deemed to include any Affiliate of New Cingular Wireless PCS, LLC using the Premises for any Permitted Use or otherwise exercising the rights of Tenant pursuant to this Agreement. "Affiliate" means with respect to a party to this Agreement, any person or entity that (directly or indirectly) controls, is controlled by, or under common control with, that party. "Control" of a person or entity means the power (directly or indirectly) to direct the management or policies of that person or entity, whether through the ownership of voting securities, by contract, by agency or otherwise.

(j) **Survival.** Any provisions of this Agreement relating to indemnification shall survive the termination or expiration hereof. In addition, any terms and conditions contained in this Agreement that by their sense and context are intended to survive the termination or expiration of this Agreement shall so survive.

(k) **W-9.** As a condition precedent to payment, Landlord agrees to provide Tenant with a completed IRS Form W-9, or its equivalent, upon execution of this Agreement and at such other times as may be reasonably requested by Tenant, including, any change in Landlord's name or address.

(l) **Execution/No Option.** The submission of this Agreement to any party for examination or consideration does not constitute an offer, reservation of or option for the Premises based on the terms set forth herein. This Agreement will become effective as a binding Agreement only upon the handwritten legal execution, acknowledgment and delivery hereof by Landlord and Tenant. This Agreement may be executed in two (2) or more counterparts, all of which shall be considered one and the same agreement and shall become effective when one or more counterparts have been signed by each of the parties. All parties need not sign the same counterpart.

(m) **Attorneys' Fees.** In the event that any dispute between the parties related to this Agreement should result in litigation, the prevailing party in such litigation shall be entitled to recover from the other party all reasonable fees and expenses of enforcing any right of the prevailing party, including without limitation, reasonable attorneys' fees and expenses. Prevailing party means the party determined by the court to have most nearly prevailed even if such party did not prevail in all matters. This provision will not be construed to entitle any party other than Landlord, Tenant and their respective Affiliates to recover their fees and expenses.

(n) **WAIVER OF JURY TRIAL.** EACH PARTY, TO THE EXTENT PERMITTED BY LAW, KNOWINGLY, VOLUNTARILY AND INTENTIONALLY WAIVES ITS RIGHT TO A TRIAL BY JURY IN ANY ACTION OR PROCEEDING UNDER ANY THEORY OF LIABILITY ARISING OUT OF OR IN ANY WAY CONNECTED WITH THIS AGREEMENT OR THE TRANSACTIONS IT CONTEMPLATES.

[SIGNATURES APPEAR ON NEXT PAGE]

IN WITNESS WHEREOF, the parties have caused this Agreement to be effective as of the last date written below.

"LANDLORD"

Cindy Honeycutt

By: Cindy Honeycutt

Print Name: Cindy Honeycutt

Its: Owner

Date: 01-04-18

LANDLORD ACKNOWLEDGMENT

STATE OF Kentucky)
COUNTY OF Carroll) ss:

On the 4 day of January, 2018 before me, personally appeared Cindy Honeycutt, who acknowledged under oath, that he/she/they is/are the person/officer named in the within instrument, and that he/she/they executed the same in his/her/their stated capacity as the voluntary act and deed of the Landlord for the purposes therein contained.

Notary Public: Andrew V. Odey
My Commission Expires: 9/28/2019

Andrew V. Odey

"TENANT"

New Cingular Wireless PCS, LLC,
a Delaware limited liability company

By: AT&T Mobility Corporation

Its: Manager

By:

Print Name: Jason Allday

Its: Area Manager – TN/KY

Date: 5/22/18


TENANT ACKNOWLEDGMENT

STATE OF ALABAMA)

) ss:

COUNTY OF JEFFERSON)

On the 22 day of May, 2018, before me personally appeared Jason Allday, and acknowledged under oath that he is the Area Manager – TN/KY of AT&T Mobility Corporation, the Manager of New Cingular Wireless PCS, LLC, the Tenant named in the attached instrument, and as such was authorized to execute this instrument on behalf of the Tenant.

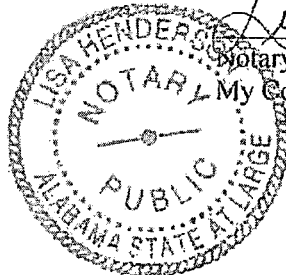

Notary Public: Lisa Henderson

My Commission Expires: 7/9/2018

EXHIBIT 1

DESCRIPTION OF PREMISES

Page 1 of 7

to the Option and Lease Agreement dated May 22, 2018, by and between Cindy Honeycutt, a widow, as Landlord, and New Cingular Wireless PCS, LLC, a Delaware limited liability company, as Tenant.

The Property is legally described as follows:

BEGINNING At two chestnut oaks on the point of a ridge a corner to John R. Blanton tract, owned by Kentshig Corporation, thence down with the meanders of the ridge between Coal Hollow and Lick Hollow, N 26-30 E 39 feet N 57-15 E 125.9 feet, N 51-30 E 221.2 feet, N 45-30 E 130 feet to a sourwood, N 34-00 E 311 feet to a chestnut oak and service, N 39-00 E 311.2 feet, N 27-30 E 236.2 feet to a spotted oak N 24-00 W 152.8 feet, N 6-00 127 feet N 6-00 E 170.1 feet, N 26-00 W 127.4 feet, N 14-50 W 253.3 feet N 53-30 W 53.2 feet, N 56-45 W 130.3 feet, N 5-45 W 123.3 feet, N 3-30 E 121.2 feet to a chestnut, N 12-15 E 199.6 feet to two chestnut oaks and sourwood on top of the ridge at Jane Brooks line, thence with said line, leaving the ridge, N 22-00 W 170 feet to a rock on the bank of Camp Creek, thence leaving the lines of said Brock and with the lines of S. R. Bailey, up said Creek S 57-30 W 113 feet, S 20-00 W 106.3 feet to a stake, between said creek and the road, S 57-00 W 111.2 feet, N 53-30 W 160 feet to a stake at the foot of a spur ridge, thence running up the same with its meanders S 37-00 E 194, S 26-00 W 153.9 feet to a white oak, S 11-15 W 142 feet, S 6-00 E 56.2 feet to a stake near a leaning white oak, S 6-20 W 295.7 feet to a stake by a beech, S 7-15 N 63.6 feet to a stake corner of J.R. Blanton Tract, thence leave the line of said Bailey Tract and with line of Blanton tract S 12-15 W 358 feet, S 2-00 W 333.5 feet S 1-15 W 371.3 feet, S 13-15 E 236 feet S 42-15 E 112.9 feet, S 52-15 E 149 feet to a stake on a high point South 224.9 feet, S 23-15 E 114 feet, S 6-45 E 212.7 feet, S 21-15 E 73.3 feet, S 15-00 E 277.8 feet to the beginning, containing 70.9 acres more or less.

FLA COORDINATE POINT
 NAD 83
 LATITUDE: 35°45'02.10"
 LONGITUDE: 83°24'43.64"
 NAVD 88
 ELEVATION: 1537.8 AMSL
 NORTHING: 345974.952
 EASTING: 5605745.837

TEMPORARY BENCHMARK
 NORTHING: 345976.899
 EASTING: 5605712.273
 ELEVATION: 1539.29'
 LOCATION: A 600 NAIL
 N18°30'E 62.2' FROM THE
 NORTHWEST CORNER OF THE
 PROPOSED LEASE AREA.

GLOBAL POSITIONING SYSTEMS NOTE

1. THE BOUNDARY CORNERS AND A PORTION OF THE TOPOGRAPHY WAS LOCATED USING GPS.
2. THE TYPE OF GPS UTILIZED WAS NETWORK ADJUSTED REAL TIME KINEMATIC (NODV VRS NETWORK), NAD 83 KENTUCKY SINGLE ZONE WITH THE ORTHOMETRIC HEIGHT COMPUTED USING GEOID12A. RELATIVE POSITIONAL ACCURACY VARIED FROM 0.04" TO 0.09" HORIZONTALLY.
3. SPECTRA PRECISION EPOCH 50 DUAL FREQUENCY RECEIVERS WERE USED TO PERFORM THE SURVEY.

GENERAL NOTES

NO SEARCH OF PUBLIC RECORDS HAS BEEN COMPLETED BY POD GROUP TO DETERMINE ANY DEFECTS AND/OR AMBIGUITIES IN THE TITLE OF THE SUBJECT PROPERTY.

THIS SURVEY IS FOR THE PROPOSED LEASE AREA AND THE PROPOSED ACCESS & UTILITY EASEMENTS ONLY, AND ONLY A PARTIAL BOUNDARY SURVEY OF THE PARENT TRACT HAS BEEN PERFORMED.

A PORTION OF THIS SURVEY WAS CONDUCTED BY METHOD OF RANDOM TRAVERSE WITH SIDE SHOTS. UNADJUSTED CLOSURE EQUALS 0.09'. FOR A PRECISION OF 1:48,144 AND HAS NOT BEEN ADJUSTED.

THIS PROPERTY IS SUBJECT TO ANY RECORDED EASEMENTS AND/OR RIGHTS OF WAY SHOWN HEREON OR NOT.

THIS PLAT IS NOT INTENDED FOR LAND TRANSFER.

THE PARENT PARCEL, THE PROPOSED LEASE AREA, AND THE PROPOSED ACCESS & UTILITY EASEMENT SHOWN HEREON ARE NOT LOCATED IN A 100-YEAR FLOOD PLAIN (ZONE X) PER FLOOD HAZARD BOUNDARY MAP, COMMUNITY MAP NUMBER 21095C0270E, DATED MARCH 16, 2015.

LEGEND



UTILITY POLE
 CHAIN
 EX. OVERHEAD ELECTRIC & TELEPHONE
 EX. FENCE LINE
 SET 1/2" REBAR 18" LONG
 CAPPED "PATTERSON PLS 3136"
 PROPERTY LINE
 ADJACENT PROPERTY LINE

P.O.B. POINT OF BEGINNING
 SPC STATE PLANE COORDINATE
 EX. FENCE LINE
 SET 1/2" REBAR 18" LONG
 CAPPED "PATTERSON PLS 3136"
 PROPERTY LINE
 ADJACENT PROPERTY LINE


LAND SURVEYOR'S CERTIFICATE

I, MARK E. PATTERSON, HEREBY CERTIFY THAT I AM A LICENSED PROFESSIONAL LAND SURVEYOR LICENSED IN COMPLIANCE WITH THE LAWS OF THE COMMONWEALTH OF KENTUCKY. I FURTHER CERTIFY THAT THIS PLAT AND THE SURVEY ON THE GROUND WERE PERFORMED BY PERSONS UNDER MY DIRECT SUPERVISION, AND THAT THE DIRECTIONAL AND LINEAR MEASUREMENTS BEING WITNESSED BY MONUMENTS SHOWN HEREON ARE TRUE AND CORRECT TO THE BEST OF MY KNOWLEDGE, THE "RURAL" SURVEY, AND THE PLAT ON WHICH IT IS BASED, MEETS ALL SPECIFICATIONS AS STATED IN KAR 201:18-150.

Mark Patterson 5/14/2018
 MARK PATTERSON, PLS #3136 DATE

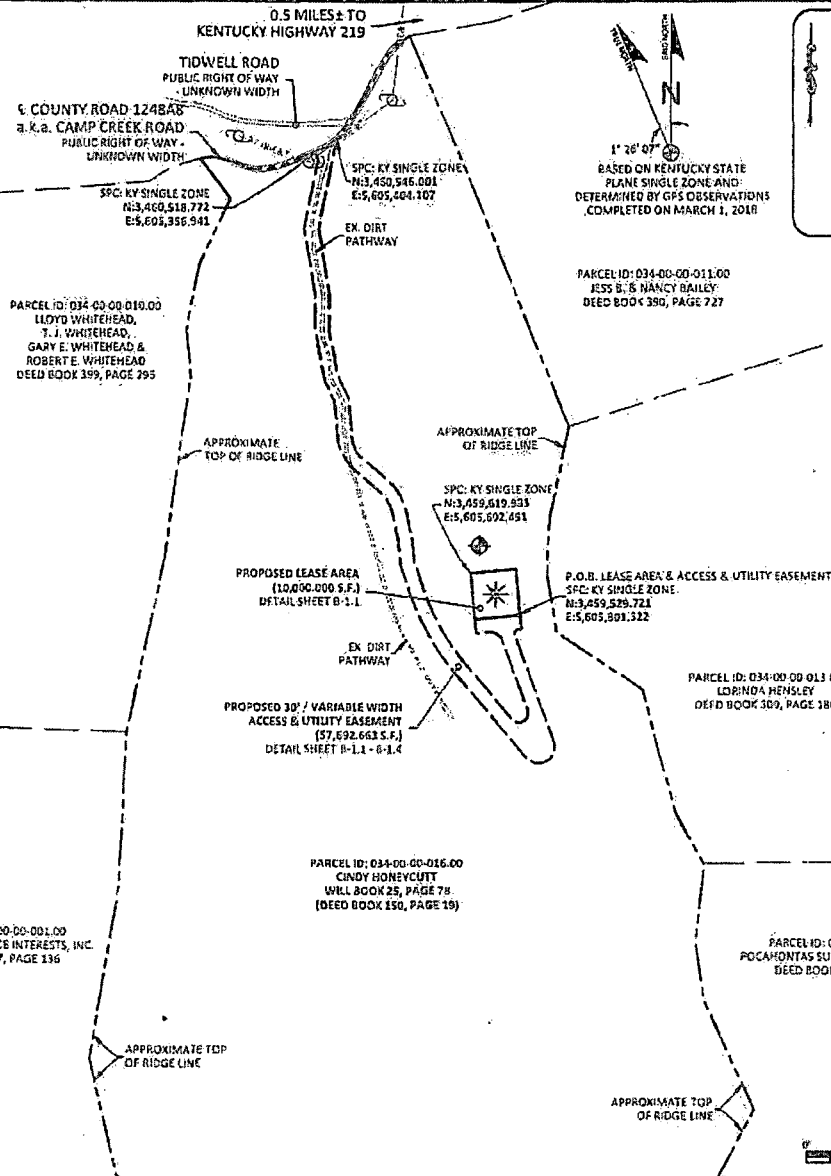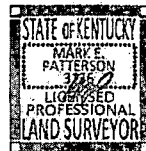

PARCEL ID: 034-00-00-011.00
JESS B. & NANCY BAILEY
DEED BOOK 390, PAGE 727

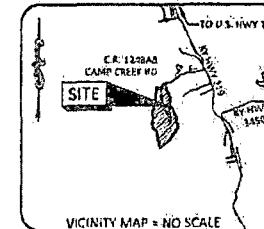

PREPARED BY:
POD
 POWER OF DESIGN
 2400 BLUEGRASS PARKWAY
 HOOVERVILLE, KY 40029
 502-439-9353

PREPARED FOR:
MasTec

PREPARED FOR:
at&t

Chafy Honeycutt
 5-18-18

SITE SURVEY

REV.	DATE	DESCRIPTION
A	0.1.18	PRELIMINARY WITH TITLE
D	5.2.18	REVIEW ACCESS & UTILITY EASEMENT
C	5.4.18	CLIENT COMMENTS
E	5.14.18	ISSUED AS FINAL

SITE INFORMATION:

WALLINS CREEK
 COUNTY ROAD 1248AB
 J.R.A. CAMP CREEK ROAD
 WALLINS CREEK, KY 40873
 HARLAN COUNTY

TAX PARCEL NUMBER:
 034-00-00-016.00

TAX PARCEL ADDRESS:
 O HENSLEY HOLLOW - WALLINS CREEK, KY 40873

PROPERTY OWNER:
 CINDY HONEYCUTT
 P. O. BOX 356
 WHITESBURG, KY 41858

SOURCE OF TITLE:
 WILL BOOK 25, PAGE 78
 (DEED BOOK 150, PAGE 19)

SITE NUMBER:

POD NUMBER: 10-21583
 DRAWN BY: DAP
 CHECKED BY: MEP
 SURVEY DATE: 3.1.18
 PLAT DATE: 4.2.18

SHEET TITLE:

SITE SURVEY
 THIS DOES NOT REPRESENT A
 BOUNDARY SURVEY OF THE
 PARENT PARCEL

SHEET NUMBER: (5 pages)

B-1

GLOBAL POSITIONING SYSTEMS NOTE

1. THE BOUNDARY CORNERS AND A PORTION OF THE TOPOGRAPHY WAS LOCATED USING GPS.
2. THE TYPE OF GPS UTILIZED WAS NETWORK ADJUSTED REAL TIME KINEMATIC (KDOT VRS NETWORK). NAD 83 KENTUCKY SINGLE ZONE WITH THE ORTHOMETRIC HEIGHT COMPUTED USING GEOID124. RELATIVE POSITIONAL ACCURACY VARIED FROM 0.04" TO 0.09" HORIZONTALLY.
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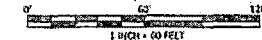
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LEGEND

- P.O.B. POINT OF BEGINNING
- SPC STATE PLANE COORDINATE
- X 1526.7 EX. GROUND ELEVATION
- EX. FENCE LINE
- SET 1/2" REBAR 16" LONG CAPPED "PATTERSON PLS 3136"
- PROPERTY LINE
- ADJACENT PROPERTY LINE



LAND SURVEYOR'S CERTIFICATE

I, MARK E. PATTERSON, HEREBY CERTIFY THAT I AM A LICENSED PROFESSIONAL LAND SURVEYOR LICENSED IN COMPLIANCE WITH THE LAWS OF THE COMMONWEALTH OF KENTUCKY. I FURTHER CERTIFY THAT THIS PLAT AND THE SURVEY ON THE GROUND WERE PERFORMED BY PERSONS UNDER MY DIRECT SUPERVISION, AND THAT THE DIRECTIONAL AND LINEAR MEASUREMENTS BEING WITNESSED BY MONUMENTS SHOWN HEREON ARE TRUE AND CORRECT TO THE BEST OF MY KNOWLEDGE. THE "RURAL" SURVEY, AND THE PLAT ON WHICH IT IS BASED, MEETS ALL SPECIFICATIONS AS STATED IN KAR 201.18.150.

Mark Patterson 5/14/2018
MARK PATTERSON, PLS #3136 DATE



SHEET B-1.2
MATCH LINE

SPC: KY SINGLE ZONE
N: 3,459,619.983
E: 5,605,892.451

PROPOSED
LEASE AREA
(10,000,000 S.F.)

S29°16'22"E
CH=212.07'
R=335.00'

N59°10'22"W
CH=224.00'
R=565.00'

N57°49'45"W
CH=36.53'
R=30.00'

N59°27'59"E
CH=39.37'
R=22.00'

S59°27'59"W
CH=68.60'
R=35.00'

N59°10'22"W
CH=224.00'
R=565.00'

S59°27'59"E
CH=39.37'
R=22.00'

N59°10'22"W
CH=224.00'
R=565.00'

S59°27'59"W
CH=68.60'
R=35.00'

N59°10'22"W
CH=224.00'
R=565.00'

S59°27'59"E
CH=39.37'
R=22.00'

N59°10'22"W
CH=224.00'
R=565.00'

S59°27'59"W
CH=68.60'
R=35.00'

PARCEL ID:
034-00-00-013.00
(BRINDA HENSLEY
DEED BOOK 309, PAGE 180)

3" 26' 07"
BASED ON KENTUCKY STATE
PLANE SINGLE ZONE AND
DETERMINED BY GPS OBSERVATIONS
COMPLETED ON MARCH 7, 2018

FAA COORDINATE POINT
NAD 83
LATITUDE: 36°48'02.36"
LONGITUDE: 83°24'43.64"
NAVD 88
ELEVATION: 1517.4 AMSL
NORTHING: 3459574.852
EASTING: 5605746.867

TEMPORARY BENCHMARK
NORTHING: 3459678.839
EASTING: 5605712.273
ELEVATION: 1539.25'
LOCATION: A 600 NAIL
N18°16'E 62.2' FROM THE
NORTHWEST CORNER OF THE
PROPOSED LEASE AREA.

PARCEL ID: 034-00-00-016.00
CINDY HONEYCUTT
WILL BOOK 25, PAGE 78
(DEED BOOK 150, PAGE 19)

APPROXIMATE TOP
OF RIDGE LINE

PROPOSED 30' / VARIABLE WIDTH
ACCESS & UTILITY EASEMENT
(57,692.663 S.F.)

PREPARED BY: 14400 HILLCROSS PARKWAY LOUISVILLE, KY 40299 502-455-0332		
PREPARED FOR: 		
PREPARED FOR: 		
<i>Cindy Honeycutt</i> 5-18-18 SITE SURVEY		
REV	DATE	DESCRIPTION
A	4.11.18	PRELIM ISSUE WITH TITLE
B	5.2.18	REVISED ACCESS & UTILITY EASEMENT
C	5.4.18	CLIENT COMMENTS
D	5.14.18	ISSUED AS FINAL
SITE INFORMATION: WALLINS CREEK COUNTY ROAD 1248AS R.R. CAMP CREEK ROAD WALLINS CREEK, KY 40873 HANLAN COUNTY TAX PARCEL NUMBER: 034-00-00-016.00 TAX PARCEL ADDRESS: 0 HENSLEY HOLLOW - WALLINS CREEK, KY 40873 PROPERTY OWNER: CINDY HONEYCUTT P.O. BOX 356 WHITEBURG, KY 41856 SOURCE OF TITLE: WILL BOOK 25, PAGE 78 (DEED BOOK 150, PAGE 19)		
SITE NUMBER: 18-21589		
POD NUMBER: 18-21589 DRAWN BY: DAP CHECKED BY: MEP SURVEY DATE: 3.1.18 PLAT DATE: 4.2.18		
SHEET TITLE: SITE SURVEY THIS DOES NOT REPRESENT A BOUNDARY SURVEY OF THE PARENT PARCEL		
SHEET NUMBER: (5 pages) B-1.1		

GENERAL NOTES

NO SEARCH OF PUBLIC RECORDS HAS BEEN COMPLETED BY POD GROUP TO DETERMINE ANY DEFECTS AND/OR AMBIGUITIES IN THE TITLE OF THE SUBJECT PROPERTY.

THIS SURVEY IS FOR THE PROPOSED LEASE AREA AND THE PROPOSED ACCESS & UTILITY EASEMENTS ONLY, AND ONLY A PARTIAL BOUNDARY SURVEY OF THE PARENT TRACT HAS BEEN PERFORMED.

A PORTION OF THIS SURVEY WAS CONDUCTED BY METHOD OF RANDOM TRAVERSE WITH SIDE SHOTS. UNADJUSTED CLOSURE EQUALS 0.09', FOR A PRECISION OF 1:48,144 AND HAS NOT BEEN ADJUSTED.

THIS PROPERTY IS SUBJECT TO ANY RECORDED EASEMENTS AND/OR RIGHTS OF WAY SHOWN HEREON OR NOT.

THIS PLAT IS NOT INTENDED FOR LAND TRANSFER.

THE PARENT PARCEL, THE PROPOSED LEASE AREA, AND THE PROPOSED ACCESS & UTILITY EASEMENT SHOWN HEREON ARE NOT LOCATED IN A 100-YEAR FLOOD PLAIN (ZONE X) PER FLOOD HAZARD BOUNDARY MAP, COMMUNITY-PANEL NUMBER 210500270E, DATED MARCH 16, 2015.

FAX COORDINATE POINT

NAD 83
LATITUDE: 36°45'01.36"
LONGITUDE: 83°24'43.66"
NAVD 88
ELEVATION: 1537.7 ANSL
NORTHING: 3459574.952
EASTING: 5605745.887

TEMPORARY BENCHMARK

NORTHING: 3459678.899
EASTING: 5605712.273
ELEVATION: 1539.23'
LOCATION: A 600 NAIL
N18°36'E 62.2' FROM THE
NORTHWEST CORNER OF THE
PROPOSED LEASE AREA.

1" = 26' 07"
BASED ON KENTUCKY STATE
PLANE SINGLE ZONE AND
DETERMINED BY GPS OBSERVATIONS
COMPLETED ON MARCH 1, 2018

PREPARED BY:
POD
POWER-TO-DESIGN

18800 BLUEGRASS PARKWAY
LOUISVILLE, KY 40259
502-453-9220

PREPARED FOR:
MasTec

PREPARED FOR:
at&t

Cindy Horeycutt
5-18-18

PARCEL ID: 034-00-00-011.00
JESS B. & NANCY BAILEY
DEED BOOK 390, PAGE 727

SITE SURVEY

REV.	DATE	DESCRIPTION
A	4.1.18	PRELIM ISSUE WITH TITLE
B	5.2.18	REVISED ACCESS & UTILITY EASEMENT
C	5.4.18	CLIENT COMMENTS
D	5.14.18	ISSUED AS FINAL

SITE INFORMATION:

WALLINS CREEK
COUNTY ROAD 13-808A
A.K.A. CAMP CREEK ROAD
WALLINS CREEK, KY 40273
HARLAN COUNTY

TAX PARCEL NUMBER:
034-00-00-016.00
TAX PARCEL ADDRESS:
O HENSLEY HOLLOW, WALLINS CREEK, KY 40273

PROPERTY OWNER:
CINDY HOREYCUITT
P.O. BOX 355
WHITESBURG, KY 41856

SOURCE OF TITLE:
WILL BOOK 25, PAGE 78
(DEED BOOK 150, PAGE 19)

SITE NUMBER:

POD NUMBER: 18-21559
DRAWN BY: DAP
CHECKED BY: MEP
SURVEY DATE: 5.1.18
PLAT DATE: 4.2.18

SHEET TITLE:

SITE SURVEY
THIS DOES NOT REPRESENT A
BOUNDARY SURVEY OF THE
PARENT PARCEL

SHEET NUMBER: (5 pages)

B-1.3

GLOBAL POSITIONING SYSTEMS NOTE

1. THE BOUNDARY CORNERS AND A PORTION OF THE TOPOGRAPHY WAS LOCATED USING GPS.
2. THE TYPE OF GPS UTILIZED WAS NETWORK ADJUSTED REAL TIME KINEMATIC (KDOT VRS NETWORK). NAD 83 KENTUCKY SINGLE ZONE WITH THE DATUMS TIE HEIGHT COMPUTED USING GEOID12A. RELATIVE POSITIONAL ACCURACY VARIED FROM 0.04' TO 0.09' HORIZONTALLY.
3. SPECTRA PRECISION EPOCH 50 DUAL FREQUENCY RECEIVERS WERE USED TO PERFORM THE SURVEY.

LEGEND

UTILITY POLE

POINT OF BEGINNING

STATE PLANE COORDINATE

X 1500 EX. GROUND ELEVATION

EX. OVERHEAD ELECTRIC & TELEPHONE

EX. FENCE LINE

SET 1/2" REBAR 18" LONG

CAPPED "PATTERSON PLS 3136"

PROPERTY LINE

ADJACENT PROPERTY LINE

LAND SURVEYOR'S CERTIFICATE

I, MARK E. PATTERSON, HEREBY CERTIFY THAT I AM A LICENSED PROFESSIONAL LAND SURVEYOR LICENSED IN COMPLIANCE WITH THE LAWS OF THE COMMONWEALTH OF KENTUCKY. I FURTHER CERTIFY THAT THIS PLAT AND THE SURVEY ON THE GROUND WERE PERFORMED BY PERSONS UNDER MY DIRECT SUPERVISION, AND THAT THE DIRECTIONAL AND LINEAR MEASUREMENTS BEING WITNESSED BY MONUMENTS SHOWN HEREON ARE TRUE AND CORRECT TO THE BEST OF MY KNOWLEDGE. THE "NATURAL" SURVEY, AND THE PLAT ON WHICH IT IS BASED, MEETS ALL SPECIFICATIONS AS STATED IN KAR 201 18-150.



Mark Patterson
MARK PATTERSON, PLS 03136

5/14/2018

DATE



1-800-752-6007

POD GROUP, INC.

1-800-752-6007

POD GROUP, INC.

POD GROUP, INC.

POD GROUP, INC.

POD GROUP, INC.

POD GROUP, INC.

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POD GROUP, INC.

POD GROUP, INC.

POD GROUP, INC.

LEGAL DESCRIPTIONS

PROPOSED LEASE AREA

THE FOLLOWING IS A DESCRIPTION OF THE PROPOSED LEASE AREA TO BE LEASED FROM THE PROPERTY CONVEYED TO CINDY HONEYCUTT AS RECORDED IN THE OFFICE OF THE CLERK OF HARLAN COUNTY, KENTUCKY AS WILL BOOK 25, PAGE 78, BEING THE SAME PROPERTY CONVEYED TO HAGAN & WILMA HONEYCUTT AS DESCRIBED IN DEED BOOK 150, PAGE 19, PARCEL ID: 034-00-00-016-00, WHICH IS MORE PARTICULARLY DESCRIBED AS FOLLOWS:

BEARING DATUM USED HEREIN IS BASED UPON KENTUCKY STATE PLANE COORDINATE SYSTEM, SINGLE ZONE, NAD 83, FROM A REAL TIME KINEMATIC GLOBAL POSITIONING SYSTEM OBSERVATION USING THE KENTUCKY TRANSPORTATION CABINET REAL TIME GPS NETWORK COMPLETED ON MARCH 1, 2018.

BEGINNING TO A SET 1/2" REBAR, 18" LONG, CAPPED "PATTERSON PLS 3136", HEREAFTER REFERRED TO AS A "SET IPC" AT THE SOUTHEAST CORNER OF THE PROPOSED LEASE AREA WITH A STATE PLANE COORDINATE, KENTUCKY SINGLE ZONE VALUE OF N 3,459,529.721 & E 5,605,801.322, ON THE PROPERTY CONVEYED TO CINDY HONEYCUTT AS RECORDED IN THE OFFICE OF THE CLERK OF HARLAN COUNTY, KENTUCKY AS WILL BOOK 25, PAGE 78, BEING THE SAME PROPERTY CONVEYED TO HAGAN & WILMA HONEYCUTT AS DESCRIBED IN DEED BOOK 150, PAGE 19, PARCEL ID: 034-00-00-016-00, THENCE S84°39'40"W 109.00' TO A SET IPC; THENCE N05°20'20"W 100.00' TO A SET IPC, WITH A STATE PLANE COORDINATE, KENTUCKY SINGLE ZONE VALUE OF N 3,459,619.933 & E 5,605,892.451 IN THE NORTHWEST CORNER OF SAID LEASE AREA, THENCE N84°39'40"E 100.00' TO A SET IPC; THENCE S05°20'20"E 100.00' TO THE POINT OF BEGINNING CONTAINING 10,000.000 SQUARE FEET AS PER SURVEY BY MARK E. PATTERSON, PLS #3136 DATED MARCH 1, 2018.

PROPOSED 30' VARIABLE WIDTH ACCESS & UTILITY EASEMENT

THE FOLLOWING IS A DESCRIPTION OF THE PROPOSED 30' VARIABLE WIDTH ACCESS & UTILITY EASEMENT TO BE GRANTED FROM THE PROPERTY CONVEYED TO CINDY HONEYCUTT AS RECORDED IN THE OFFICE OF THE CLERK OF HARLAN COUNTY, KENTUCKY AS WILL BOOK 25, PAGE 78, BEING THE SAME PROPERTY CONVEYED TO HAGAN & WILMA HONEYCUTT AS DESCRIBED IN DEED BOOK 150, PAGE 19, PARCEL ID: 034-00-00-016-00, WHICH IS MORE PARTICULARLY DESCRIBED AS FOLLOWS:

BEARING DATUM USED HEREIN IS BASED UPON KENTUCKY STATE PLANE COORDINATE SYSTEM, SINGLE ZONE, NAD 83, FROM A REAL TIME KINEMATIC GLOBAL POSITIONING SYSTEM OBSERVATION USING THE KENTUCKY TRANSPORTATION CABINET REAL TIME GPS NETWORK COMPLETED ON MARCH 1, 2018.

BEGINNING TO A SET 1/2" REBAR, 18" LONG, CAPPED "PATTERSON PLS 3136", HEREAFTER REFERRED TO AS A "SET IPC" AT THE SOUTHEAST CORNER OF THE PROPOSED LEASE AREA WITH A STATE PLANE COORDINATE, KENTUCKY SINGLE ZONE VALUE OF N 3,459,529.721 & E 5,605,801.322, ON THE PROPERTY CONVEYED TO CINDY HONEYCUTT AS RECORDED IN THE OFFICE OF THE CLERK OF HARLAN COUNTY, KENTUCKY AS WILL BOOK 25, PAGE 78, BEING THE SAME PROPERTY CONVEYED TO HAGAN & WILMA HONEYCUTT AS DESCRIBED IN DEED BOOK 150, PAGE 19, PARCEL ID: 034-00-00-016-00, THENCE LEAVING SAID LEASE AREA, S05°20'20"E 100.00', THENCE S84°39'40"W 5.80', THENCE WITH THE CHORD OF A CURVE TO THE LEFT HAVING A RADIUS OF 10.00', S31°10'15"W 16.37', THENCE S20°14'07"E 243.11', THENCE WITH THE CHORD OF A CURVE TO THE RIGHT HAVING A RADIUS OF 35.00', S59°27'39"W 68.89', THENCE N40°44'27"W 224.28', THENCE WITH THE CHORD OF A CURVE TO THE RIGHT HAVING A RADIUS OF 505.00', N19°15'22"E 724.80', THENCE N17°47'52"W 51.09', THENCE N04°27'33"W 47.37', THENCE N11°37'35"W 60.41', THENCE WITH THE CHORD OF A CURVE TO THE LEFT HAVING A RADIUS OF 91.00', N30°47'09"W 59.77', THENCE N49°36'42"W 71.23', THENCE WITH THE CHORD OF A CURVE TO THE RIGHT HAVING A RADIUS OF 101.20', N27°34'11"W 76.90', THENCE N05°11'59"W 79.29', THENCE N11°35'58"E 143.40', THENCE N22°34'32"W 19.21' TO THE CENTER OF COUNTY ROAD 1246AB (A.K.A. CAMP CREEK ROAD) HAVING A STATE PLANE COORDINATE, KENTUCKY SINGLE ZONE VALUE OF N 3,459,518.772 & E 5,605,566.941; THENCE WITH THE CENTER OF SAID ROAD, N67°25'20"E 12.00'; THENCE WITH THE CHORD OF A CURVE TO THE LEFT HAVING A RADIUS OF 104.20', N57°45'55"E 45.59' HAVING A STATE PLANE COORDINATE, KENTUCKY SINGLE ZONE VALUE OF N 3,460,545.001 & E 5,605,404.107; THENCE LEAVING SAID CENTER OF ROAD AND TRAVELING ACROSS THE PROPERTY OF HONEYCUTT, S11°31'58"W 195.89'; THENCE S09°33'30"E 190.10'; THENCE S00°17'44"W 74.50'; THENCE S10°20'36"E 100.27'; THENCE S27°32'01"E 51.14'; THENCE S05°11'39"E 84.91'; THENCE WITH THE CHORD OF A CURVE TO THE LEFT HAVING A RADIUS OF 71.00', S27°31'11"E 54.08'; THENCE S49°59'42"E 71.23'; THENCE WITH THE CHORD OF A CURVE TO THE LEFT HAVING A RADIUS OF 121.00', S30°47'09"E 79.42'; THENCE S11°37'35"E 61.26'; THENCE S01°27'33"E 45.74'; THENCE S17°47'32"E 47.58'; THENCE WITH THE CHORD OF A CURVE TO THE LEFT HAVING A RADIUS OF 55.00', S29°18'22"E 112.07'; THENCE S04°44'27"E 141.07'; THENCE WITH THE CHORD OF A CURVE TO THE LEFT HAVING A RADIUS OF 20.00', N59°27'59"E 38.37'; THENCE N20°19'10"W 157.69'; THENCE WITH THE CHORD OF A CURVE TO THE LEFT HAVING A RADIUS OF 10.00', N57°49'45"W 36.53'; THENCE S84°39'40"W 27.09'; THENCE N05°20'20"W 30.00' TO A SET IPC IN THE SOUTHWEST CORNER OF SAID LEASE AREA; THENCE WITH SAID LEASE AREA, N84°39'40"E 100.00' TO THE POINT OF BEGINNING CONTAINING 57,692.653 SQUARE FEET AS PER SURVEY BY MARK E. PATTERSON, PLS #3136 DATED MARCH 1, 2018.

PARENT PARCEL, LEGAL DESCRIPTION, WILL BOOK 25, PAGE 78 (DEED BOOK 150, PAGE 19) (NOT FIELD SURVEYED)

BEGINNING AT TWO CHESTNUT OAKS ON THE POINT OF A RIDGE A CORNER TO JOHN R. BLANTON TRACT, OWNED BY KENTONIA CORPORATION; THENCE DOWN WITH THE MEANDERS OF THE RIDGE BETWEEN COAL HOLLOW AND LUCK HOLLOW, N 29-30 E 39 FEET N 57-15 E 125.8 FEET, N 51-30 E 323.2 FEET, N 45-30 E 290 FEET TO A SOUTHWOOD N 34-60 E 311 FEET TO A CHESTNUT OAK AND SERVICE, N 29-30 E 111.2 FEET, N 27-30 E 202.2 FEET TO A SPOTTED OAK N 24-00 W 152.8 FEET, N 6-00 E 127 FEET N 6-00 E 170.2 FEET, N 23-00 W 127.4 FEET, N 14-50 W 268.4 FEET N 35-30 W 93.2 FEET, N 56-45 W 130.3 FEET, N 9-45 W 125.8 FEET, N 3-30 E 121.2 FEET TO A CHESTNUT, N 12-15 E 198.2 FEET TO TWO CHESTNUT OAKS AND SOUTHWOOD ON TOP OF THE RIDGE AT JANE BROCK'S LINE, THENCE WITH SAID LINE, LEAVING THE RIDGE, N 22-30 W 870 FEET TO A ROCK ON THE BANK OF CAMP CREEK; THENCE LEAVING THE LINES OF SAID BROCK AND WITH THE LINES OF S. H. BAILEY, UP SAID CREEK S 57-30 W 123 FEET, S 70-00 W 108.5 FEET TO A STAKE, BETWEEN SAID CREEK AND THE ROAD, S 87-00 W 221.2 FEET, N 55-30 W 160 FEET TO A STAKE AT THE FOOT OF A SPUR RIDGE, THENCE RUNNING UP THE SAME WITH ITS MEANDERS S 37-00 E 134, S 24-00 W 258.4 FEET TO A WHITE OAK, S 11-15 W 142 FEET, S 6-00 E 56.7 FEET TO A STAKE NEAR A LEANING WHITE OAK, S 8-20 W 255.7 FEET TO A STAKE BY A BEECH, S 7-15 W 83.6 FEET TO A STAKE CORNER OF J. R. BLANTON TRACT, THENCE LEAVE THE LINE OF SAID BAILEY TRACT AND WITH LINE OF BLANTON TRACT S 12-15 W 158 FEET, S 3-20 W 331.5 FEET, S 1-15 W 371.5 FEET, S 23-15 E 236 FEET S 42-15 E 142.8 FEET, S 58-15 E 149 FEET TO A STAKE ON A HIGH POINT SOUTH 224.8 FEET, S 29-15 E 114 FEET, S 6-45 E 218.7 FEET, S 21-15 E 78.8 FEET, S 15-00 E 277.5 FEET TO THE BEGINNING, CONTAINING 70.9 ACRES MORE OR LESS.

REPORT OF TITLE (PARCEL 034-00-00-016-00) HARLAN COUNTY

THIS SURVEY DOES NOT CONSTITUTE A TITLE SEARCH BY POD GROUP, LLC AND AS SUCH WE ARE NOT RESPONSIBLE FOR THE INVESTIGATION OR INDEPENDENT SEARCH FOR EASEMENTS OF RECORD, ENCUMBRANCES, RESTRICTIVE COVENANTS, OWNERSHIP TITLE EVIDENCE, UNRECORDED EASEMENTS, AUGMENTING EASEMENTS, IMPLIED OR PRESCRIPTIVE EASEMENTS, OR ANY OTHER FACTS THAT AN ACCURATE AND CURRENT TITLE SEARCH MAY DISCLOSE AND THIS SURVEY WAS COMPLETED WITH THE AID OF TITLE WORK PREPARED BY US TITLE SOLUTIONS, FOR THE BENEFIT OF MASTEC NETWORK SOLUTIONS, ON BEHALF OF AT&T, FILE NO. 58823-11711-5030, REFERENCE NO. FA13890720, ISSUE DATE OF DECEMBER 8, 2017. THE FOLLOWING COMMENTS ARE IN REGARD TO SAID REPORT.

SCHEDULE B

1. TAXES, TAX LIENS, TAX SALES, WATER RATES, SEWER AND ASSESSMENTS SET FORTH IN SCHEDULE HEREIN. TAX ID: 034-00-00-016-00 - PERIOD: 2017 - PAYMENT STATUS: PAID - TAX AMOUNT: \$61.09 (NOT A SURVEY MATTER, THEREFORE POD GROUP, LLC DID NOT EXAMINE OR ADDRESS THIS ITEM.)
2. MORTGAGES RETURNED HEREIN. (0 - SEE SEPARATE MORTGAGE SCHEDULE. NONE WITHIN PERIOD SEARCHED)
3. ANY STATE OF FACTS WHICH AN ACCURATE SURVEY MIGHT SHOW OR SURVEY EXCEPTIONS SET FORTH HEREIN. (POD GROUP, LLC DID NOT PERFORM A BOUNDARY SURVEY, THEREFORE WE DID NOT ADDRESS THIS ITEM.)

4. RIGHTS OF TENANTS OR PERSON IN POSSESSION. (NOT A SURVEY MATTER, THEREFORE POD GROUP, LLC DID NOT EXAMINE OR ADDRESS THIS ITEM.)

(JUDGMENTS, LIENS AND UCC)

5. NONE WITHIN PERIOD SEARCHED (COVENANTS/RESTRICTIONS)
6. NONE WITHIN PERIOD SEARCHED

7. NONE WITHIN PERIOD SEARCHED (EASEMENTS AND RIGHTS OF WAY)
8. NONE WITHIN PERIOD SEARCHED

(OTHER FILED DOCUMENTS)


9. LEASE AGREEMENT BETWEEN HAGAN & WILMA HONEYCUTT AND LINDA DAY DATED 6/5/1984 RECORDED 6/12/1984 IN BOOK 23 PAGE 369. (LEASE AS RECORDED IN BOOK 29, PAGE 369 IS FOR ALL OF THE COAL AND MINING RIGHTS, LEASE AFFECTS THE PARENT PARCEL, THE PROPOSED LEASE AREA AND THE PROPOSED ACCESS & UTILITY EASEMENT.)
10. LEASE AGREEMENT BETWEEN HAGAN & WILMA HONEYCUTT AND LINDA DAY DATED 6/13/1984 RECORDED 6/13/1984 IN BOOK 29 PAGE 385. (LEASE AS RECORDED IN BOOK 29, PAGE 385 IS FOR ALL OF THE COAL AND MINING RIGHTS, LEASE AFFECTS THE PARENT PARCEL, THE PROPOSED LEASE AREA AND THE PROPOSED ACCESS & UTILITY EASEMENT.)
11. PROBATE ORDER BETWEEN THE ESTATE OF WILMA HONEYCUTT, DECEASED AND HAGAN H. HONEYCUTT DATED 7/23/1993 RECORDED 7/26/1993 IN BOOK 21 PAGE 100. (ORDER AS RECORDED IN BOOK 21, PAGE 100 AFFECTS THE PARENT PARCEL, LEAVING SAID REAL ESTATE TO HAGAN H. HONEYCUTT.)
12. PROBATE ORDER BETWEEN LAST WILL AND TESTAMENT OF HAGAN HONEYCUTT, DECEASED AND CINDY HONEYCUTT DATED 1/20/1998 RECORDED 3/23/1998 IN BOOK 25 PAGE 78. (ORDER AS RECORDED IN BOOK 25, PAGE 78 AFFECTS THE PARENT PARCEL, LEAVING SAID REAL ESTATE TO CINDY HONEYCUTT.)

LAND SURVEYOR'S CERTIFICATE:

I, MARK E. PATTERSON, HEREBY CERTIFY THAT I AM A LICENSED PROFESSIONAL LAND SURVEYOR LICENSED IN COMPLIANCE WITH THE LAWS OF THE COMMONWEALTH OF KENTUCKY. I FURTHER CERTIFY THAT THIS PLAT AND THE SURVEY ON THE GROUND WERE PERFORMED BY PERSONS UNDER MY DIRECT SUPERVISION, AND THAT THE DIRECTIONAL AND LINEAR MEASUREMENTS BEING WITNESSED BY MONUMENTS SHOWN HEREON ARE TRUE AND CORRECT TO THE BEST OF MY KNOWLEDGE. THE "RURAL" SURVEY, AND THE PLAT ON WHICH IT IS BASED, MEETS ALL SPECIFICATIONS AS STATED IN EAR 201 38-150.



Mark Patterson 5/14/2018
MARK PATTERSON, PLS #3136 DATE

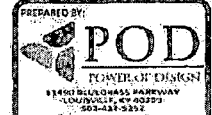

Cindy Honeycutt
5-187

SITE SURVEY

REV.	DATE	DESCRIPTION
A	4.1.18	PRELIMINARY WITH TITLE
B	5.2.18	REVISED ACCESS & UTILITY EASEMENT
C	5.4.18	CLIENT COMMENTS
D	5.14.18	ISSUED AS FINAL

SITE INFORMATION:

WALLIS CREEK
COUNTY ROAD 1246AB
A.K.A. CAMP CREEK ROAD
WALLIS CREEK, KY 40873
HARLAN COUNTY

TAX PARCEL NUMBER:

034-00-00-016-00

TAX PARCEL ADDRESS:

O HENSLEY HOLLOW - WALLIS CREEK, KY 40873

PROPERTY OWNER:

CINDY HONEYCUTT

P. O. BOX 156

WHITESBURG, KY 41858

SOURCE OF TITLE: WILL BOOK 25, PAGE 78

(DEED BOOK 150, PAGE 19)

SITE NUMBER:

POD NUMBER: 13-21589

DRAWN BY: DAP

CHECKED BY: MEP

SURVEY DATE: 3.1.18

PLAT DATE: 4.2.18

SHEET TITLE:

SITE SURVEY

THIS DOES NOT REPRESENT A BOUNDARY SURVEY OF THE PARENT PARCEL

SHEET NUMBER: (5 pages)

B-1.4

EXHIBIT 11

ENVIRONMENTAL DISCLOSURE

Landlord represents and warrants that the Property, as of the date of this Agreement, is free of hazardous substances except as follows:

1. NONE.

[Landlord Letterhead]

DATE

Building Staff / Security Staff
Landlord, Lessee, Licensee
Street Address
City, State, Zip

Re: Authorized Access granted to AT&T

Dear Building and Security Staff,

Please be advised that we have signed a lease with AT&T permitting AT&T to install, operate and maintain telecommunications equipment at the property. The terms of the lease grant AT&T and its representatives, employees, agents and subcontractors ("representatives") 24 hour per day, 7 day per week access to the leased area.

To avoid impact on telephone service during the day, AT&T representatives may be seeking access to the property outside of normal business hours. AT&T representatives have been instructed to keep noise levels at a minimum during their visit.

Please grant the bearer of a copy of this letter access to the property and to leased area. Thank you for your assistance.

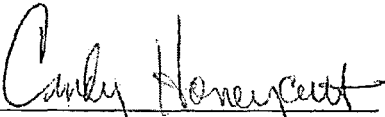
→ 
Landlord Signature

EXHIBIT J
NOTIFICATION LISTING

NOTIFICATION LISTING
SITE NAME: WALLINS CREEK

HONEYCUTT HAGAN & WILMA
c/o CINDY HONEYCUTT
PO BOX 356
WHITESBURG, KY 41858

BLANTON OXIE & MARY BAILEY
c/o ARRINGTON EDNA
10209 BLUFF SPRINGS TRACE
LOUISVILLE, KY 40223

HENSLEY MOSS & RINDA
PO BOX 222
WALLINS, KY 40873

POCAHONTAS SURFACE INTERESTS INC
THREE COMMERCIAL PLACE
NORFOLK, VA 23510

WHITEHEAD LLOYD ETAL
c/o ROBERT WHITEHEAD
3703 PAINTCREEK RD
STANTON, KY 40380

TIDWELL BILL & BEULAH
PO BOX 111
WALLINS, KY 40873

TIDWELL MARSHA
2339 HWY 215
EVARTS, KY 40828

NIDAY PATTY
346 HWY 219
WALLINS, KY 40873

BLANTON GROVER
c/o ARRINGTON EDNA
10209 BLUFF SPRINGS TRACE
LOUISVILLE, KY 40223

BROCK RICHARD L
1607 WOODBURN AVE
COVINGTON, KY 41011

PARK HOWARD CEMETERY
c/o EVERETT JONES & R TIDWELL
GEN DEL
WALLINS, KY 40873

EVANS JAMES OTIS & HOLLY EVANS
PO BOX 884
WALLINS, KY 40873

GROSS JAMES V
PO BOX 923
WALLINS, KY 40873

MCMILLIAN MICHAEL & ROBIN
PO BOX 324
WALLINS, KY 40873

HENSLEY CHARLES
PO BOX 222
WALLINS CREEK, KY 40873

HENSLEY ARLIS & MILDRED
269 HENSLEY LANE
WALLINS CREEK, KY 40873

HENSLEY WENDELL & HENRIETTA
PO BOX 320
WALLINS, KY 40873

BLANTON GROVER
c/o ARRINGTON EDNA
10209 BLUFF SPRINGS TRACE
LOUISVILLE, KY 40223

EXHIBIT K
COPY OF PROPERTY OWNER NOTIFICATION



1578 Highway 44 East, Suite 6
P.O. Box 369
Shepherdsville, KY 40165-0369
Phone (502) 955-4400 or (800) 516-4293
Fax (502) 543-4410 or (800) 541-4410

**Notice of Proposed Construction of
Wireless Communications Facility
Site Name: Wallins Creek**

Dear Landowner:

New Cingular Wireless PCS, LLC, a Delaware Limited Liability Company, d/b/a AT&T Mobility has filed an application with the Kentucky Public Service Commission ("PSC") to construct a new wireless communications facility on a site located at County Road 1248A8 a.k.a. Camp Creek Road, Wallins Creek, Kentucky 40873 (36°48'02.36" North latitude, 83°24'43.64" West longitude). The proposed facility will include a 255-foot tall antenna tower, plus a 15-foot lightning arrestor and related ground facilities. This facility is needed to provide improved coverage for wireless communications in the area.

This notice is being sent to you because the County Property Valuation Administrator's records indicate that you may own property that is within a 500' radius of the proposed tower site or contiguous to the property on which the tower is to be constructed. You have a right to submit testimony to the Kentucky Public Service Commission ("PSC"), either in writing or to request intervention in the PSC's proceedings on the application. You may contact the PSC for additional information concerning this matter at: Kentucky Public Service Commission, Executive Director, 211 Sower Boulevard, P.O. Box 615, Frankfort, Kentucky 40602. Please refer to docket number 2018-00340 in any correspondence sent in connection with this matter.

In addition to expanding and improving voice and data service for AT&T mobile customers, this site will also provide wireless local loop ("WLL") broadband internet service to homes and businesses in the area. WLL will support internet access at the high speeds required to use and enjoy the most current business, education and entertainment technologies.


We have attached a map showing the site location for the proposed tower. Applicant's radio frequency engineers assisted in selecting the proposed site for the facility, and they have determined it is the proper location and elevation needed to provide quality service to wireless customers in the area. Please feel free to contact us toll free at (800) 516-4293 if you have any comments or questions about this proposal.

Sincerely,
David A. Pike
Attorney for Applicant

enclosure

Site Name: Wallins Creek
Driving Directions to Proposed Tower Site

1. Beginning at the offices of the Harlan County Clerk located at 210 E. Central Street, Harlan, Kentucky.
2. Start out going west on E Central St toward N 1St St.
3. Take the 3rd right onto S US Highway 421/US-421 N.
4. Turn left onto S US Highway 119/US-119 S.
5. Turn left onto State Highway 3461/KY-3461.
6. Turn slight left onto Highway 219/KY-219.
7. Turn right onto Camp Creek Rd.
8. Arrive at County Road 1248A8 a.k.a. Camp Creek Road, Wallins Creek, Kentucky 40873 on the left.
9. The site coordinates are 36°48'02.36" North latitude, 83°24'43.64" West longitude.

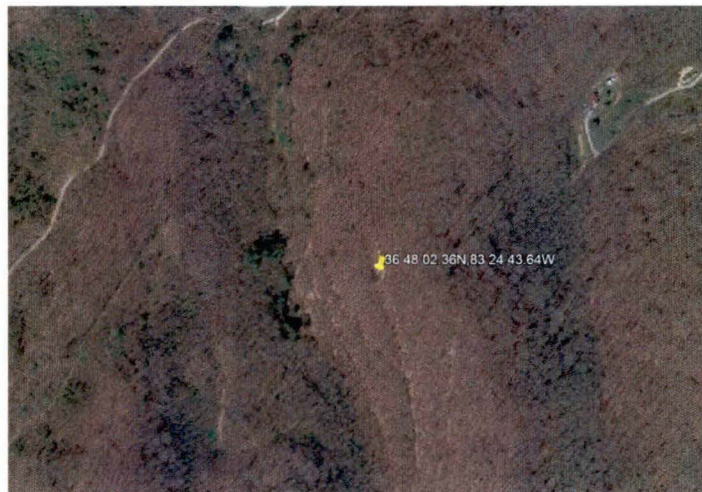

Prepared by:
Robert W. Grant
Pike Legal Group PLLC
1578 Highway 44 East, Suite 6
P.O. Box 369
Shepherdsville, KY 40165-3069
Telephone: 502-955-4400 or 800-516-4293

PARCEL ID: 034-00-00-016.00
HONEYCUTT HAGAN & WILMA
c/o CINDY HONEYCUTT
PO BOX 356
WHITESBURG, KY 41858

PARCEL ID: 034-00-00-011.00
BLANTON OXIE & MARY BAILEY
c/o ARRINGTON EDNA
10209 BLUFF SPRINGS TRACE
LOUISVILLE, KY 40223

PARCEL ID: 034-00-00-013.00
HENSLEY MOSS & RINDA
PO BOX 222
WALLINS, KY 40873

PARCEL ID: 023-00-00-001.00
POCAHONTAS SURFACE INTERESTS INC
THREE COMMERCIAL PLACE
NORFOLK, VA 23510

PARCEL ID: 034-00-00-010.00
WHITEHEAD LLOYD ETAL
c/o ROBERT WHITEHEAD
3703 PAINTCREEK RD
STANTON, KY 40380

PARCEL ID: 034-00-00-008.00
TIDWELL BILL & BEULAH
PO BOX 111
WALLINS, KY 40873

PARCEL ID: 034-00-00-008.01
TIDWELL MARSHA
2339 HWY 215
EVARTS, KY 40828

PARCEL ID: 034-30-00-074.00
MIDAY PATTY
346 HWY 219
WALLINS, KY 40873

PARCEL ID: 034-00-00-007.00
BLANTON GROVER
c/o ARRINGTON EDNA
10209 BLUFF SPRINGS TRACE
LOUISVILLE, KY 40223

PARCEL ID: 034-30-00-076.00
BROCK RICHARD L
1607 WOODBURN AVE
COVINGTON, KY 41011

PARCEL ID: 034-30-00-070.00
PARK HOWARD CEMETERY
c/o EVERETT JONES & R TIDWELL
GEN DEL
WALLINS, KY 40873

PARCEL ID: 034-30-00-073.00
EVANS JAMES OTIS & HOLLY EVANS
PO BOX 884
WALLINS, KY 40873

PARCEL ID: 034-30-00-073.00_2
EVANS JAMES & HOLLY EVANS
PO BOX 884
WALLINS, KY 40873

PARCEL ID: 034-30-00-073.00_3
GROSS JAMES V
PO BOX 923
WALLINS, KY 40873


CERTIFICATE

I HEREBY CERTIFY THAT THIS EXHIBIT
PERTAINING TO THE ADJOINING PROPERTY
OWNERS PER PVA RECORDS WAS PREPARED
UNDER MY DIRECT SUPERVISION. NO BOUNDARY
SURVEYING OF ANY KIND HAS BEEN PERFORMED
FOR THIS EXHIBIT.

MARK PATTERSON, PLS #3136

DATE

0' 400' 800'
1 INCH = 400 FEET

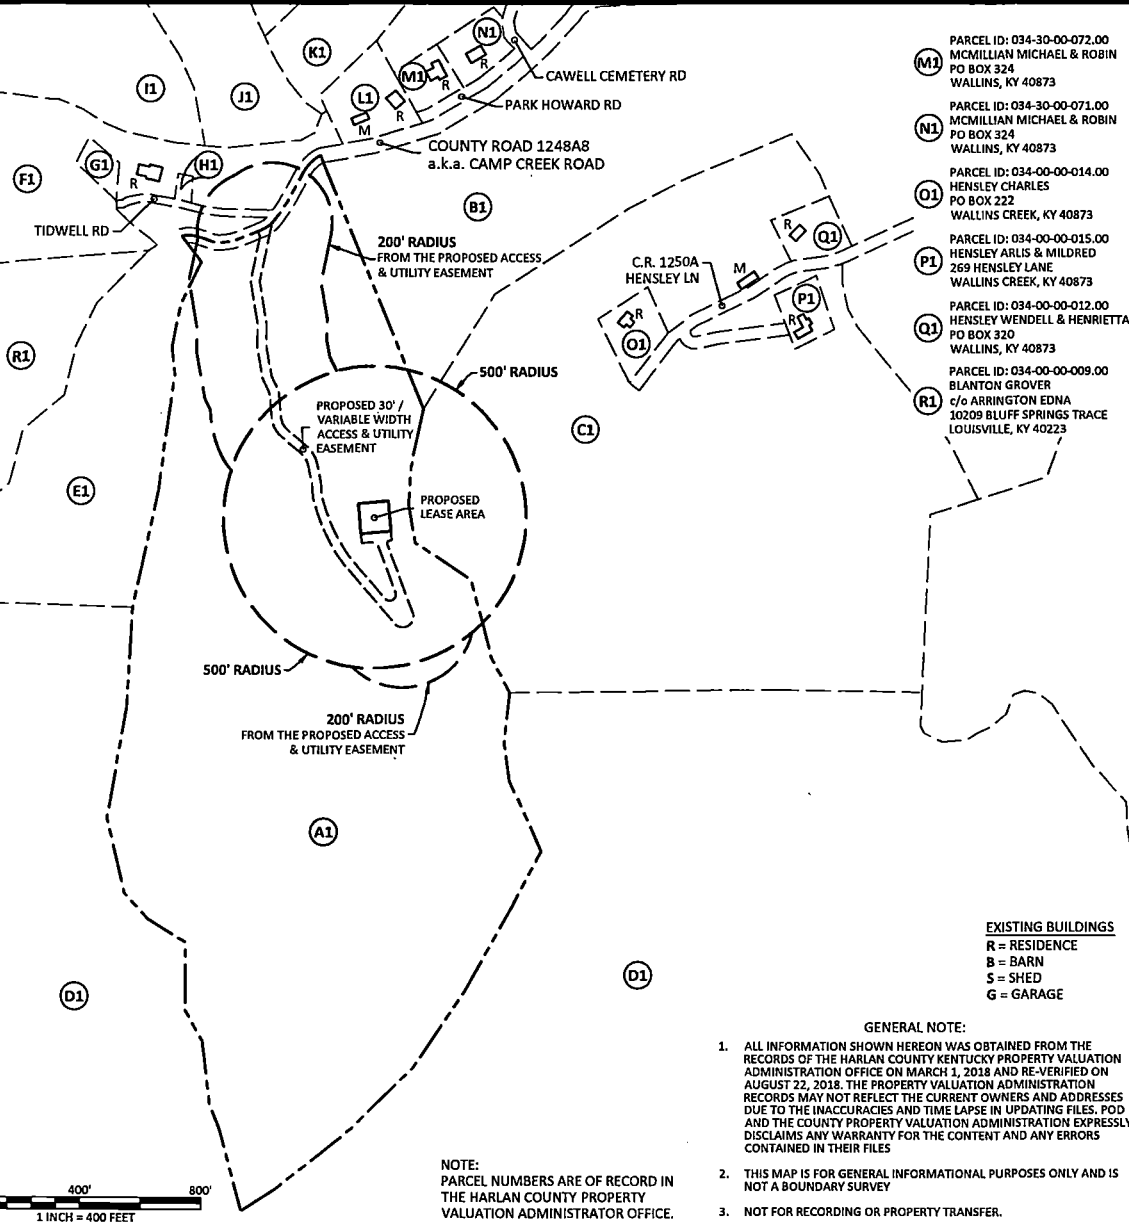

NOTE:
PARCEL NUMBERS ARE OF RECORD IN
THE HARLAN COUNTY PROPERTY
VALUATION ADMINISTRATOR OFFICE.

EXISTING BUILDINGS
R = RESIDENCE
B = BARN
S = SHED
G = GARAGE

GENERAL NOTE:

- ALL INFORMATION SHOWN HEREON WAS OBTAINED FROM THE RECORDS OF THE HARLAN COUNTY KENTUCKY PROPERTY VALUATION ADMINISTRATION OFFICE ON MARCH 1, 2018 AND RE-VERIFIED ON AUGUST 22, 2018. THE PROPERTY VALUATION ADMINISTRATION RECORDS MAY NOT REFLECT THE CURRENT OWNERS AND ADDRESSES DUE TO THE INACCURACIES AND TIME LAPSE IN UPDATING FILES. POD AND THE COUNTY PROPERTY VALUATION ADMINISTRATION EXPRESSLY DISCLAIMS ANY WARRANTY FOR THE CONTENT AND ANY ERRORS CONTAINED IN THEIR FILES
- THIS MAP IS FOR GENERAL INFORMATIONAL PURPOSES ONLY AND IS NOT A BOUNDARY SURVEY
- NOT FOR RECORDING OR PROPERTY TRANSFER.

PREPARED BY:		POD POWER OF DESIGN 13490 BLUEGRASS PARKWAY LOUISVILLE, KY 40299 502-437-5252	
PREPARED FOR:		MasTec	
PREPARED FOR:		at&t	
EXHIBIT			
REV.	DATE	DESCRIPTION	
A	8.22.18	ISSUED FOR REVIEW	
SITE INFORMATION:			
WALLINS CREEK COUNTY ROAD 1248A8 a.k.a. CAMP CREEK ROAD WALLINS CREEK, KY 40873 HARLAN COUNTY			
TAX PARCEL NUMBER: 034-00-00-016.00			
TAX PARCEL ADDRESS: O HENSLEY HOLLOW - WALLINS O WALLINS CREEK, KY 40873			
PROPERTY OWNER: CINDY HONEYCUTT P. O. BOX 356 WHITESBURG, KY 41858			
SOURCE OF TITLE: WILL BOOK 25, PAGE 78 (DEED BOOK 150, PAGE 19)			
SITE NUMBER:			
POD NUMBER:	18-27369		
DRAWN BY:	DAP		
CHECKED BY:	MEP		
SURVEY DATE:	3.1.18		
PLAT DATE:	8.22.18		
SHEET TITLE:			
500' RADIUS AND ABUTTERS MAP			
SHEET NUMBER: (1 pages)			
B-2			

EXHIBIT L
COPY OF COUNTY JUDGE/EXECUTIVE NOTICE



1578 Highway 44 East, Suite 6
P.O. Box 369
Shepherdsville, KY 40165-0369
Phone (502) 955-4400 or (800) 516-4293
Fax (502) 543-4410 or (800) 541-4410

VIA CERTIFIED MAIL

Hon. Dan Mosley
County Judge Executive
PO Box 956
Harlan, KY 40831

RE: Notice of Proposal to Construct Wireless Communications Facility
Kentucky Public Service Commission Docket No. 2018-00340
Site Name: Wallins Creek

Dear Judge/Executive:

New Cingular Wireless PCS, LLC, a Delaware Limited Liability Company, d/b/a AT&T Mobility has filed an application with the Kentucky Public Service Commission ("PSC") to construct a new wireless communications facility on a site located at County Road 1248A8 a.k.a. Camp Creek Road, Wallins Creek, Kentucky 40873 (36°48'02.36" North latitude, 83°24'43.64" West longitude). The proposed facility will include a 255-foot tall antenna tower, plus a 15-foot lightning arrestor and related ground facilities. This facility is needed to provide improved coverage for wireless communications in the area.

You have a right to submit comments to the PSC or to request intervention in the PSC's proceedings on the application. You may contact the PSC at: Executive Director, Public Service Commission, 211 Sower Boulevard, P.O. Box 615, Frankfort, Kentucky 40602. Please refer to docket number 2018-00340 in any correspondence sent in connection with this matter.

In addition to expanding and improving voice and data service for AT&T mobile customers, this site will also provide wireless local loop ("WLL") broadband internet service to homes and businesses in the area. WLL will support internet access at the high speeds required to use and enjoy the most current business, education and entertainment technologies.


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Sincerely,
David A. Pike
Attorney for Applicant

enclosures

Site Name: Wallins Creek
Driving Directions to Proposed Tower Site

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8. Arrive at County Road 1248A8 a.k.a. Camp Creek Road, Wallins Creek, Kentucky 40873 on the left.
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Prepared by:
Robert W. Grant
Pike Legal Group PLLC
1578 Highway 44 East, Suite 6
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Telephone: 502-955-4400 or 800-516-4293

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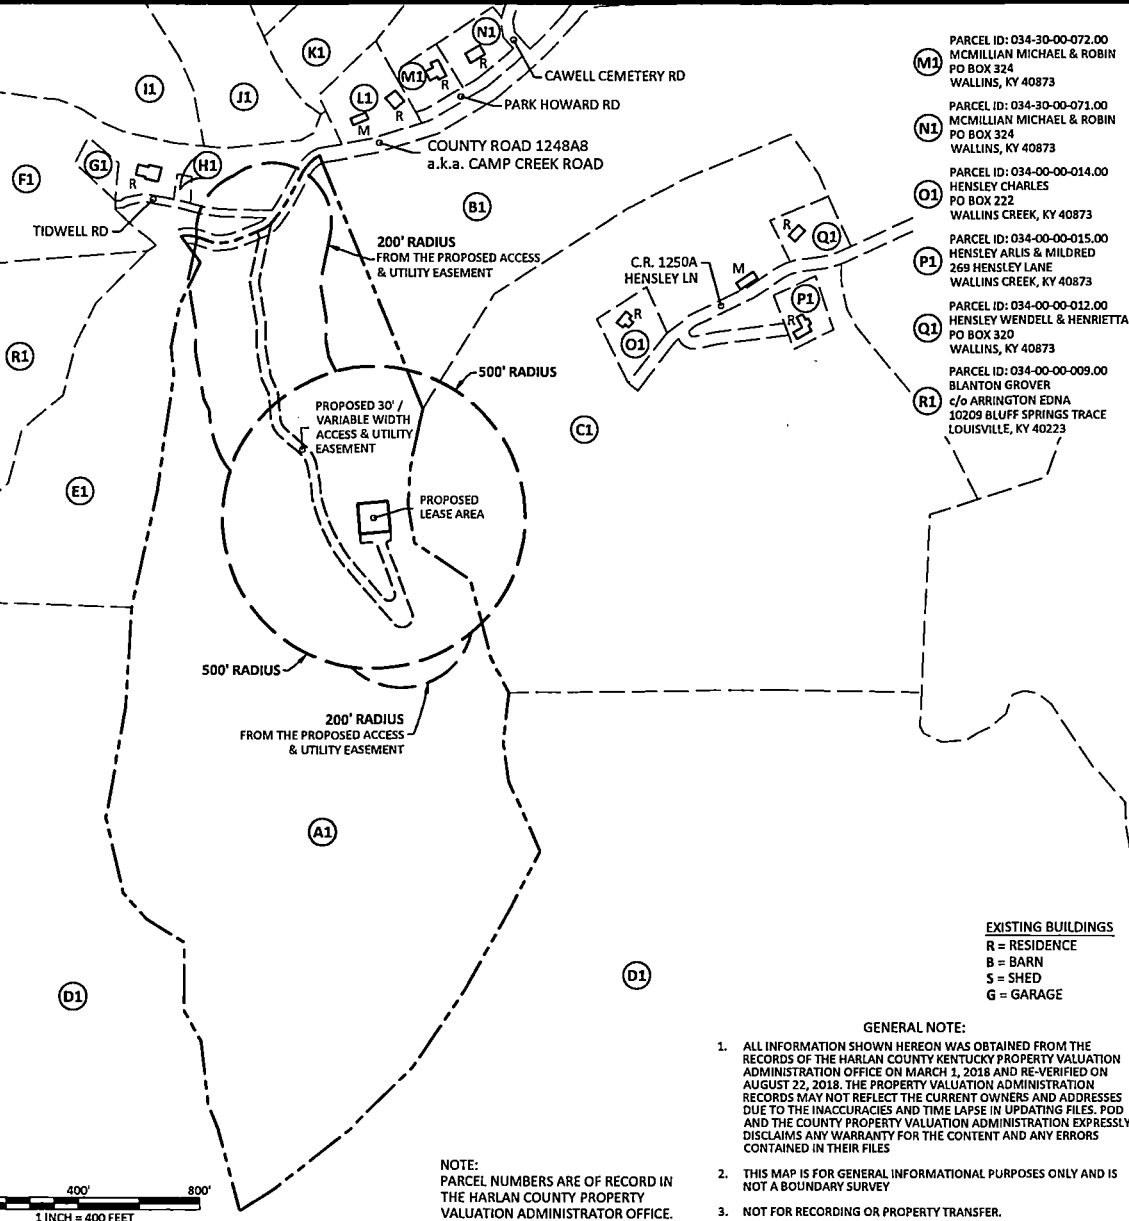
PARCEL ID: 034-30-00-073.00_3
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MARK PATTERSON, PLS #3136 DATE

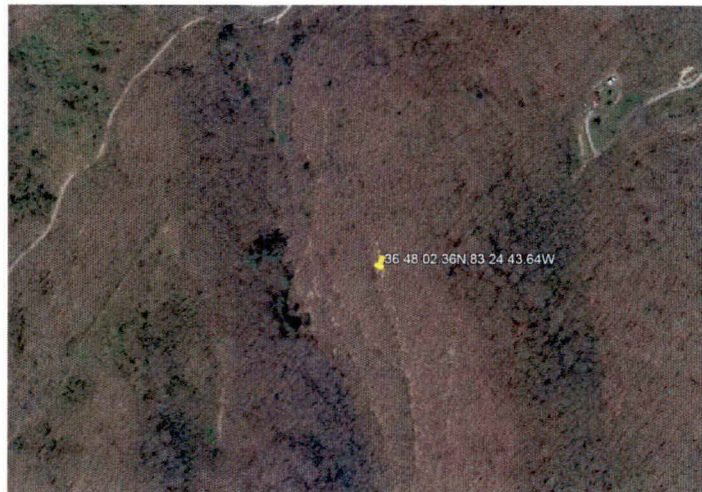0' 400' 800'
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PREPARED BY:
POD
POWER OF DESIGN
11400 BLUEGRASS PARKWAY
LOUISVILLE, KY 40299
502-437-5253

PREPARED FOR:
MasTec

PREPARED FOR:
at&t

EXHIBIT

REV.	DATE	DESCRIPTION
A	8.22.18	ISSUED FOR REVIEW

SITE INFORMATION:

WALLINS CREEK
COUNTY ROAD 1248A8
a.k.a. CAMP CREEK ROAD
WALLINS CREEK, KY 40873
HARLAN COUNTY

TAX PARCEL NUMBER:
034-00-00-016.00

TAX PARCEL ADDRESS:
0 HENSLEY HOLLOW - WALLINS O
WALLINS CREEK, KY 40873

PROPERTY OWNER:
CINDY HONEYCUTT
P. O. BOX 356
WHITESBURG, KY 41858

SOURCE OF TITLE:
WILL BOOK 25, PAGE 78
(DEED BOOK 150, PAGE 19)

SITE NUMBER:

POD NUMBER: 18-27369
DRAWN BY: DAP
CHECKED BY: MEP
SURVEY DATE: 3.1.18
PLAT DATE: 8.22.18

SHEET TITLE:

**500' RADIUS AND
ABUTTERS MAP**

SHEET NUMBER: (1 pages)

B-2

EXHIBIT M
COPY OF POSTED NOTICES
AND NEWSPAPER NOTICE ADVERTISEMENT

SITE NAME: WALLINS CREEK
NOTICE SIGNS

The signs are at least (2) feet by four (4) feet in size, of durable material, with the text printed in black letters at least one (1) inch in height against a white background, except for the word "**tower**," which is at least four (4) inches in height.

New Cingular Wireless PCS, LLC, a Delaware limited liability company, d/b/a AT&T Mobility proposes to construct a telecommunications **tower** on this site. If you have questions, please contact Pike Legal Group, PLLC, P.O. Box 369, Shepherdsville, KY 40165; telephone: (800) 516-4293, or the Executive Director, Public Service Commission, 211 Sower Boulevard, PO Box 615, Frankfort, Kentucky 40602. Please refer to docket number 2018-00340 in your correspondence.

New Cingular Wireless PCS, LLC, a Delaware limited liability company, d/b/a AT&T Mobility proposes to construct a telecommunications **tower** near this site. If you have questions, please contact Pike Legal Group, PLLC, P.O. Box 369, Shepherdsville, KY 40165; telephone: (800) 516-4293, or the Executive Director, Public Service Commission, 211 Sower Boulevard, PO Box 615, Frankfort, Kentucky 40602. Please refer to docket number 2018-00340 in your correspondence.



1578 Highway 44 East, Suite 6
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Shepherdsville, KY 40165-0369
Phone (502) 955-4400 or (800) 516-4293
Fax (502) 543-4410 or (800) 541-4410

VIA TELEFAX: 606-573-0042

Harlan Daily Enterprise
PO Box 1155
Harlan, KY 40831

RE: Legal Notice Advertisement
Site Name: Wallins Creek

Dear Harlan Daily Enterprise:

Please publish the following legal notice advertisement in the next edition of *The Harlan Daily Enterprise*:


NOTICE

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After this advertisement has been published, please forward a tear sheet copy, affidavit of publication, and invoice to Pike Legal Group, PLLC, P. O. Box 369, Shepherdsville, KY 40165. Please call me at (800) 516-4293 if you have any questions. Thank you for your assistance.

Sincerely,
Robert W. Grant
Pike Legal Group, PLLC

EXHIBIT N
COPY OF RADIO FREQUENCY DESIGN SEARCH AREA

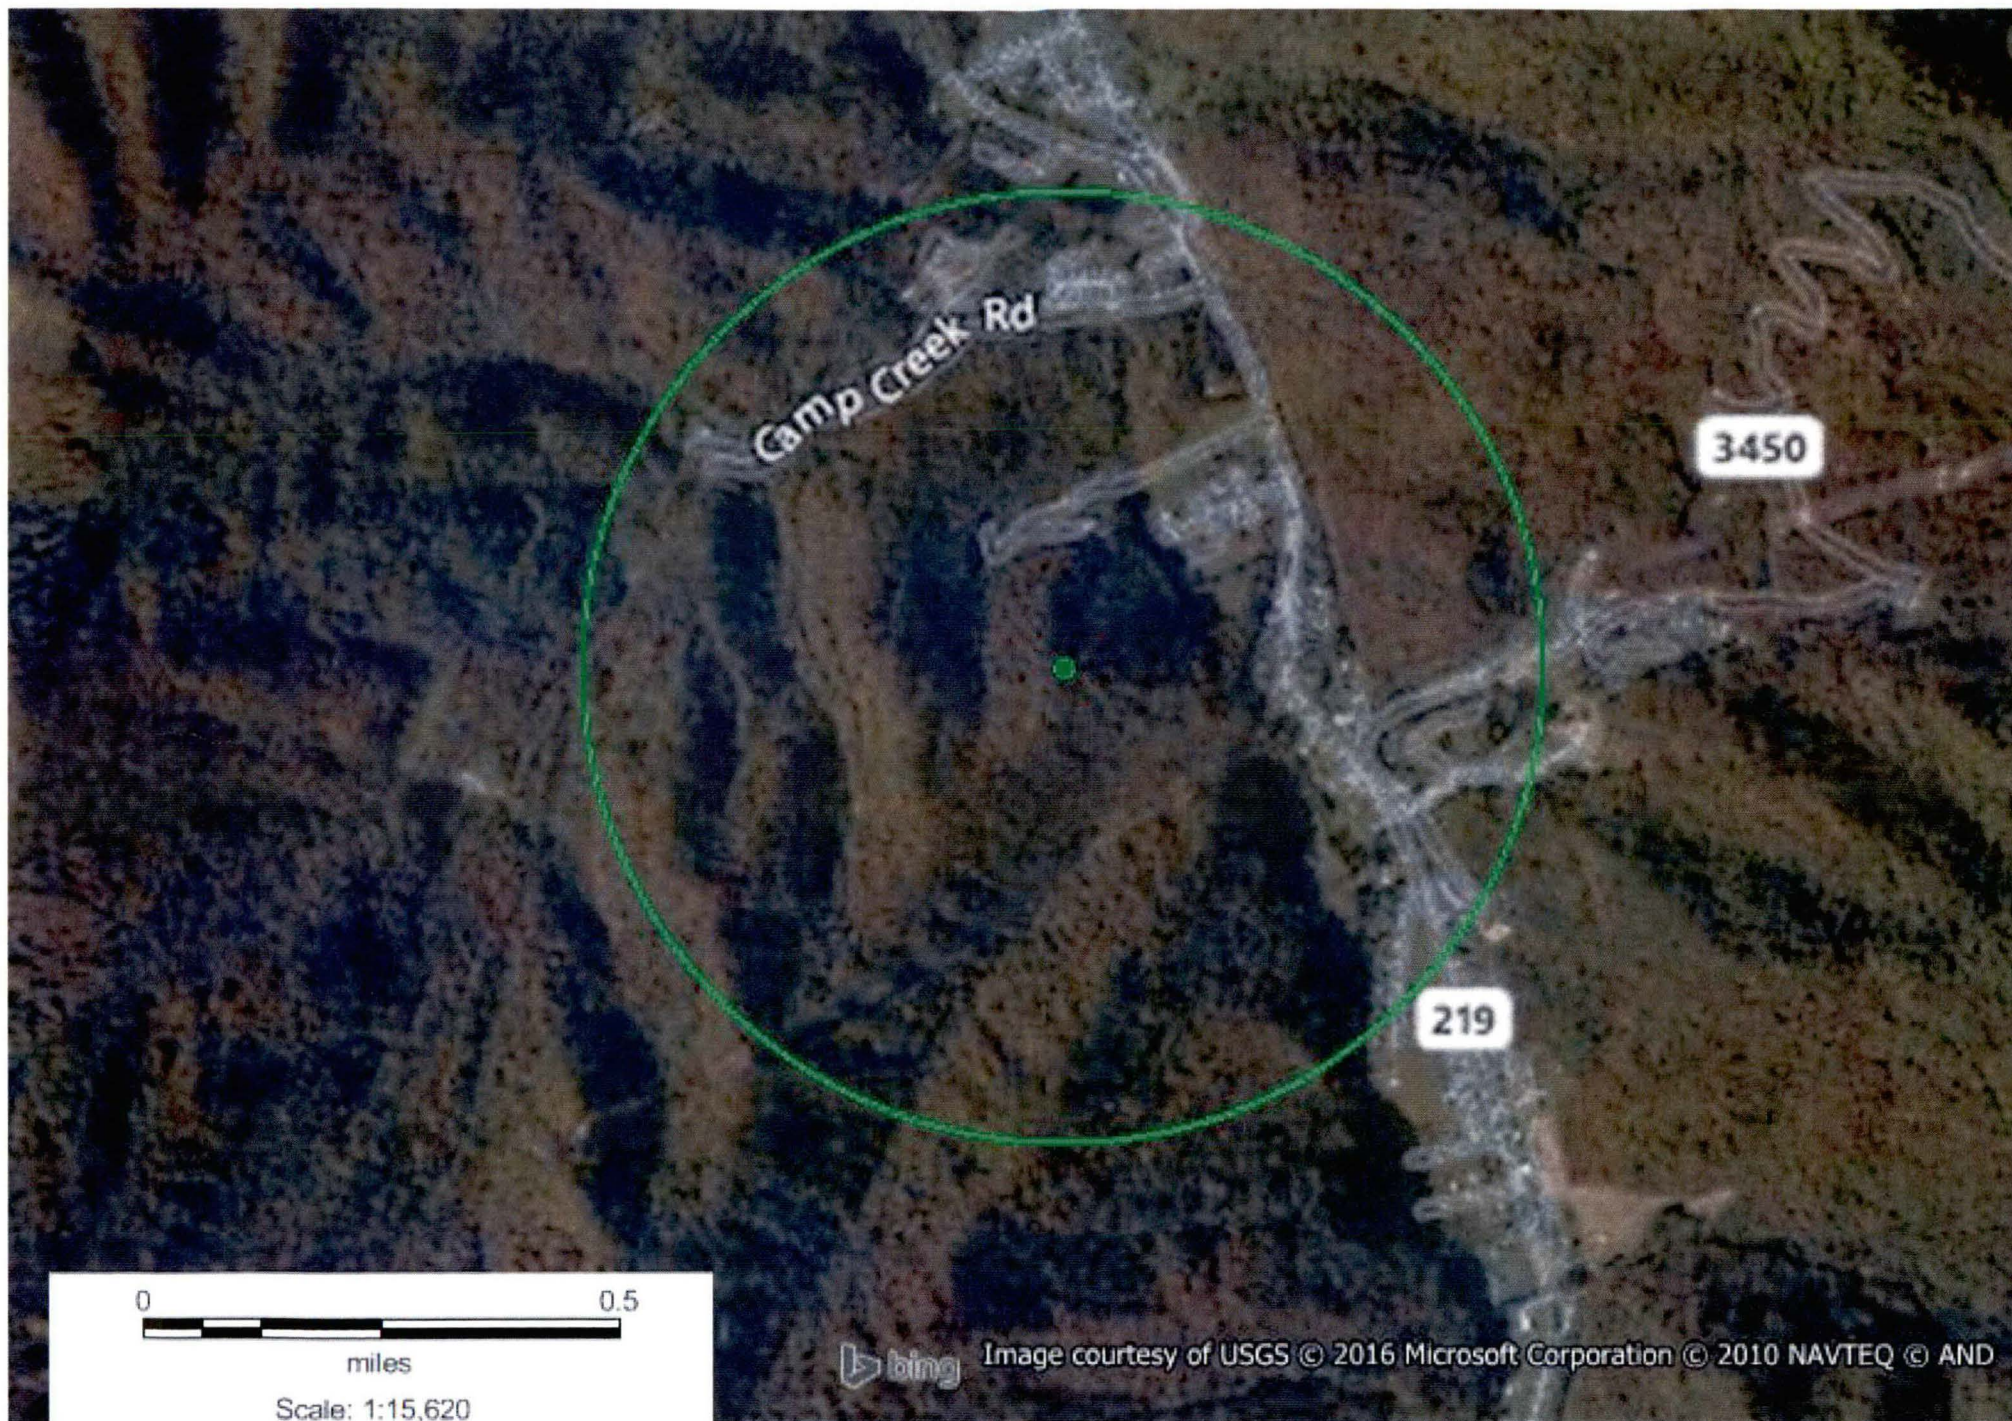

Lat: 36.800197
Lon: -83.407855
Radius: .5 miles

Wallins Creek Search Area